DESIGN CRITERIA

THE STRUCTURE IS DESIGNED IN ACCORDANCE WITH THE FLORIDA BUILDING CODE 8TH EDITION. REFERENCE TO OTHER STANDARD SPECIFICATIONS OR CODES SHALL MEAN THE LATEST PUBLICATION.

FOUNDATIONS ARE DESIGNED FOR AN ASSUMED ALLOWABLE BEARING PRESSURE OF 2,000 PSF. SUPERIMPOSED LIVE LOADS: ROOFS AND CANOPIES: (REDUCIBLE). ULTIMATE WIND SPEED NOMINAL WIND SPEED. 121 MPH MEAN ROOF HEIGHT. . 19 FT RISK CATEGORY .. WIND EXPOSURE .. ENCLOSURE CLASSIFICATION .. . ENCLOSED INTERNAL PRESSURE COEFFICIENT

THIS BUILDING IS LOCATED IN THE WIND BORNE DEBRIS REGION. IMPACT RESISTANCE GLAZING IS REQUIRED.

CONCRETE

DIRECTIONALITY FACTOR (Kd).

ALL CONCRETE PROPORTIONING, MIXING, TRANSPORTATION, PLACING, AND CURING SHALL CONFORM TO ACI 301.

ALL CONCRETE SHALL BE LABORATORY DESIGNED AND CONTROLLED TO MEET THE REQUIREMENTS OF ACI 318 AND THE PROJECT'S DESIGN BUILDING CODE.

USE OF CALCIUM CHLORIDE, CHLORIDE IONS, OR OTHER SALTS IS CONCRETE IS PROHIBITED.

CONCRETE SHALL CONFORM TO THE FOLLOWING: F'c @ 28 DAYS TYPE AGGREGATE LOCATION W/C RATIO (MAX) NORMAL WEIGHT SLAB-ON-GRADE 0.50 4,000 NORMAL WEIGHT WALLS 0.55NORMAL WEIGHT FOOTINGS 0.55 3,000 NORMAL WEIGHT ALL OTHER CONCRETE 0.55

THE AIR CONTENT IN ALL CONCRETE EXPOSED TO WEATHER SHALL BE BETWEEN 1% & 4%. CONCRETE PROTECTION FOR REINFORCEMENT SHALL BE AS NOTED BELOW, OR PER LATEST ACI 318 FOR CONDITIONS OTHER THAN THOSE LISTED:

CONCRETE CAST AGAINST EARTH..... BEAMS AND COLUMNS... ..2" FROM TOP SLABS ON GRADE... FORMED CONCRETE EXPOSED TO EARTH OR WEATHER... SLABS & WALLS NOT EXPOSED TO EARTH OR WEATHER..

CHAMFER ALL EXPOSED CORNER 3/4" MINIMUM.

ALL HOOKS CALLED FOR IN STRUCTURAL DRAWINGS SHALL BE ACI STANDARD HOOKS, UNO. REINFORCING STEEL SHALL CONFORM TO ASTM A615, GRADE 60 UNO.

ALL WELDED WIRE MESH SHALL CONFORM TO ASTM A185. LAP TWO SQUARES AT SPLICES. DO NOT WELD REINFORCING STEEL UNLESS APPROVED IN WRITING BY THE STRUCTURAL ENGINEER.

TIE ALL REINFORCING STEEL AND EMBEDS SECURELY IN PLACE PRIOR TO PLACING CONCRETE. THE CONTRACTOR SHALL PROVIDE SUPPORTS TO MAINTAIN THE REQUIRED REINFORCING POSITION. "WET STICKING" DOWELS INTO CONCRETE IS NOT PERMITTED.

THE CONTRACTOR SHALL COMPARE THE STRUCTURAL PLANS AND DETAILS WITH THE ARCHITECTURAL PLANS AND DETAILS AND REPORT ANY DISCREPANCIES TO THE ARCHITECT PRIOR TO THE COMMENCEMENT OF SHOP DRAWINGS.

THE CONTRACTOR SHALL PROVIDE AN ALLOWANCE OF 1% OF TOTAL REINFORCING STEEL FOR THE PROJECT TO BE FABRICATED AND PLACED DURING CONSTRUCTION AT THE DIRECTION OF THE STRUCTURAL ENGINEER, IN ADDITION TO THE REINFORCING STEEL REQUIRED BY THE STRUCTURAL DRAWINGS. THE OWNER SHALL RECEIVE CREDIT FOR ANY UNUSED QUANTITY AT THE END OF THE PROJECT.

ALL REINFORCING SHALL HAVE AN ACI CLASS B SPLICE AT BAR LAPS.

METAL DECK

UNLESS NOTED OTHERWISE ON PLANS, THE METAL DECK SHALL BE GALVANIZED (G60 MINIMUM) CONFORMING TO THE STEEL DECK INSTITUTE'S SPECIFICATIONS, LATEST

SEE STRUCTURAL DRAWINGS FOR METAL DECK TYPE AND GAGE.

THE HANGING OF ANY LOADS INCLUDING MECHANICAL EQUIPMENT FROM THE ROOF DECK

ALL METAL DECK SHALL BE FASTENED TO THE STEEL SUPPORTS AT END OF PANEL AND AT ALL INTERMEDIATE SUPPORTS PER DETAIL 8/S2.2.

DECKING SHALL BE CONTINUOUS OVER 3 SPANS MINIMUM WHERE ALLOWABLE WITH SUPPORTING STRUCTURE.

TOUCH UP ALL AREAS DAMAGED DURING INSTALLATION WITH REPAIR PAINT MATCHING THE SHOP COAT.

STEEL JOIST

ALL OPEN WEB JOIST AND JOIST GIRDERS SHALL BE FABRICATED, FURNISHED, AND ERECTED IN ACCORDANCE WITH THE STEEL JOIST INSTITUTE'S STANDARD SPECIFICATIONS FOR OPEN WEB STEEL JOISTS, LATEST EDITION.

THE DESIGN OF ALL STEEL JOIST AND JOIST GIRDERS SHALL BE BY THE MANUFACTURER'S ENGINEER. ALL JOIST AND JOIST GIRDERS ALONG WITH THE BRIDGING SHALL BE DESIGNED FOR THE GRAVITY LOADS OF THE PROJECT IN ADDITION TO THE WIND LOADS SHOWN ON THE STRUCTURAL DRAWINGS. A DEAD LOAD OF 10 PSF MAY BE USED FOR NET UPLIFT CALCULATIONS.

K SERIES JOISTS SHALL BEAR A MINIMUM OF 2 1/2" OVER STEEL SUPPORTS. LH SERIES JOISTS SHALL BEAR A MINIMUM OF 4" OVER STEEL SUPPORTS. BEARING PLATES AND ANGLES SHALL BE ADJUSTED TO PROVIDE LEVEL BEARING ON SUPPORT SURFACE.

SHOP DRAWINGS SHALL BE SUBMITTED COMPLETELY DETAILING THE JOISTS FOR ERECTION. INCLUDE ALL BRIDGING AND CONNECTIONS. CALCULATIONS AND SHOP DRAWINGS SHALL BE SIGNED, SEALED, AND DATED BY A STRUCTURAL ENGINEER REGISTERED IN THE STATE OF THE PROJECT.

PROVIDE A SHOP COAT OF STANDARD PRIMER PAINT. COLOR TO BE SPECIFIED BY THE ARCHITECT OR OWNER. PRIMER TO BE COMPATIBLE WITH FINISH COAT WHERE APPLICABLE. TOUCH UP DAMAGED AREAS WITH SAME PAINT USED FOR SHOP COAT.

FOUNDATIONS

A GEOTECHNICAL ENGINEER REGISTERED IN THE STATE OF THE PROJECT SHALL INSPECT AND ASSURE THE ADEQUACY OF ALL SUBGRADES, FILLS, AND BACKFILLS BEFORE PLACEMENT OF FOUNDATIONS, FOOTINGS, SLABS, ETC. WRITTEN ACCEPTANCE OF THE WORK INSPECTED AND VERIFICATION OF ASSUMED SOIL BEARING PRESSURE SHALL BE SUBMITTED TO THE ARCHITECT AND STRUCTURAL ENGINEER.

WHERE FOOTING STEPS ARE REQUIRED, THE STEPS SHALL BE NO STEEPER THAN ONE VERTICAL TO TWO HORIZONTAL, UNO ON PLAN. THE CONTRACTOR IS RESPONSIBLE FOR LOCATING THE REQUIRED FOOTING STEP LOCATIONS.

. PER CODE

ALL STRUCTURAL STEEL SHALL CONFORM TO THE FOLLOWING:

ASTM A992 FOR W-SHAPES ASTM A36 FOR PLATES, ANGLES, & MISC FRAMING ASTM A588, GRADE 50, WHERE NOTED ASTM A501 OR A53 FOR PIPE

HEADED STUDS SHALL COMPLY WITH ASTM A108 AND SHALL BE AUTOMATICALLY END WELDED PER MANUFACTURER'S RECOMMENDATIONS.

ANCHOR RODS SHALL CONFORM TO ASTM F1554. GRADE 36, UNO.

ASTM A500, GRADE B FOR TUBES

ALL CONNECTION BOLTS SHALL CONFORM TO ASTM A325.

WELDING OF STRUCTURAL STEEL SHALL BE PER AWS D1.1. LATEST EDITION.

SMALLER THAN THE THICKNESS OF THE THINNER OF THE ELEMENTS TO BE WELDED. UNLESS NOTED OTHERWISE PROVIDE THE GREATER OF THE FOLLOWING BEAM END

1) MINIMUM 5/16" DOUBLE ANGLE SHEAR CONNECTION, FULL DEPTH OF THE BEAM, WELDED OR BOLTED WITH VERTICAL BOLT SPACING OF 3".

WHERE FILLET WELD SIZE ISN'T CALLED-OUT ON WELD SYMBOL, FILLET SIZE SHALL BE 1/16"

2) WHERE BEAM REACTIONS ARE SHOWN, CONNECTIONS SHALL DEVELOP THE REACTION

3) WHEN BEAM REACTIONS ARE NOT SHOWN, CONNECTIONS SHALL BE PROPORTIONED TO SUPPORT 60% OF THE TOTAL UNIFORM LOAD CAPACITY SHOWN IN THE UNIFORM LOAD TABLES OF THE AISC MANUAL FOR THE GIVEN BEAM, SPAN, AND GRADE OF STEEL USED. FOR COMPOSITE BEAMS THE PROPORTION CONNECTIONS FOR 90% OF THE UNIFORM LOAD

4) CONNECTIONS SHALL BE PROPORTIONED FOR THE ECCENTRICITY BETWEEN CENTROIDS OF THE CONNECTION AND THE SUPPORTING MEMBER.

STRUCTURAL STEEL SHALL BE SHOP PRIMED PER SSPC PAINT SYSTEM NO. 7.00. PRIMER SHALL BE SSPC PAINT WITH A MINIMUM DRY FILM THICKNESS OF 2.0 MILS. OMIT PAINT AT SURFACES TO BE FIREPROOFED. TOUCH-UP BOLT HEADS, NUTS, FIELD WELDS, AND ABRASIONS IN SHOP PRIMER WITH SAME PAINT.

ALL STEEL EXPOSED TO WEATHER SHALL BE HOT-DIPPED GALVANIZED.

IF ANY DISCREPANCIES BETWEEN SPECIFICATIONS, NOTES, AND DRAWINGS ARE NOTED, THE

MORE STRINGENT REQUIREMENT GOVERNS. COLUMN ANCHOR BOLTS ARE DESIGNED FOR COMPLETE CONDITION ONLY. CONTRACTOR SHALL PROVIDE ALL TEMPORARY BRACING REQUIRED TO MAINTAIN STABILITY UNTIL ALL BRACING ELEMENTS REQUIRED FOR STRUCTURAL STABILITY ARE IN PLACE.

THE CONTRACTOR SHALL BE RESPONSIBLE FOR COORDINATION OF MISC STEEL SHOWN ON THE STRUCTURAL DRAWINGS SUCH AS SHELF ANGLES, LINTELS, SUPPORT MEMBERS FOR CURTAIN WALL OR MASONRY AND EDGE ANGLES FOR OPENINGS AND PERIMETER CONDITIONS. IT IS THE INTENT OF THESE DRAWINGS THAT THESE ITEMS ARE FIELD ATTACHED BY FIELD WELDING OR FIELD BOLTING TO MEET TOLERANCES REOUIRED BY THE OTHER TRADES, THESE TOLERANCES MAY BE MORE STRINGENT THAN AISC TOLERANCES.

THE CONTRACTOR SHALL COMPARE THE STRUCTURAL PLANS AND DETAILS WITH THE ARCHITECTURAL PLANS AND DETAILS AND REPORT ANY DISCREPANCIES TO THE ARCHITECT PRIOR TO THE COMMENCEMENT OF SHOP DRAWINGS.

THE CONTRACTOR SHALL PROVIDE AN ALLOWANCE OF 1% OF TOTAL STRUCTURAL STEEL FOR THE PROJECT TO BE FABRICATED AND INSTALLED DURING CONSTRUCTION AS DIRECTED BY THE STRUCTURAL ENGINEER IN ADDITION TO THE STRUCTURAL STEEL REQUIRED BY THE CONSTRUCTION DRAWINGS. THE OWNER SHALL RECEIVE CREDIT FOR ANY UNUSED QUANTITY AT THE COMPLETION OF THE PROJECT.

TILT-UP WALL PANEL NOTES

DESIGN AND DETAILING OF ALL TILT-UP WALL PANELS SHALL BE PROVIDED BY DELEGATED SPECIALITY ENGINEER.

SIGNED AND SEALED SHOP DRAWINGS OF ALL TILT-UP SHALL BE SUBMITTED TO EOR FOR REVIEW. SHOP DRAWINGS SHALL SPECIFY ALL PANEL THICKNESS, DIMENSIONS, REINFORCING, EMBEDS, HOLDOWNS, DOWELS, AND JOINT LOCATIONS.

DEFERRED SUBMITTALS

THE FOLLOWING ITEMS ARE CONSIDERED DEFERRED SUBMITTALS AND SHALL BE

- SUBMITTED TO THE ENGINEER OF RECORD: 1. PRE-ENGINEERED TRUSS SYSTEM
- METAL FABRICATIONS & STEEL CONNECTIONS 3. ROOF TOP EQUIPMENT AND ANCHORAGES
- 4. STRUCTURAL STEEL CONNECTIONS
- 5. TILT-UP CONCRETE PANELS 6. TILT-UP PANEL STEEL EMBEDS

ALL DEFERRED DESIGN SUBMITTALS, SHOP DRAWINGS AND CALCULATIONS PROVIDED BY OTHERS AND SUBMITTED FOR REVIEW SHALL BE SIGNED AND SEALED BY AN ENGINEER REGISTERED IN THE STATE OF THE PROJECT.

DEFERRED SUBMITTALS NOT LISTED WILL NOT BE REVIEWED BY THE ENGINEER OF RECORD AND SHALL BE SUBMITTED TO THE BUILDING OFFICIAL.

SUPPLEMENTARY NOTES

THE CONTRACTOR IS SOLELY RESPONSIBLE FOR THE DESIGN, ADEQUACY, AND SAFETY OF ERECTION, BRACING, SHORING, TEMPORARY SUPPORTS, ETC. THE STRUCTURAL ELEMENTS ARE NOT CONSIDERED STABLE UNTIL THE STRUCTURE IS COMPLETE.

REVIEW OF THE SUBMITTAL INFORMATION SHALL BE FOR GENERAL REQUIREMENTS OF THE PROJECT, AND SHALL NOT INCLUDE CHECKING OF DETAILED DIMENSIONS OR DETAILED QUANTITIES, NOR REVIEW OF THE CONTRACTOR'S SAFETY MEASURES ON OF OFF THE WORKSITE OR THE MEANS AND METHODS OF DOING ANY WORK.

THE CONTRACTOR SHALL VERIFY ALL EXISTING CONDITIONS AND ARCHITECTURAL AND STRUCTURAL PLAN DIMENSIONS AND ELEVATIONS PRIOR TO THE COMMENCEMENT OF CONSTRUCTION AND NOTIFY THE STRUCTURAL ENGINEER OF ANY CONFLICTS.

ALL STRUCTURAL OPENINGS AROUND OR AFFECTED BY MECHANICAL, ELECTRICAL AND PLUMBING EQUIPMENT SHALL BE VERIFIED WITH EQUIPMENT PURCHASED BEFORE PROCEEDING WITH STRUCTURAL WORK AFFECTED.

ANY ENGINEERING DESIGN PROVIDED BY OTHERS AND SUBMITTED FOR REVIEW SHALL BEAR THE SEAL OF AN ENGINEER REGISTERED IN THE STATE OF THE PROJECT.

GENERAL CONTRACTOR MUST REVIEW AND APPROVE SHOP DRAWINGS PRIOR TO SUBMITTAL TO ARCHITECT/ENGINEER. SUBMITTALS WHICH DO NOT CONTAIN THE CONTRACTOR'S SHOP DRAWING STAMP OR HAVE BEEN MERELY "RUBBER STAMPED" SHALL BE RETURNED WITHOUT REVIEW. CONTRACTOR SHOULD ALLOW TWO WEEKS FOR

CONTRACTOR SHALL NOT ORDER MATERIAL OR COMMENCE WITH CONSTRUCTION UNTIL SHOP DRAWINGS HAVE BEEN REVIEWED AND APPROVED. WORK DONE OR ORDERS PLACED BEFORE SHOP DRAWING APPROVAL IS AT THE CONTRACTOR'S RISK.

THE PROJECT'S STRUCTURAL DRAWINGS AND ELECTRONIC FILES ARE THE PROPERTY OF LOWE STRUCTURES, INC. THE CONTRACTOR AND SUBCONTRACTOR SHALL COMPENSATE LOWE STRUCTURES, INC. FOR THE USE OF THE PROJECT'S CAD FILES FOR ANY PURPOSE INCLUDING SHOP DRAWING PREPARATION.

THE CONTRACTOR SHALL NOT SCALE DRAWINGS. DIMENSIONS SHOWN ON ARCHITECTURAL AND STRUCTURAL PLANS AND DETAILS WILL CONTROL.

POST INSTALLED ANCHORS

POST- INSTALLED ANCHORS SHALL ONLY BE USED WHERE SPECIFIED ON THE CONSTRUCTION DOCUMENTS. THE CONTRACTOR SHALL OBTAIN APPROVAL FROM THE EOR PRIOR TO INSTALLING POST- INSTALLED ANCHORS IN PLACE OF MISSING OR MISPLACED CAST-IN-PLACE ANCHORS. HOLES SHALL BE DRILLED AND CLEANED IN ACCORDANCE WITH THE MANUFACTURERS WRITTEN INSTRUCTIONS. SUBSTITUTION REQUESTS FOR PRODUCTS OTHER THAN THOSE SPECIFIED BELOW SHALL BE SUBMITTED BY THE CONTRACTOR TO THE EOR ALONG WITH CALCULATIONS THAT ARE PREPARED & SEALED BY A REGISTERED PROFESSIONAL ENGINEER. THE CALCULATIONS SHALL DEMONSTRATE THAT THE SUBSTITUTED PRODUCT IS CAPABLE OF ACHIEVING THE PERTINENT EQUIVALENT PERFORMANCE VALUES (MINIMUM) OF THE SPECIFIED PRODUCT USING THE APPROPRIATE DESIGN PROCEDURE AND/OR STANDARD(S) AS REQUIRED BY THE BUILDING CODE. PROVIDE CONTINUOUS SPECIAL INSPECTION FOR ALL MECHANICAL AND ADHESIVE ANCHORS PER THE APPLICABLE EVALUATION REPORT.

• MECHANICAL ANCHORS: SHALL HAVE BEEN TESTED AND QUALIFIED FOR USE IN ACCORDANCE WITH ACI 355.2 AND ICC-ES AC193 FOR CRACKED AND UNCRACKED CONCRETE RECOGNITION. PRE-APPROVED MECHANICAL ANCHORS INCLUDE: -SIMPSON STRONG TIE "TITEN-HD"

-SIMPSON STRONG TIE "TITEN" -SIMPSON STRONG TIE "TORQ-CUT" -HILTI "KWIK BOLT 3"

-DEWALT "SCREW-BOLT +"

 ADHESIVE ANCHORS: SHALL HAVE BEEN TESTED AND QUALIFIED FOR USE IN ACCORDANCE WITH ACI 355.4 AND ICC-ES AC308 FOR CRACKED AND UNCRACKED CONCRETE RECOGNITION. PRE-APPROVED ADHESIVE ANCHORS INCLUDE: -HILTI "HY 200-A"

-SIMPSON "SET - XP" -SIMPSON "SET-3G"

-DEWALT "PURE 110+" • POWDER AND GAS ACTUATED FASTENERS: SHALL HAVE BEEN TESTED AND

QUALIFIED FOR USE IN ACCORDANCE WITH ICC-ES AC70. PRE-APPROVED MECHANICAL

ANCHORS INCLUDE: -SIMPSON STRONG TIE "POWER DRIVEN FASTENERS" -SIMPSON STRONG TIE "GAS ACTUATED FASTENERS"

• MECHANICAL ANCHORS: SHALL HAVE BEEN TESTED AND QUALIFIED FOR USE IN ACCORDANCE WITH ICC-ES AC01 OR AC106. PRE-APPROVED MECHANICAL ANCHORS

-SIMPSON STRONG TIE "TITEN-HD" -SIMPSON STRONG TIE "TITEN"

-BUILDEX "TAPCON"

-HILTI "KWIK BOLT 3" -DEWALT "SCREW-BOLT +" • ADHESIVE ANCHORS: SHALL HAVE BEEN TESTED AND QUALIFIED FOR USE IN ACCORDANCE WITH ICC-ES AC58. PRE-APPROVED ADHESIVE ANCHORS INCLUDE:

-HILTI "HY 270" -SIMPSON "SET-XP" -SIMPSON "200-A" -DEWALT "AC100+ GOLD"

ANCHORS INSTALLED IN CONCRETE MASONRY SHALL BE INSTALLED INTO SOLID GROUTED CONCRETE MASONRY.

ADHESIVE ANCHORS SHALL BE INSTALLED WITH 12 BAR DIAMETER EMBEDMENT MINIMUM

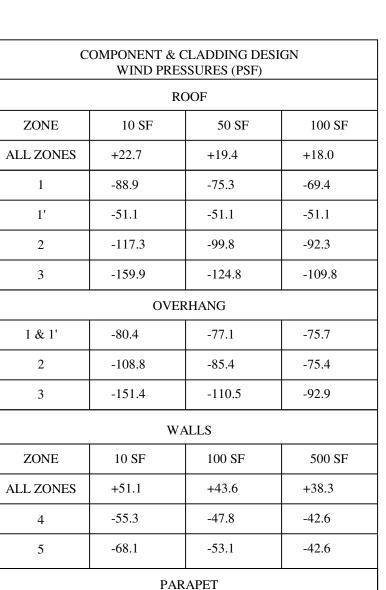


TABLE PRESSURES ARE FOR THE SQUARE FOOT (SF)

TRIBUTARY AREA SHOWN. FOR OTHER TRIBUTARY AREAS, LINEARLY INTERPOLATE BETWEEN VALUES SHOWN ABOVE. POSITIVE PRESSURES ACT TOWARD THE BUILDING. NEGATIVE PRESSURES ACT AWAY FROM THE

100 SF

-83.5

500 SF

-67.0

+100.7

-67.0

10 SF

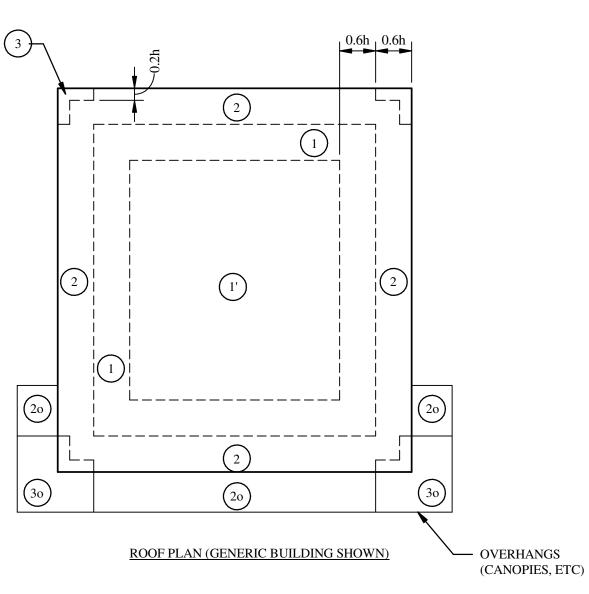
+158.8

+174.8

-92.1

-93.8

SEE DIAGRAMS FOR ZONE LOCATIONS. ALL PRESSURES SHOWN ARE ULTIMATE PRESSURES. a = 7'-7"



WALLS (GENERIC BUILDING SHOWN






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ORK PERFORMED BY SUBCONTRACTORS OR OTHER TRADES WITH THE



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DESCRIPTION ISSUE DATE SSUE FOR PERMIT 1 09/15/2025 REVISION 1 PROJECT INFORMATION BLOCK JOB# 06/27/2025
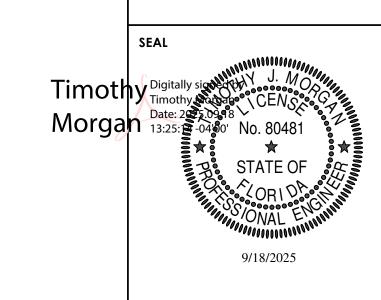
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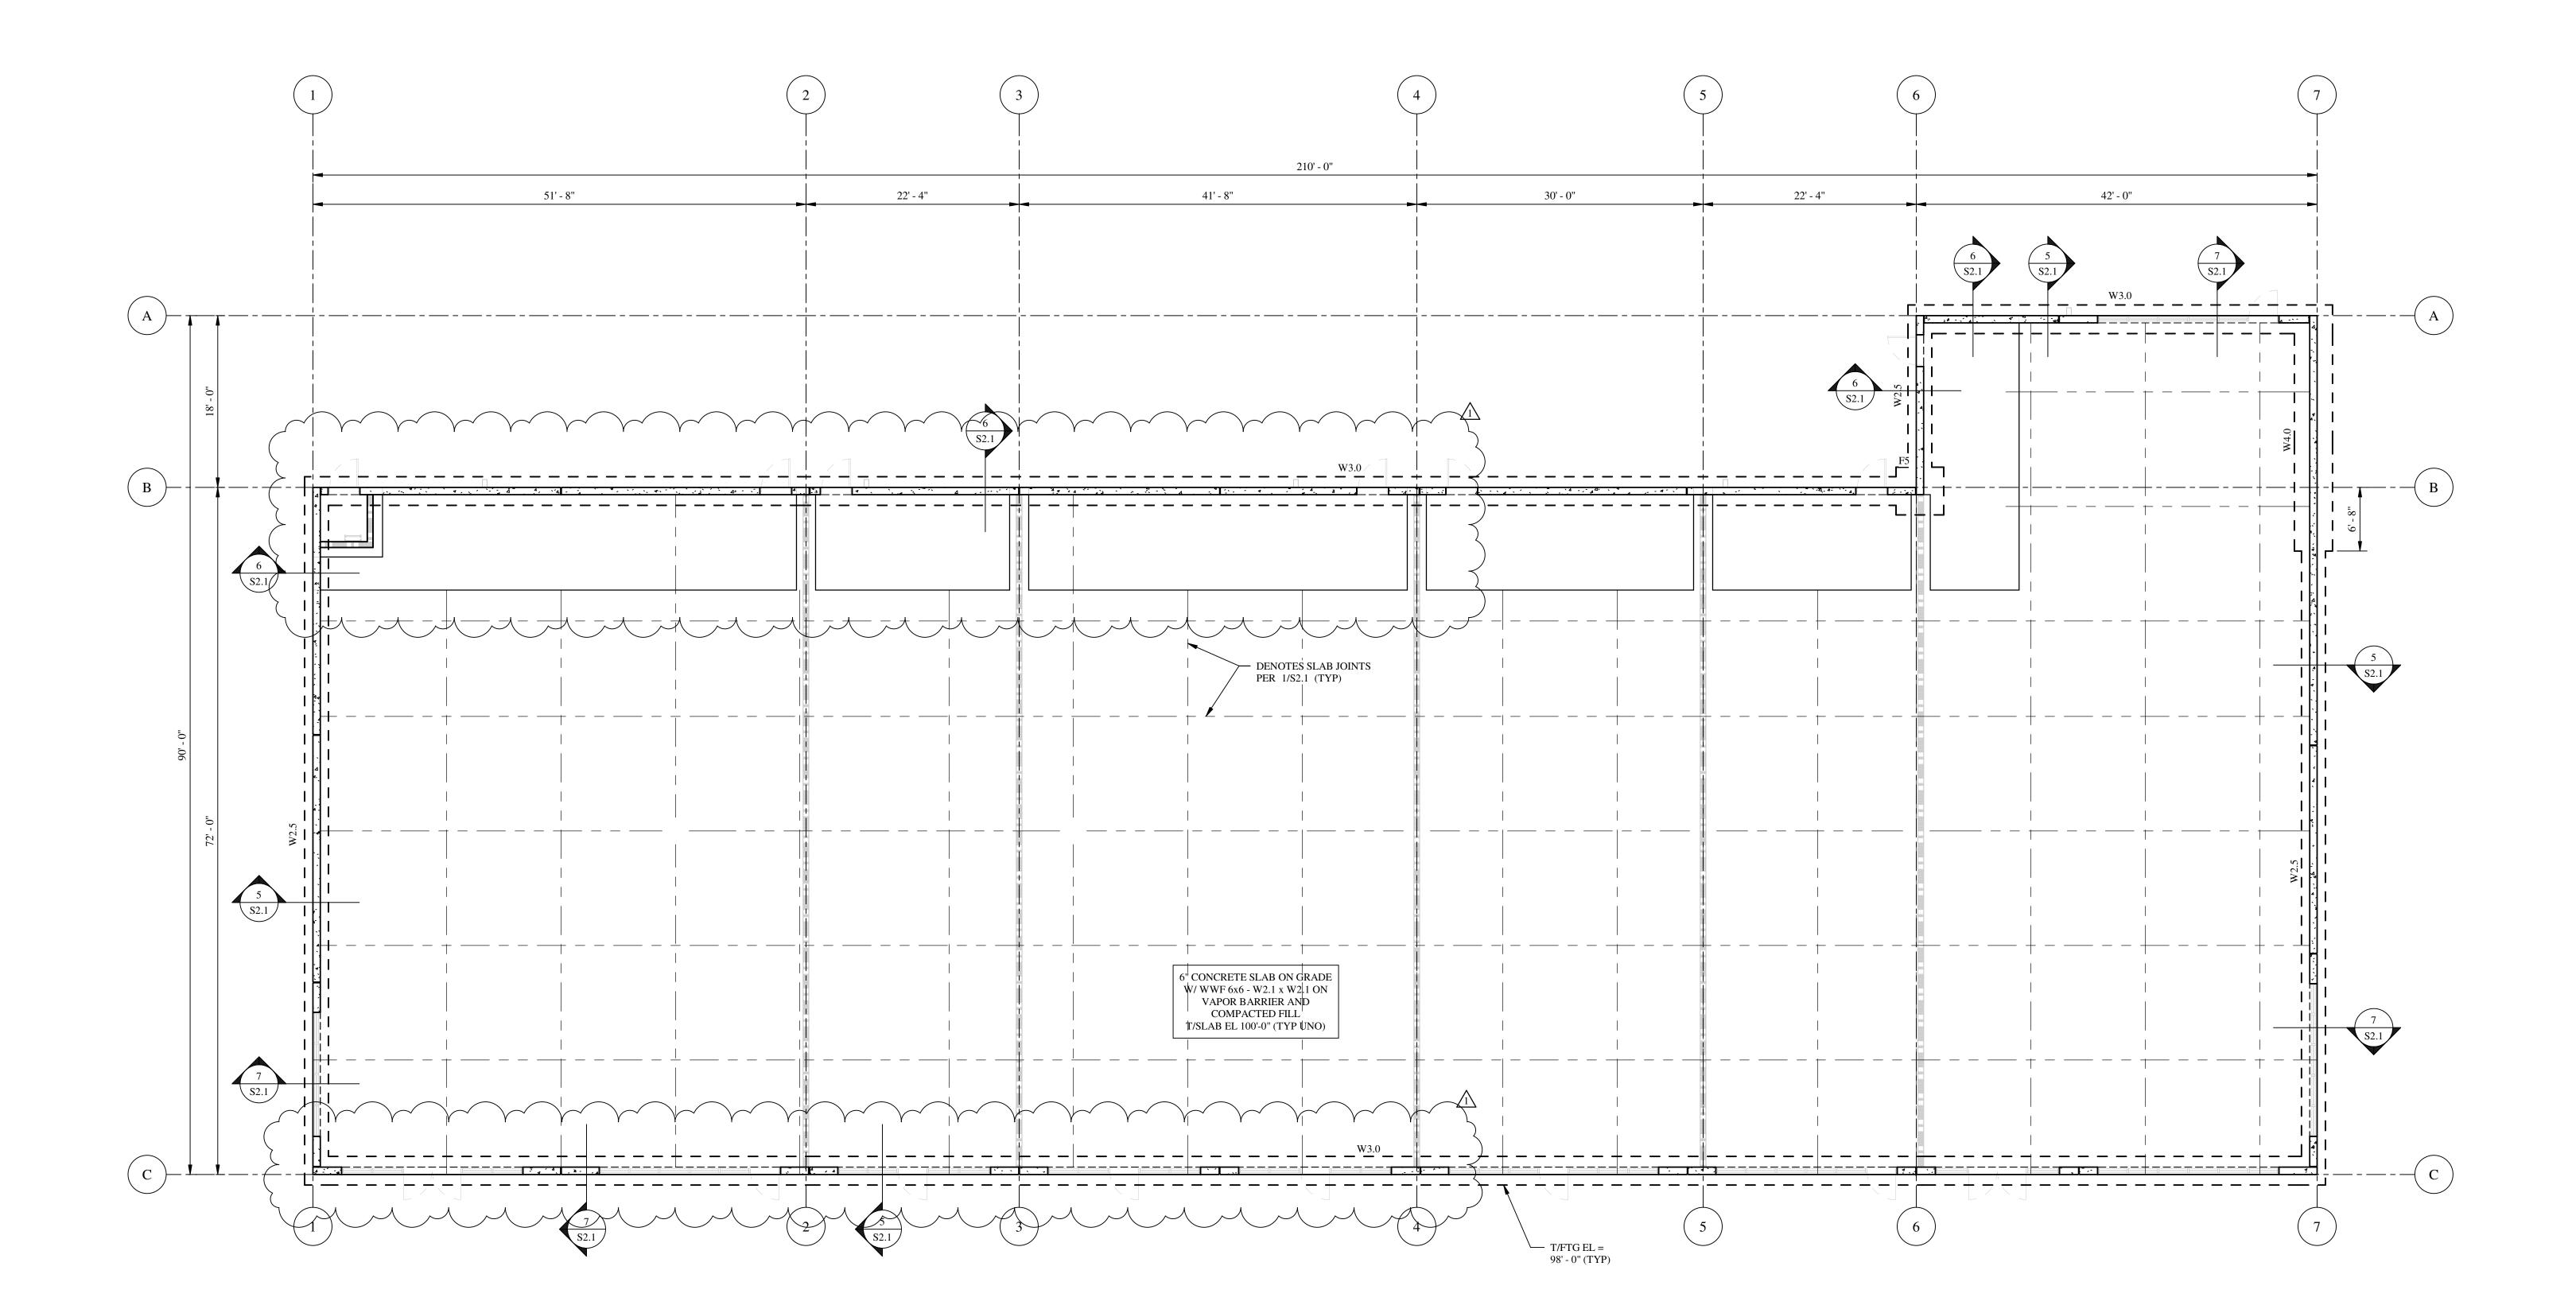
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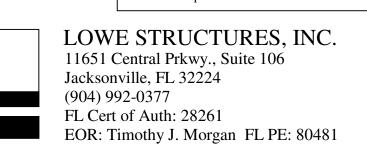




- 1. SEE S0.1 FOR GENERAL NOTES AND DESIGN CRITERIA. 2. CONTRACTOR TO COORD ALL DIMS & LAYOUT W/ ARCH PLAN PRIOR
- TO THE COMMENCEMENT OF CONSTRUCTION. ARCH DIMS AND ELEVATIONS WILL CONTROL.
- 3. ALL ELEVATIONS ARE BASED ON A DATUM T/ SLAB ELEVATION OF 100'-0". COORD ELEVATION W/ CIVIL & ARCH. 4. F# & W# DENOTES FOOTING TYPE. SEE SCHEDULE ON THIS SHEET FOR
- FOOTING SIZE & REINF.
- 5. SEE 2/S2.1 WHERE PIPES PENETRATE BUILDING PERIMETER. 6. SEE 3/S2.1 FOR REINF @ WALL FTG CORNERS.
- 7. SEE 4/S2.1 FOR FOOTING STEP DETAIL . GC TO FIELD VERIFY REQ'D STEP LOCATIONS.

FOOTING SCHEDULE							
TYPE	LENGTH	WIDTH	DEPTH	BOTTOM REINF (LONG WAY)	BOTTOM REINF (SHORT WAY)	REMARKS	
F5	5' - 0"	5' - 0"	1' - 2"	6-#5	6-#5		
W2.5	CONT	2' - 6"	1' - 2"	3-#5	#4 @ 24" OC		
W3.0	CONT	3' - 0"	1' - 2"	4-#5	#4 @ 24" OC		
W4.0	CONT	4' - 0"	1' - 2"	5-#5	#4 @ 24" OC		

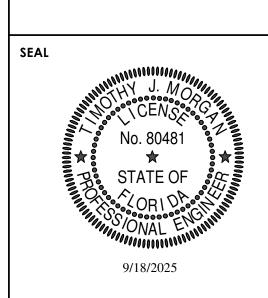
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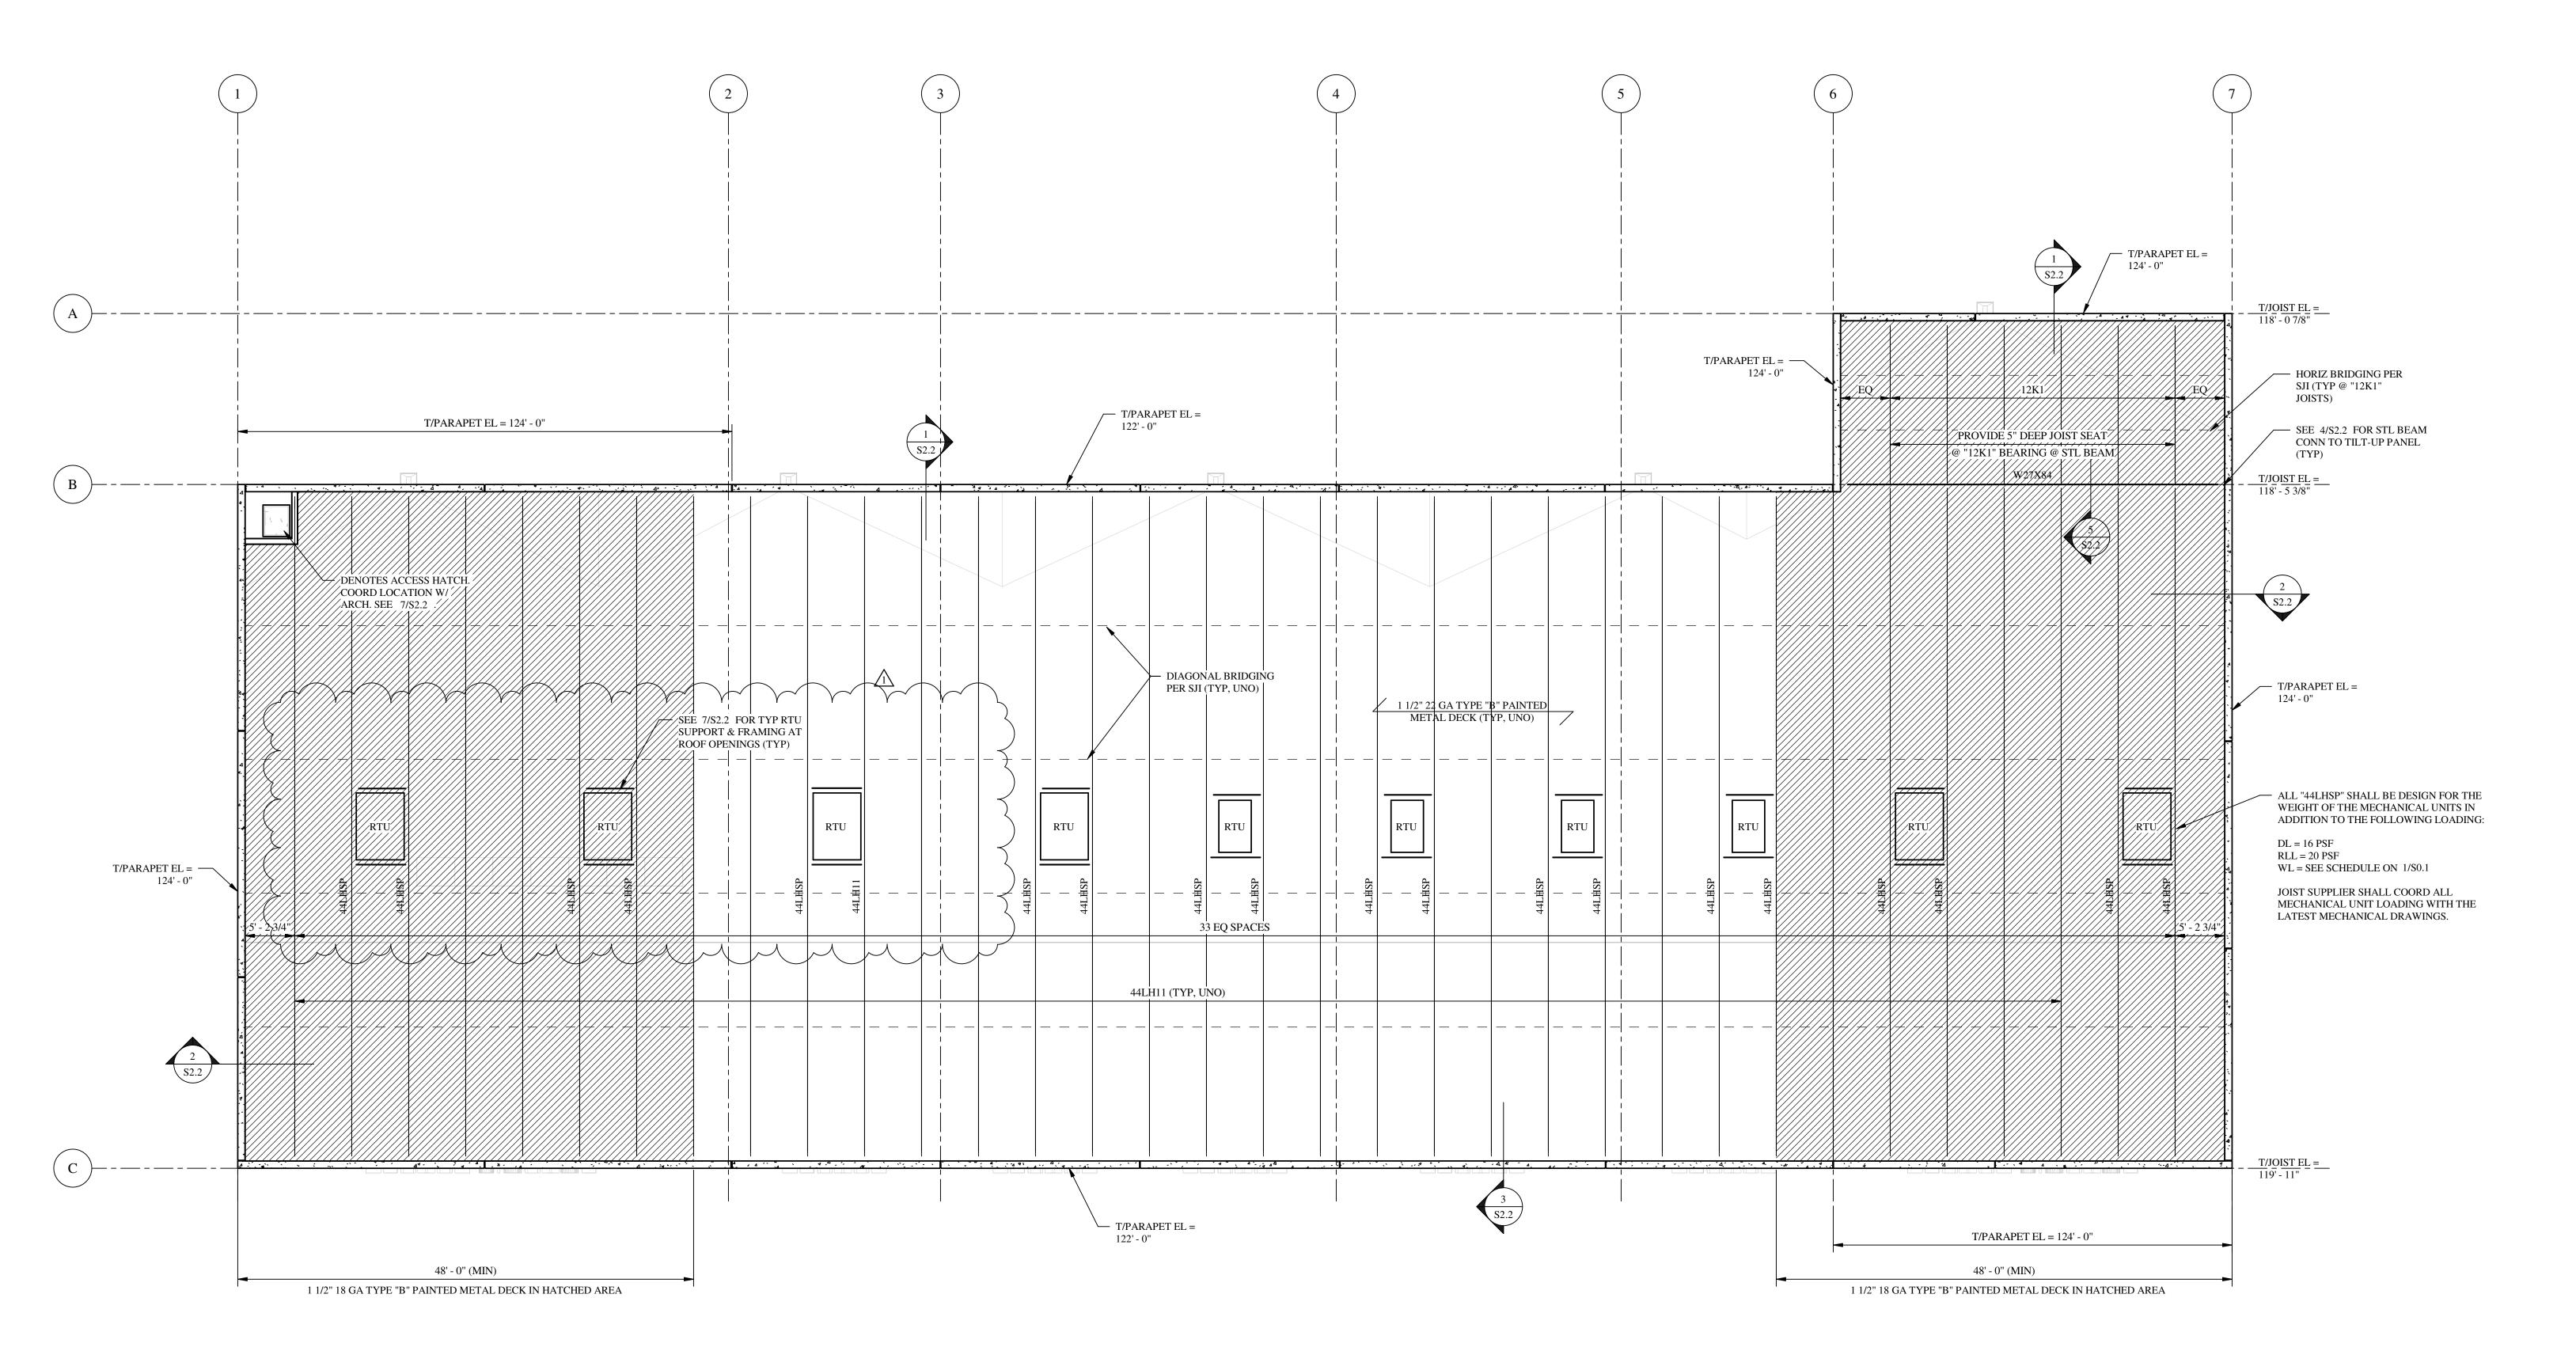
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FOUNDATION PLAN

SHEET NUMBER

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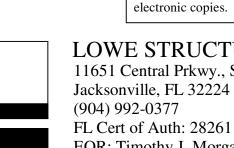
SHEET TITLE





- 1. ELEVATIONS ARE BASED ON TOP OF SLAB ON GRADE DATUM 100'-0". 2. FOR DESIGN CRITERIA AND GENERAL NOTES, SEE SHEET S0.1.
- 3. SEE 8/S2.2 FOR ROOF DECK ATTACHMENT REQUIREMENTS. 4. SEE 6/S2.2 FOR JOIST REINFORCING AT CONCENTRATED LOADS.
- 5. SEE 7/S2.2 FOR FRAMING AT ROOF OPENINGS. 6. T/ BEAM EL SHALL BE -5" FROM T/JST EL , UNO.
- 7. SEE 9/S2.2 FOR ROOF DECK ANGLE SPLICE DETAILS.
- 8. SEE 10/S2.2 FOR HEAT PUMP RAIL ATTACHMENT DETAIL. COORD LOCATIONS WITH MECH PLANS.

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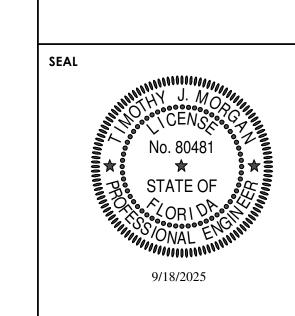
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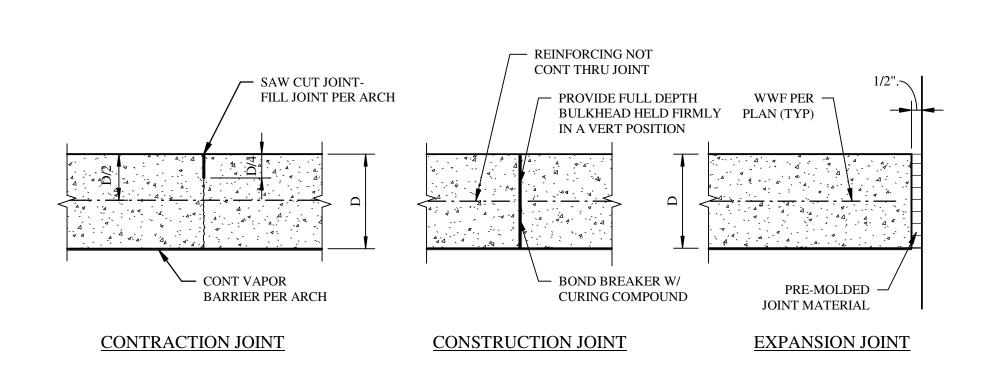



ISSUE DATE DESCRIPTION ISSUE FOR PERMIT 1 09/15/2025 REVISION 1 PROJECT INFORMATION BLOCK JOB # DATE: 06/27/2025 DRAWN BY: CHECKED BY:


ROOF FRAMING PLAN


SHEET NUMBER

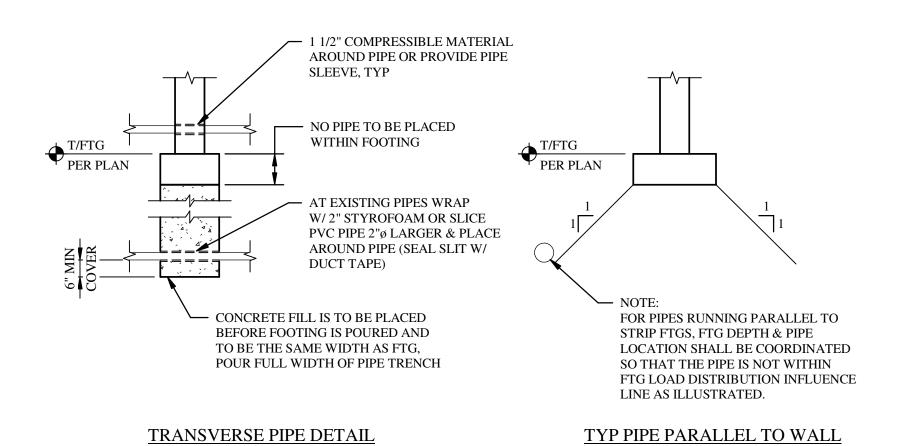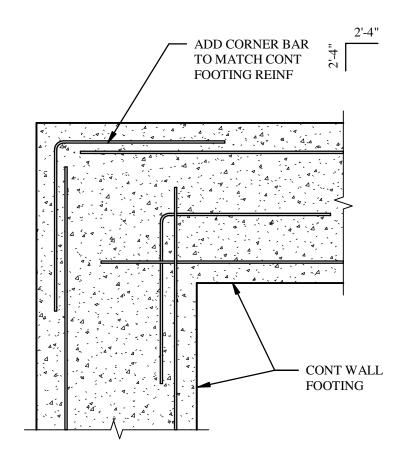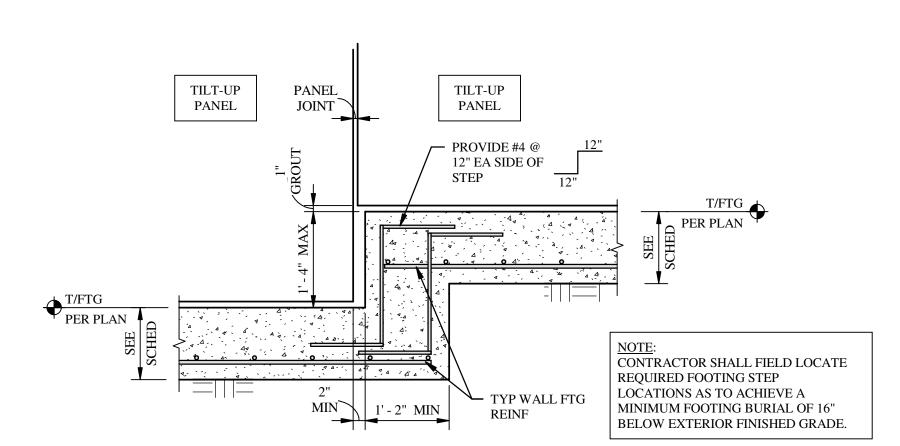SHEET TITLE









FTG STEP DETAIL

architects

100 N Laura Street P: 904 - 640 - 1309
Suite 801 Lic #: AA - 0003590
Jacksonville, FL 32202 W: www.bdgllp.com

TRADITION

A BU

SHOPPES

REINF @ CONT FTG CORNERS

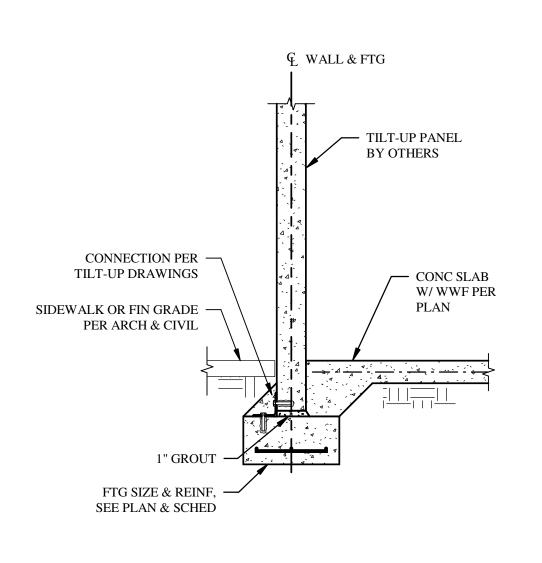


PIPE PENETRATION DETAIL









NOTES:

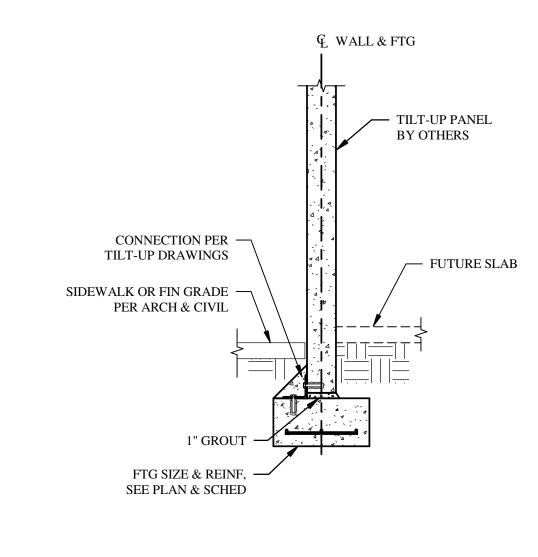
1. USE CONSTRUCTION JOINT WHEREVER CONSTRUCTION

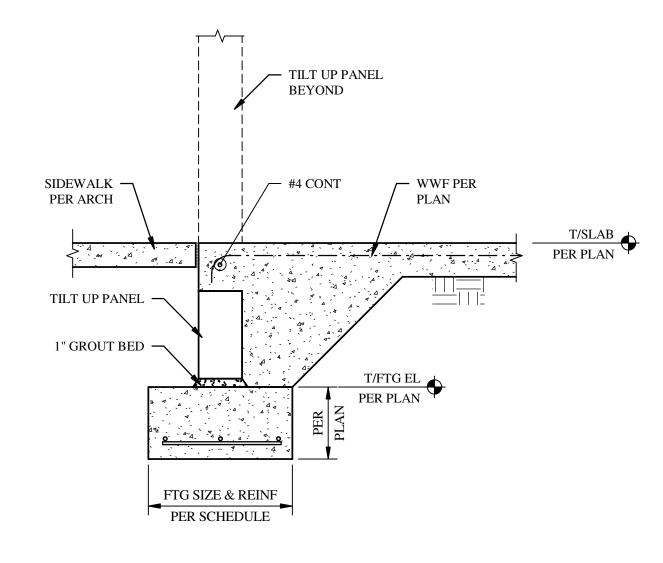
2. CONTRACTION JOINTS SHALL BE CUT INTO SLAB WITHIN

3. SLAB JOINTS SHALL BE SPACED NO GREATER THAN 18'-0"

IS STOPPED OR SPECIFIED ON PLAN.


12 HOURS OF CONCRETE PLACEMENT.







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ISSUE	DATE	DESCRIPTION		
0	06/27/2025	ISSUE FOR PERMIT		
1	09/15/2025	REVISION 1		
PROJECT INFORMATION BLOCK				
JOB	#	250024		
DATE	:	06/27/2025		
DRA	WN BY:	MLC		
CHE	CKED BY:	TJM		

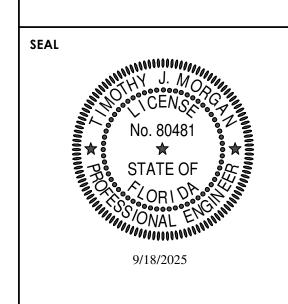signature must be verified on any electronic copies. SECTIONS & DETAILS LOWE STRUCTURES, INC. 11651 Central Prkwy., Suite 106

This item has been electronically sealed by Timothy J. Morgan on 9/18/2025 using

Printed copies of this document are not considered signed and sealed and the

a digital signature.

Jacksonville, FL 32224

FL Cert of Auth: 28261

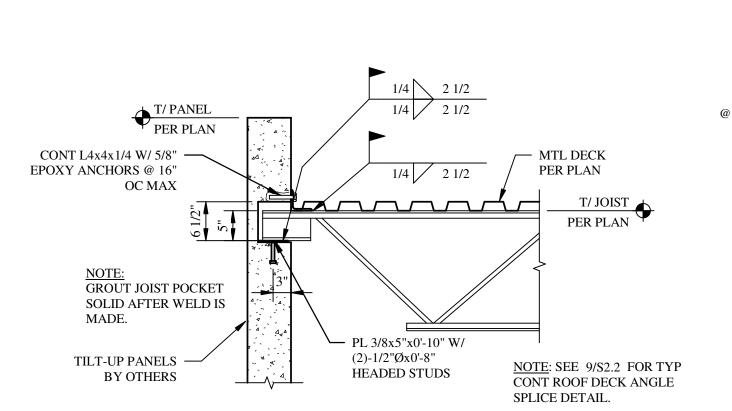
EOR: Timothy J. Morgan FL PE: 80481

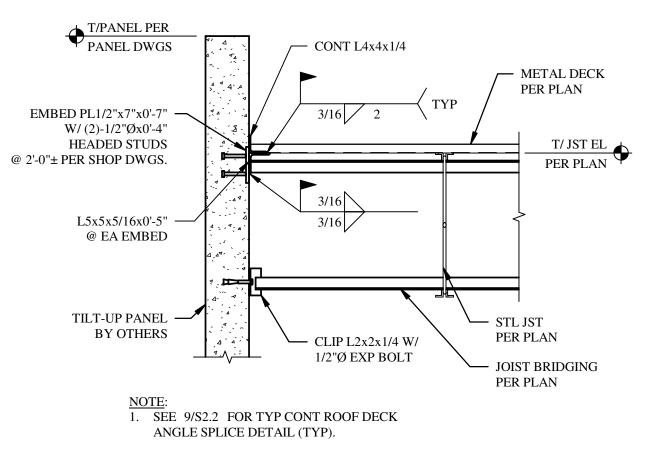
(904) 992-0377

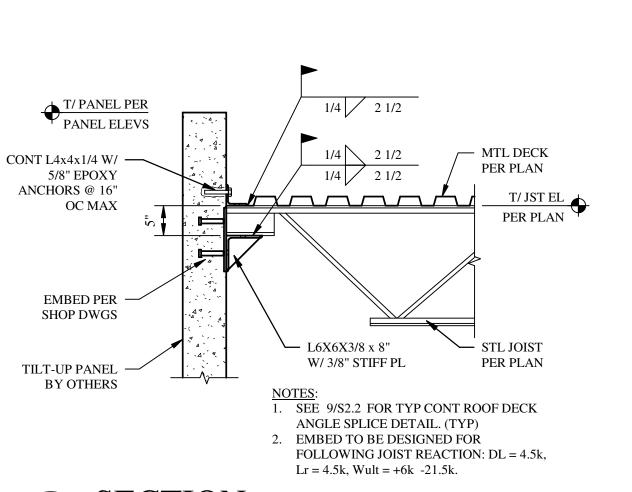
SHEET NUMBER

SHEET TITLE









PROVIDE 5/8"Ø BURGLAR BARS @ 6" EW, OMIT @ DUCT OPNG (IF REQ'D

SEE ARCH)

► L5x5x3/8x0'-5" LG

'X' DIM | 'X' MEMBER

 \leq 6'-0" L4x3x3/8 LLV

 $\leq 3'-0''$ L3x3x1/4

 $\leq 9'-0"$ L4x4x3/8

PER 6/S2.2

€ JOIST PER ➤ REINF JOIST

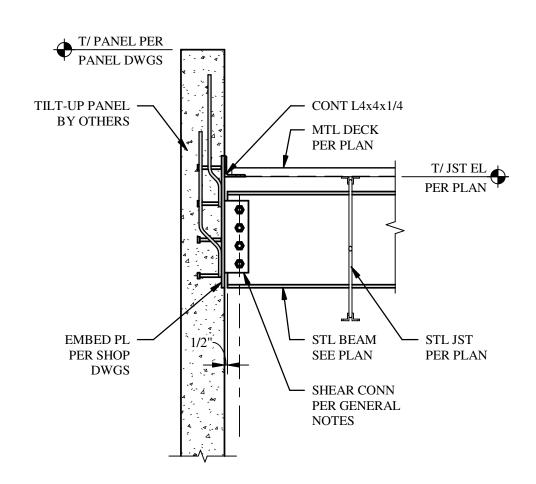
SECTION A-A

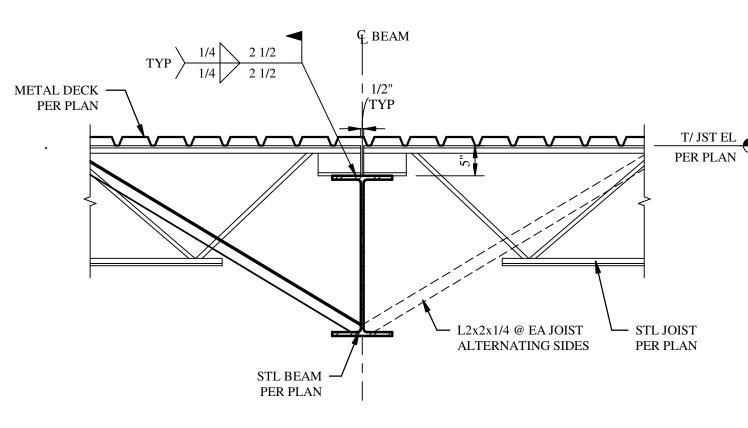
PLAN

 OPNG SIZE EQUALS INSIDE DIMENSION

OF PREFAB CURBS


(L6x6x3/8x0'-5" LG @ L6x4 ANGLE)






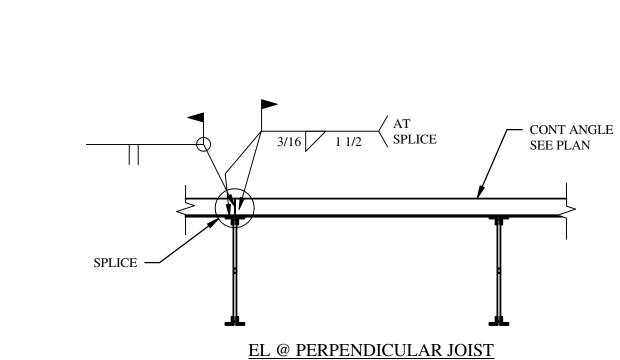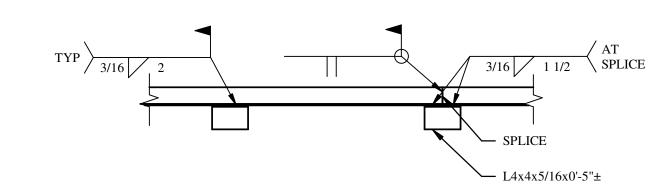NOTES:
1) PROVIDE 1/2"Ø ERECTION BOLTS AS REQ'D BY OSHA.
2) * MAKE CONNECTION AFTER DEAD LOAD IS APPLIED.









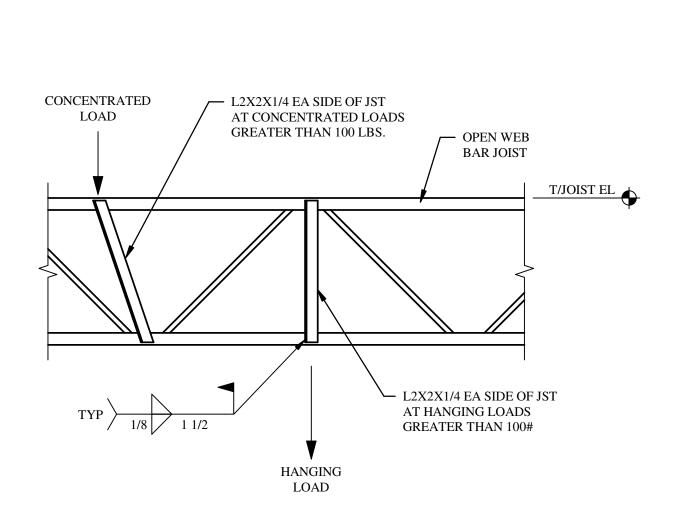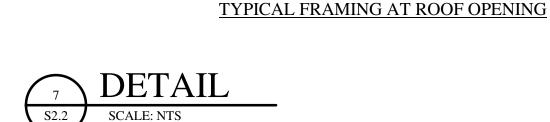EL @ PARALLEL JOIST ROOF DECK EDGE ANGLE SPLICE DETAILS









L4X4X3/8

1. VERIFY ALL DIM W/SUPPLIER BEFORE FABRICATION.

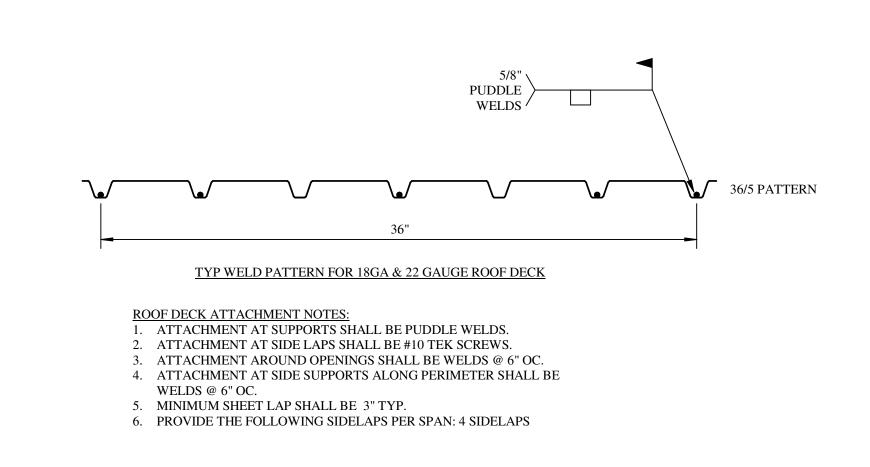
TO DECK SPAN. 5/8"Ø WELD TO EACH FLUTE

3. ROOF DECK IS NOT REQUIRED INSIDE MECH UNIT CURBS.

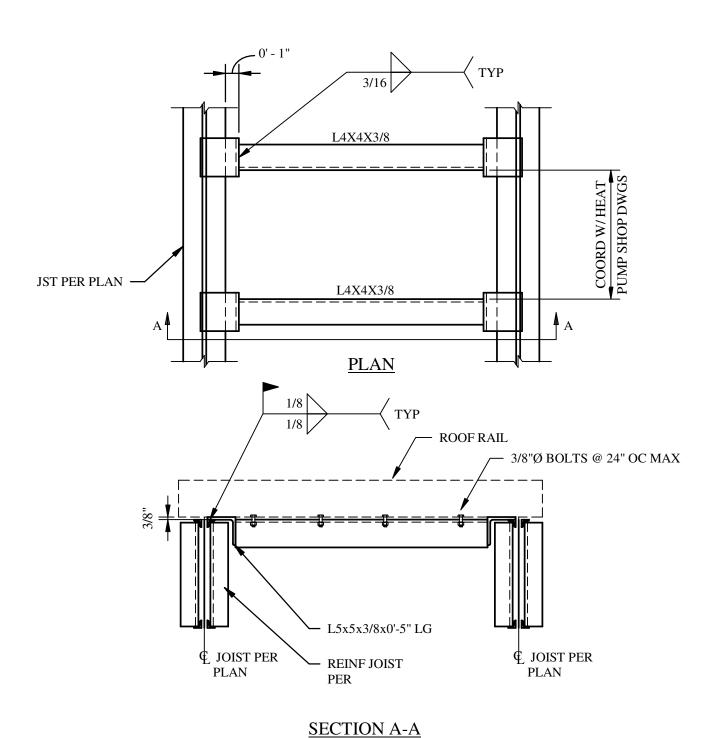
2. INSTALL PREFAB CURBS DIRECTLY ON STEEL SUPPORT ANGLES.

4. AT OPENINGS 6" TO 12" PROVIDE L2x2x1/4x3'-0" LG PERPENDICULAR


JST PER PLAN —








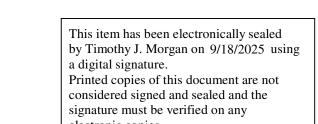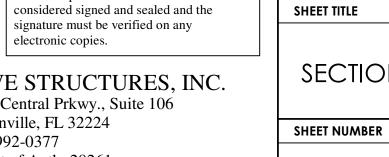HEAT PUMP RAIL ATTACHMENT
S2.2 SCALE: NTS








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HEART OF TRADITION 1G 4 - SHELL

A = B

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ISSUE FOR PERMIT 1 09/15/2025 REVISION 1 PROJECT INFORMATION BLOCK JOB # DATE: 06/27/2025 DRAWN BY: CHECKED BY:

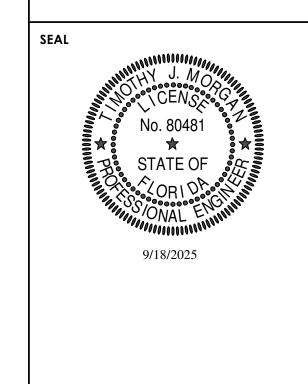SECTIONS & DETAILS