


### MARKETPLACE AT KANNER


3301 S KANNER HIGHWAY STUART, FLORIDA 34994 PROJECT# 230651

PRODUCT TYPE	MANUFACTURER	MODEL # / SERIES	FL PRODUCT APPR. NO.	MIAMI DADE N.O.A.
EXTERIOR PANELS			<u> </u>	
SWINGING - STOREFRONT	YKK AP AMERICA	MODEL 35H MEDIUM STILE	FL 16554.1 - R13	N/A
WALL PANELS				
STOREFRONT	YKK AP AMERICA	YHS50 TU	FL 14218.10 - R14	N/A
ALUMINUM COMPOSITE METAL PANEL	SOUTHERN ALUMINUM FINISHING COMPANY	ARCONIC REYNOBOND COMPOSITE PANELS	FL 17435 - R4	N/A
EIFS	DRYVIT	DRYVIT OUTSULATION PLUS MD	FL 3423.3 - R12	N/A
ROOFING PRODUCTS				
TPO ROOFING SYSTEM	HOLCIM SOLUTIONS	ELEVATE ULTRAPLY TPO ROOF SYSTEMS	FL 10264.1 R-19	17-0727.01
ROOF HATCH	BILCO	S-50	FL 15110.1 - R6	N/A
ROOFING BOARD	USG	SECUROCK GYPSUM FIBER ROOF BOARD	FL 4264.1 - R9	N/A
ROOFING FASTENERS	METAL ERA	METAL ERA ROOF EDGE TERMINATION SYSTEM	FL 29463.1 - R2	N/A
OTHER PRODUCTS				
CONCRETE LINTELS	CAST-CRETE USA	HIGH STRENGTH PRECAST AND PRESTRESS CONCRETE LINTEL	FL 158.1 - R18	N/A

SYMBOLS					
WALL TYPE	ROOM XXX ROOM TAG	A1.0	DETAIL TAG		PLAN DETAIL TAG
# REVISION NUMBER	(101A) DOOR TAG	W A1.0 E	INTERIOR ELEVATION TAG	A1.0	BUILDING SECTION TAG
FINISH FINISH TAG	F10 WINDOW TAG	S			
X KEYNOTE	ELEVATION DATUM TAG	A1.0	EXTERIOR ELEVATION TAG		GRID BUBBLE & CENTER LINE

OWNER & CONS	SULTANTS	UTILITIES		
<u>OWNER</u>	CIVIL / LANDSCAPE	<u>MEP</u>	CBRE	SANITARY SEWER AND WATER
FIFTH THIRD BANK TAMMALA BROOKS VICE PRESIDENT  DIRECTOR - PROJECT GROUP FIFTH THIRD BANK RETAIL 38 FOUNTAIN SQUARE PLAZA MD 10903K	EDC ENGINEERS SURVEYORS ENVIROMENTAL 930 S HARBOR CITY BLVD, SUITE 506, MELBOURNE, FLORIDA 32901 CONTACT: DAVID C. BAGGETT PHONE: 772-462-2455	INFINITY ENGINEERING GROUP, LLC 1208 E. KENNEDY BLVD, SUITE 230 TAMPA, FL 33602 CONTACT: TODD STICKLER 813.434.4770	PROJECT MANAGER CBRE   GLOBAL WORKPLACE SOLUTIONS. 111 W OAK AVE / TAMPA, FL 33602 904.859.0408	CITY OF STUART WATER AND SEWER STANDARD UTILITY DETSILS   STUART, FL (cityofstuart.us)
CINCINNATI, OH 45202 TAMMALA.BROOKS@53.COM	ARCHITECT	<u>STRUCTURAL</u>		ELECTRIC
TAMINALA.BROOKS@33.COM	BDG ARCHITECTS 400 N ASHLEY DRIVE, SUITE. 600 TAMPA, FL 33602 CONTACT: JACK MARSHALL 205.252.8222 CA CONTACT: JUAN QUINONES 813.323.9233	GEORGE F YOUNG, INC 3500 BLUE LAKE DR SUITE 460, BIRMINGHAM, AL 35243 CONTACT: JOHN PERDUE 205.644.0111		FLORIDA POWER & LIGHT - FPL   HOMEPAGE

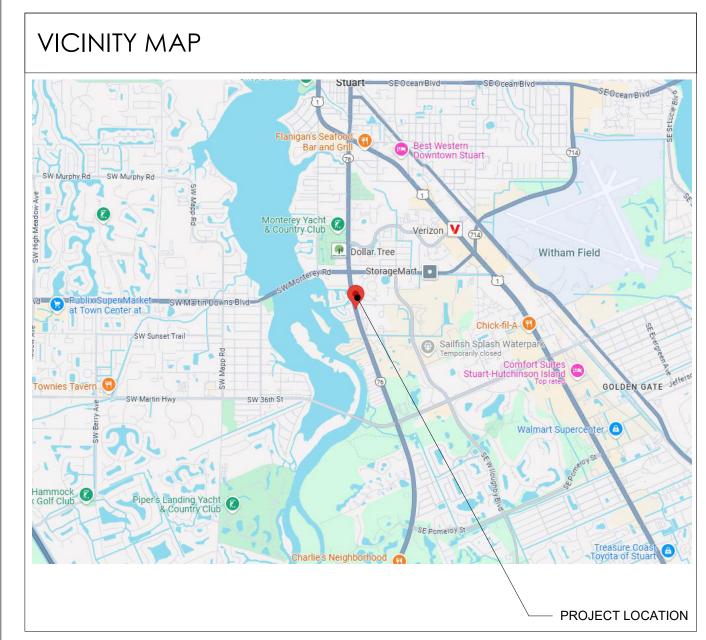

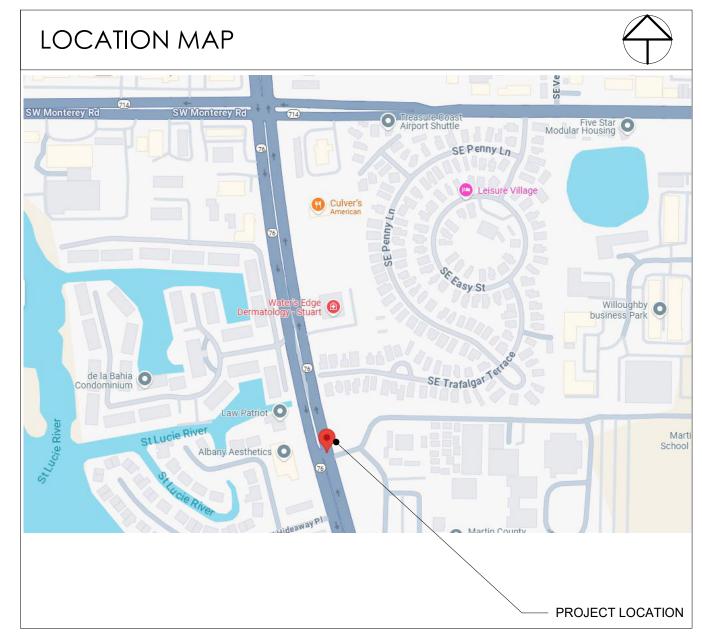

SHEET NAME

COVER SHEET
LIFE SAFETY PLAN
ACCESSIBILITY NOTES

DRAWINGS ISSUED

### GENERAL NOTES

- 1. THE CONSTRUCTION NOTES AND DRAWINGS ARE SUPPLIED TO ILLUSTRATE THE DESIGN AND GENERAL TYPE OF CONSTRUCTION DESIRED AND ARE INTENDED TO IMPLY THE FINEST QUALITY OF CONSTRUCTION, MATERIAL AND WORKMANSHIP THROUGHOUT.
- 2. ALL WORK SHALL BE IN COMPLIANCE WITH APPLICABLE FEDERAL, STATE AND LOCAL BUILDING CODES, REGULATIONS, ORDINANCES AND STANDARDS INCLUDING ADA AND OTHER HANDICAP ACCESSIBILITY CODES.
- 3. PRIOR TO COMMENCEMENT OF ANY CONSTRUCTION, CONTRACTOR SHALL VERIFY EXISTENCE AND LOCATION OF ALL ABOVE AND BELOW GRADE, UTILITIES, INCLUDING SANITARY SEWER, STORM SEWER, WATER, GAS, ELECTRICAL, TELEPHONE, ETC. ANY DISCREPANCIES IN UTILITY LOCATIONS SHALL BE BROUGHT TO THE IMMEDIATE ATTENTION OF THE ARCHITECT. GENERAL CONTRACTOR SHALL BE RESPONSIBLE FOR SET UP AND COORDINATION OF ALL UTILITY SERVICES FOR THE PROJECT.
- 4. GENERAL CONTRACTOR SHALL COORDINATE SCHEDULING AND SEQUENCING OF THE WORK WITH OWNER'S REPRESENTATIVE. GENERAL CONTRACTOR IS RESPONSIBLE FOR COORDINATING THE OWNER'S VENDORS ON SITE DURING CONSTRUCTION.
- 5. GENERAL CONTRACTOR SHALL PROVIDE AN AS-BUILT SET OF DRAWINGS TO THE [SUPERVISOR(PROJECT MANAGEMENT)] (SPM) AT THE END OF THE PROJECT.
- 6. GENERAL CONTRACTOR WILL SECURE ALL BUILDING PERMITS & INSPECTIONS NECESSARY FOR THE CONSTRUCTION OF THE PROJECT. UPON COMPLETION OF PROJECT, OBTAIN ALL FINAL INSPECTIONS AS REQUIRED BY LOCAL JURISDICTIONS AND FURNISH OWNER WITH EVIDENCE OF ALL SUCH INSPECTIONS AND CERTIFICATES OF OCCUPANCY.
- 7. THE GENERAL CONTRACTOR SHALL VERIFY ALL DIMENSIONS PRIOR TO BEGINNING CONSTRUCTION AND REPORT ANY ERRORS OR INCONSISTENCIES TO THE ARCHITECT.
- 8. THE DRAWINGS ARE NOT TO BE SCALED. LARGE SCALE DRAWINGS HAVE PRECEDENCE OVER SMALL SCALE DRAWINGS.
- 9. THE CONTRACTOR, WITHOUT EXTRA CHARGE, SHALL MAKE SLIGHT ALTERATIONS CUTTING, FITTING, OR PATCHING OF HIS WORK AS MAY BE NECESSARY TO MAKE ADJUSTABLE PARTS FIT TO FIXED PARTS, LEAVING ALL IN WORKING ORDER WHEN COMPLETED.
- 10. WHERE TRENCHING OR CORE DRILLING IS REQUIRED, SUBFLOORING AND/OR SUBSTRATE SHALL BE RETURNED TO A LEVEL CONDITION.
- 11. GENERAL CONTRACTOR SHALL PROVIDE TERMITE PROTECTION, TO COMPLY WITH FBC 1816.1, UNDER ANY TRENCHING WORK.
- 12. GENERAL CONTRACTOR IS RESPONSIBLE FOR ALL SITE CUT & FILL TO ATTAIN FINISH GRADES AS INDICATED ON THESE DRAWINGS. GENERAL CONTRACTOR SHALL INCLUDE THE COST OF ANY TOPSOIL REQUIRED IN ADDITION TO THAT ON SITE, AT THE TIME OF THE PRE-BID MEETING, IN BASE RID.
- 13. GENERAL CONTRACTOR TO BE RESPONSIBLE FOR SITE CLEAN UP NIGHTLY AND SECUREMENT OF THE WORK SITE.
- 14. ALL NEW CONSTRUCTION SHALL BE VERIFIED TO BE IN COMPLIANCE WITH THE LOCALLY ADOPTED ACCESSIBILITY REGULATIONS. ANYTHING FOUND NOT IN COMPLIANCE SHALL BE REPLACED AT THE CONTRACTOR'S EXPENSE. ALL SLOPES SHALL BE MEASURED WITH A 24" SMART LEVEL.
- 15. GENERAL CONTRACTOR SHALL PERFORM AS NECESSARY A TOPOGRAPHIC SURVEY PRIOR TO STARTING CONSTRUCTION AND REPORT ANY DISCREPANCIES IN GRADES AS COMPARED TO EXISTING GRADES INDICATED ON DRAWINGS. SUBMIT A COPY OF TOPOGRAPHIC SURVEY TO ARCHITECT AND INDICATE ANY DISCREPANCIES ON SURVEY PRIOR TO COMMENCING EARTHWORK WHEN SCOPE OF THE PROJECTS NECESSITATES IT.
- 16. NOTED ACCESSIBLE ITEMS AND DESCRIPTIONS FOR PARKING LOT, ARE TO BE A PORTION OF THE SHOWN ACCESSIBILITY WORK. COORDINATED WITH PROJECT MANAGER AS REQUIRED TO COMPLETE THE NOTED WORK. WHERE GRADES ARE AFFECTED THE CONTRACTOR SHALL USE A SURVEYOR AS NEEDED TO ENSURE PROPER GRADES ARE ACHIEVED. STRIPING SHALL BE COMPLETED PER THE REQUIREMENTS OF THE CURRENT ADAAG GUIDELINES, AND THE CUSTOMER PATH OF TRAVEL REMEDIATION GUIDELINES (LATEST REVISION) AS WELL AS APPLICABLE STATE AND LOCAL CODES.

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\-100 \-110	SLAB PLAN FLOOR PLAN	•							
4-110 4-120	DIMENSIONAL FLOOR PLAN	•							_
N-130	REFLECTED CEILING PLAN	•							
4-131 4-140	ENLARGED REFLECTED CEILING PLAN ROOF PLAN	•							$\dashv$
A-150	FINISH PLAN, LEGEND, AND NOTES	•							
4-170 4-190	FURNITURE & EQUIPMENT TRASH ENCLOSURE AND DETAILS	•					$\vdash\vdash$		$\dashv$
<b>A-200</b>	EXTERIOR ELEVATIONS	•							
A-201 A-202	EXTERIOR ELEVATIONS  COLOR ELEVATIONS	•					$\square$		$\overline{}$
A-203	COLOR ELEVATIONS	•							
A-300	BUILDING SECTIONS	•							
4-301 4-310	BUILDING SECTIONS  EXTERIOR WALL SECTIONS	•					$\vdash$		$\dashv$
A-311	EXTERIOR WALL SECTIONS	•							
4-312 4-400	WALL SECTIONS ENLARGED FLOOR PLAN	•							$\overline{}$
A-401	ENLARGED FLOOR PLAN	•							
A-402	PLAN DETAILS	•							$\Box$
4-403 4-404	PLAN DETAILS ENLARGED FLOOR PLANS & DETAILS	•							$\dashv$
<b>A-406</b>	BANK EQUIPMENT CUT SHEETS	•							
A-410	ENLARGED RESTROOM PLANS, ELEVATIONS, & DETAILS	•							$\blacksquare$
4-440 4-450	ROOF DETAILS WALL SECTION DETAILS	•					$\vdash$		$\dashv$
4-600	DOOR SCHEDULE & DETAILS	•							
A-610 A-611	WINDOWS SCHEDULE & DETAILS STOREFRONT DETAILS	•							$\dashv$
4-611 4-620	INTERIOR PARTITION SCHEDULE & DETAILS	•							$\dashv$
A-630	CEILING SCHEDULE & DETAILS	•							
A-700 A-701	TRANSACTION BAR - ENLARGED PLAN & DETAILS  BACK COUNTER - ENLARGED PLAN & DETAILS	•					$\square$		$\dashv$
A-701	LIBRARY - ENLARGED PLAN & DETAILS	•							
A-703	SERVICE COUNTER - ENLARGED PLAN & DETAILS	•							
A-704 A-705	TECH WALL - ENLARGED PLAN & DETAILS  EMPLOYEE LOUNGE - ENLARGED PLAN & DETAILS	•							$\dashv$
A-706	BOOTH - ENLARGED PLAN & DETAILS	•							
A-707	BOOTH - DETAILS	•							$\Box$
A-708 A-709	WORK ROOM - ENLARGED PLAN & DETAILS CHECK DESK - ENLARGED PLAN & DETAILS	•							_
STRUCTURA									
S-101 S-102	GENERAL NOTES	•							
S-102 S-103	COMPONENTS & CLADDING SPECIAL INSPECTIONS	•					H		-
S-104	SPECIAL INSPECTIONS	•							
S-201 S-211	BRANCH FOUNDATION AND FLOOR PLAN BRANCH ROOF FRAMING PLAN	•							$\overline{}$
S-301	FOUNDATION SECTIONS	•							
S-311	ROOF SECTIONS	•							
S-312 S-401	ROOF SECTIONS TYPICAL DETAILS	•							
S-402	TYPICAL DETAILS	•							
S-403 S-404	TYPICAL DETAILS TYPICAL DETAILS	•							$\dashv$
S-404 S-405	TYPICAL DETAILS  TYPICAL DETAILS	•					H		$\exists$
MECHANICA						· I			_
M-001 M-002	MECHANICAL NOTES AND SPECIFICATIONS  MECHANICAL NOTES AND LEGEND	•					$\square$		-
M-101	MECHANICAL SCHEDULES	•							
M-102	MECHANICAL COMOUNCIE PEROPE	•							
M-103 M-301	MECHANICAL COMCHECK REPORT  MECHANICAL PROPOSED CEILING PLAN	•							$\dashv$
VI-302	MECHANICAL PROPOSED ROOF PLAN	•							
M-401 M-501	MECHANICAL ISOMETRIC PLAN MECHANICAL DETAILS	•					oxdot		$\dashv$
M-501 M-502	MECHANICAL DETAILS MECHANICAL DETAILS AND SEQUENCE	•							$\dashv$
M-503	MECHANICAL CONTROLS CUTSHEETS	•							#
M-504 PLUMBING	MECHANICAL IOT CUTSHEETS	•							
P-001	PLUMBING SPECIFICATIONS AND NOTES	•							
P-101	PLUMBING TABLES AND SCHEDULES	•							_
P-301 P-302	PLUMBING PROPOSED FOUNDATION PLAN PLUMBING PROPOSED FLOOR PLAN	•					$\vdash$		$\dashv$
P-303	PLUMBING PROPOSED ROOF PLAN	•							
P-401	PLUMBING ISOMETRIC RISER DIAGRAM	•							1
P-402 P-501	PLUMBING BUILDING ISOMETRIC PLUMBING DETAILS	•					$\vdash$		$\dashv$
ELECTRICAL									
E-001 E-002	ELECTRICAL LEGEND AND ABBREVIATION ELECTRICAL GENERAL NOTES	•							$\dashv$
E-002 E-003	ELECTRICAL SPECIFICATIONS	•					H		
E-004	COMMCHECK	•							
E-100 E-101	ELECTRICAL POWER & AUXILIARY PLAN ELECTRICAL POWER ROOF PLAN	•							$\dashv$
E-130	ELECTRICAL LIGHTING PLAN	•							
E-150	ELECTRICAL SECURITY PLAN	•					П		1
E-500 E-600	ELECTRICAL DETAILS LUMINAIRE AND SENSOR SCHEDULES AND DETAILS	•					Н		$\dashv$
E-601	EXTERIOR LIGHTING CUTSHEETS	•							$\exists$
E-602 E-603	EXTERIOR LIGHTING CUTSHEETS  EXTERIOR LIGHTING CUTSHEETS	•							$\dashv$
E-603 E-610	ELECTRICAL PANEL SCHEDULES	•							$\dashv$
E-700	ELECTRICAL DEVICE PLAN	•							
E-701 E-702	ELECTRICAL ELEVATIONS ELECTRICAL ELEVATIONS	•							$\dashv$
E-702 E-703	ELECTRICAL ELEVATIONS ELECTRICAL ELEVATIONS	•					Н		$\dashv$
E-704	ELECTRICAL ELEVATIONS	•							
E-800 FIRE ALARM	ELECTRICAL RISER DIAGRAM	•					Ш		
FA-001	FIRE ALARM LEGEND AND GENERAL NOTES	•							
FA-002	FIRE ALARM RISER & DETAILS	•							=
FA-101	FIRE ALARM PLAN	•					ш		



DRAWINGS ISSUED

 400 N Ashley Drive,
 P: 813 - 323 - 9233

 Suite. 600
 Lic. #: AA - 0003590

 Tampa, FL 33602
 W: www.bdgllp.com

FIFTH THIRD

### I THIRD BANK LACE AT KANNEF

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PROJECT INFORMATION BLOCK

JOB # 230651

DATE: 03/24/25

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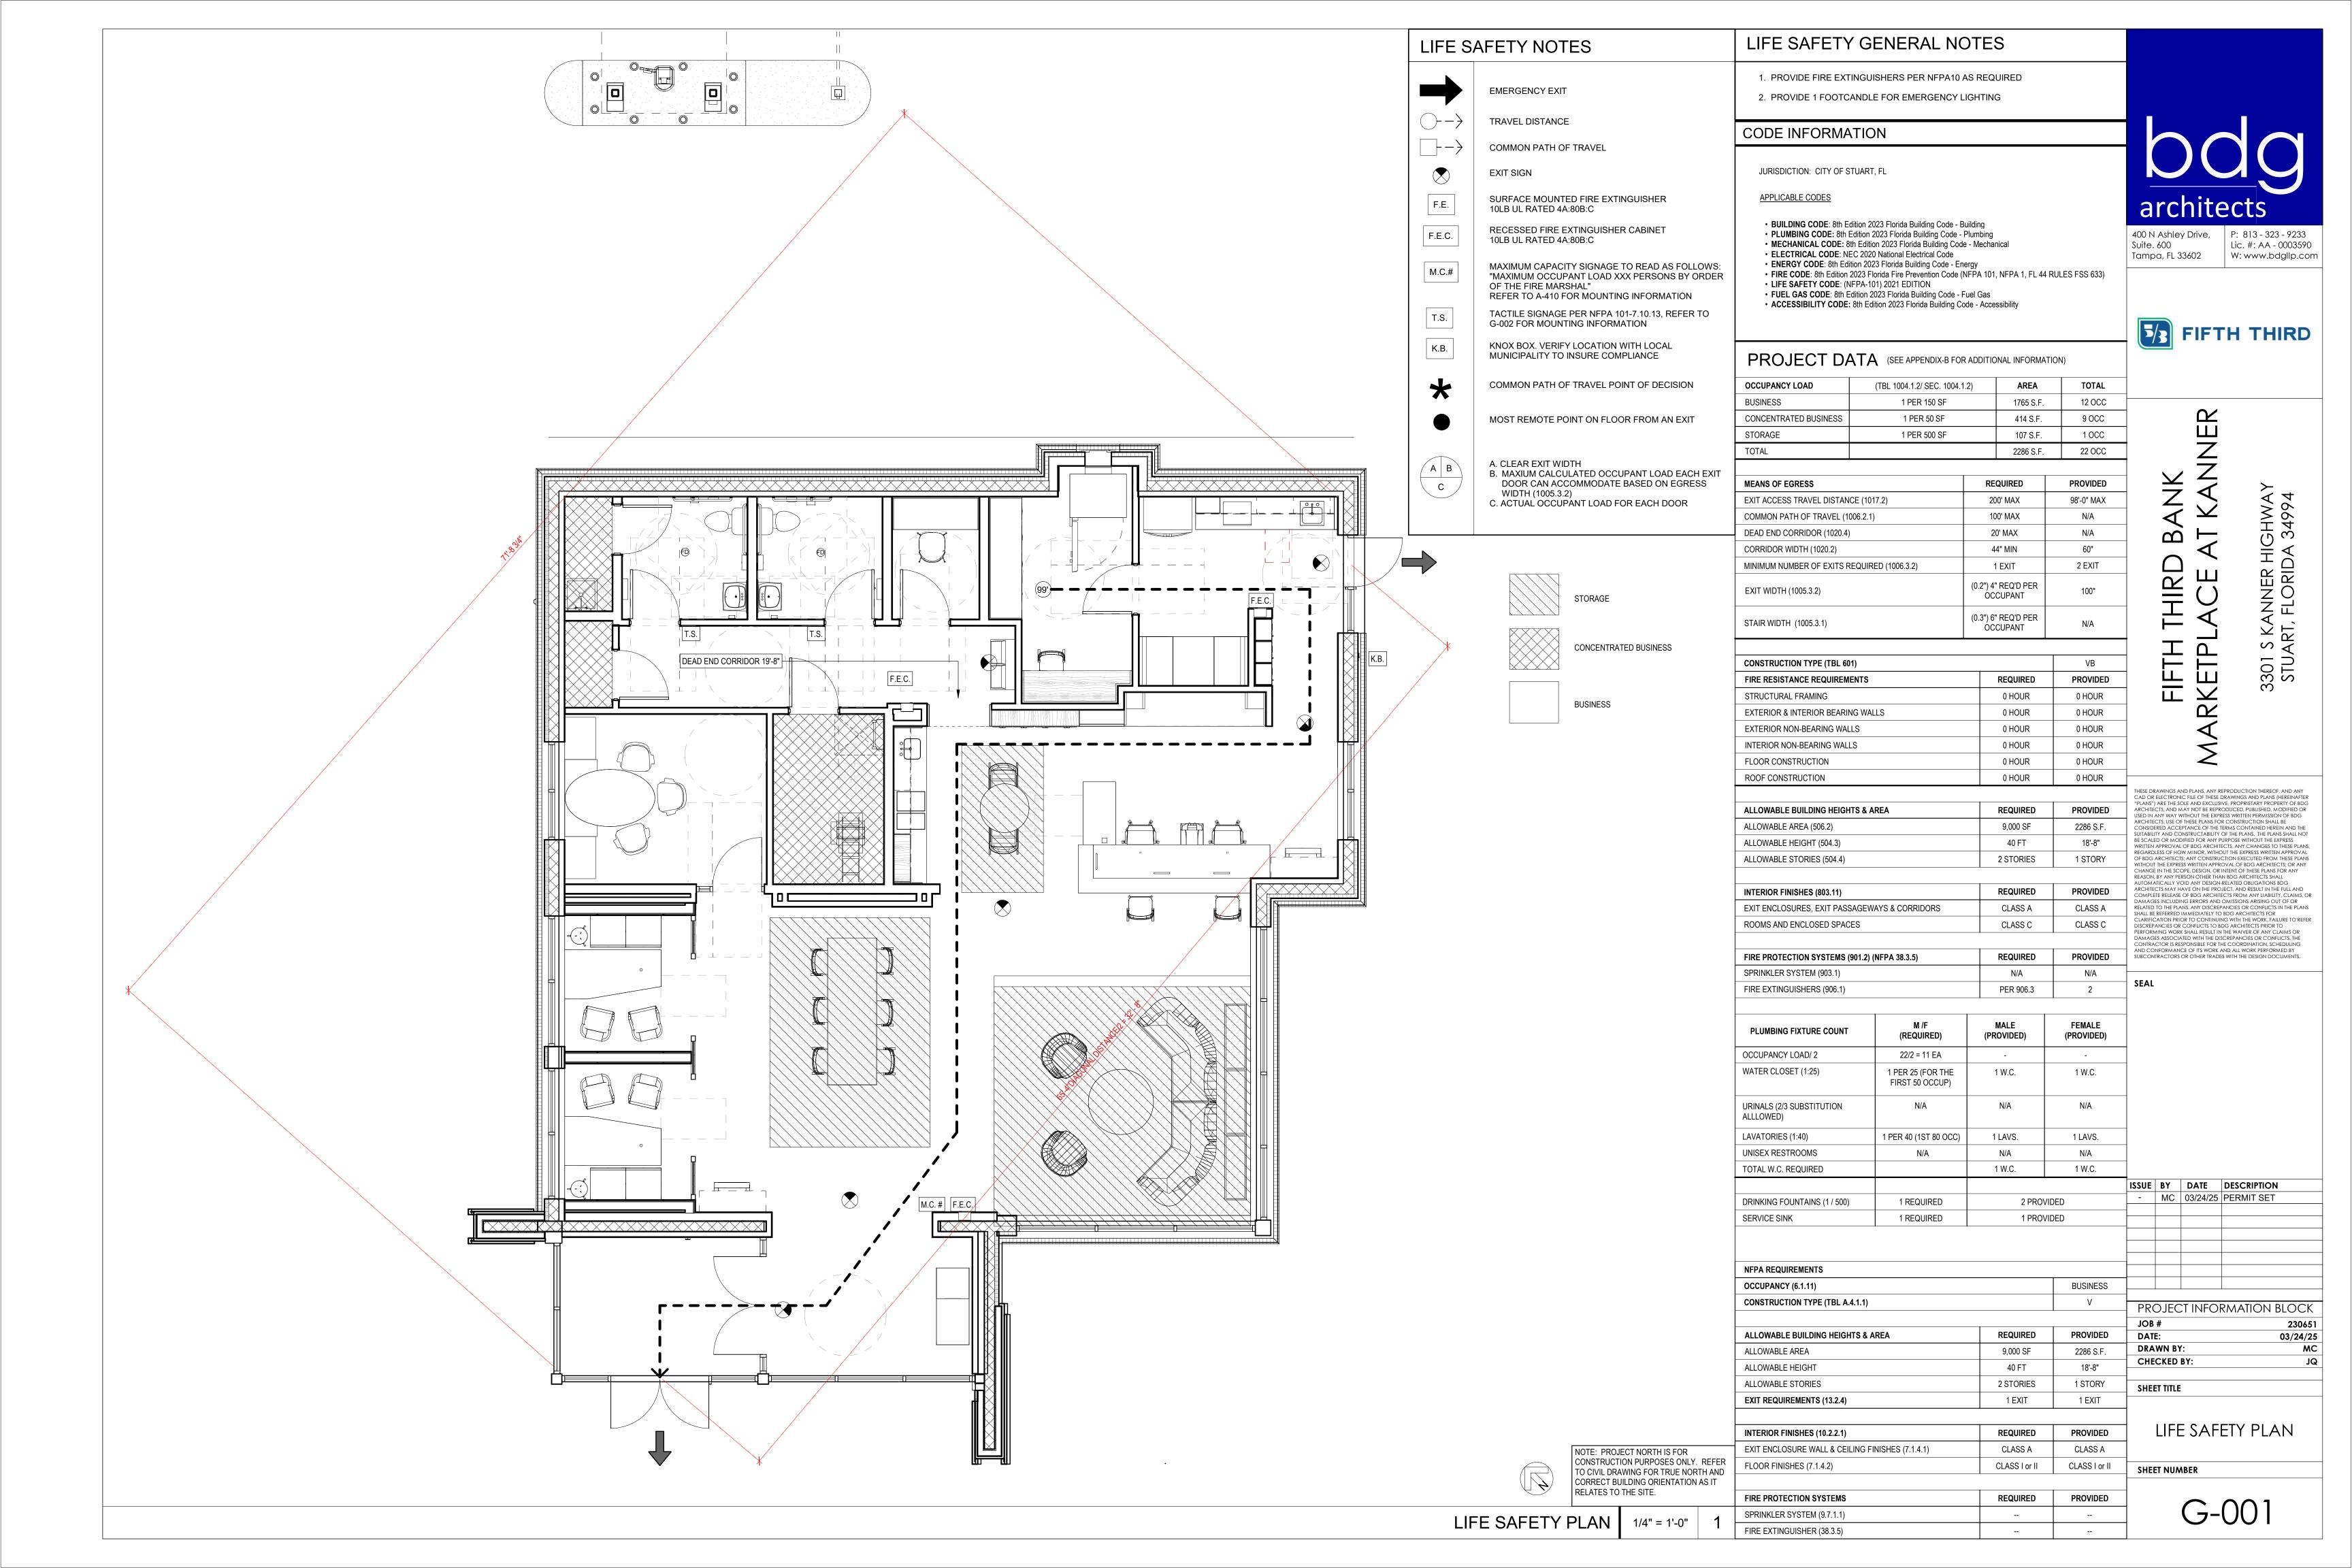
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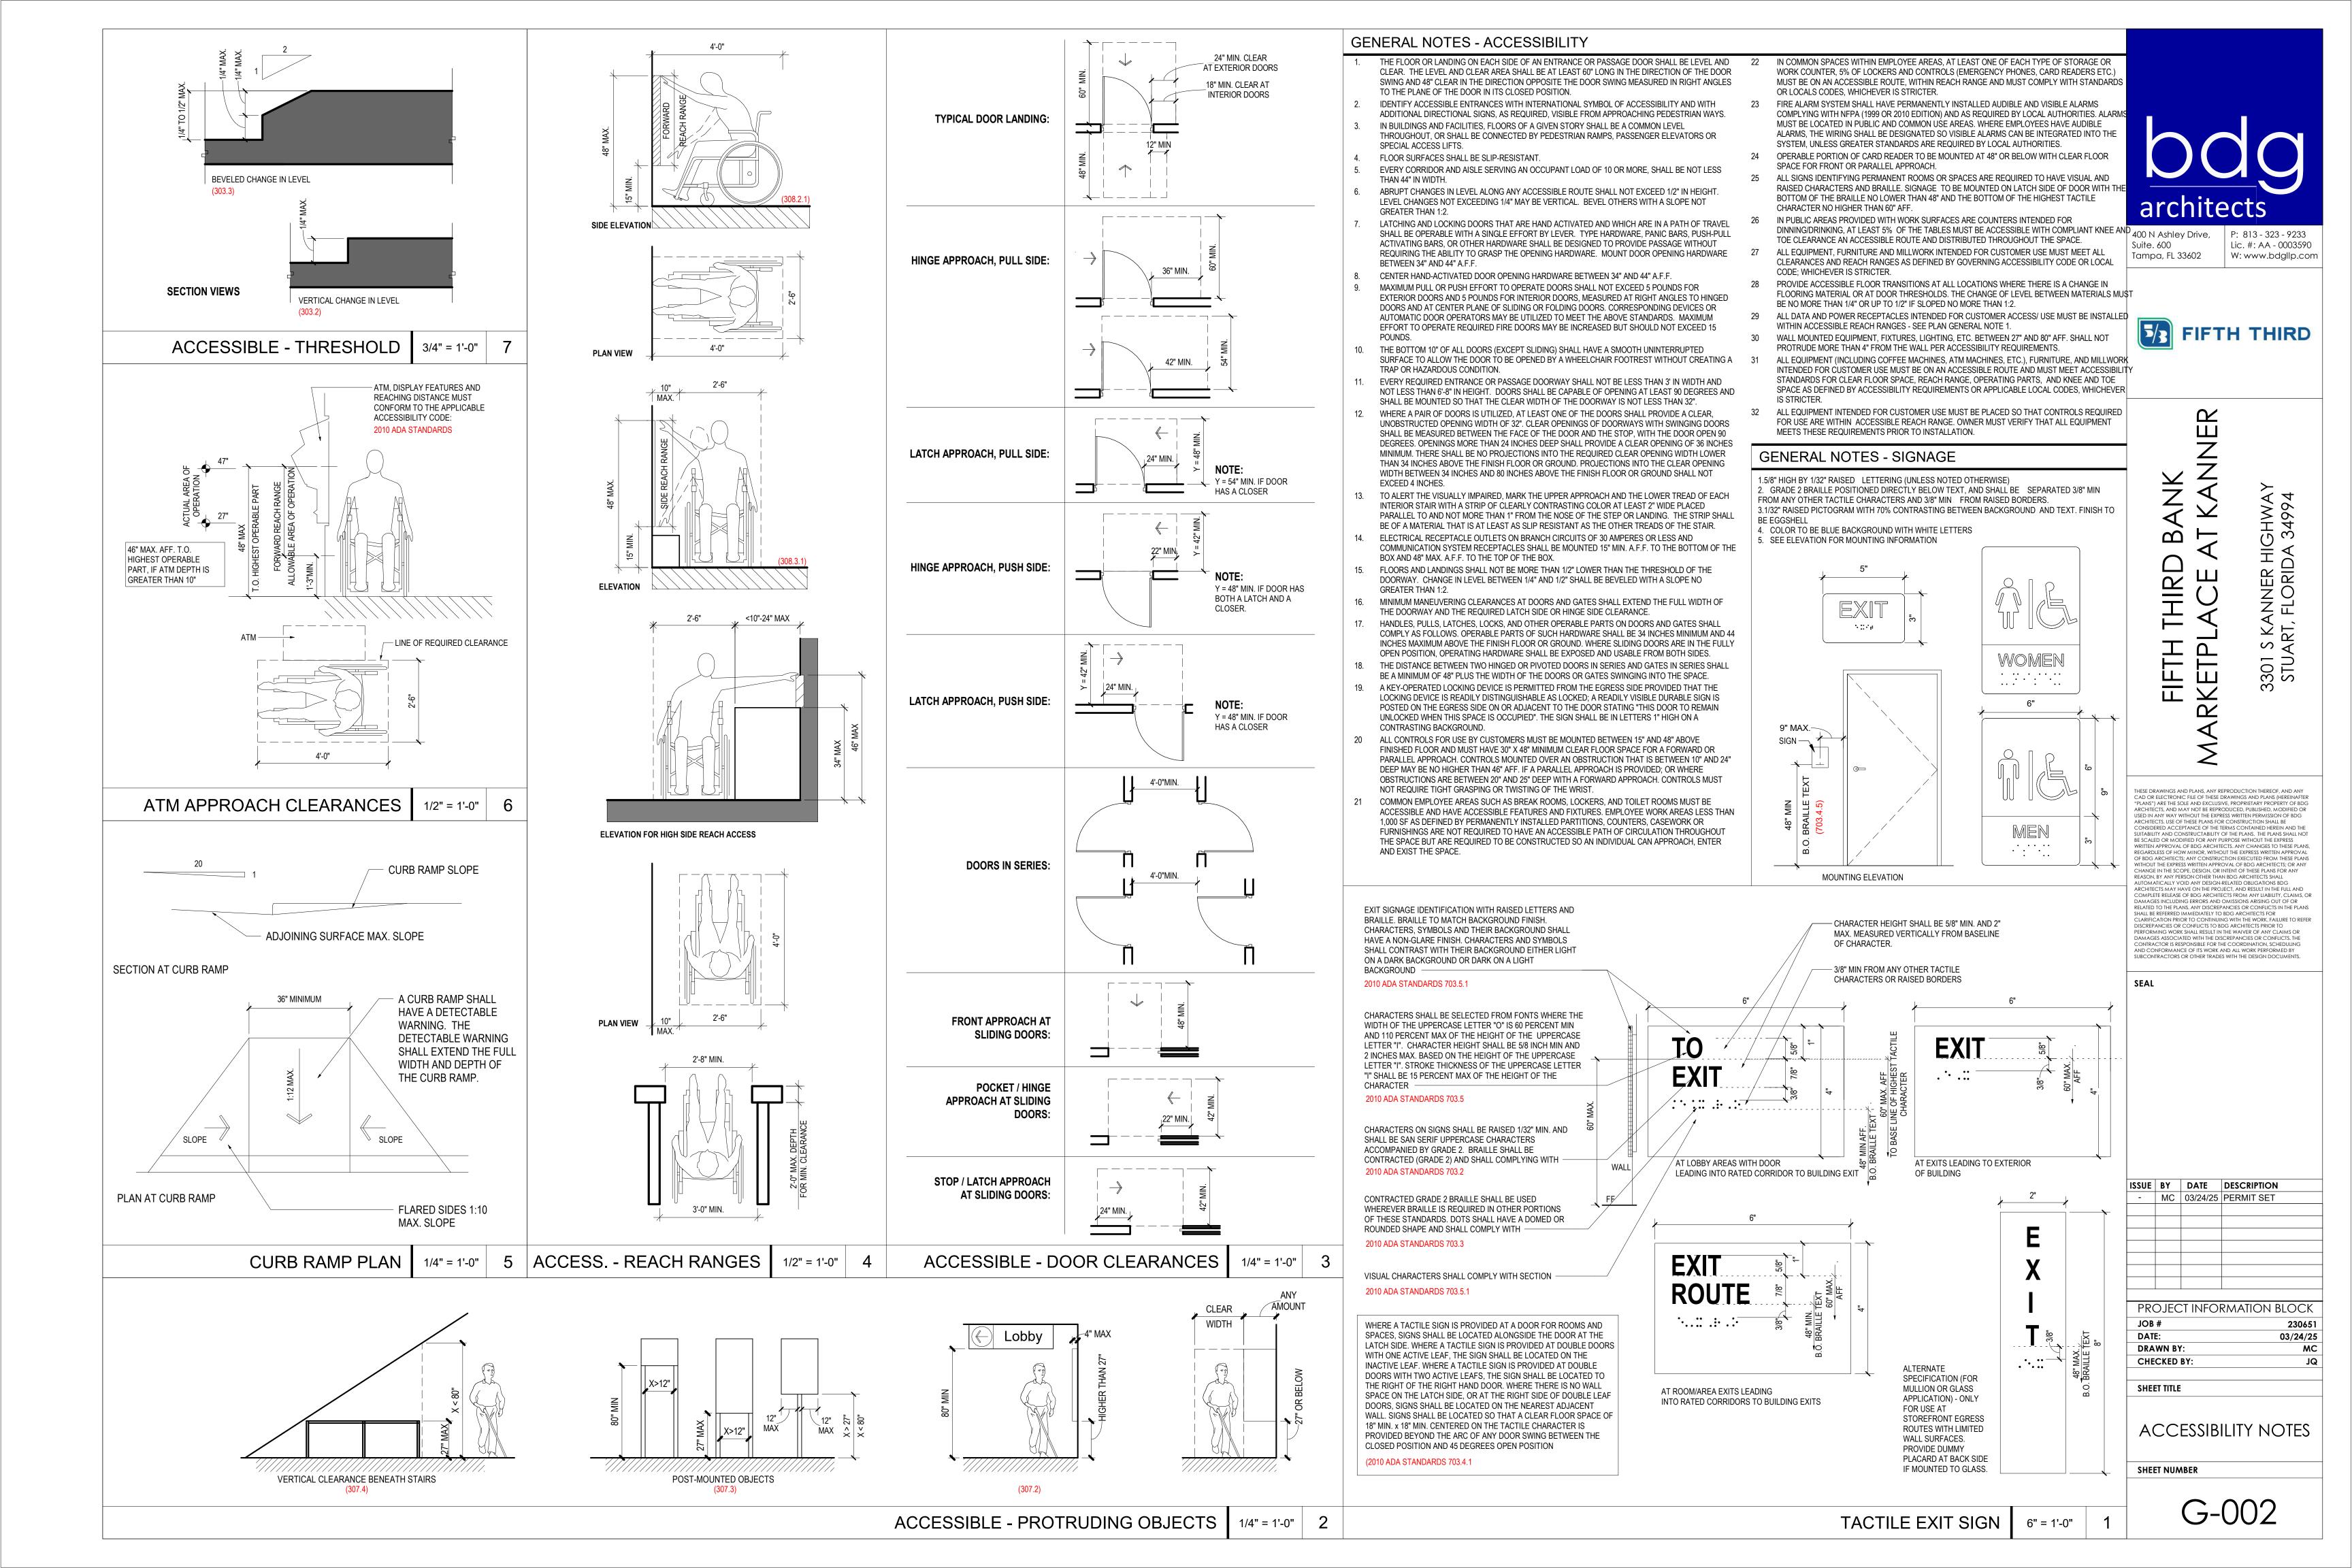
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FIFTH THIRD

## D BANK AT KANNER

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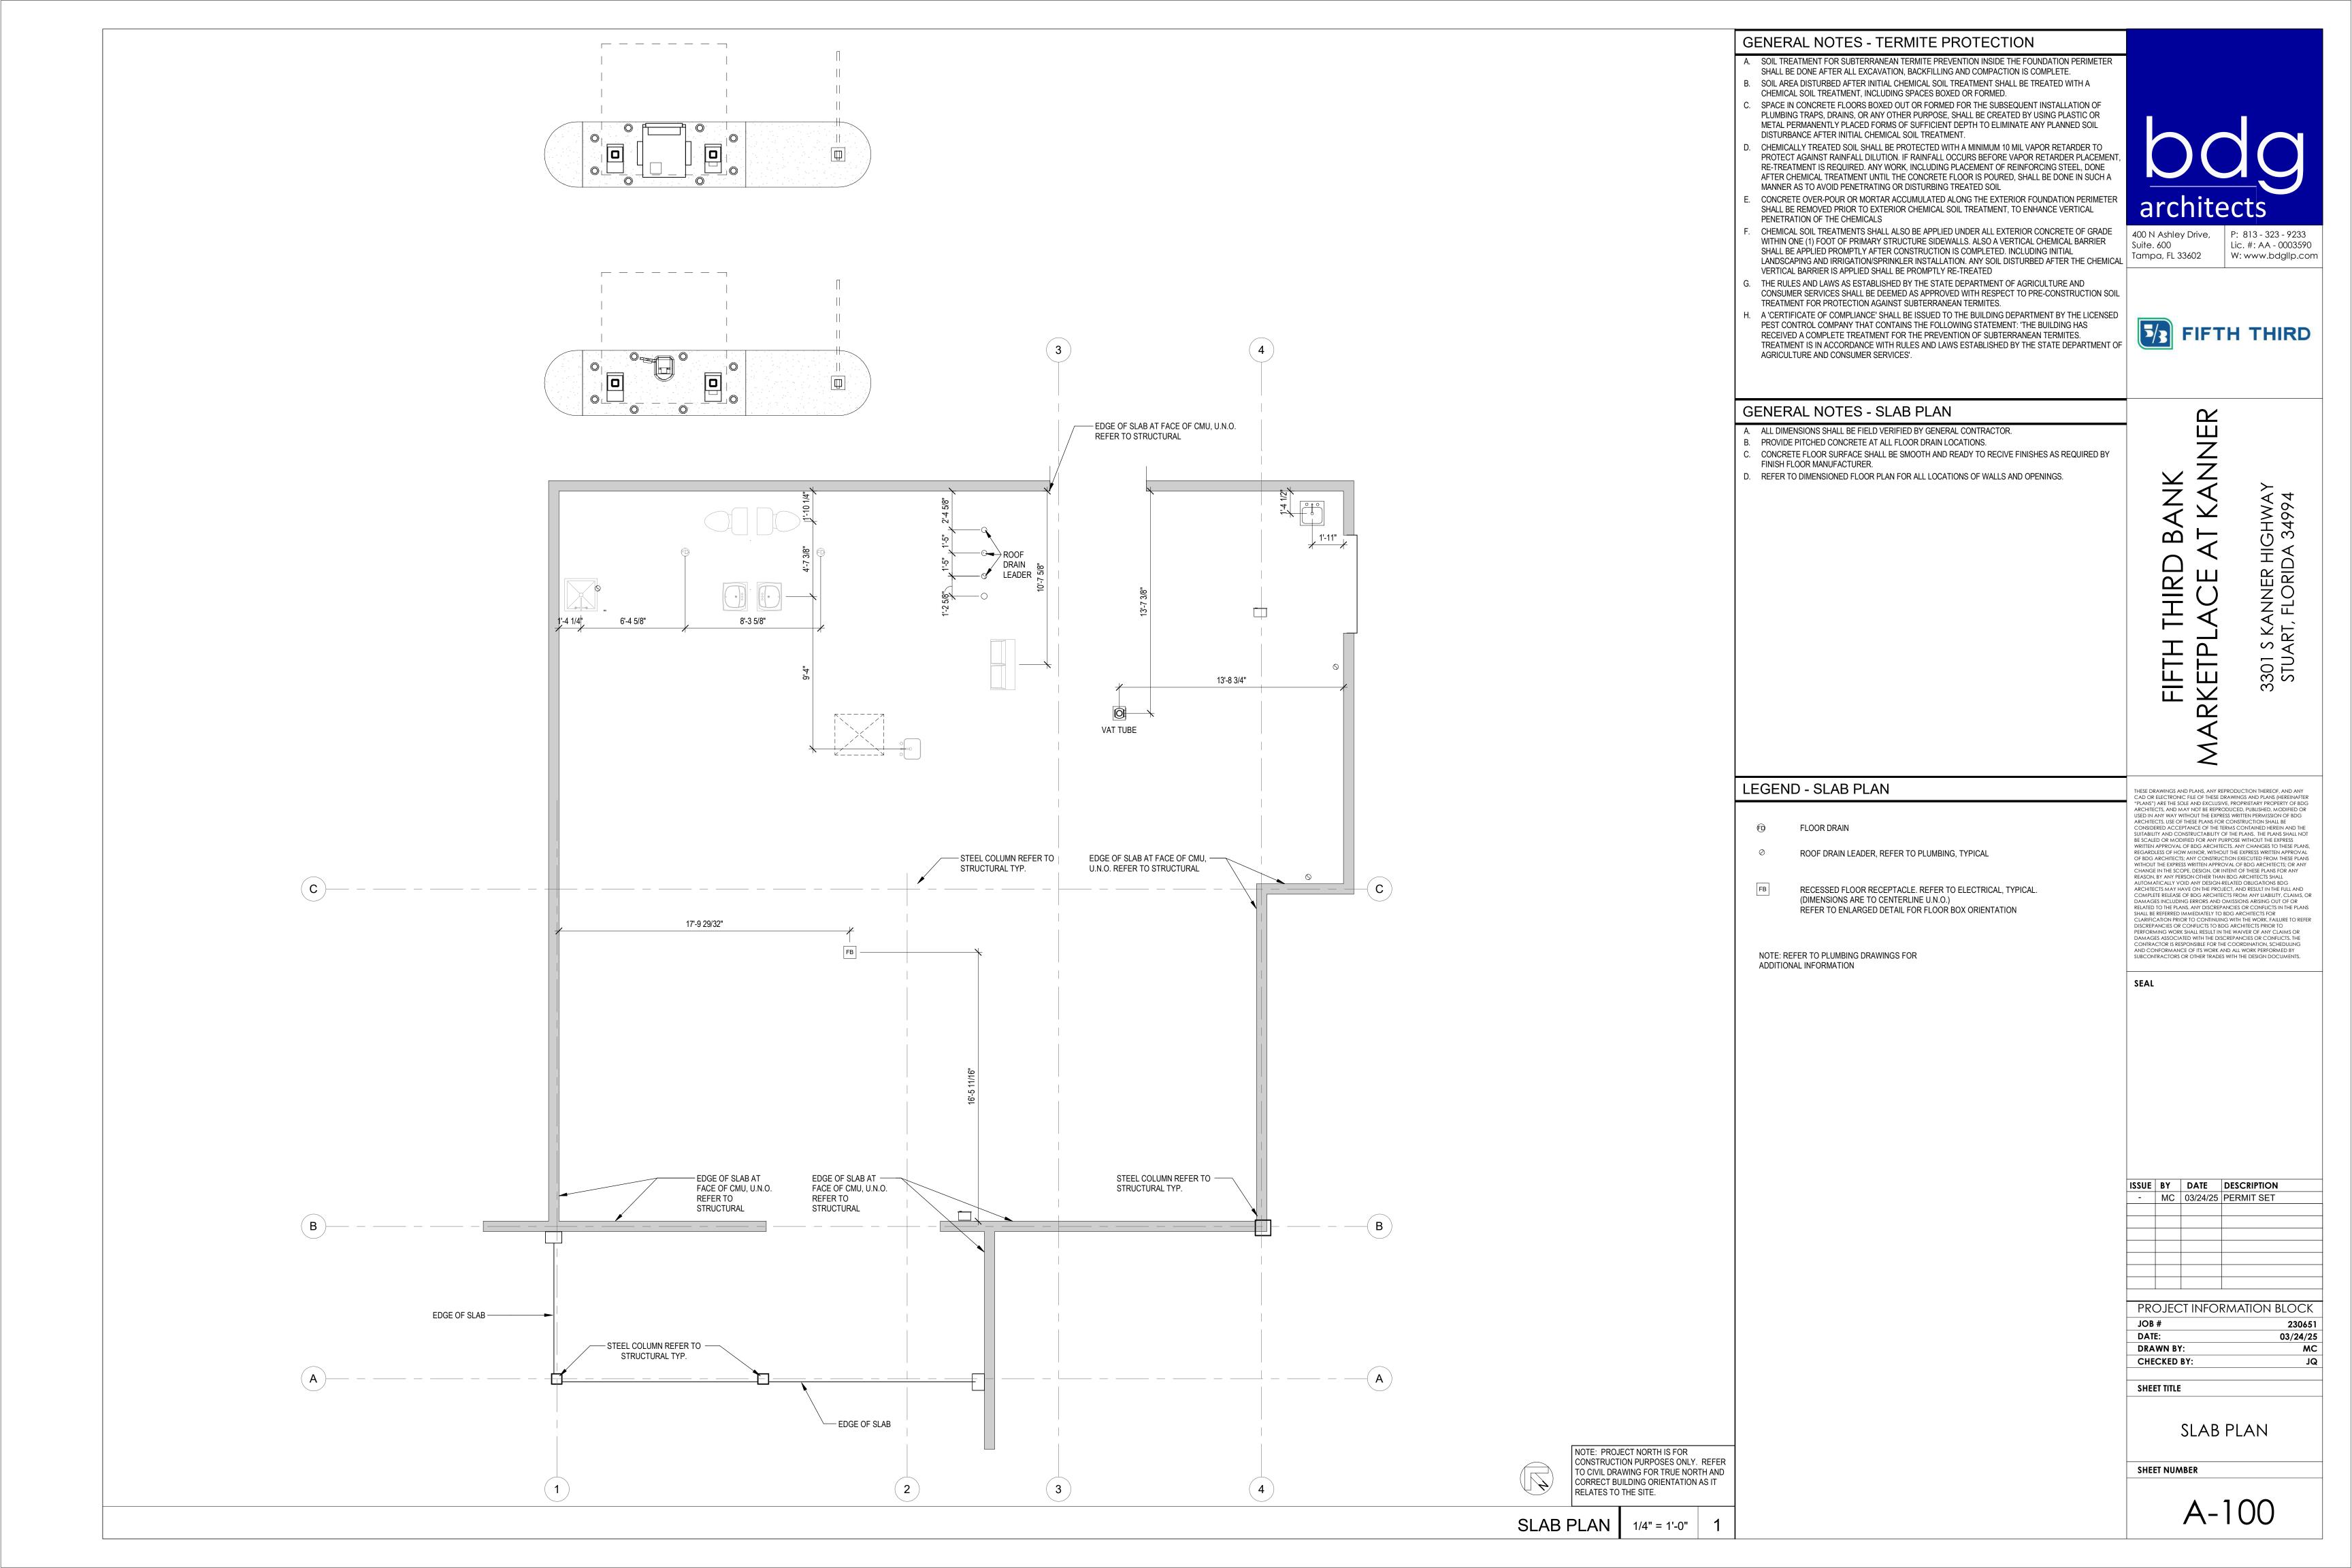
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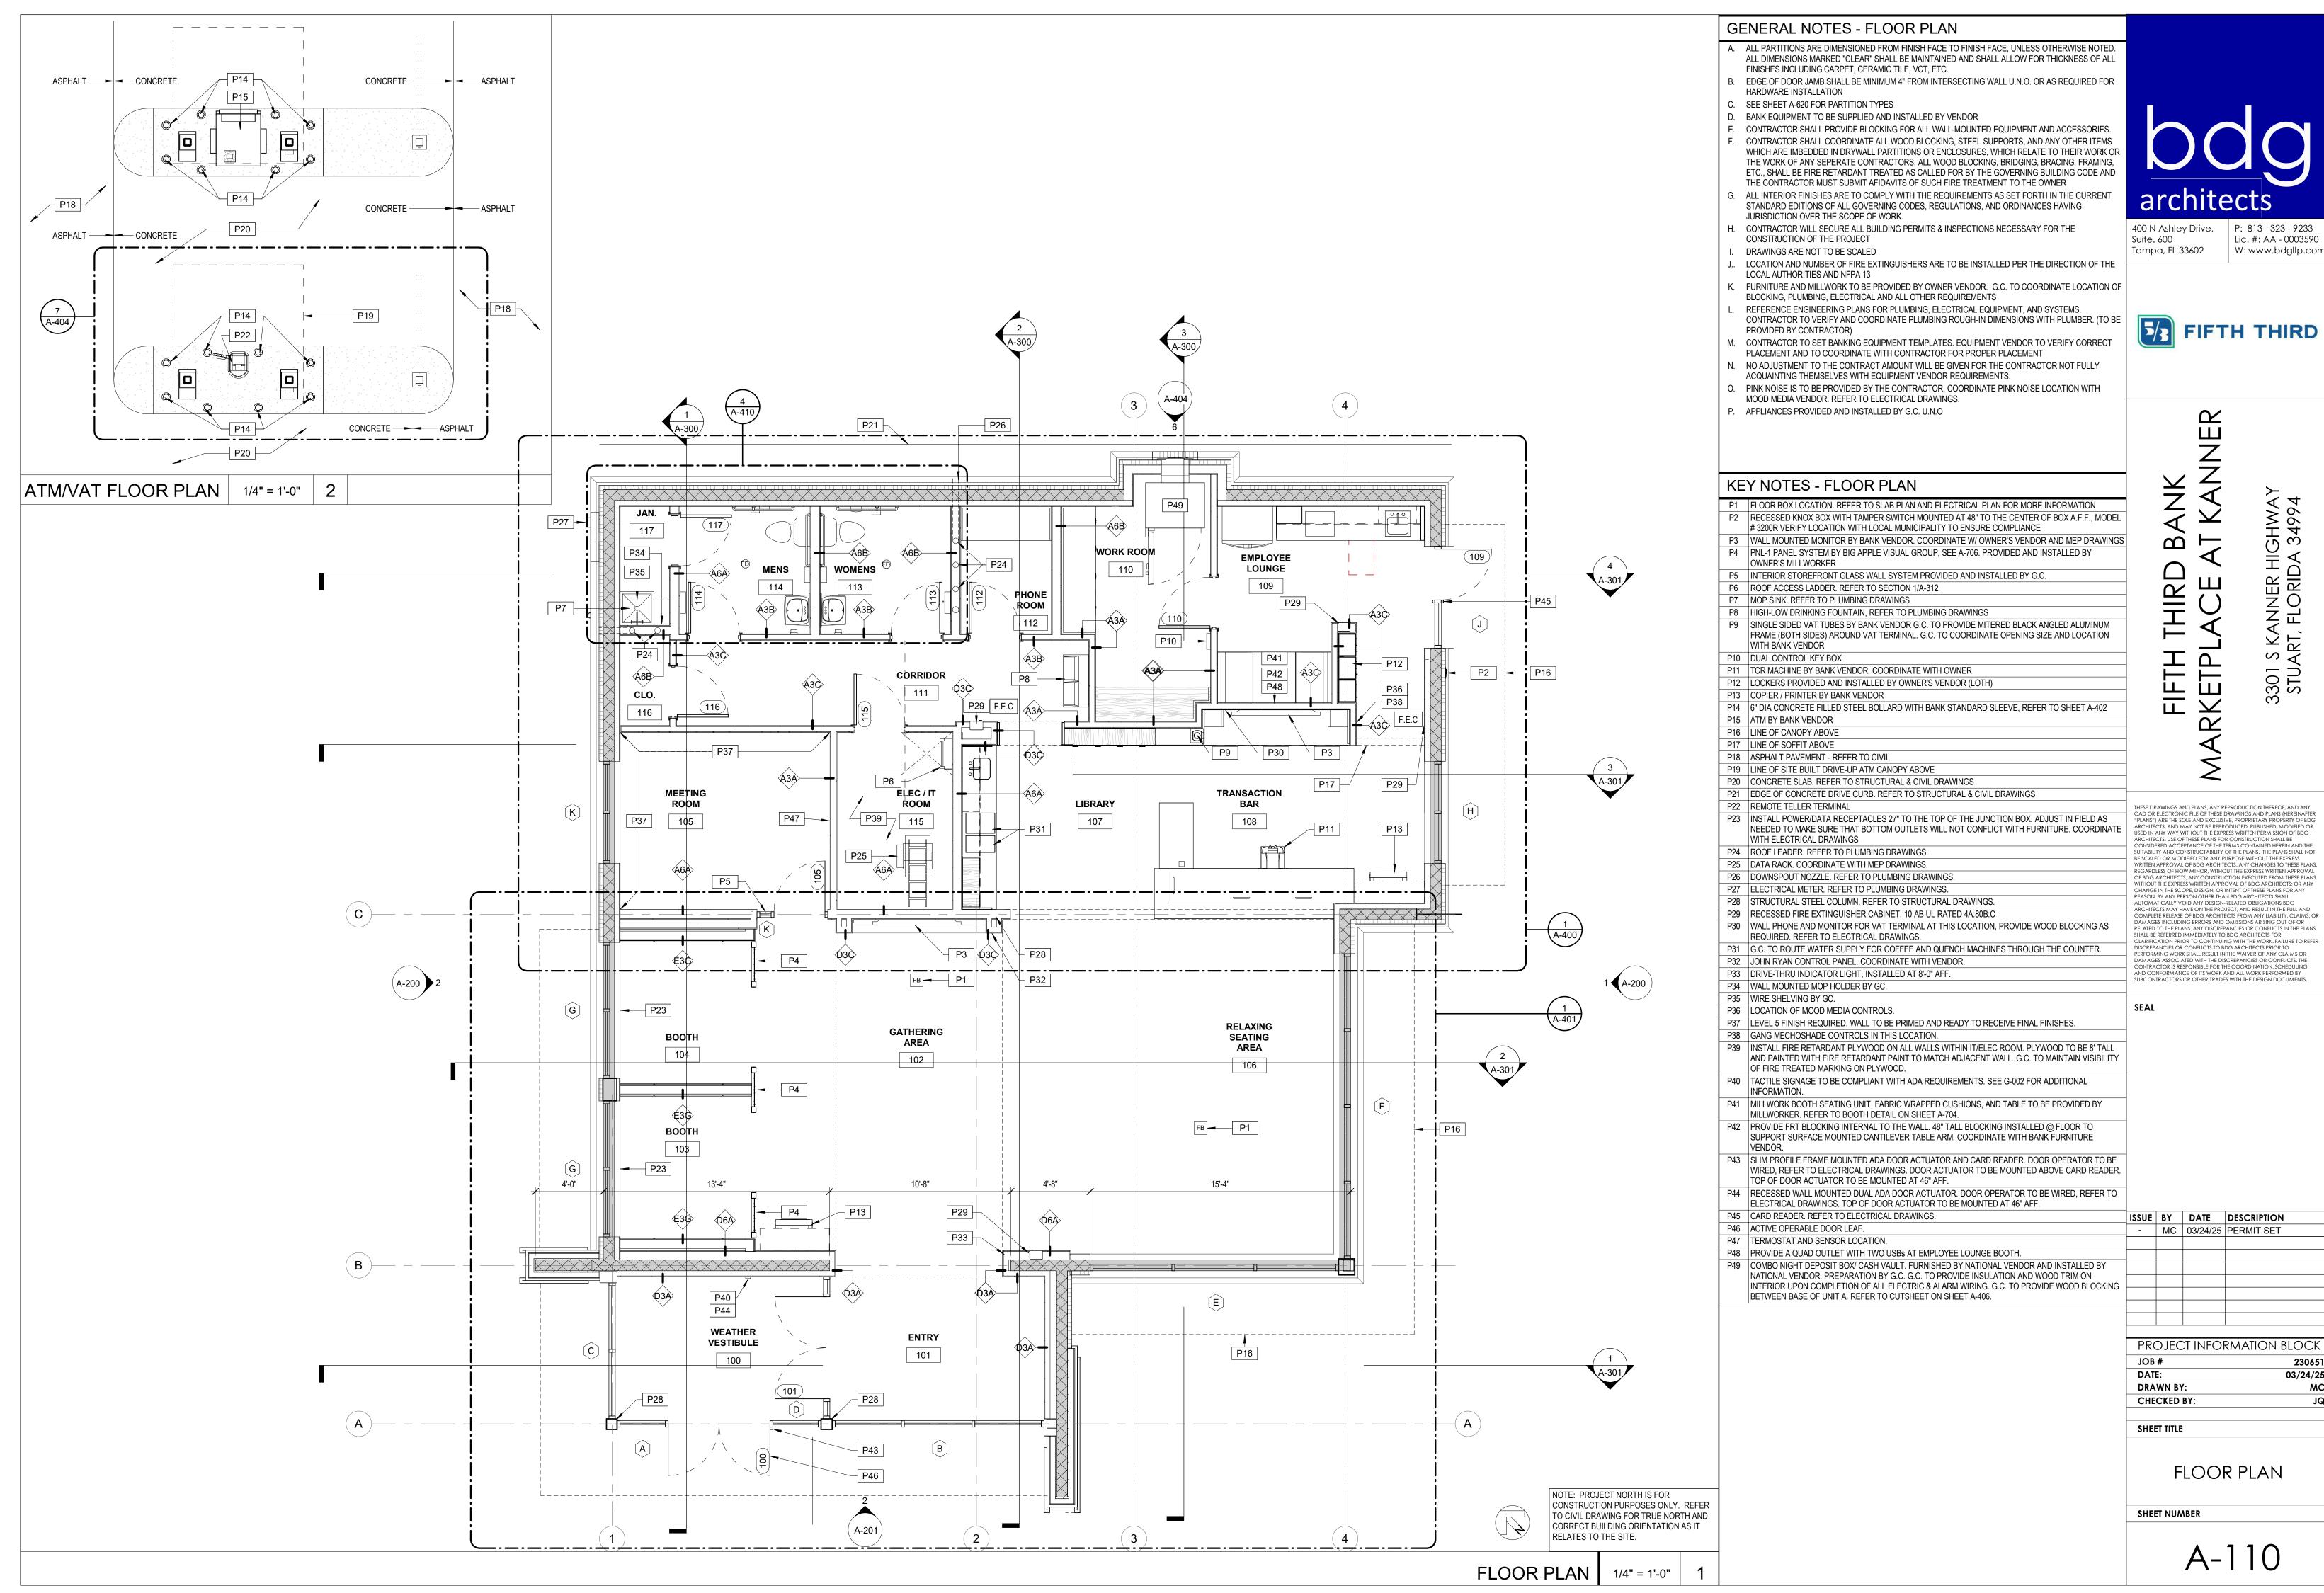
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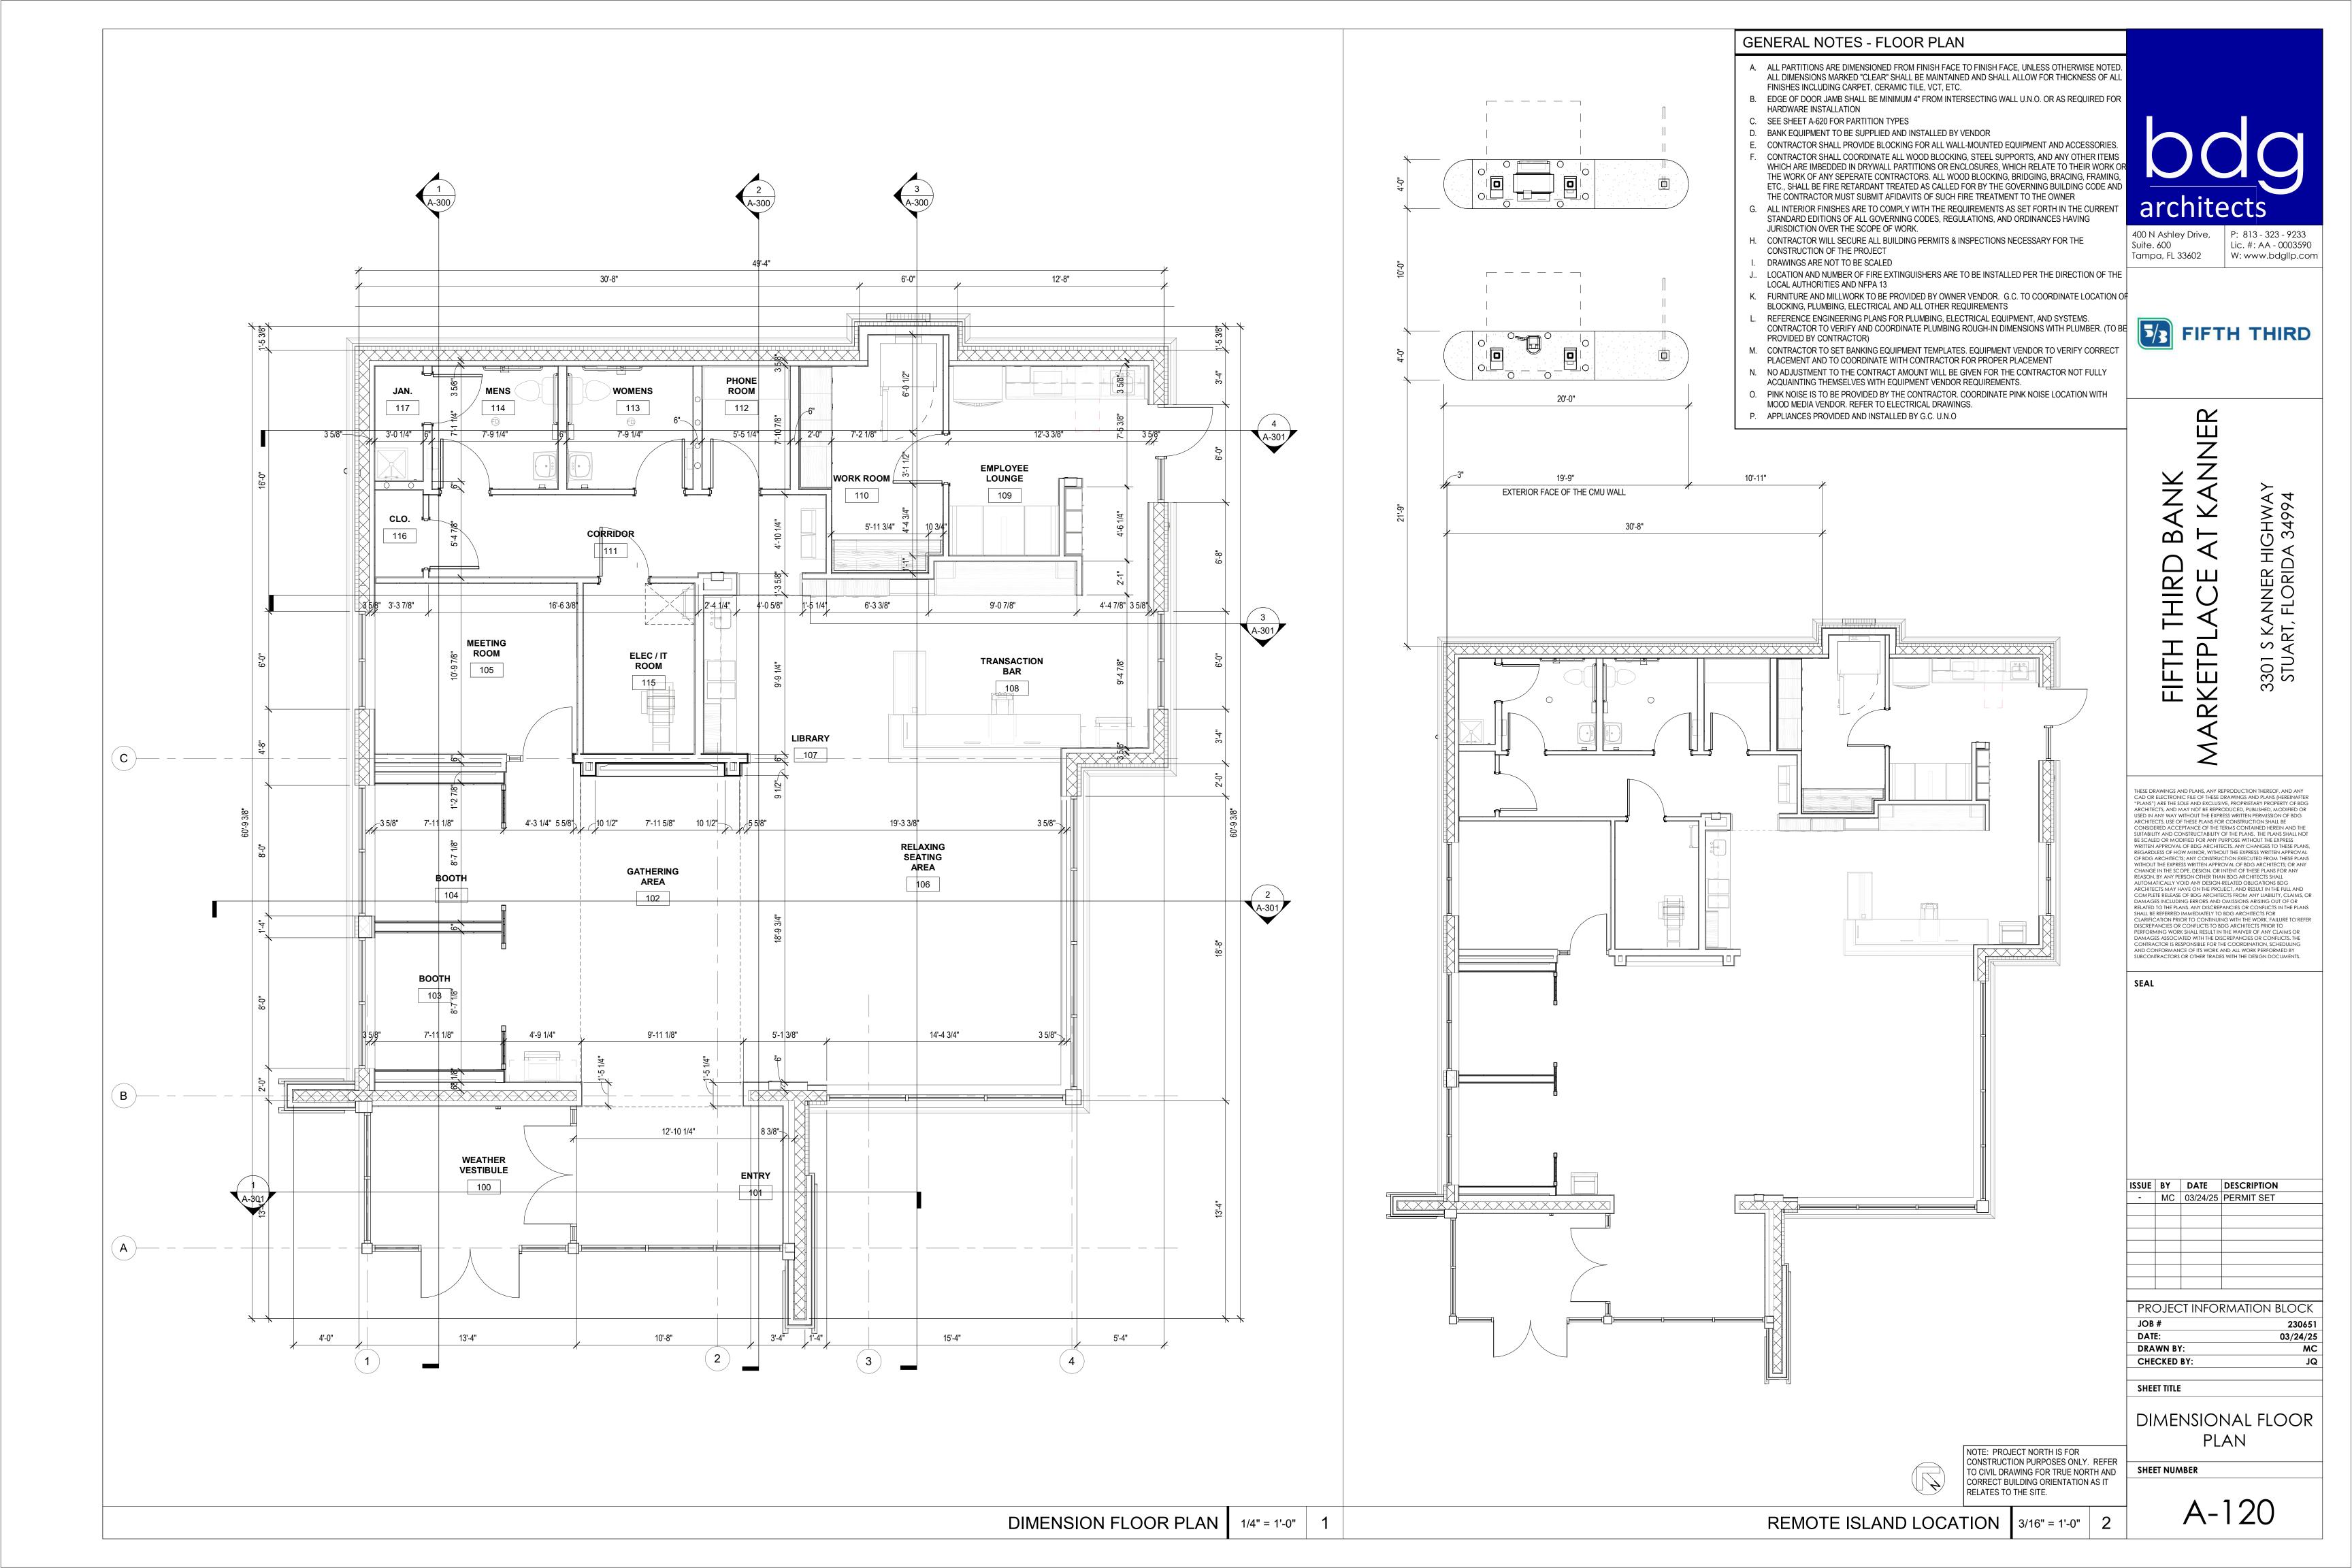
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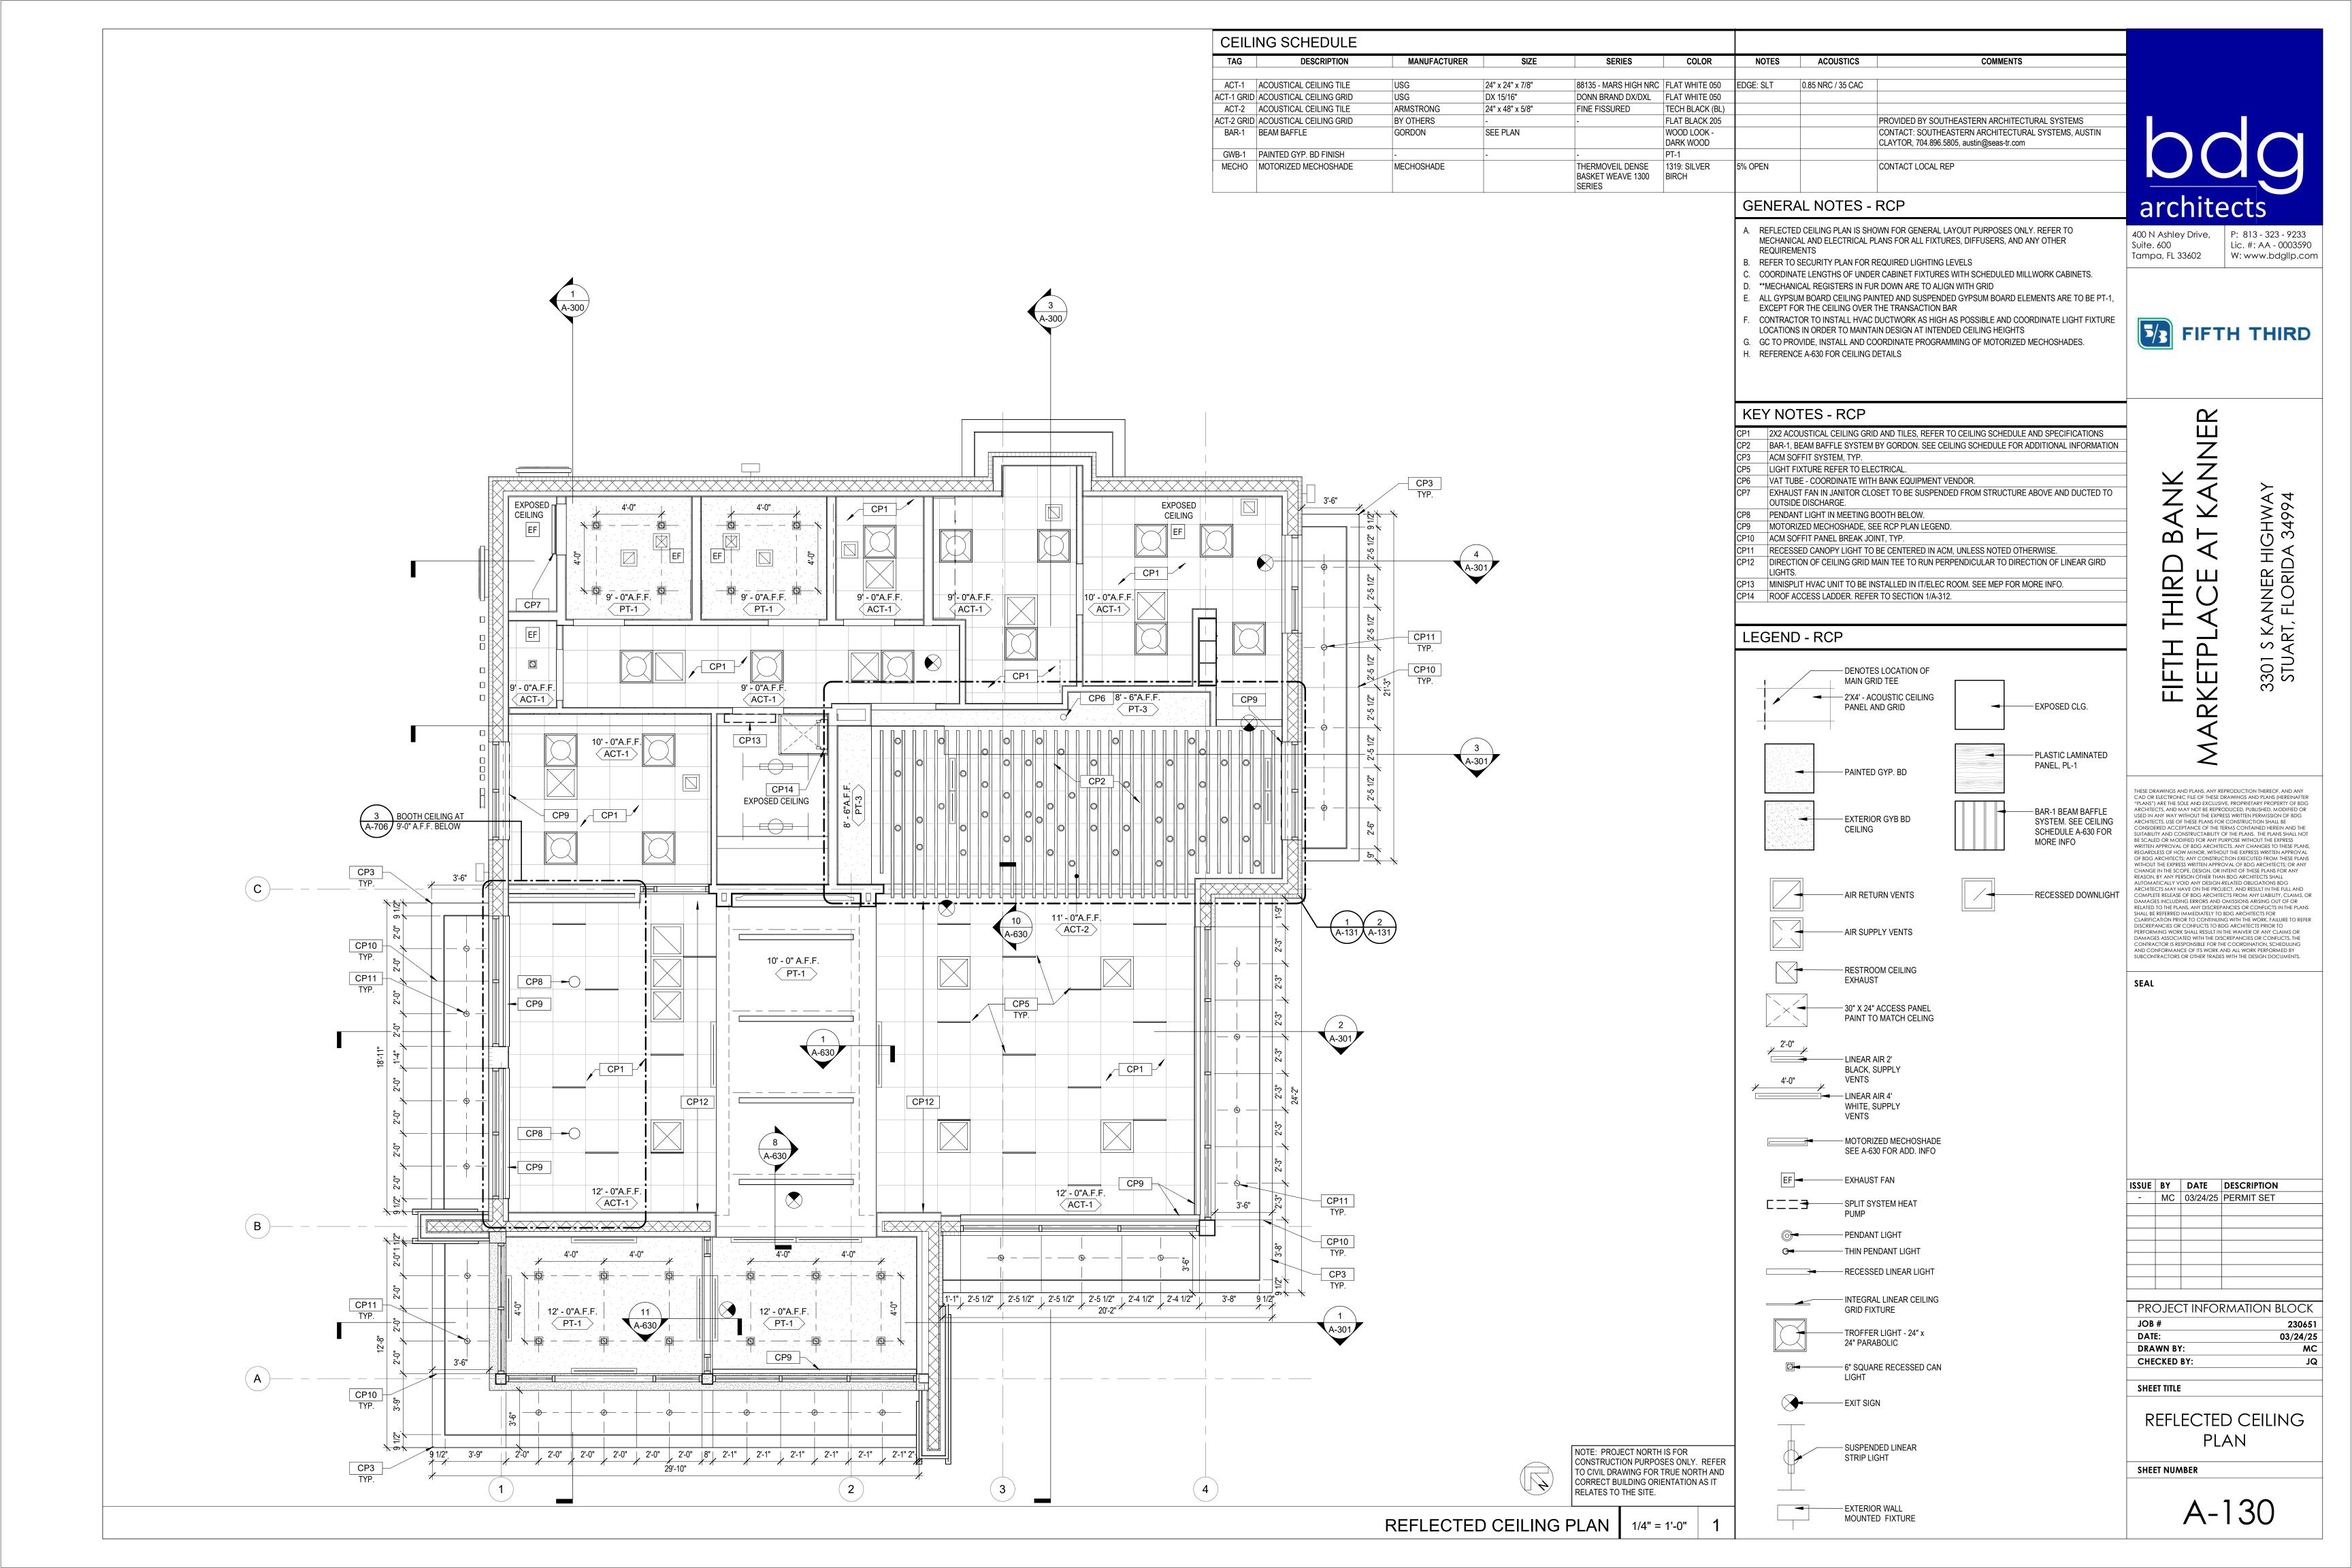






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PROJECT INFORMATION BLOCK 230651 03/24/25







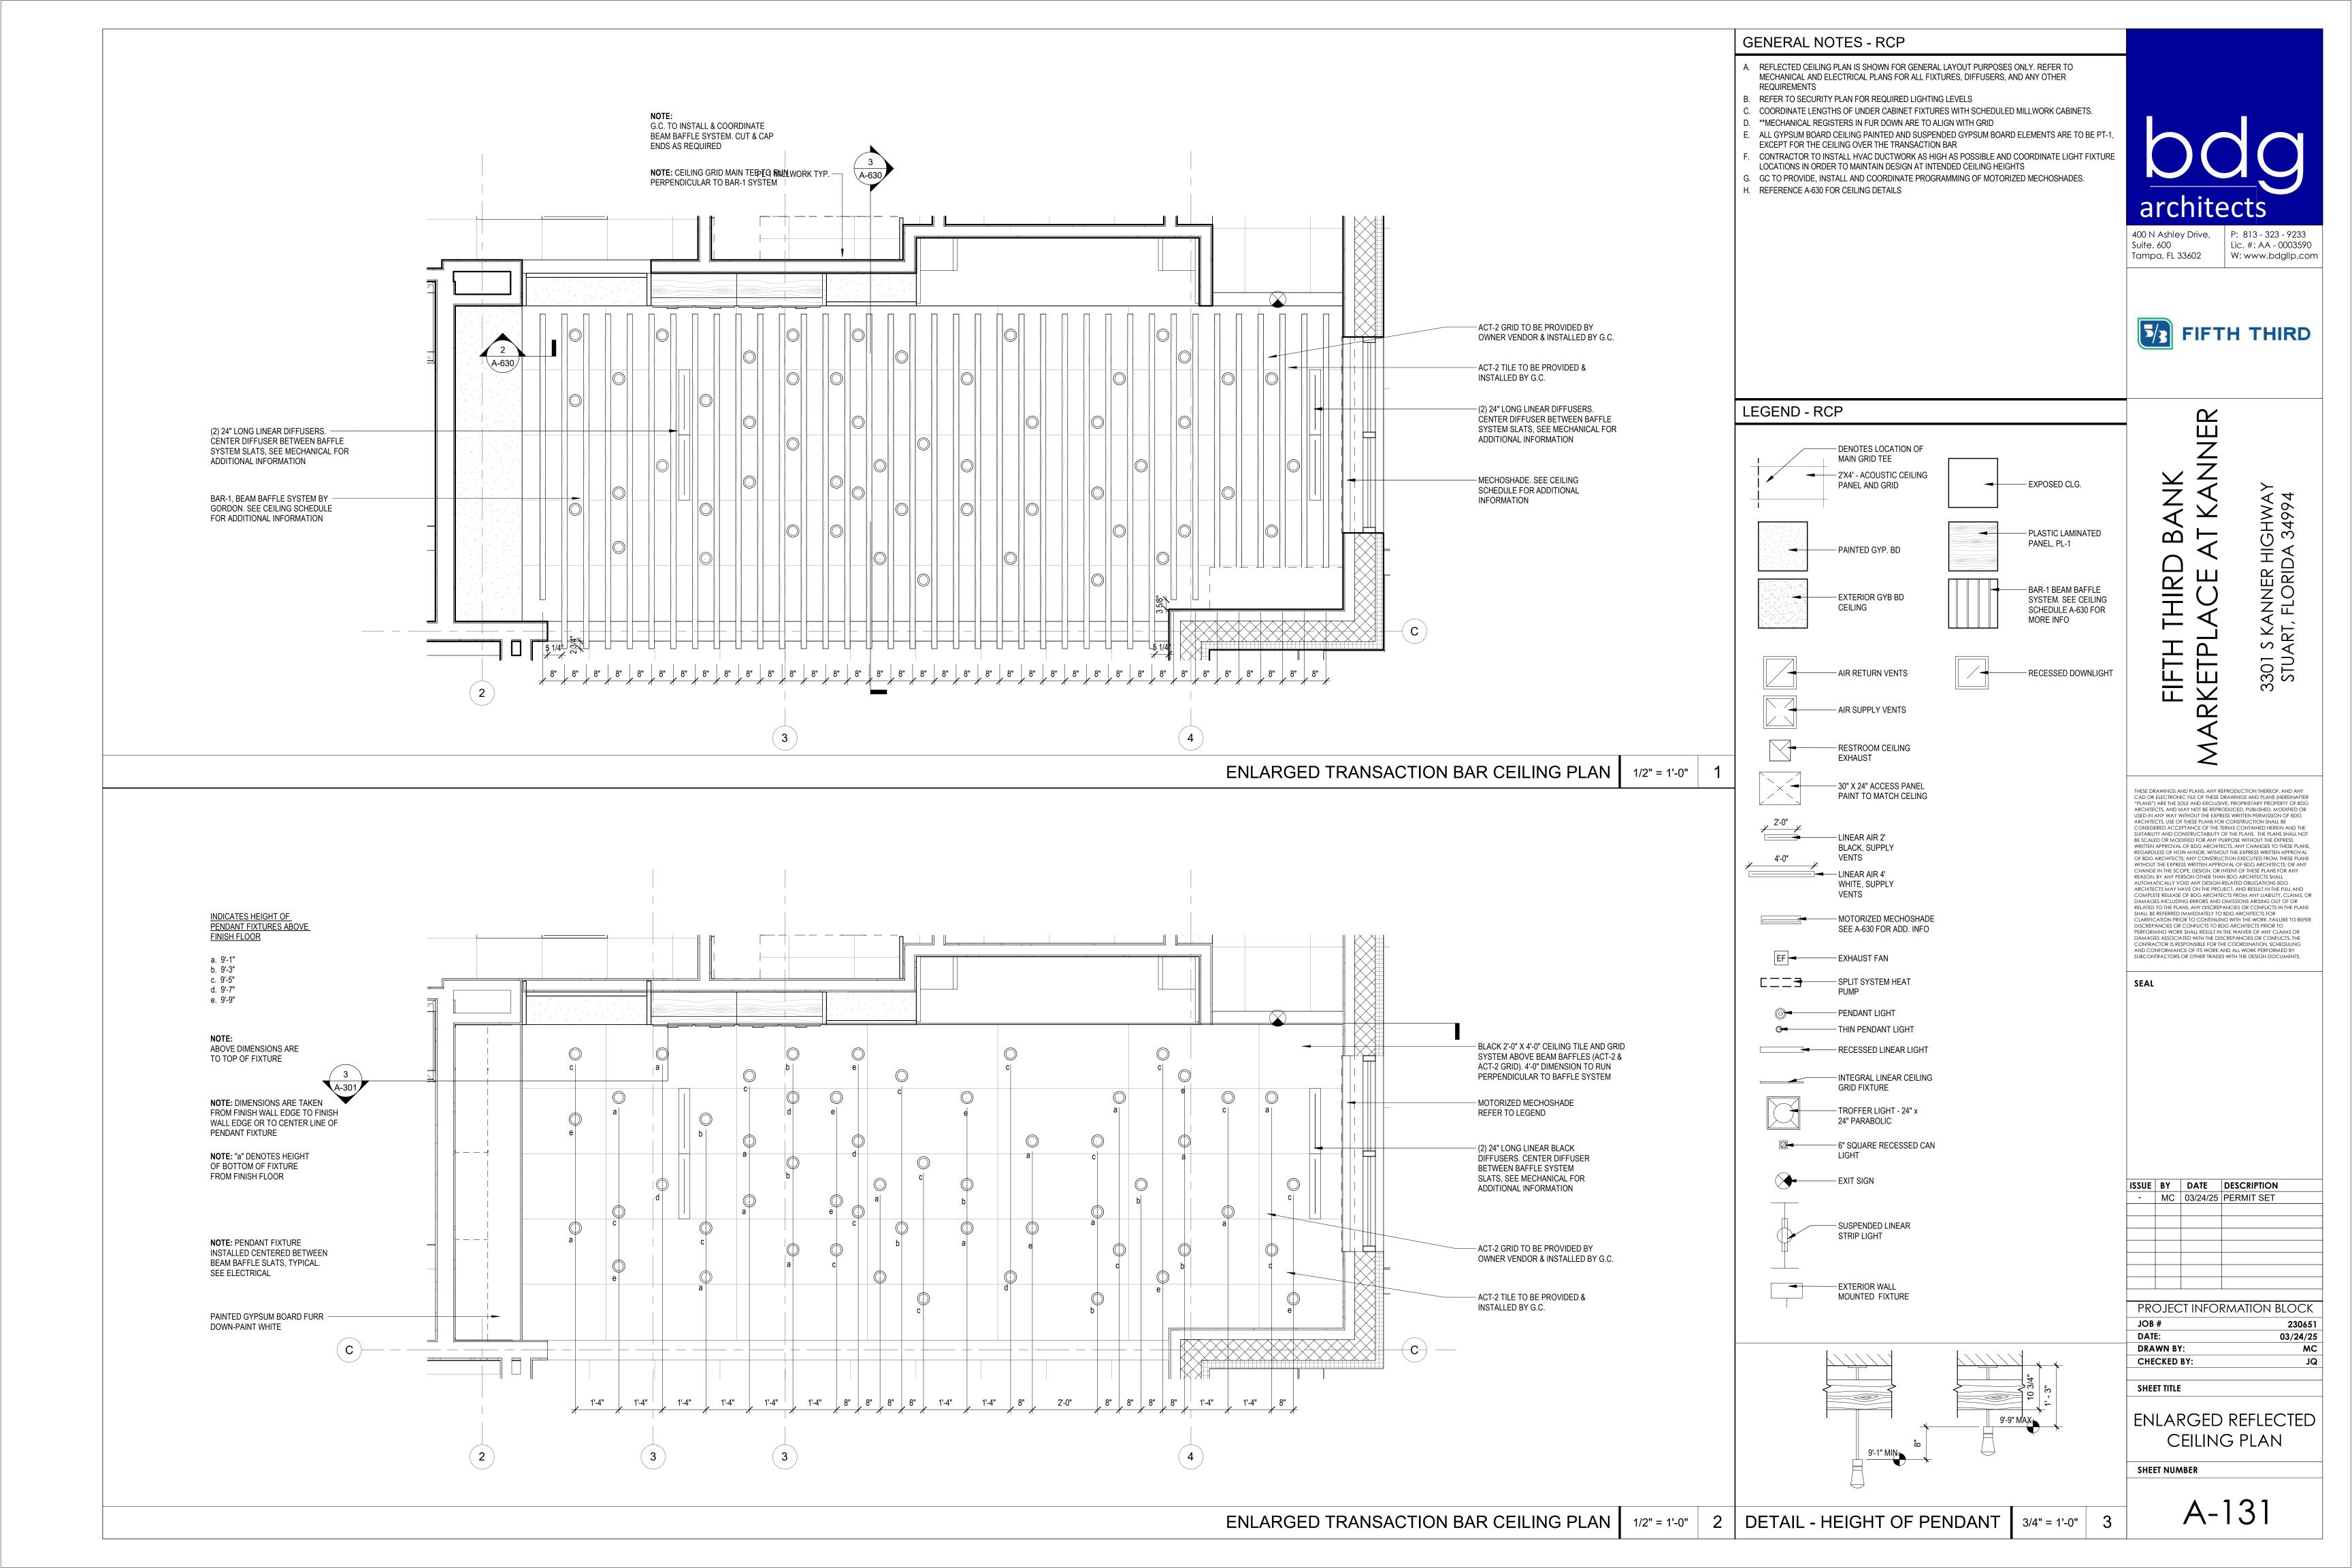
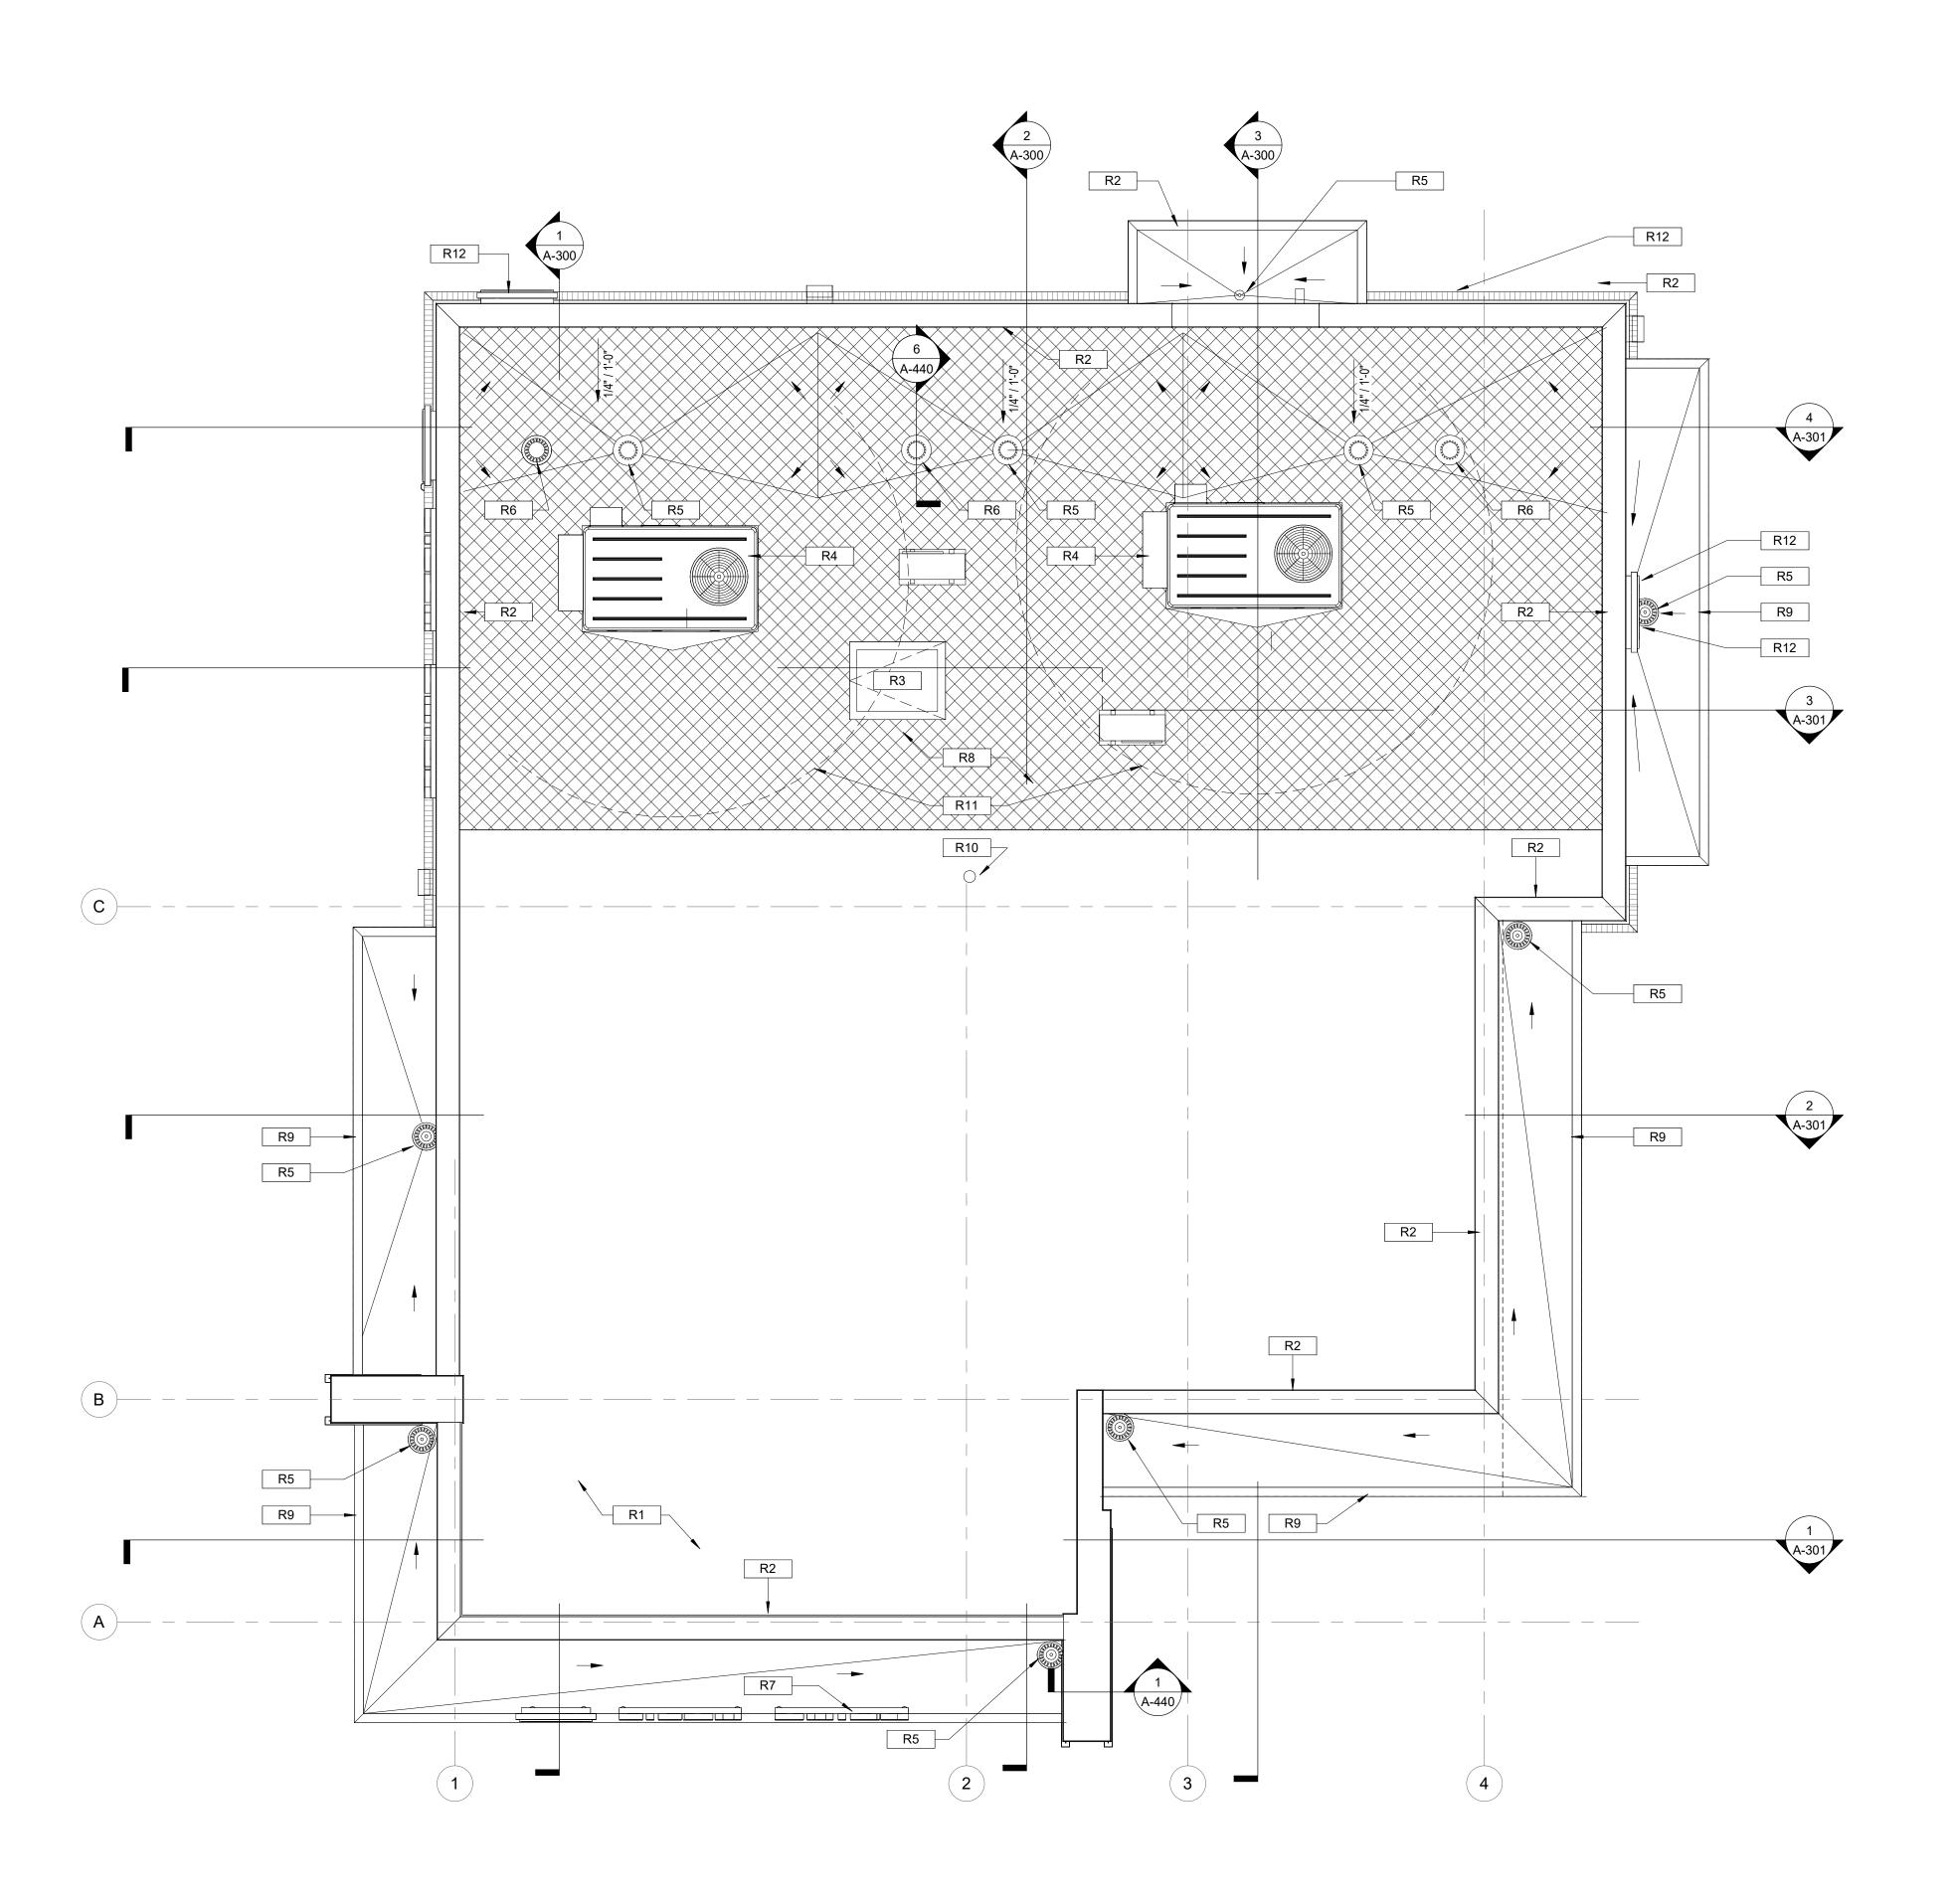
### GENERAL NOTES - ROOF PLAN

- 1. ROOF CRICKETS TO BE 1/4" PER FOOT MINIMUM, FULLY TAPERED POLYISOCYANURATE INSULATION, MECHANICALLY ATTACHED TO DECK BELOW AS PART OF ATTACHMENT OF LAYER
- 2. INSTALL ALL ROOF SYSTEMS AND RELATED COMPONENTS IN STRICT ACCORDANCE WITH MANUFACTURER'S SPECIFICATIONS AND INSTALLATION DETAILS. PROVIDE SHOP DRAWINGS FOR APPROVAL AS REQUIRED BY SPECIFICATIONS.
- 3. VERIFY AND COORDINATE LOCATION OF ALL ROOF PENETRATIONS WITH STRUCTURAL,
- MECHANICAL, ELECTRICAL, AND PLUMBING. 4. ALL ROOF PENETRATIONS REQUIRE PRESSURE TREATED 2x6 BLOCKING AT INSULATION AROUND
- ENTIRE PERIMETER FOR FLASHING ATTACHMENT.
- 5. OMISSION OF ANY ACCESSORY FROM THE ROOF PLAN SHALL NOT RELIEVE THE CONTRACTOR FROM THE RESPONSIBILITY FOR SUCH ITEMS.



Suite. 600

400 N Ashley Drive, P: 813 - 323 - 9233 Lic. #: AA - 0003590 Tampa, FL 33602 W: www.bdgllp.com

### KEY NOTES - ROOF PLAN

R1	60 MIL REINFORCED FULLY ADHERED TPO MEMBRANE OVER 1/4" PRE-PRIMED ROOFBOARD OVER FLAT POLYISOCYANURATE INSULATION WITH A MINIMUM R39 VALUE. MECHANICALLY ATTACHED TO WOOD ROOF DECK ON SLOPING WOOD JOISTS.
R2	CONT. METAL COPING TO COVER ENTIRE TOP OF PARAPET
R3	30" x 36" ROOF ACCESS HATCH
R4	MECHANICAL ROOF TOP UNIT
R5	ROOF DRAIN. REFER TO A-440
R6	OVERFLOW ROOF DRAIN. REFER TO A-440
R7	MAIN ENTRY CANOPY MOUNTED SIGNAGE
R8	HATCH INDICATES ADDITIONAL TPO WALKWAY PAD MEMBRANE
R9	PRE-FINISHED ALUMINUM COMPOSITE CLAD AWNING, ACM-3
R10	VENT STACK. REFER TO PLUMBING DRAWINGS FOR LOCATION
R11	NO VENT STACK SHALL BE LOCATED WITHIN 10'-0" RADIUS OF AN RTU INTAKE. COORDINATE WITH MECHANICAL.

### R12 WALL MOUNTED SIGNAGE ROOFING BASIS OF DESIGN: FIRESTONE 60 MIL REINFORCED FULLY ADHERED TPO

ALTERNATE: SARNAFIL G410-80 60 MIL PVC BY SIKA CORPORATION OR AN EQUIVALENT PRODUCT BY FIBERTITE ROOFING SOLUTIONS



FIFTH THIRD

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SEAL

ISSUE BY DATE DESCRIPTION - MC 03/24/25 PERMIT SET

PROJECT INFORMATION BLOCK JOB# 230651 03/24/25 DATE: DRAWN BY: CHECKED BY:

SHEET TITLE


**ROOF PLAN** 


SHEET NUMBER

A-140

NOTE: PROJECT NORTH IS FOR CONSTRUCTION PURPOSES ONLY. REFER TO CIVIL DRAWING FOR TRUE NORTH AND CORRECT BUILDING ORIENTATION AS IT RELATES TO THE SITE.

ROOF PLAN | 1/4" = 1'-0" | 1

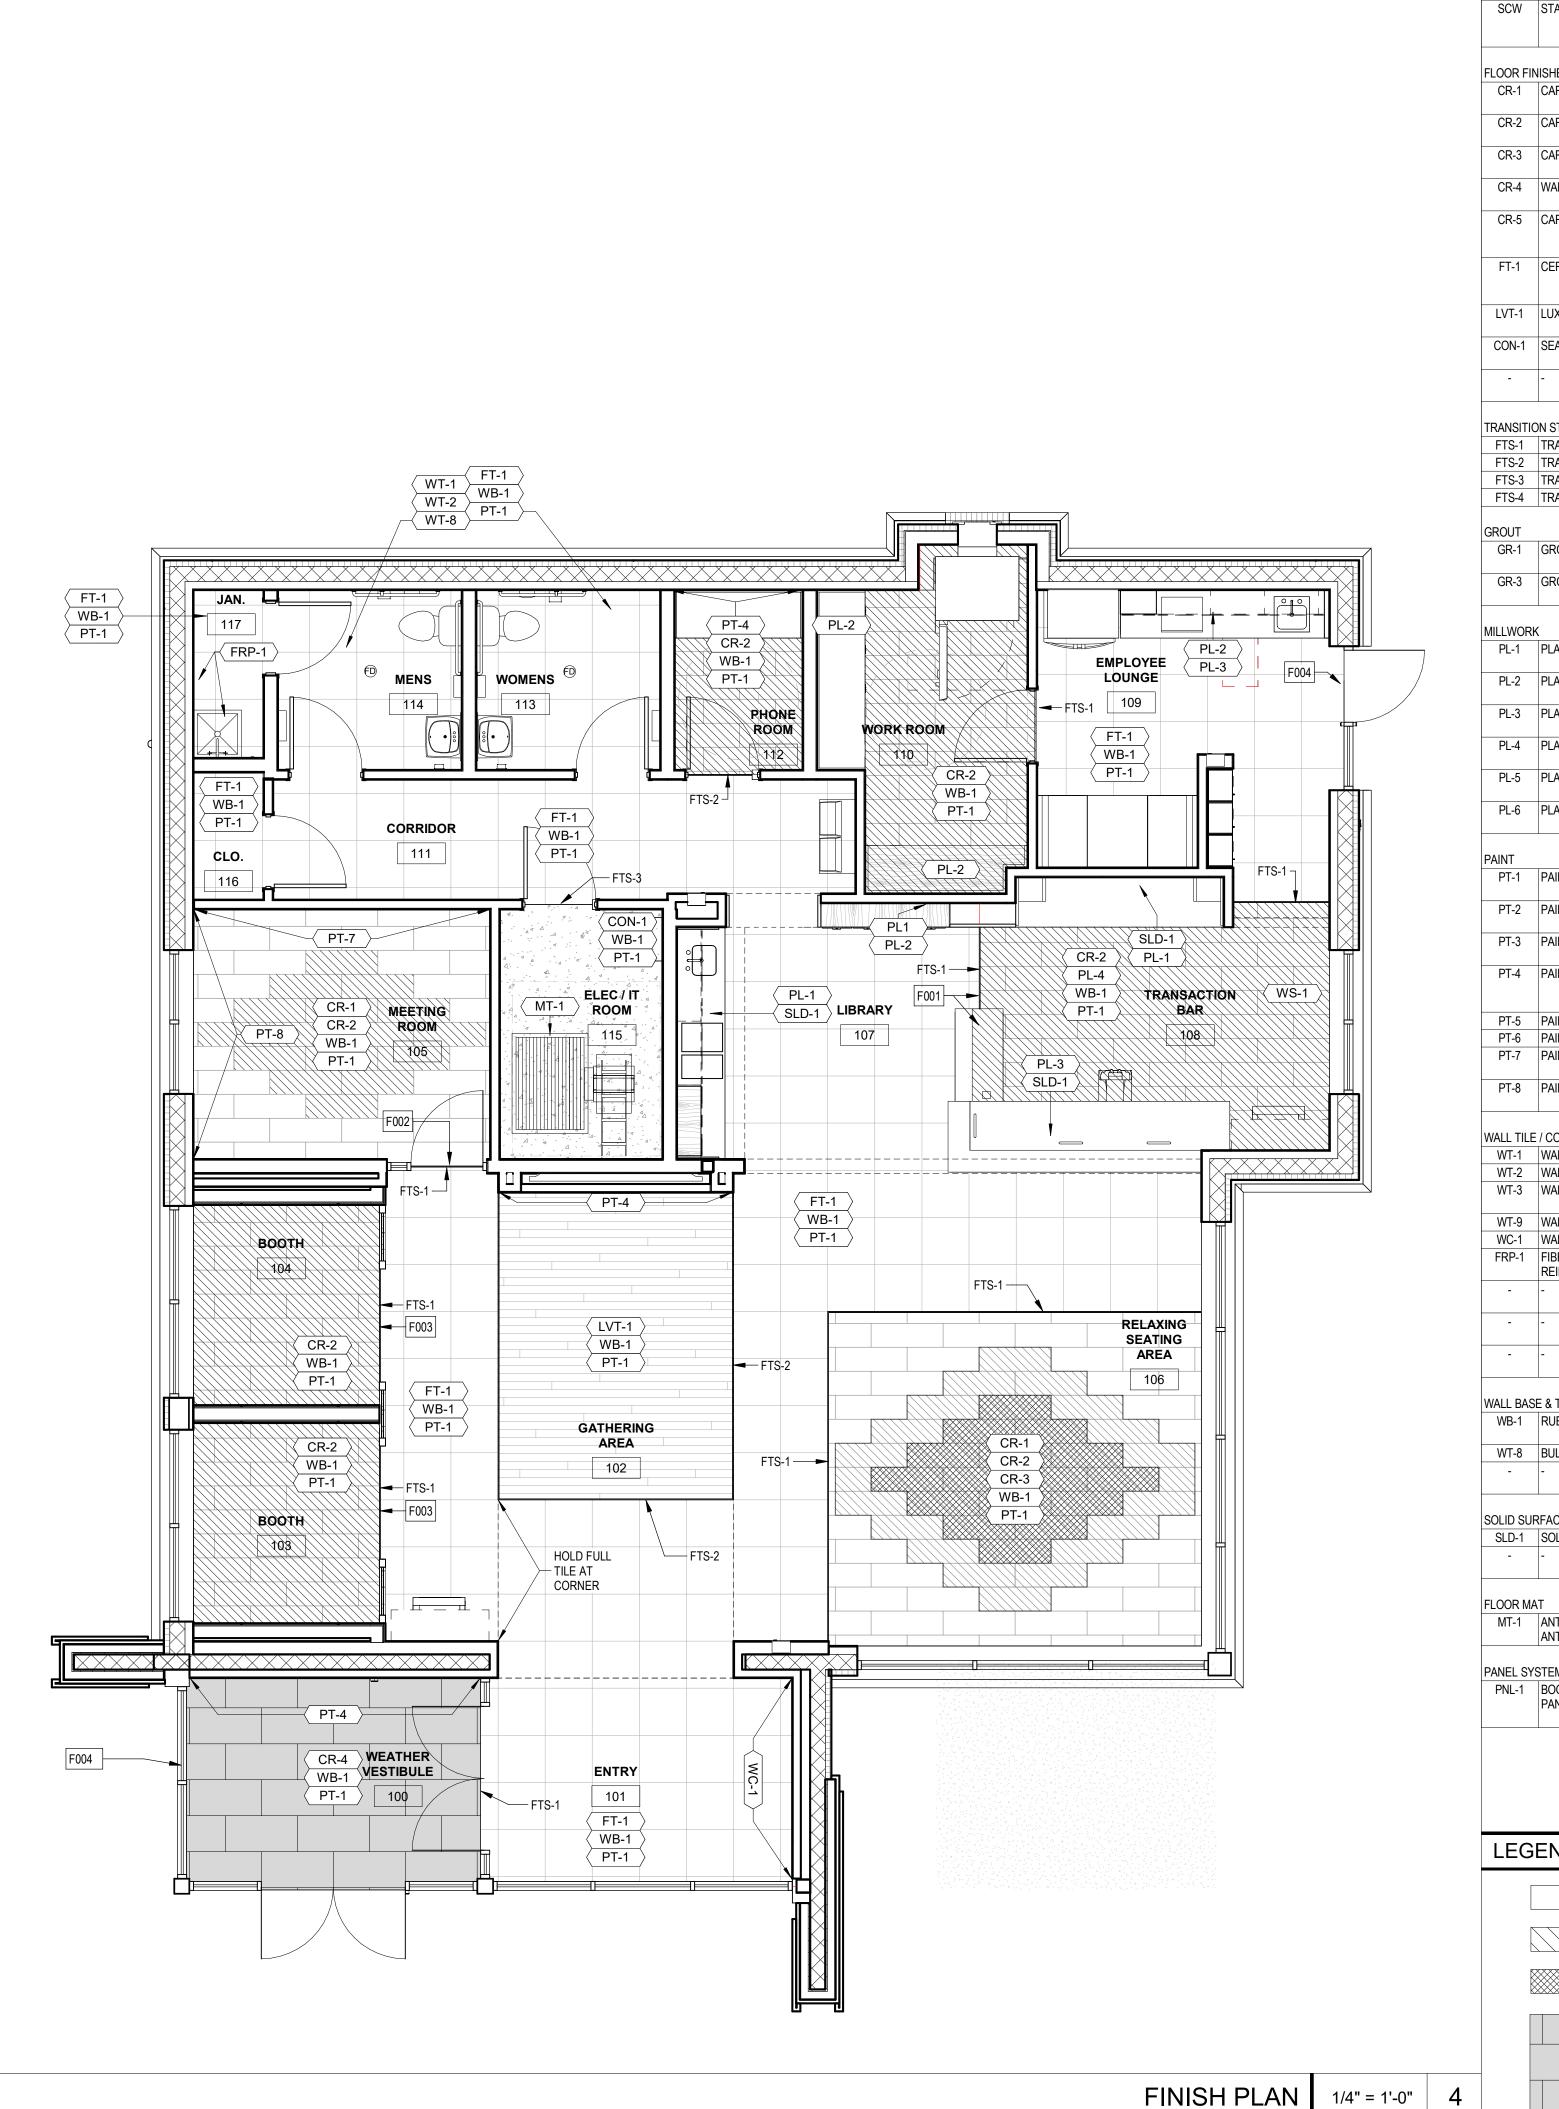

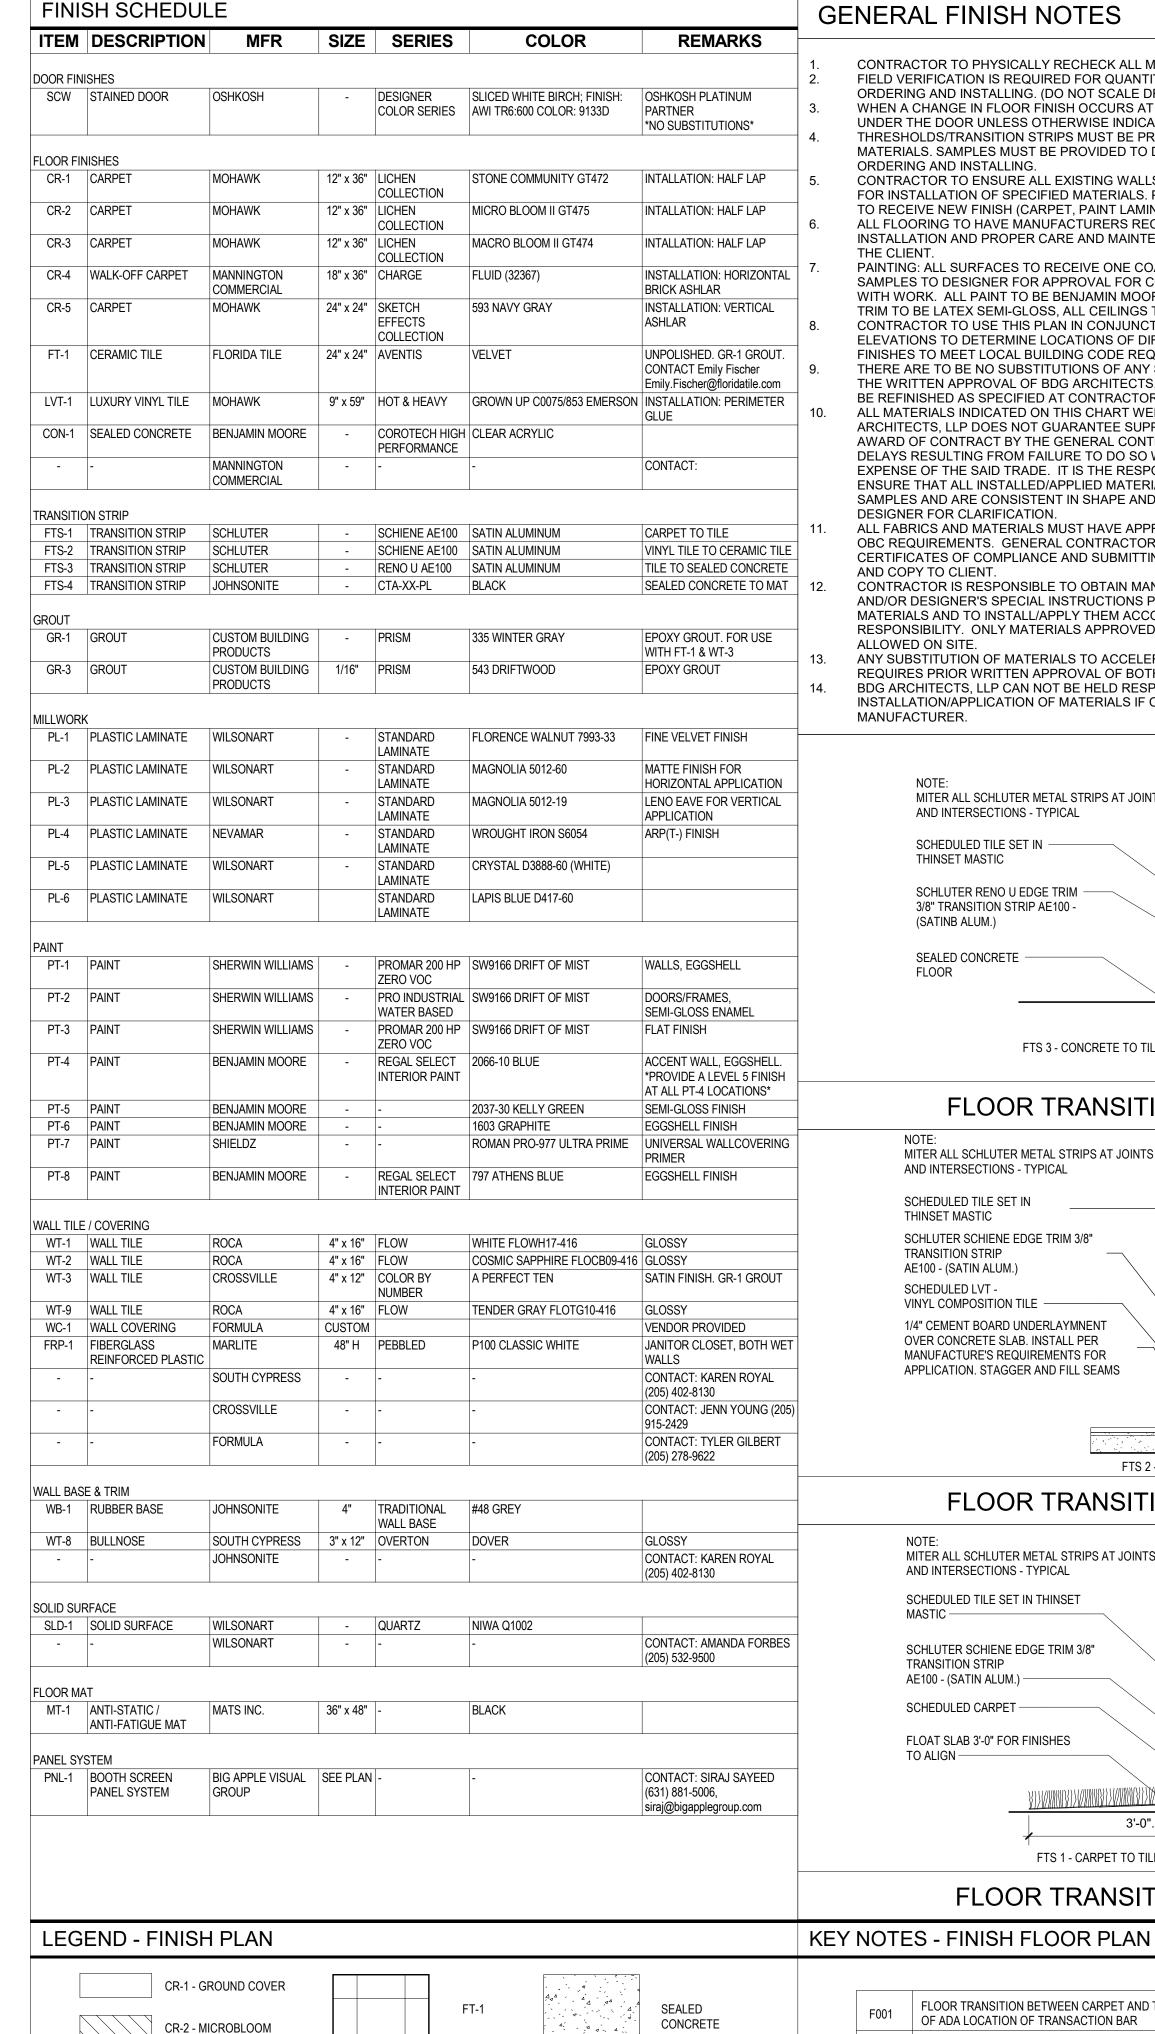

CR-3 - MICROBLOOM

CARPET

CR-4 - WALK OFF

LVT-1


CR-5 - NAVY

GRAY

### **GENERAL FINISH NOTES**

THE CLIENT.

- CONTRACTOR TO PHYSICALLY RECHECK ALL MEASUREMENTS PROVIDED IN DRAWINGS. FIELD VERIFICATION IS REQUIRED FOR QUANTITIES OF ALL MATERIALS PRIOR TO ORDERING AND INSTALLING. (DO NOT SCALE DRAWINGS).
- WHEN A CHANGE IN FLOOR FINISH OCCURS AT DOORWAY, THE SEAM IS TO BE CENTERED UNDER THE DOOR UNLESS OTHERWISE INDICATED. THRESHOLDS/TRANSITION STRIPS MUST BE PROVIDED BETWEEN DIFFERING FLOORING
- MATERIALS. SAMPLES MUST BE PROVIDED TO DESIGNER FOR APPROVAL PRIOR TO ORDERING AND INSTALLING. CONTRACTOR TO ENSURE ALL EXISTING WALLS AND FLOORS ARE PROPERLY PREPARED
- FOR INSTALLATION OF SPECIFIED MATERIALS. PATCH AND REPAIR AS NECESSARY, READY TO RECEIVE NEW FINISH (CARPET, PAINT LAMINATE, RESILIENT FLOORING, ETC.) ALL FLOORING TO HAVE MANUFACTURERS RECOMMENDED FINISH APPLIED AFTER INSTALLATION AND PROPER CARE AND MAINTENANCE INSTRUCTIONS TO BE ISSUED TO
- PAINTING: ALL SURFACES TO RECEIVE ONE COAT PRIMER, TWO COATS PAINT. PROVIDE SAMPLES TO DESIGNER FOR APPROVAL FOR COLOR VERIFICATION PRIOR TO PROCEEDING WITH WORK. ALL PAINT TO BE BENJAMIN MOORE OR EQUAL: ALL DOORS AND FRAMES. TRIM TO BE LATEX SEMI-GLOSS, ALL CEILINGS TO BE FLAT, ALL WALLS TO BE EGGSHELL CONTRACTOR TO USE THIS PLAN IN CONJUNCTION WITH ALL OTHER PLANS AND ELEVATIONS TO DETERMINE LOCATIONS OF DIFFERENT MATERIALS AND FINISHES. ALL
- FINISHES TO MEET LOCAL BUILDING CODE REQUIREMENTS. THERE ARE TO BE NO SUBSTITUTIONS OF ANY SPECIFIED MATERIALS/FINISHES WITHOUT THE WRITTEN APPROVAL OF BDG ARCHITECTS, LLP. ANY UNAUTHORIZED CHANGES WILL BE REFINISHED AS SPECIFIED AT CONTRACTOR'S EXPENSE.
- ALL MATERIALS INDICATED ON THIS CHART WERE AVAILABLE AT TIME OF SPECIFYING, BDG ARCHITECTS, LLP DOES NOT GUARANTEE SUPPLY IF NOT ORDERED IMMEDIATELY UPON AWARD OF CONTRACT BY THE GENERAL CONTRACTOR AND/OR SUBCONTRACTORS. DELAYS RESULTING FROM FAILURE TO DO SO WILL BE THE RESPONSIBILITY AND AT THE EXPENSE OF THE SAID TRADE. IT IS THE RESPONSIBILITY OF THE CONTRACTOR TO ENSURE THAT ALL INSTALLED/APPLIED MATERIALS CORRESPOND WITH THE DESIGNER'S SAMPLES AND ARE CONSISTENT IN SHAPE AND COLOR AS APPROVED. CONSULT DESIGNER FOR CLARIFICATION.
- ALL FABRICS AND MATERIALS MUST HAVE APPROPRIATE FLAME SPREAD RATINGS AS PER OBC REQUIREMENTS. GENERAL CONTRACTOR IS RESPONSIBLE FOR OBTAINING ALL CERTIFICATES OF COMPLIANCE AND SUBMITTING THEM TO LOCAL BUILDING AUTHORITIES CONTRACTOR IS RESPONSIBLE TO OBTAIN MANUFACTURERS WRITTEN SPECIFICATIONS
- AND/OR DESIGNER'S SPECIAL INSTRUCTIONS PRIOR TO INSTALLATION. APPLICATIONS OF MATERIALS AND TO INSTALL/APPLY THEM ACCORDINGLY IS THE CONTRACTOR'S RESPONSIBILITY. ONLY MATERIALS APPROVED IN WRITING BY THE DESIGNER ARE
- ANY SUBSTITUTION OF MATERIALS TO ACCELERATE THE WORK DURING CONSTRUCTION REQUIRES PRIOR WRITTEN APPROVAL OF BOTH THE OWNER AND THE DESIGNER. BDG ARCHITECTS, LLP CAN NOT BE HELD RESPONSIBLE FOR THE MANNER OF SUPPLY AND INSTALLATION/APPLICATION OF MATERIALS IF OTHER THAN SPECIFIED BY SAME AND/OR

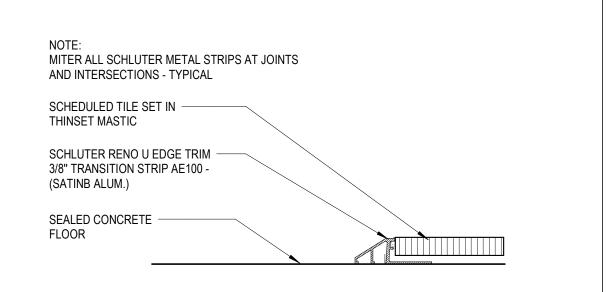

FTS 3 - CONCRETE TO TILE TRANSITION

FLOOR TRANSITION - FTS-3 6" = 1'-0" MITER ALL SCHLUTER METAL STRIPS AT JOINTS AND INTERSECTIONS - TYPICAL SCHEDULED TILE SET IN THINSET MASTIC SCHLUTER SCHIENE EDGE TRIM 3/8" TRANSITION STRIP AE100 - (SATIN ALUM.) SCHEDULED LVT -VINYL COMPOSITION TILE -1/4" CEMENT BOARD UNDERLAYMNENT OVER CONCRETE SLAB. INSTALL PER MANUFACTURE'S REQUIREMENTS FOR APPLICATION. STAGGER AND FILL SEAMS FTS 2 - VINYL TILE PLANK TO TILE

FLOOR TRANSITION - FTS-2 6" = 1'-0"

MITER ALL SCHLUTER METAL STRIPS AT JOINTS AND INTERSECTIONS - TYPICAL SCHEDULED TILE SET IN THINSET SCHLUTER SCHIENE EDGE TRIM 3/8" TRANSITION STRIP AE100 - (SATIN ALUM.) -SCHEDULED CARPET -FLOAT SLAB 3'-0" FOR FINISHES TO ALIGN -3'-0". FTS 1 - CARPET TO TILE

FLOOR TRANSITION: FTS-1	6" = 1'-0"
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FLOOR TRANSITION BETWEEN CARPET AND TILE. TRANSITION TO ALIGN TO VERTICAL PANEL OF ADA LOCATION OF TRANSACTION BAR FLOOR TRANSITION BETWEEN MEETING ROOM CARPET AND FIELD TILE. TRANSITION TO ALIGN TO INTERIOR FACE OF MEETING ROOM DEMOUNTABLE PARTITION SYSTEM. FLOOR TRANSITION BETWEEN BOOTH CARPET AND FIELD TILE. FLOORING TRANSITION TO ALIGN TO INTERIOR FACE OF MILLWORK PANEL IN THE BOOTH GC TO PROVIDE FLOORING TRANSITIONS TO CONFORM TO CHANGES IN LEVEL BETWEEN 1/4 INCH AND 1/2 INCH MUST BE BEVELED AT 1:2 OR LESS. 1/4 INCH IS THE MAXIMUM VERTICAL RISE.

400 N Ashley Drive, P: 813 - 323 - 9233 Suite. 600 Lic. #: AA - 0003590 W: www.bdgllp.com Tampa, FL 33602



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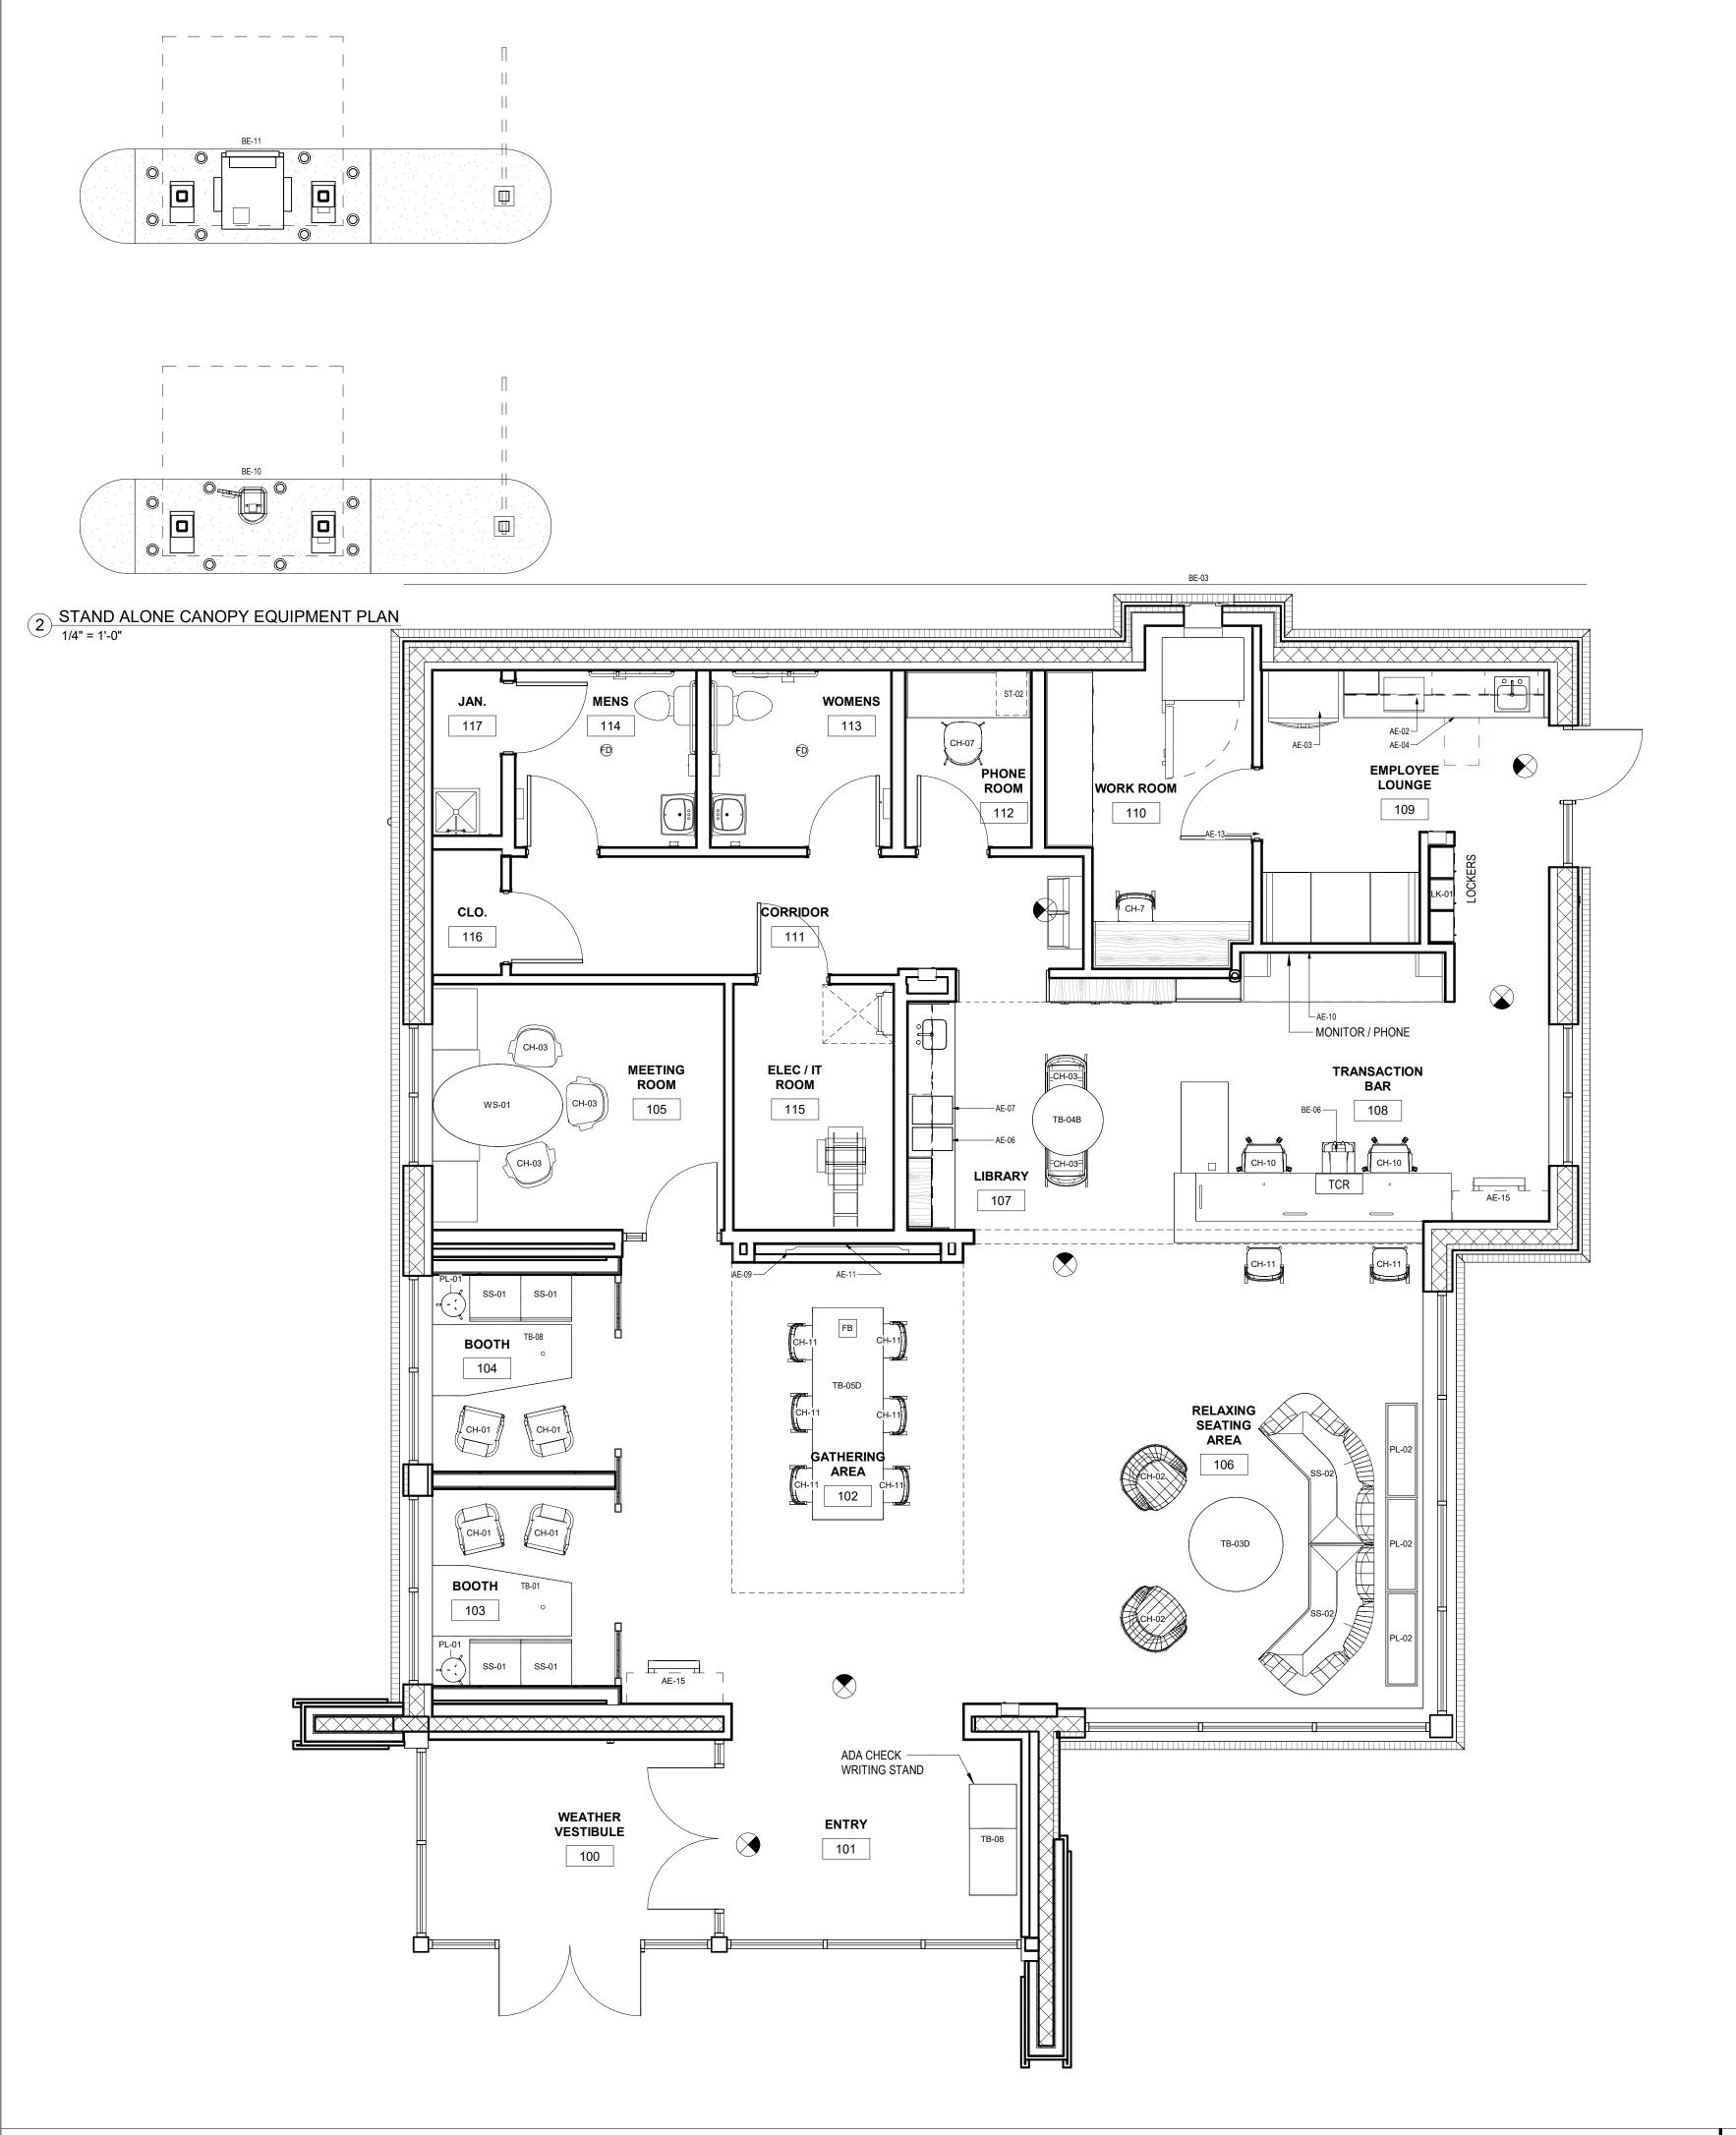
PROJECT INFORMATION BLOCK JOB# DATE: 03/24/25 **DRAWN BY:** CHECKED BY:

SHEET TITLE

FINISH PLAN, LEGEND AND NOTES

SHEET NUMBER

A-150



ITEM#	DESCRIPTION	MANUFACTURER	DIMENSIONS	MODEL	COLOR
	1	1		1	
CH-01	TOTO CHAIR	BOSS DESIGN	23.5"W x 23"D x 32"H X18.25"SH	TOT/3/HB	OAK LEGS ON WHITE CHASSIS
H-02	BOMBOM	BERNHARDT	34.25"W X 30.25"D X 30"H X 19.25"H	1076K	BASE: MATTE BLACK
CH-03	MERANO CHAIR ARMLESS	GRAND RAPIDS	17"W X 17"D X 31"H X 18"SH	W400SC	ACORN WOOD FINISH ON BEECH
CH-04	LAVA	BERNHARDT	27.25"W X 22"D X 33.25"-37.25"H X 17.75-22"SH	594	SHEL: MIST, BASE: POLISHED ALUMINUM
CH-05	TOTO CHAIR	BOSS DESIGN	23.5"W x 23"D x 32"H X18.25"SH	TOT/3/HB	AMERICAN BLACK WALNUT. LEGS ON BLACK CHASSIS
CH-06	TBD CHAIR	TBD	02 51104 - 02110 - 2011   1/40 051101	TOT/2/UD	OAK LEGG ON WHITE OUR COLO
CH-07	TOTO CHAIR	BOSS DESIGN	23.5"W x 23"D x 32"H X18.25"SH	TOT/3/HB	OAK LEGS ON WHITE CHASSIS
CH-08	MAVIC	SITONIT	23.5"W X 23.5"D X 35.4"D X 17.5"-21.5"SH	1113.T	FRAME/BASE: FOG
CH-09	BAHKITA MOVI STOOL	GLOBAL	18"W X 21"D X 35.4" X 17.5"-21.5"SH	6751	PLASTIC: ALLOY
CH-10	MOVI STOOL	SITONIT	26"W X 26"D X 37.75"H X 21.5"-28.5"SH	1062 FT3 S21	FRAME/BASE: FOG
CH-11	MERANO CHARGE STATION	GRAND RAPIDS GLOBAL INDUSTRIAL	17"W X 14"D X 29"H X 30"SH	W400BS WBB1963653	ACORN WOOD FINISH ON BEECH BLACK
CS-01 LK-01	LOCKERS	GREAT OPENINGS	17.5"W X 20"D X 13.5"H 16"W x 12"D x 72"H	C100077	WILSONART LINEN LAM
MS-01	PHONE ROOM PEDESTAL	STEELCASE	22.75"H x 15.5"W x 22.5"D	18-0101712	CUSHION COLOR: TBD
MS-03	PLANTER				
VIS-U3	PLANTER	THE CHANDLER COMPANY	48"L x 12"W x 30"H	CN481830	WHITE: SMOOTH FINISH
PD-01	PENCIL - ACCY	GREAT OPENINGS	21.75"W X 17.25"D X 2.125"H	NFC7657889	BLACK
PL-01	ROO	OFS	17.5"D X 29"H	RO-29PS	ROOT, BONE WHITE, IRON BOWL
PL-02	PLANTER	THE PLANT TROLLEY	48"W 12"D X 28"H (CAN VARY)	LARGE PLANTER	CHARCOAL GREY STAIN. SEMI-GLOSS
PT-01	THREAD	STEELCASE	30"H	PFLHUB	MERLE
PW-01	BOOTH PILLOW; BEDFORD	PALLAS TEXTILES	18" X 18"	PILLOW	JENS
PW-01	BOOTH PILLOWS; DOUBLE	HBF	18" X 18"	PILLOW	VERT
PW-02	STIRCH BOOTH PILLOWS;	ARCHITEX	18" X 18"	PILLOW	ROYAL
	HERITAGE				
SH-03	CRATE DIVIDE 3 BAY	ALLERMUIR	53"W X 18"D X 70.5"H	CRT2H3BS	FRAME: BLACK. BASE/SHELVES: BLACK
SH-04	CRATE DIVIDE 4 BAY	ALLERMUIR	70.25"W X 18"D X 70.5"H	CRT2H4BS	FRAME: BLACK. BASE/SHELVES: BLACK
SH-06	CRATE DIVIDE 6 BAY	ALLERMUIR	106"W X 18"D X 70.5"H	DQ-CRT2H6BS	FRAME: BLACK. BASE/SHELVES: BLACK
SH-08	CRATE DIVIDE 8 BAY	ALLERMUIR	142"W X 18"D X 70.5"H	DQ-CRT2H8BS	FRAME: BLACK. BASE/SHELVES: BLACK
SS-01	RAFT SOFA	BOSS DESIGN	26.25"D x 26.25"W x 20.25"-29"H	RAFT 1 FB	LEGS: POLISHED METAL
SS-02L	LUCA 45 LEFT ARM	BERNHARDT	86.25" X 44.5"D X 29.5"H X 16.5' SH	8D33L	BASE: BLACK
SS-02R	LUCA 45 RIGHT ARM	BERNHARDT	86.25" X 44.5"D X 29.5"H X 16.5' SH	8D33R	BASE: BLACK
SS-03A	LUCA 2 SEAT	BERNHARDT	66.5"W X 33.25"D X 29.5"H X 16.5"SH	8D25N	BASE: MATTE BLACK
SS-03B	LUCA 3 SEAT	BERNHARDT	95.75"W X 33.25"D X 29.5"H X 16.5"SH	8D27N	BASE: MATTE BLACK
SS-04L	LUCA LEFT ARM W/TABLE	BERNHARDT	90.25"W X 33.25"D X 29.5"H X 16.5"SH	8D26L	BASE: MATTE BLACK. TABLE: 861 WALNUT
SS-04R SS-05	LUCA RIGHT ARM W/TABLE TBD	BERNHARDT TBD	90.25"W X 33.25"D X 29.5"H X 16.5"SH	8D26R	BASE: MATTE BLACK. TABLE: 861 WALNUT
SS-06	ORAI	ALLERMUIR	101.5"W X 33.5"D X 27"H X 17"SH	OR1300	FRAME: BLACK POWDER COAT
	RAFT SOFA	BOSS DESIGN	26.25"D x 26.25"W x 29"H X 18"SH	RAFT 1 FB	LEGS: POLISHED METAL
SS-07B	RAFT SOFA	BOSS DESIGN	26.25"D X 52.75"W X 29"H X 18"SH	RAFT 2 RB	LEGS: POLISHED METAL
ST-01	TRACE	GREAT OPENINGS	36"W X 18.25"D X 51.5"HH (CAN VARY)	RG-D103 (VARIES)	PAINT: MILK
ST-01	SLIM PED W/ CUSHION	GREAT OPENINGS	12"W X 18 7/8"D X 21"H	STU 5640C	PAINT: MILK
ST-02 ST-03	STAKS	OFS OF ENINGS	36"W CX 16.5"D X 27.875"H (CAN VARY)	6-NW3617MPD2 (VARIES)	CREDENZA: STEEL LAMINATE
ST-03 ST-04	YAHEETECH	AMAZON	12.6"W X 11.8"D 34.25"H	YAHEETECH	WHITE
TB-01	INTERMIX/STAKS	OFS	72"W X 36"D X 1"H-36"D	VARIES	LAMINATE: FROSTY WHITE. COLUMN PAINT: LUSTER GRE
TB-02	LUCA	BERNHARDT	18" DIA. X 23"H	LUS-LDT-BK-WLT	TOP: WALNUT 861. BASE: MATTE BLACK PAINT
TB-02 TB-03A	LUCA	BERNHARDT	30" DIA X 16"H		
				LUS-XDM-BK-WLT	TOP: WALNUT 861. BASE: MATTE BLACK PAINT
TB-03B	LUCA SMALL CLUSTED	BERNHARDT	36" DIA X 16"H	LUS-ADM-BK-WLT	TOP: WALNUT 861. BASE: MATTE BLACK PAINT
TB-03C TB-03D	LUCA SMALL CLUSTER LUCA LARGE CLUSTER	BERNHARDT BERNHARDT	36" DIA X 16"H + 30" DIA. 18"H  22" DIA. X 14"H + 30" DIA X 14" H + 42" DIA X	VARIES VARIES	TOP: WALNUT 861. BASE: MATTE BLACK PAINT TOP: WALNUT 861. BASE: MATTE BLACK PAINT
	ROUND TOP/J87 BASE	FALCON	16"H 30" DIA	1333/J87	TOP: DESIGNER WHITE LAM. BASE SILVERSTONE
	ROUND TOP/J87 BASE	FALCON	36" DIA	1333/J87	TOP: DESIGNER WHITE LAM. BASE SILVERSTONE
	BLUEPRINT 1900N	BERNHARDT	66"W X 30"D X 42"H	BPX-01FNW-CCSQXXX	TOP: FROSTY WHITE LAM. BASE: PAINTED VENEER
	BLUEPRINT 1900S	BERNHARDT	72"W X 36"D X 42"H	BPX-01BOM-CCSQXXX	TOP: FROSTY WHITE LAM. BASE: PAINTED VENEER
	BLUEPRINT TABLE	BERNHARDT	84"W X 36"D X 42"H		TOP: FROSTY WHITE LAM. BASE: PAINTED VENEER
TB-05D	BLUEPRINT 2400+	BERNHARDT	108"W x 36"D X 42"H	BPX-01BEL-CCSQZ02	TOP: FROSTY WHITE LAM. BASE: PAINTED VENEER
TB-06	SWAP TOP / ZOLA TOP	GLOBAL + MOCKETT LEG	24"X30"	GSBTP2430 / TL53 94	TOP: DESIGNER WHITE LAM. BASE: SATIN ALUMINUM
TB-07	SWAP TOP / ZOLA TOP	GLOBAL + MOCKETT LEG	30"X48"	EX200268 / TL53 94	TOP: DESIGNER WHITE LAM. BASE: SATIN ALUMINUM
TB-08	CHECK WRITING STAND	MILLWORKER			
WD-01	CONNECT X2	CLARIDGE	36" X 48" (CAN VARY)	MULTIPLE	GLASS: WHITE. CORKBOARD: BLUEBERRY & GRAPHITE
WS-01	WORKSTATION	OFS	OVAL TOP: 42" X VARYING LENGTH; 9' OR 10'	VARIES	OVAL: FROSTY WHITE. COLUMN:LUSTER GREY. CREDENZ STEEL LAM
VVO-01					

- 400 N Ashley Drive, Suite. 600 P: 813 - 323 - 9233 Lic. #: AA - 0003590 W: www.bdgllp.com

FIFTH THIRD

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ITEM #	DESCRIPTION	MFR	MODEL#	PROV. BY	INST. BY	LOCATION	COMMENTS		
APPLIANCE	ES								
AE-01	MICROWAVE DRAWER	SHARP	SMD3070ASY	GC	GC				
AE-02	MICROWAVE	GE	JES1145SHSS	GC	GC				
AE-03	REFRIGERATOR	WHIRLPOOL	WRF540CWHZ	GC	GC		FINGERPRINT RESISTANT STAINLESS STEEL. IF SELECTED MODEL IS NOT AVAILABLE, USE KITCHENAID KRFC300ESS		
AE-04	DISHWASHER	SAMSUNG	DW50T6060US	GC	GC		18" FINGERPRINT RESISTANT STAINLESS STEEL. GC TO PURCHASE 5-YEAR EXTENDED WARRANTY TO COVER USE IN COMMERCIAL ENVIRONMENTS		
AE-06	QUENCH		Q7CT	VENDOR	GC				
AE-07	COFFEE MAKER	KEURIG	K4500	VENDOR	GC				
AE-09	TV	NEC	V984Q-C981Q 98" DISPLAY	VENDOR	VENDOR	TECH WALL		ISSUE	BY
AE-10	TV	NEC	V654Q 65"	VENDOR	VENDOR	BACK COUNTER		-	МС
AE-11	TV WALL MOUNT	PEERLESS	DS-VW795-QR	VENDOR	VENDOR	TECH WALL			
AE-12	TV WALL MOUNT			VENDOR	VENDOR	BACK COUNTER			
AE-13	SECURITY MONITOR			VENDOR	VENDOR				
AE-14	IPAD CHARGING CABINET	BELKIN	B2B074	VENDOR	VENDOR	WORKROOM	18" x14" x 7". PROVIDE POWER IN BASE CABINET		
AE-15	MFD	HP	J8A13A	VENDOR	VENDOR		HP COLOR LASERJET ENTERPRISE FLOW MFP M681Z (PRODUCT #J8A13A)		
BANK EQU	IPMFNT								
BE-01	CASH CHEST/ND COMBO	HAMILTON	20-132L	VENDOR	VENDOR		70" H x 42" W x 34" D, BLACK		
BE-02	CASH CHEST	HAMILTON	20-113R OR 20-113L	VENDOR	VENDOR		62" H x 42" W x 34" D, BLACK	PR	OJE
BE-03	WALK-UP NIGHT DEPOSIT	HAMILTON	17-014 L	VENDOR	VENDOR		29 H x 27" W x 26" D, TL-15, BLACK	JOB	#
BE-03a	DRIVE-UP NIGHT DEPOSIT	HAMILTON	16-098R OR 16-098L	VENDOR	VENDOR		23" H x 27" W x 26" D, TL-15, BLACK	DAT	E:
BE-04	NOT USED	-	-	VENDOR	VENDOR			DRA	WN B
BE-05	WALK-UP THRU WALL ATM	DIEBOLD / NIXDORF	DN SERIES 450	VENDOR	VENDOR		57" H x 28" W x 50" D, 1325 LBS		CKED
BE-06	CASH RECYCLER	NAUTILUS HYOSUNG	MS500	VENDOR	VENDOR			SHE	ET TITL
BE-07	PHONE	CISCO	7841	VENDOR	VENDOR				
BE-08	UNDERCOUNTER STEEL	CONVERGINT	FENCO #212	VENDOR	VENDOR	TRANSACTION BAR		7	ŗ
BE-09	UNDERCOUNTER STEEL	CONVERGINT	FENCO S-222 OR S-622	VENDOR	VENDOR	WORKROOM	COORDINATE WITH VENDOR		I
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DATE DESCRIPTION 03/24/25 PERMIT SET

JECT INFORMATION BLOCK 03/24/25 ED BY: TITLE

> FURNITURE & EQUIPMENT

SHEET NUMBER

A-170

BE-10 VAT TUBE SYSTEM

BE-11 DRIVE-UP ATM

HAMILTON

DIEBOLD /

NIXDORF

HA1000-XLR

SERIES 490


VENDOR


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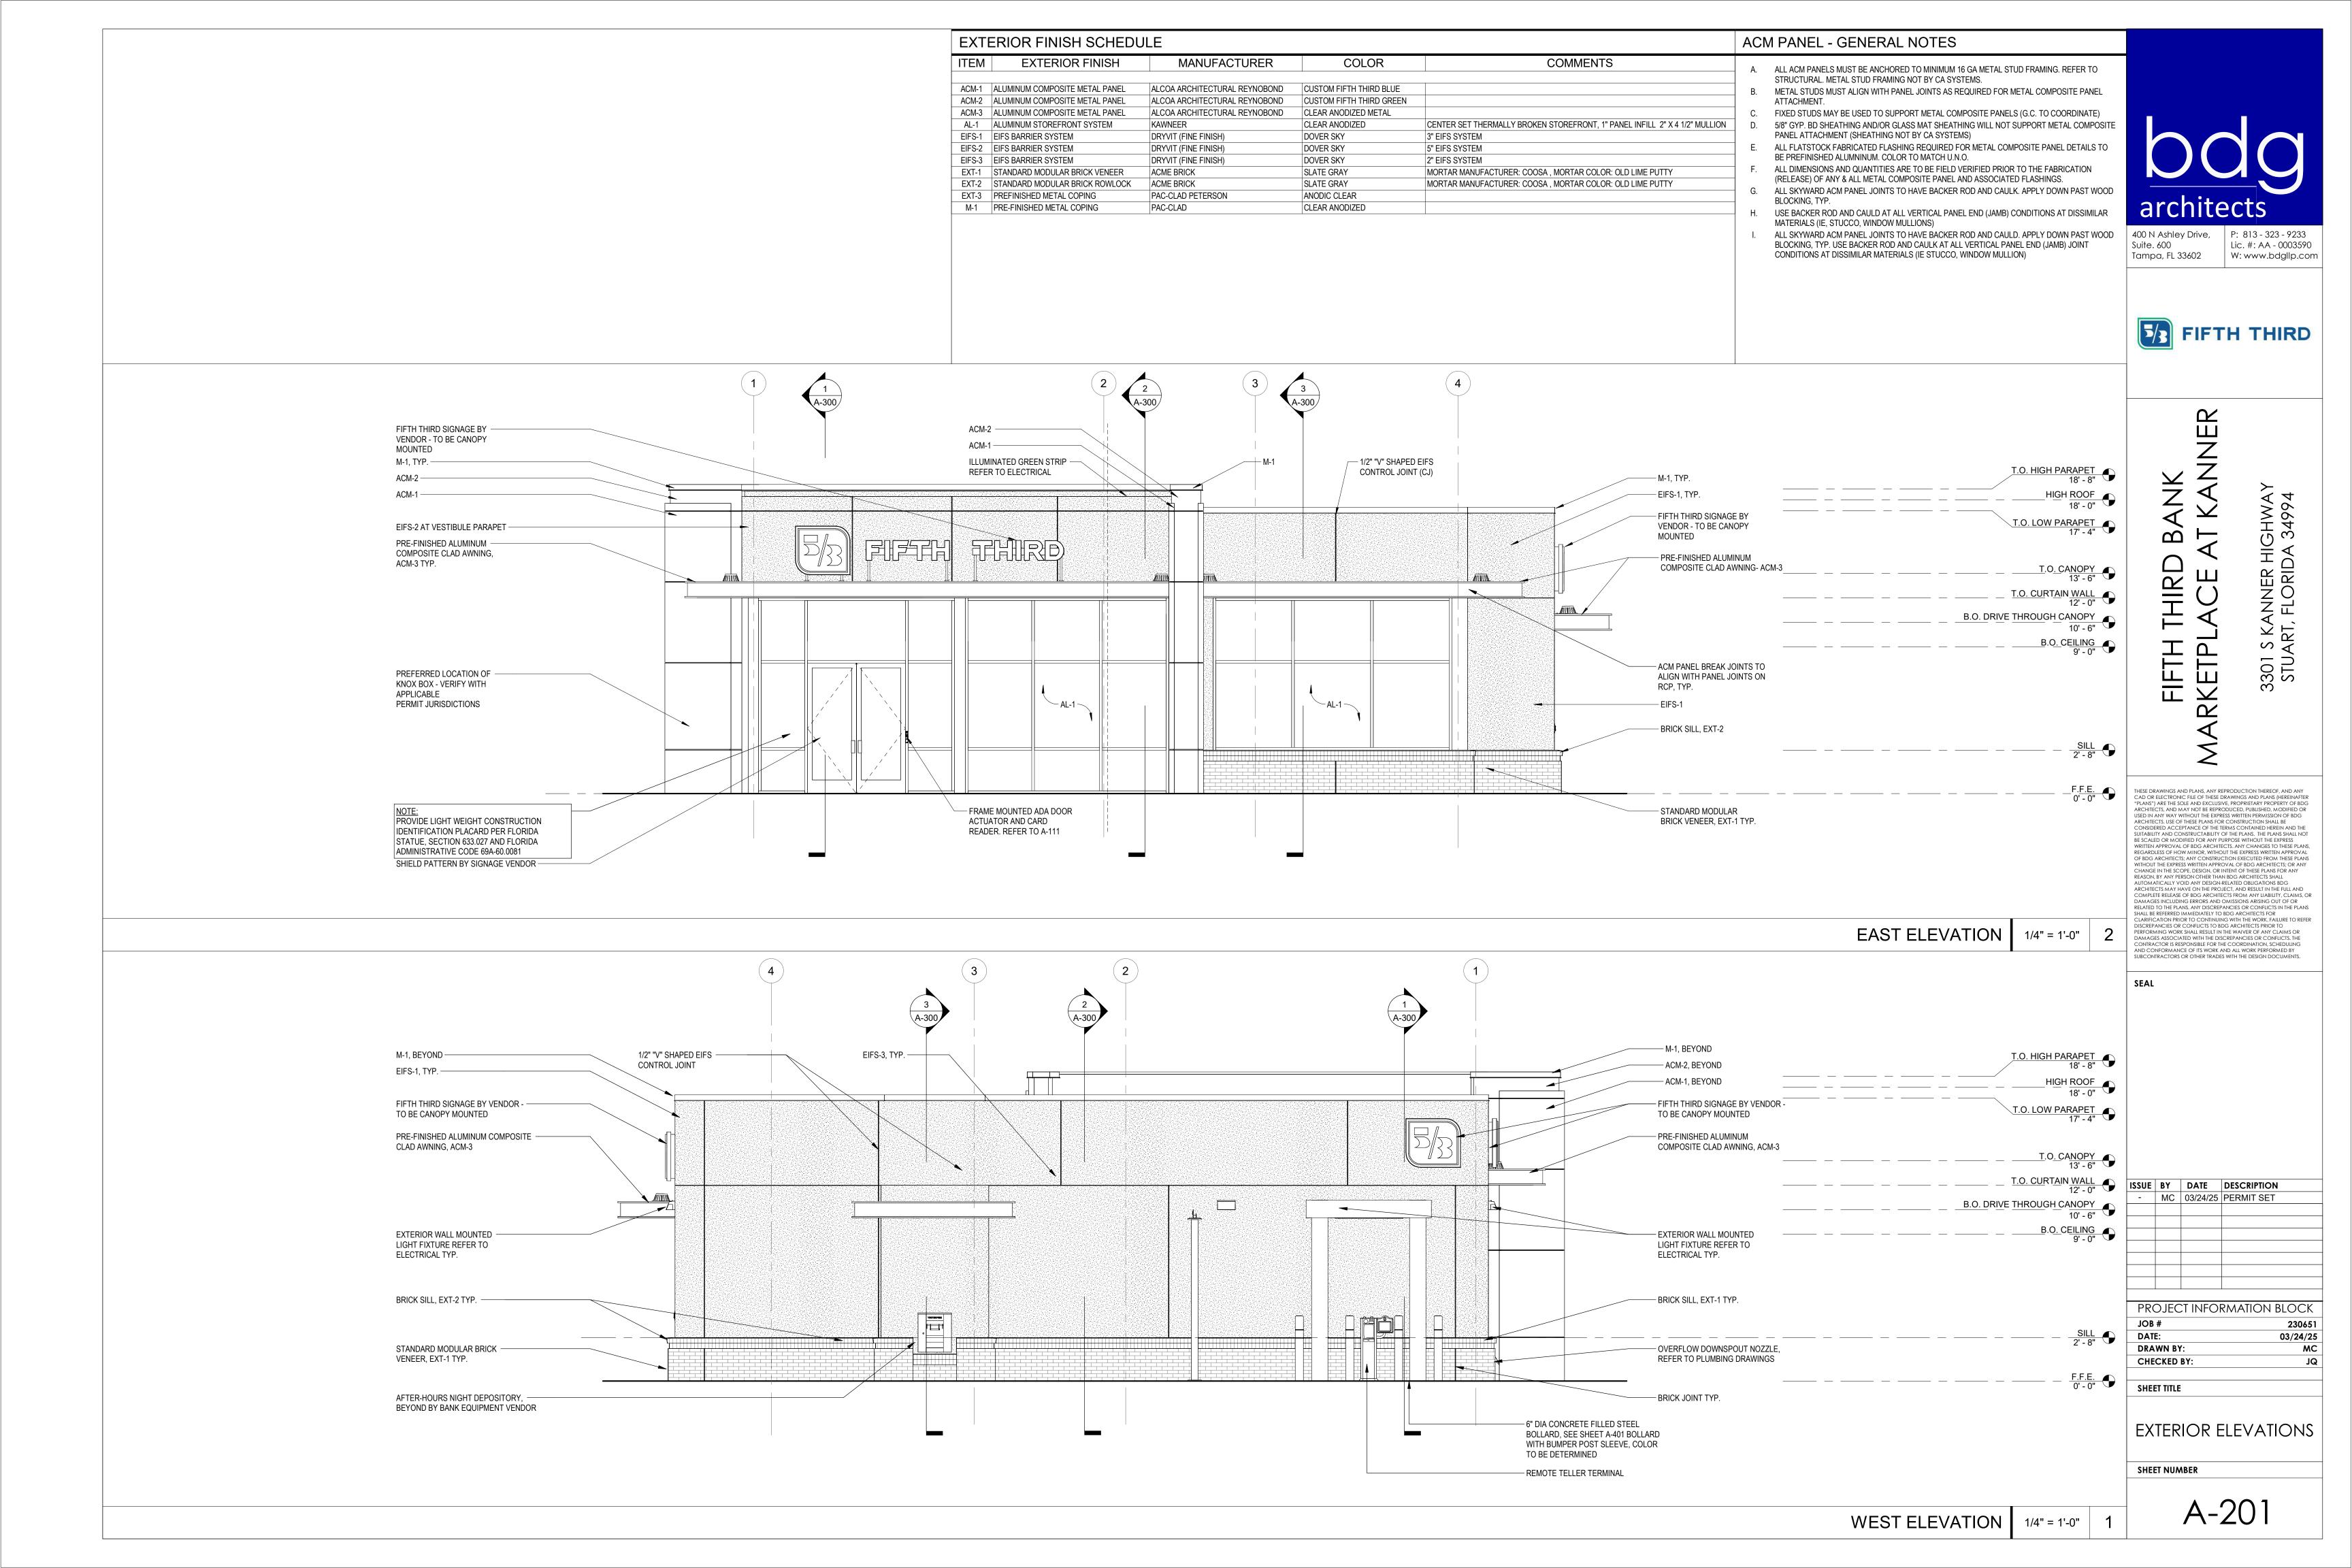
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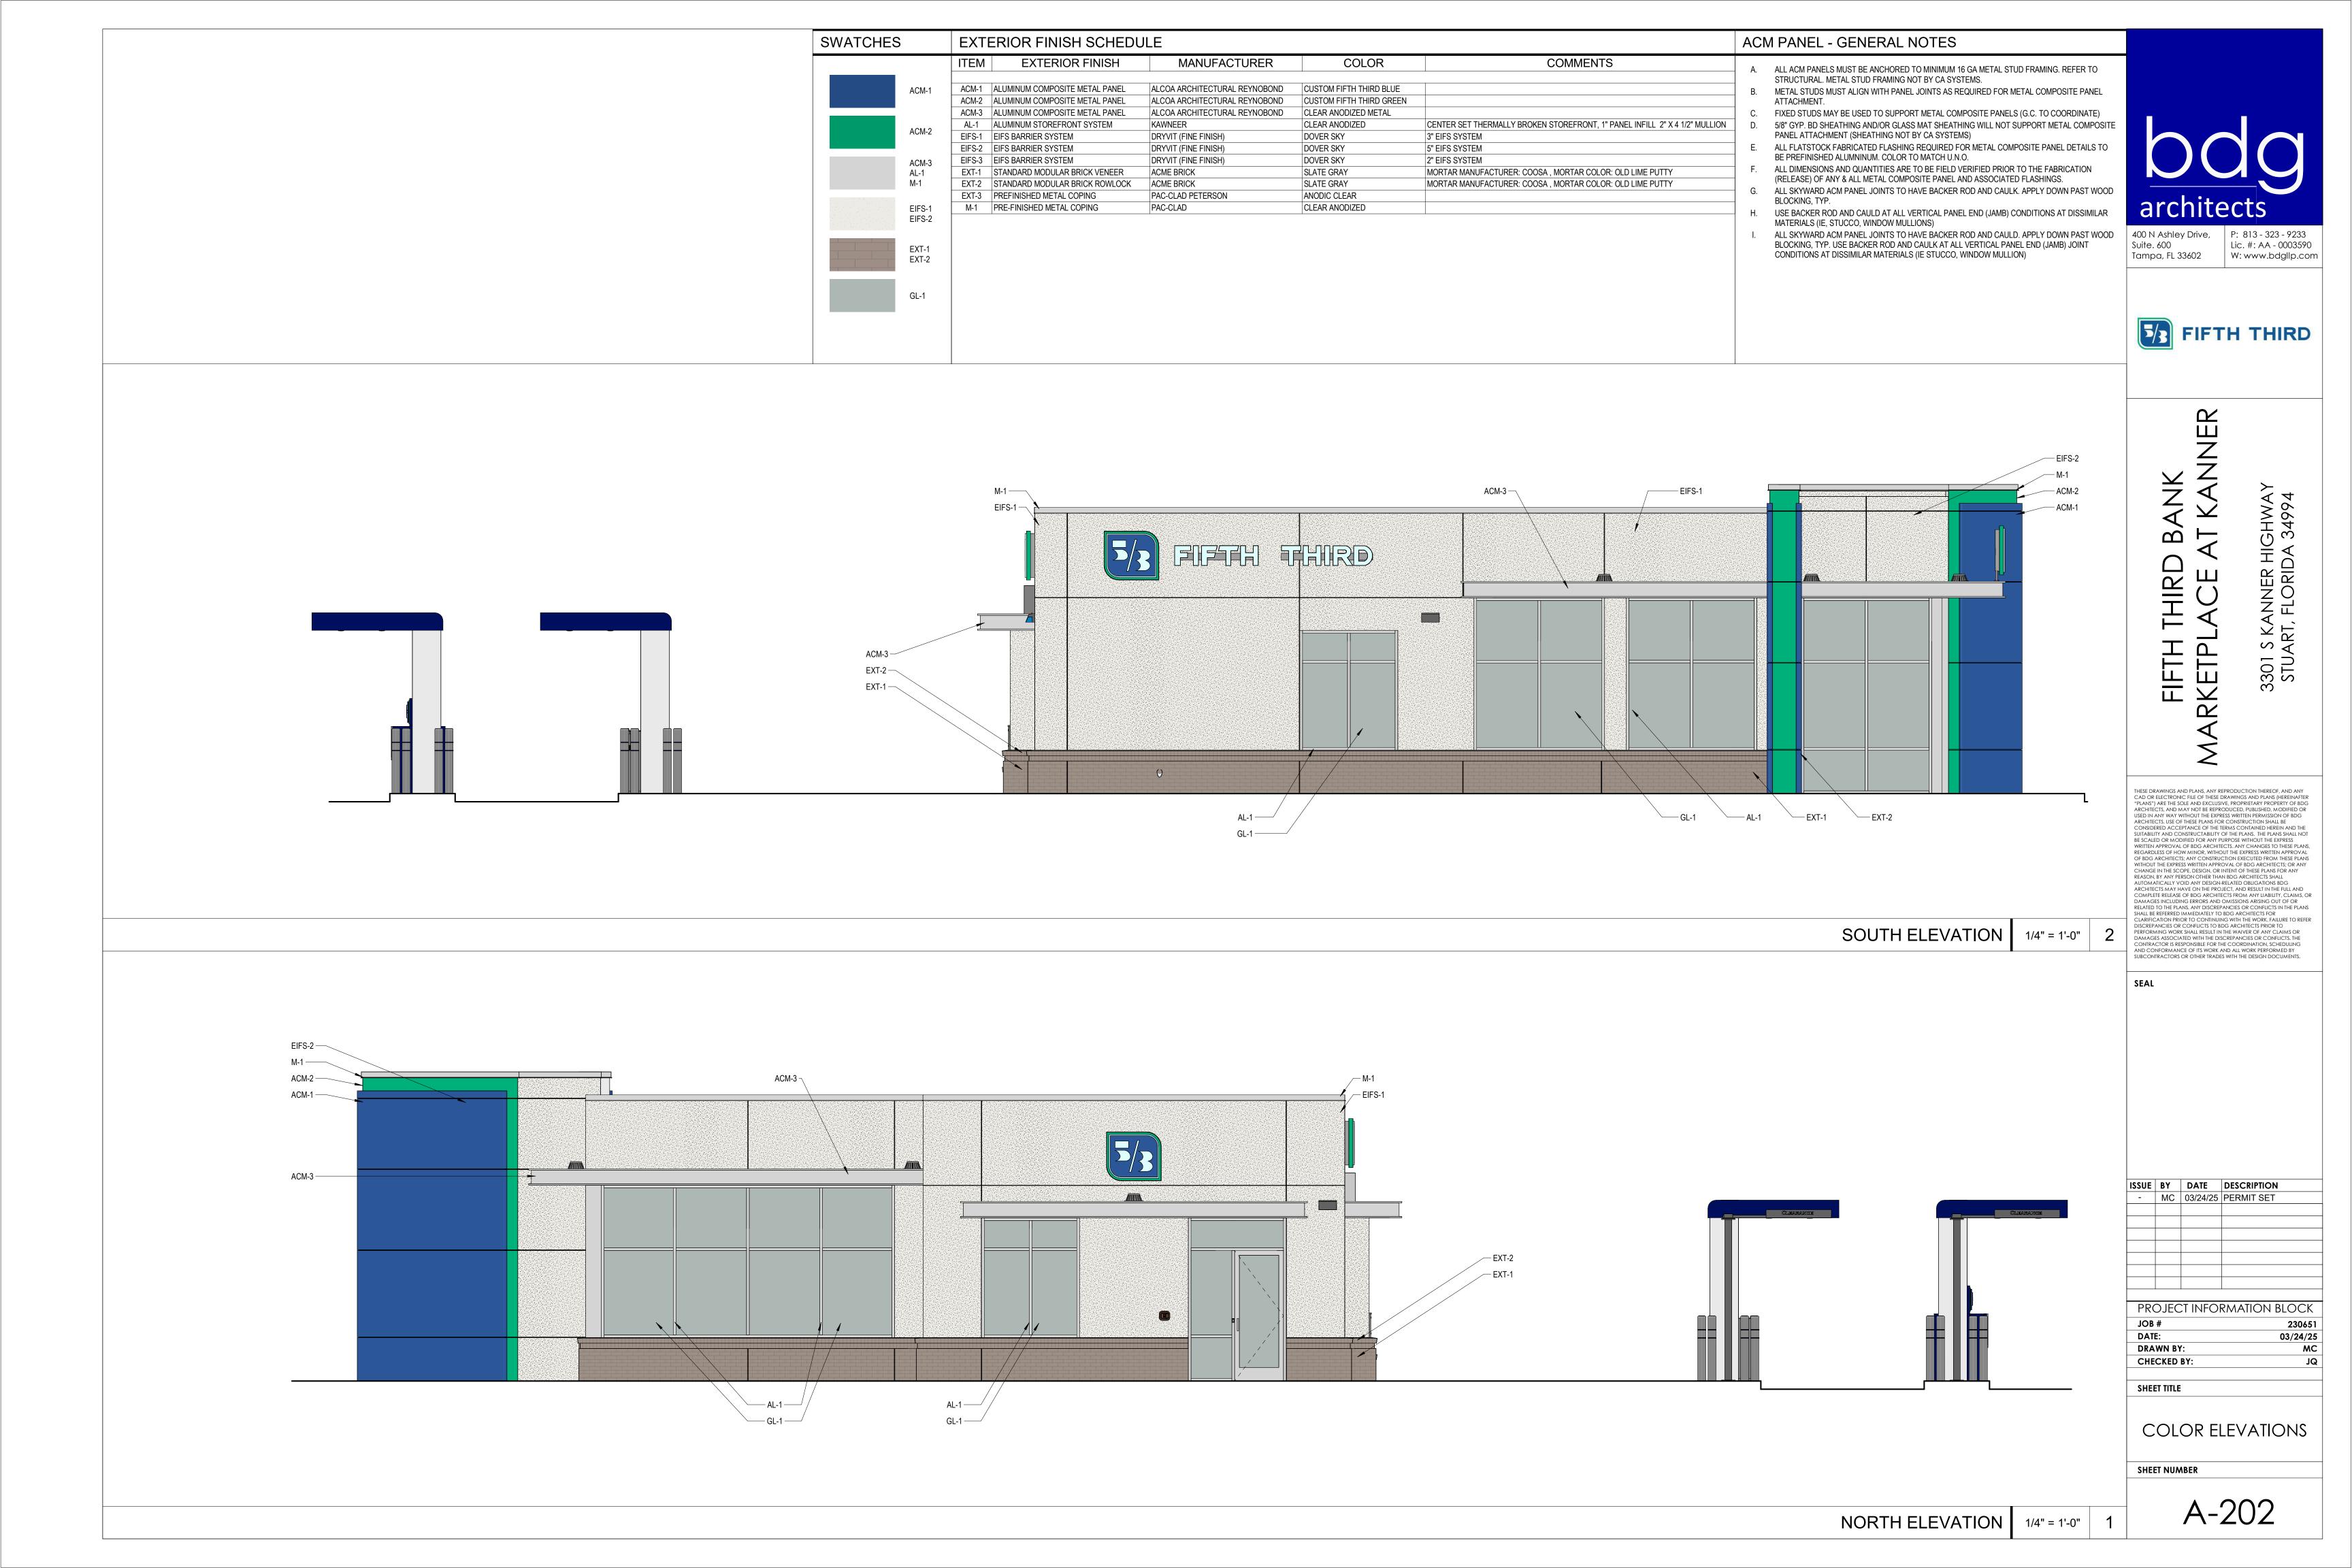
VENDOR


63.5" H x 32" W x 38" D





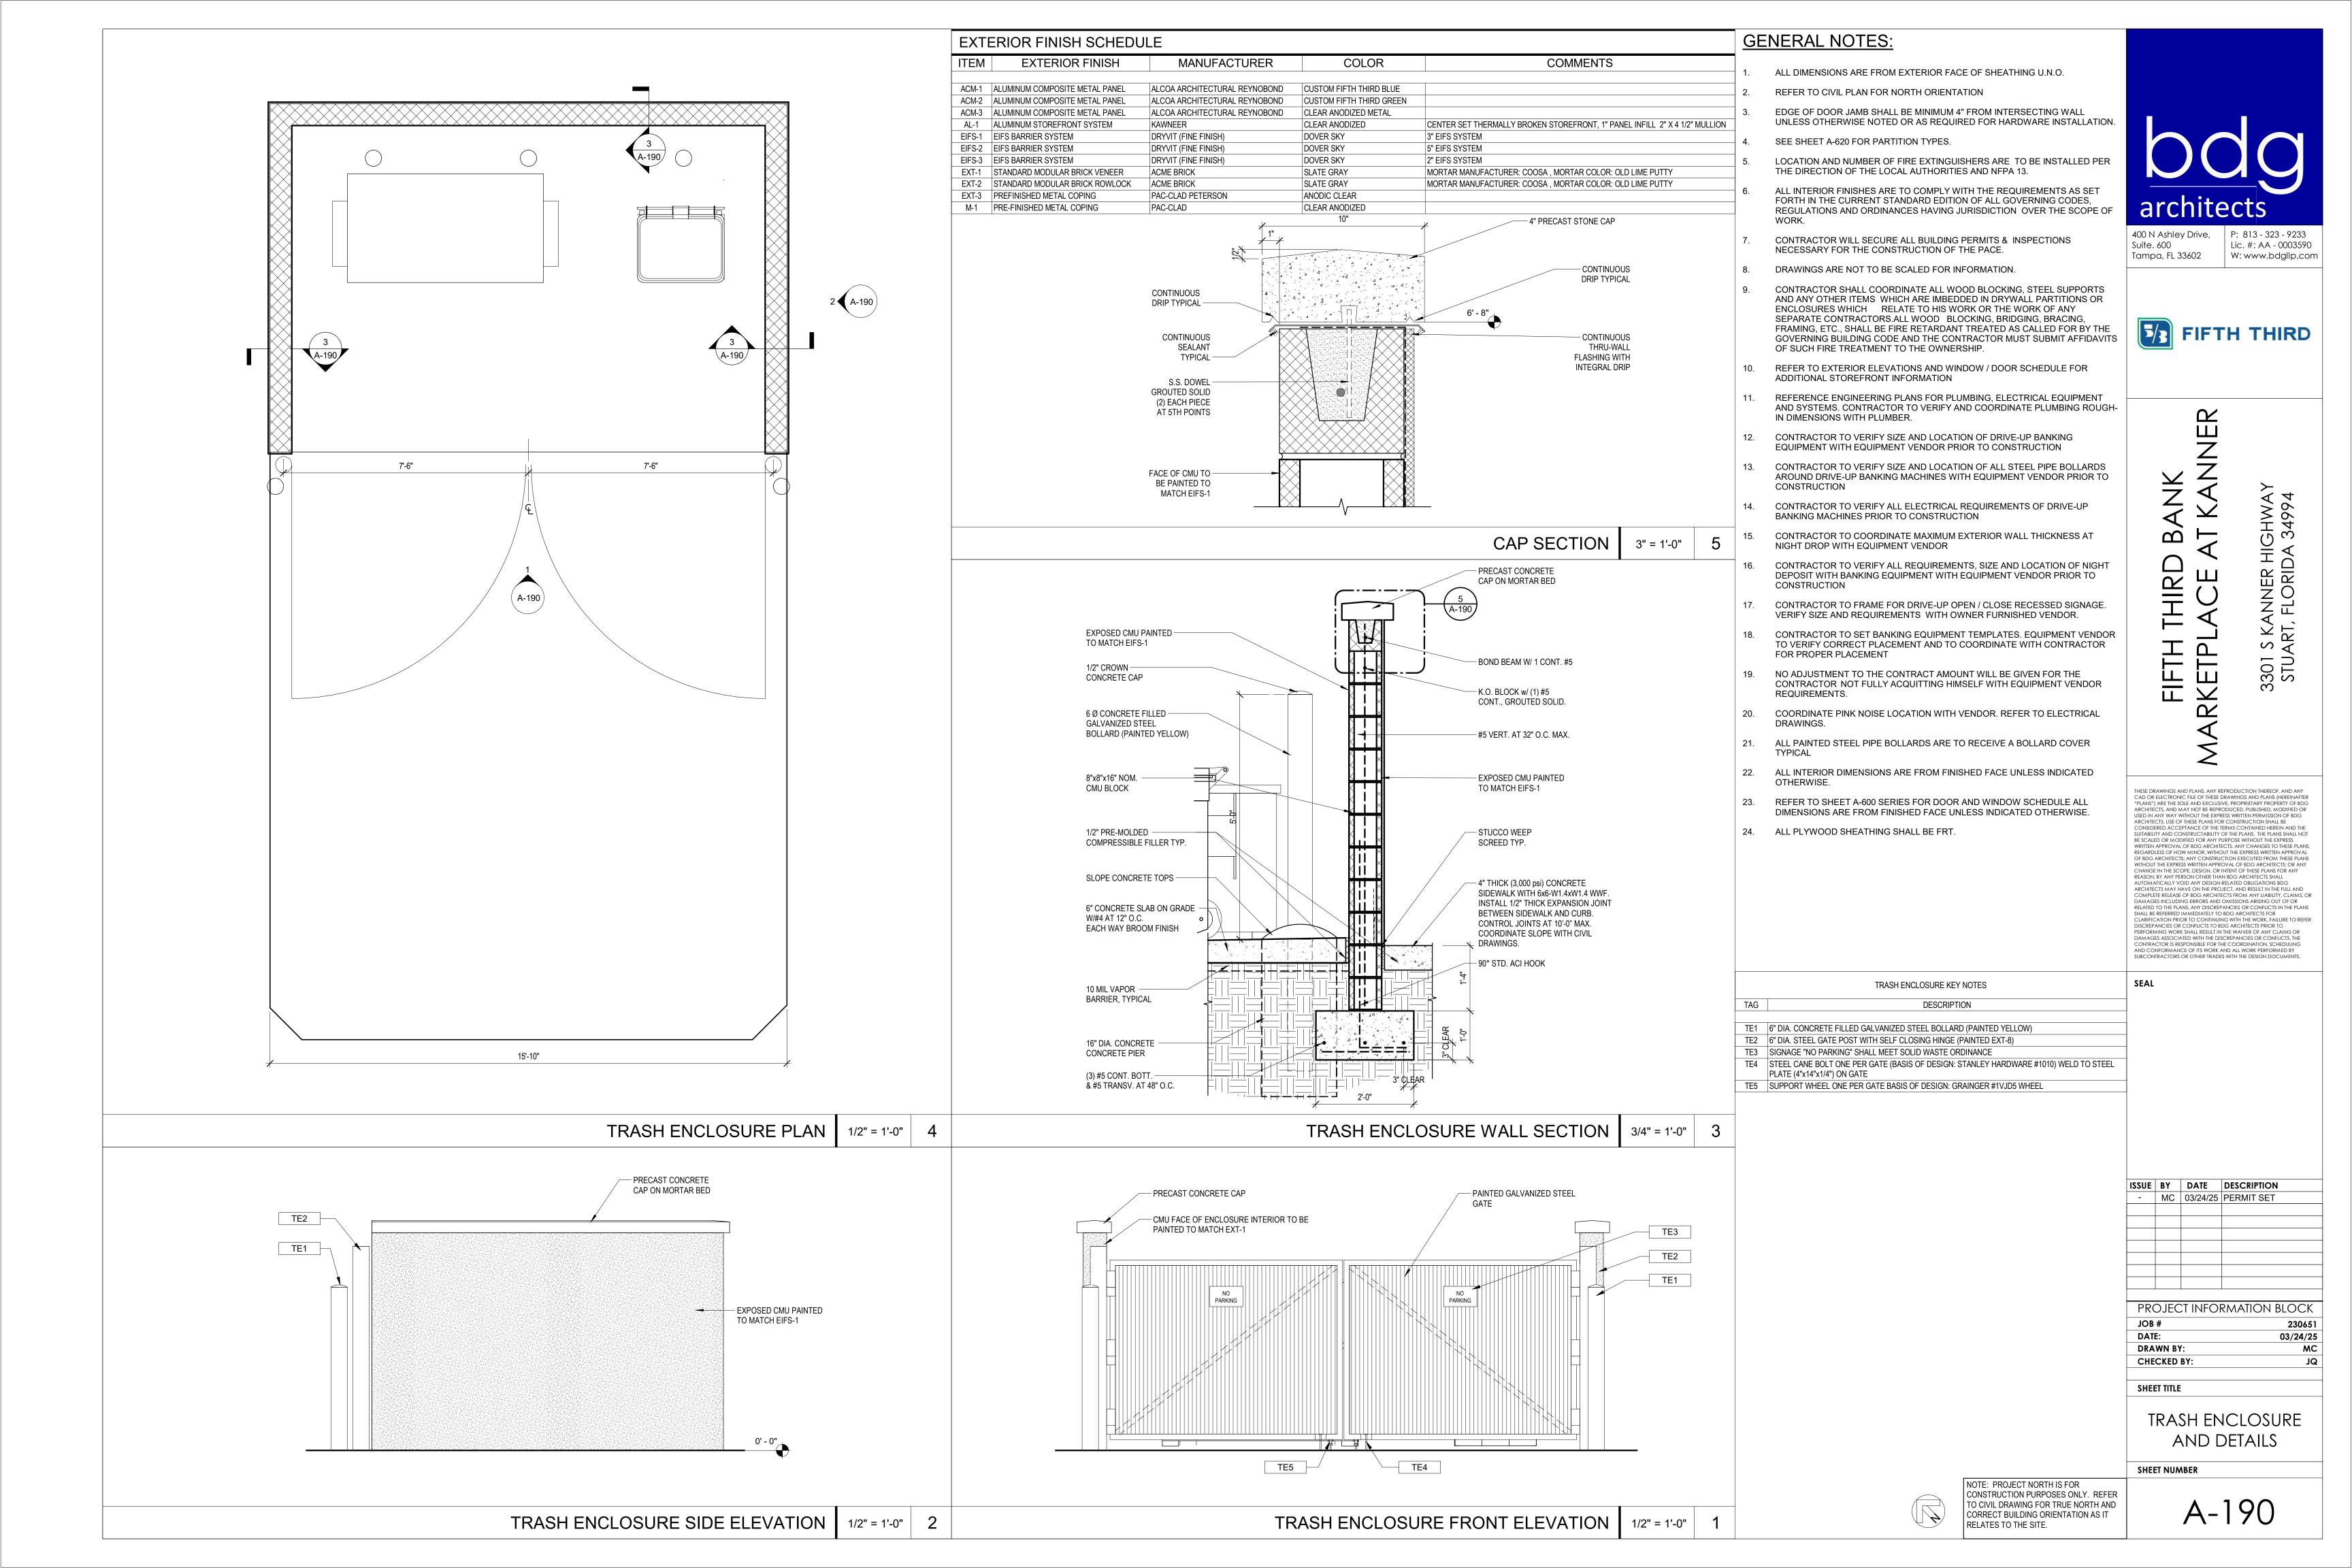

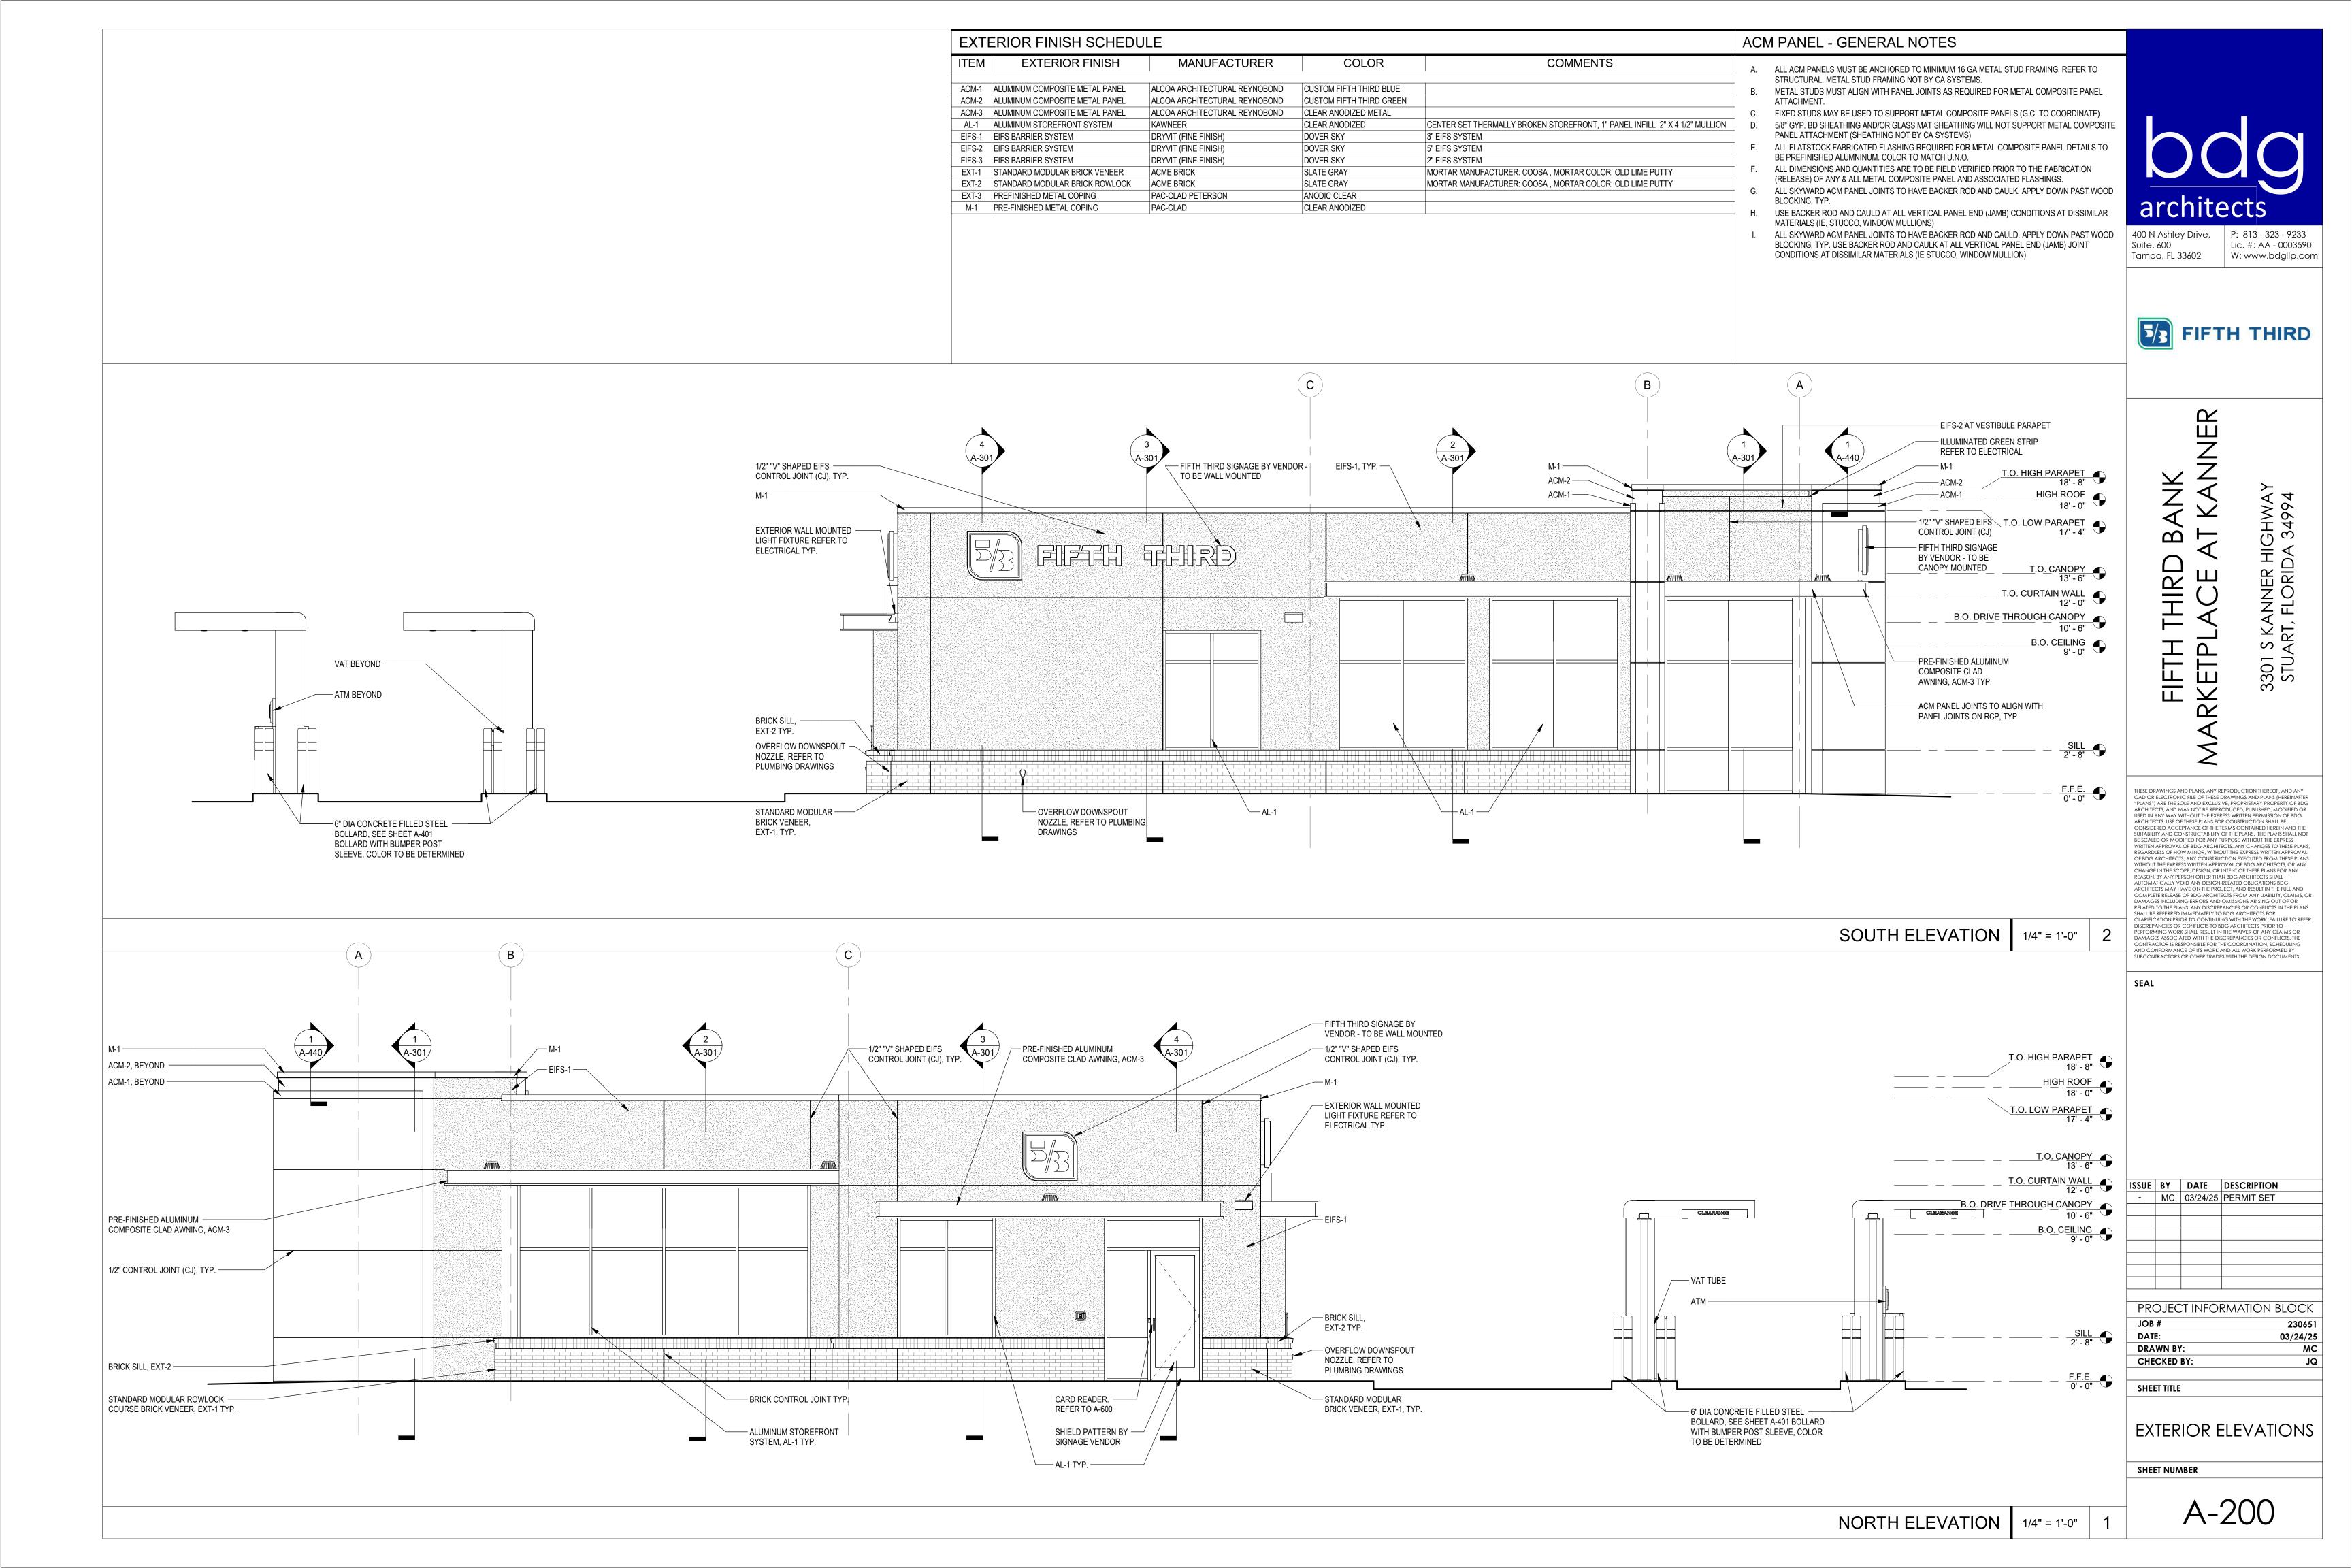

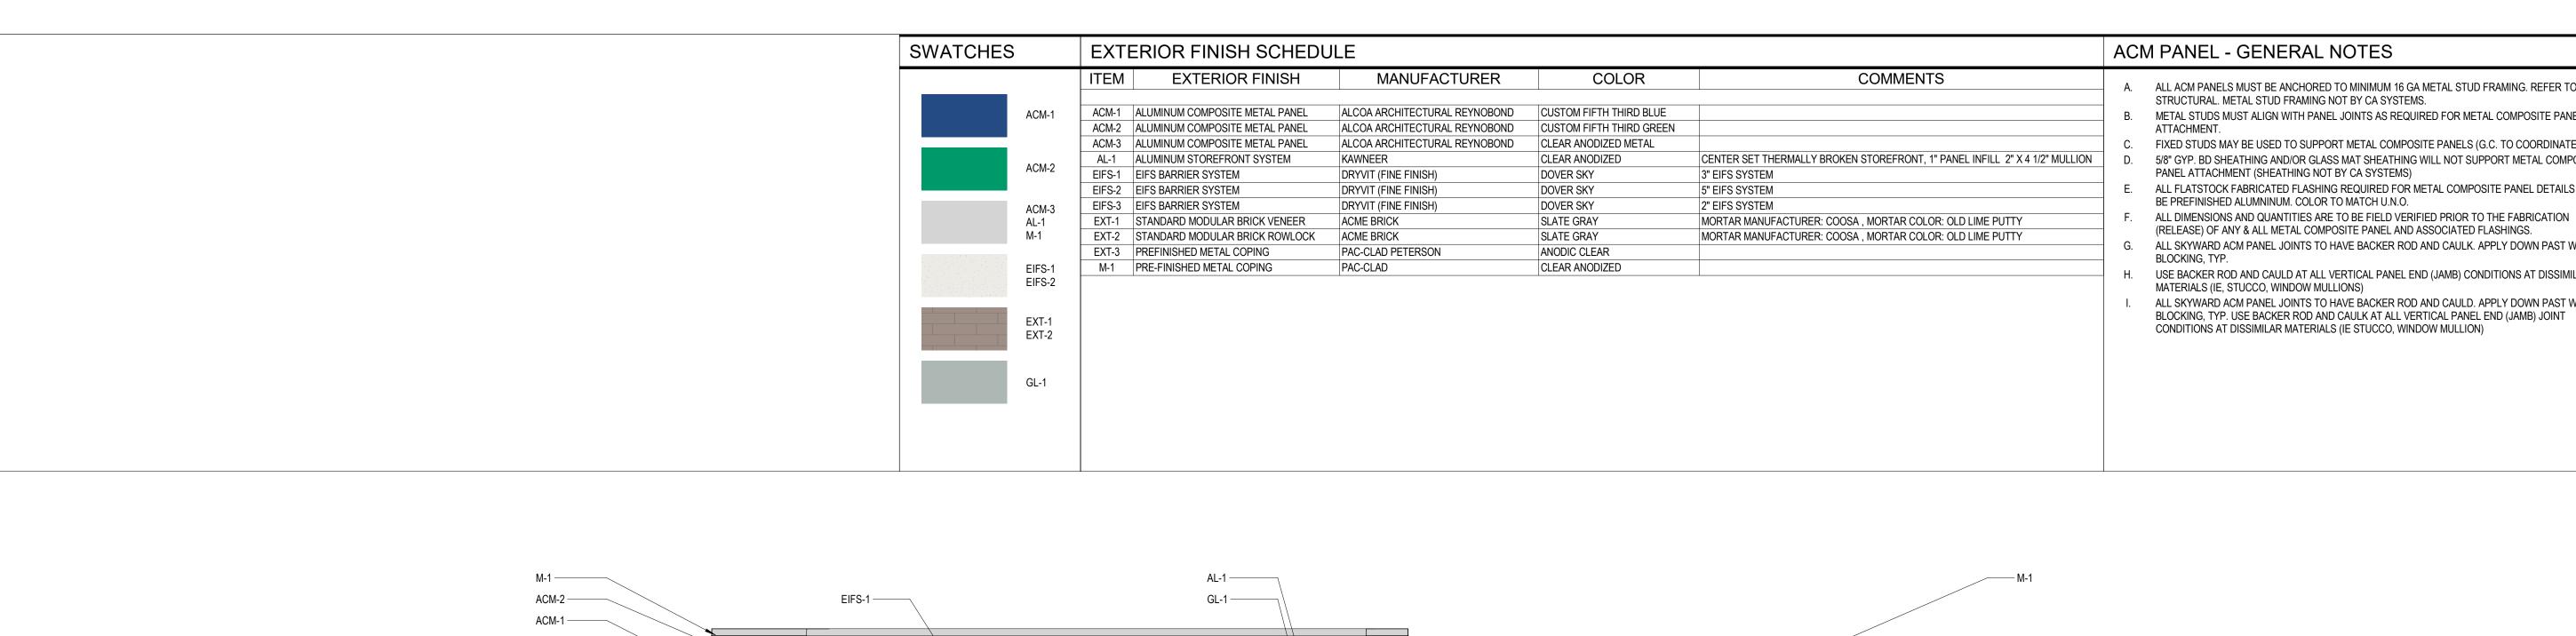

Δ	ALL ACM PANELS MUST BE ANCHORED TO MINIMUM 16 GA METAL STUD FRAMING. REFER TO
Λ.	ALE ACIVITANCES MOST BE ANOTHORIZED TO MINIMONI 10 OA MILTAL STOD I NAMIMO. NEI EN TO
	STRUCTURAL. METAL STUD FRAMING NOT BY CA SYSTEMS.
i	CITICOTOTAL. METAL CIODITA MINITOTICI DI OMOTOTEMO.

- B. METAL STUDS MUST ALIGN WITH PANEL JOINTS AS REQUIRED FOR METAL COMPOSITE PANEL
- FIXED STUDS MAY BE USED TO SUPPORT METAL COMPOSITE PANELS (G.C. TO COORDINATE)
- 5/8" GYP. BD SHEATHING AND/OR GLASS MAT SHEATHING WILL NOT SUPPORT METAL COMPOSITE PANEL ATTACHMENT (SHEATHING NOT BY CA SYSTEMS)
- E. ALL FLATSTOCK FABRICATED FLASHING REQUIRED FOR METAL COMPOSITE PANEL DETAILS TO BE PREFINISHED ALUMNINUM. COLOR TO MATCH U.N.O.
- (RELEASE) OF ANY & ALL METAL COMPOSITE PANEL AND ASSOCIATED FLASHINGS. G. ALL SKYWARD ACM PANEL JOINTS TO HAVE BACKER ROD AND CAULK. APPLY DOWN PAST WOOD
- BLOCKING, TYP. USE BACKER ROD AND CAULD AT ALL VERTICAL PANEL END (JAMB) CONDITIONS AT DISSIMILAR
- MATERIALS (IE, STUCCO, WINDOW MULLIONS) ALL SKYWARD ACM PANEL JOINTS TO HAVE BACKER ROD AND CAULD. APPLY DOWN PAST WOOD BLOCKING, TYP. USE BACKER ROD AND CAULK AT ALL VERTICAL PANEL END (JAMB) JOINT CONDITIONS AT DISSIMILAR MATERIALS (IE STUCCO, WINDOW MULLION)



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# ANK KANNER

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SUBCONTRACTORS OR OTHER TRADES WITH THE DESIGN DOCUMENTS.

SEAL

1/4" = 1'-0"

ISSUE	BY	DATE	DESCRIPTION	
-	MC	03/24/25	PERMIT SET	

PROJECT INFOR	MATION BLOCK
JOB#	230651
DATE:	03/24/25
DRAWN BY:	MC
CHECKED BY:	JQ

SHEET TITLE


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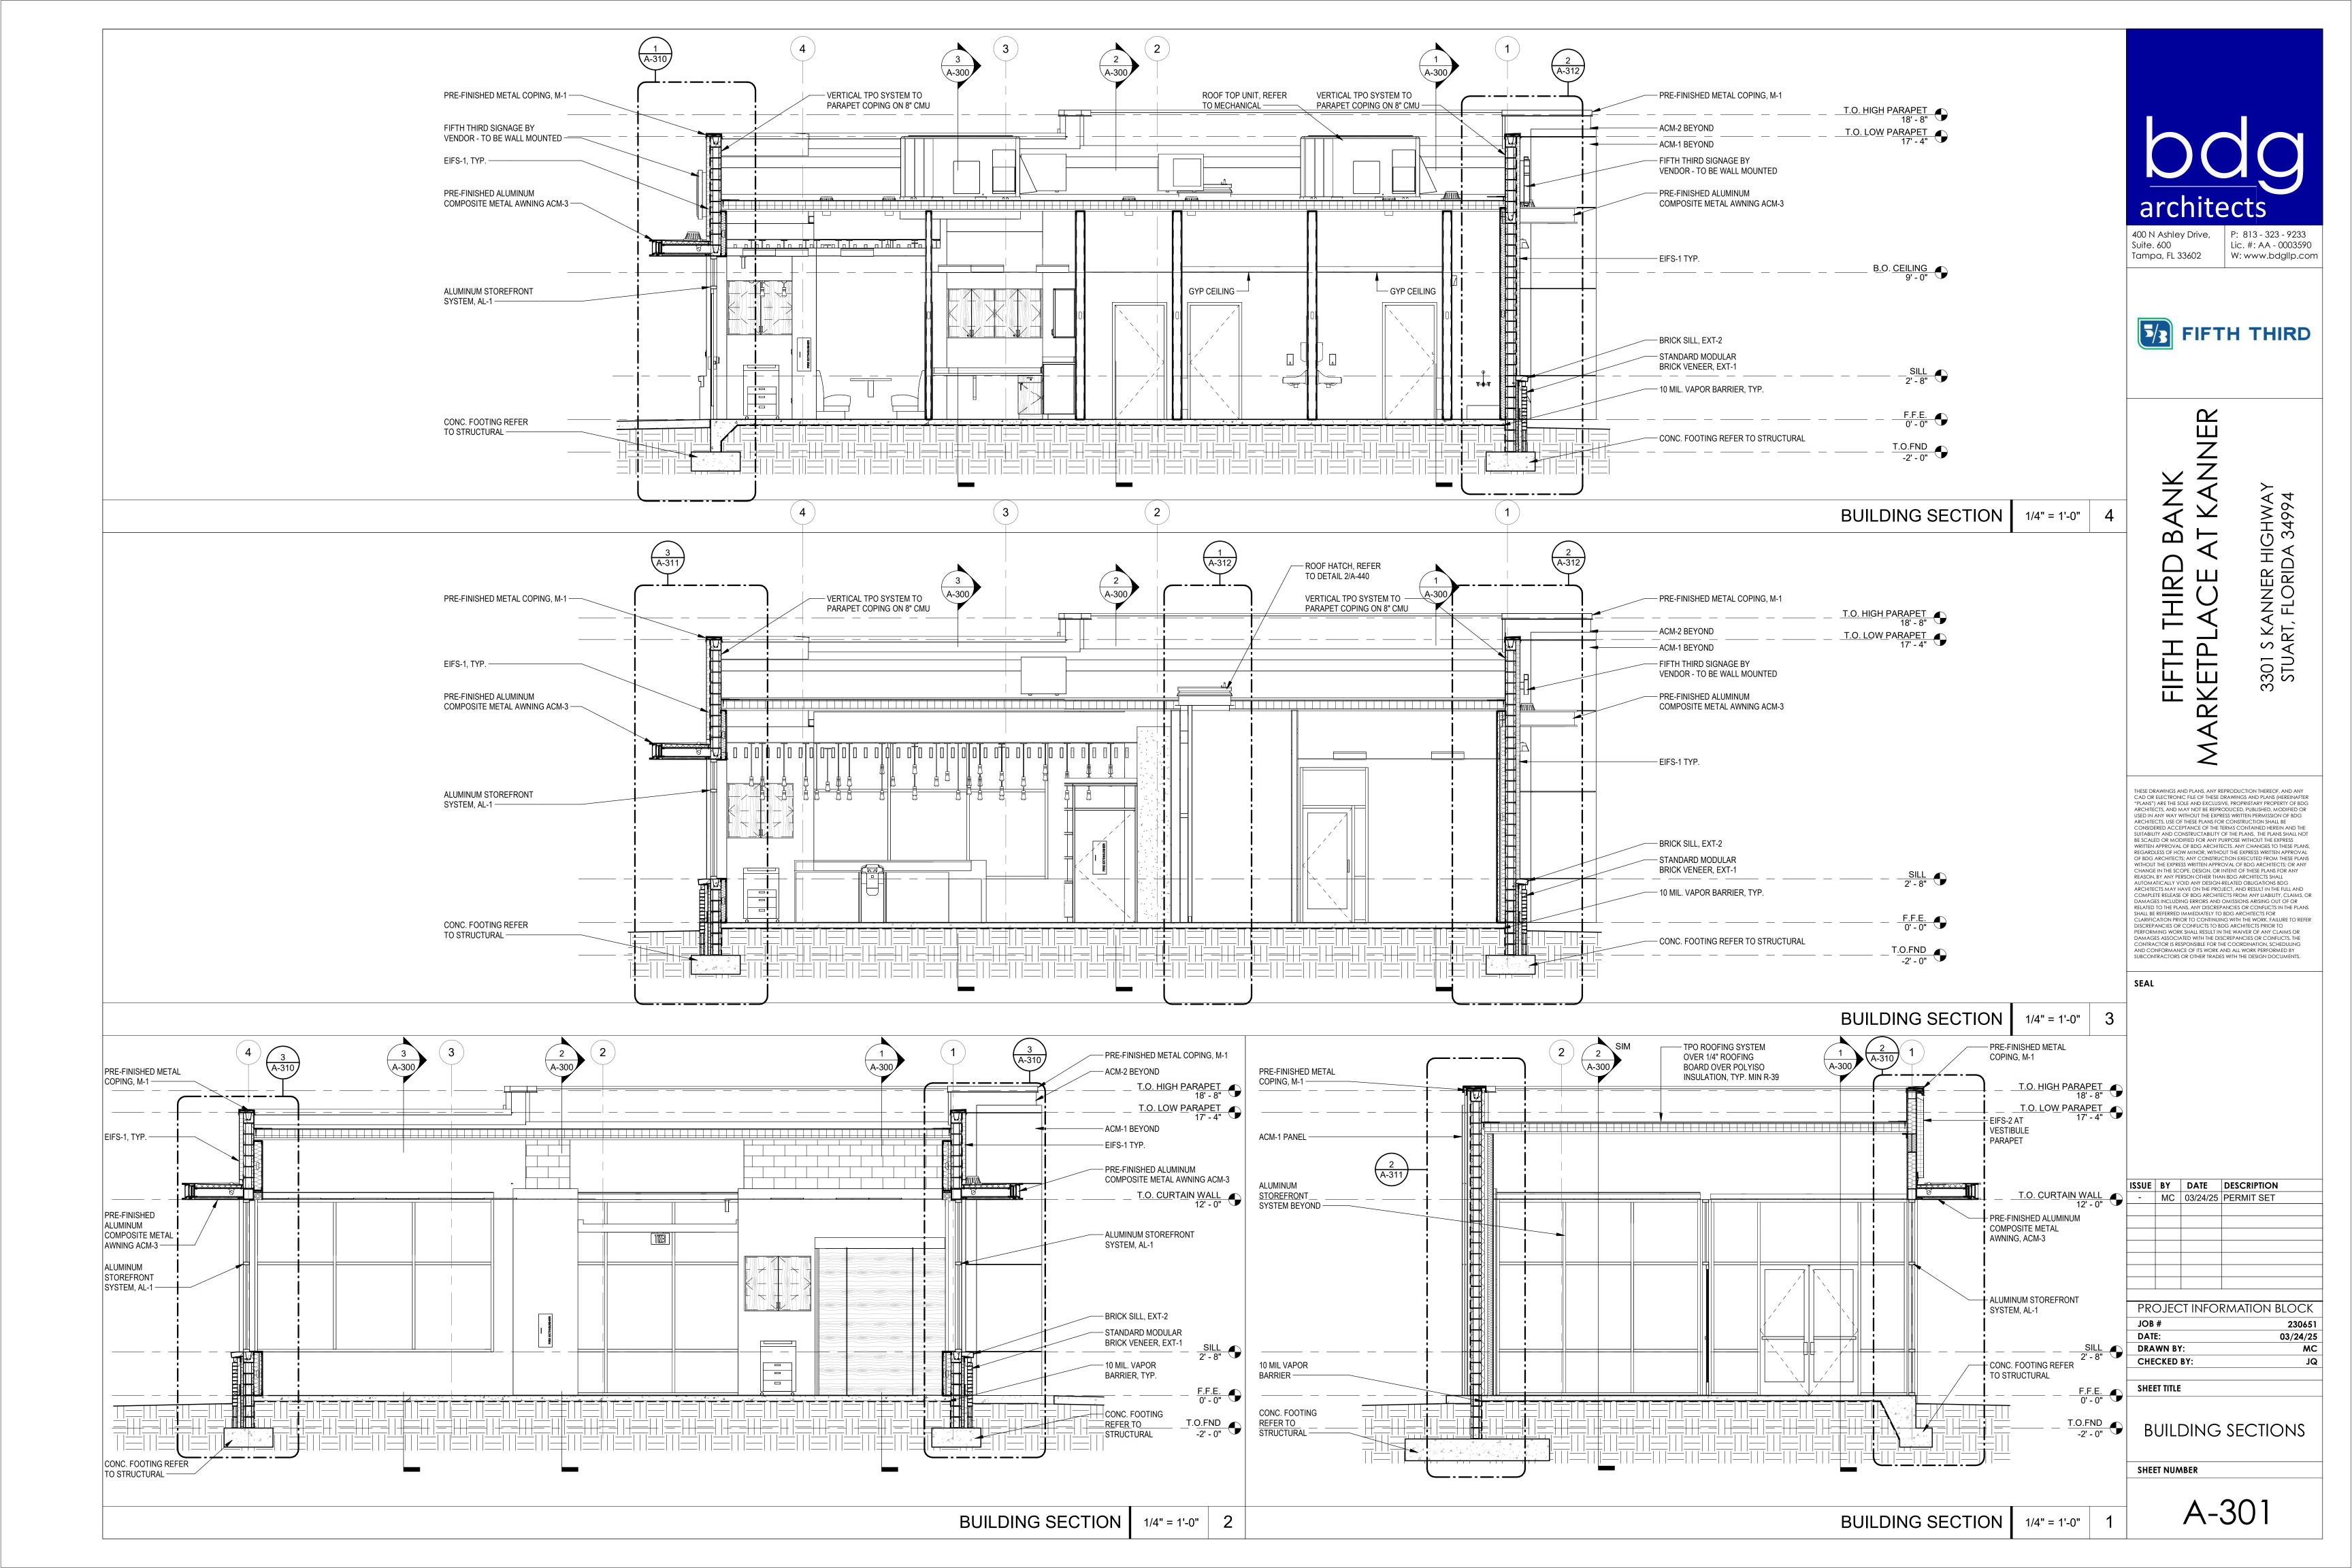
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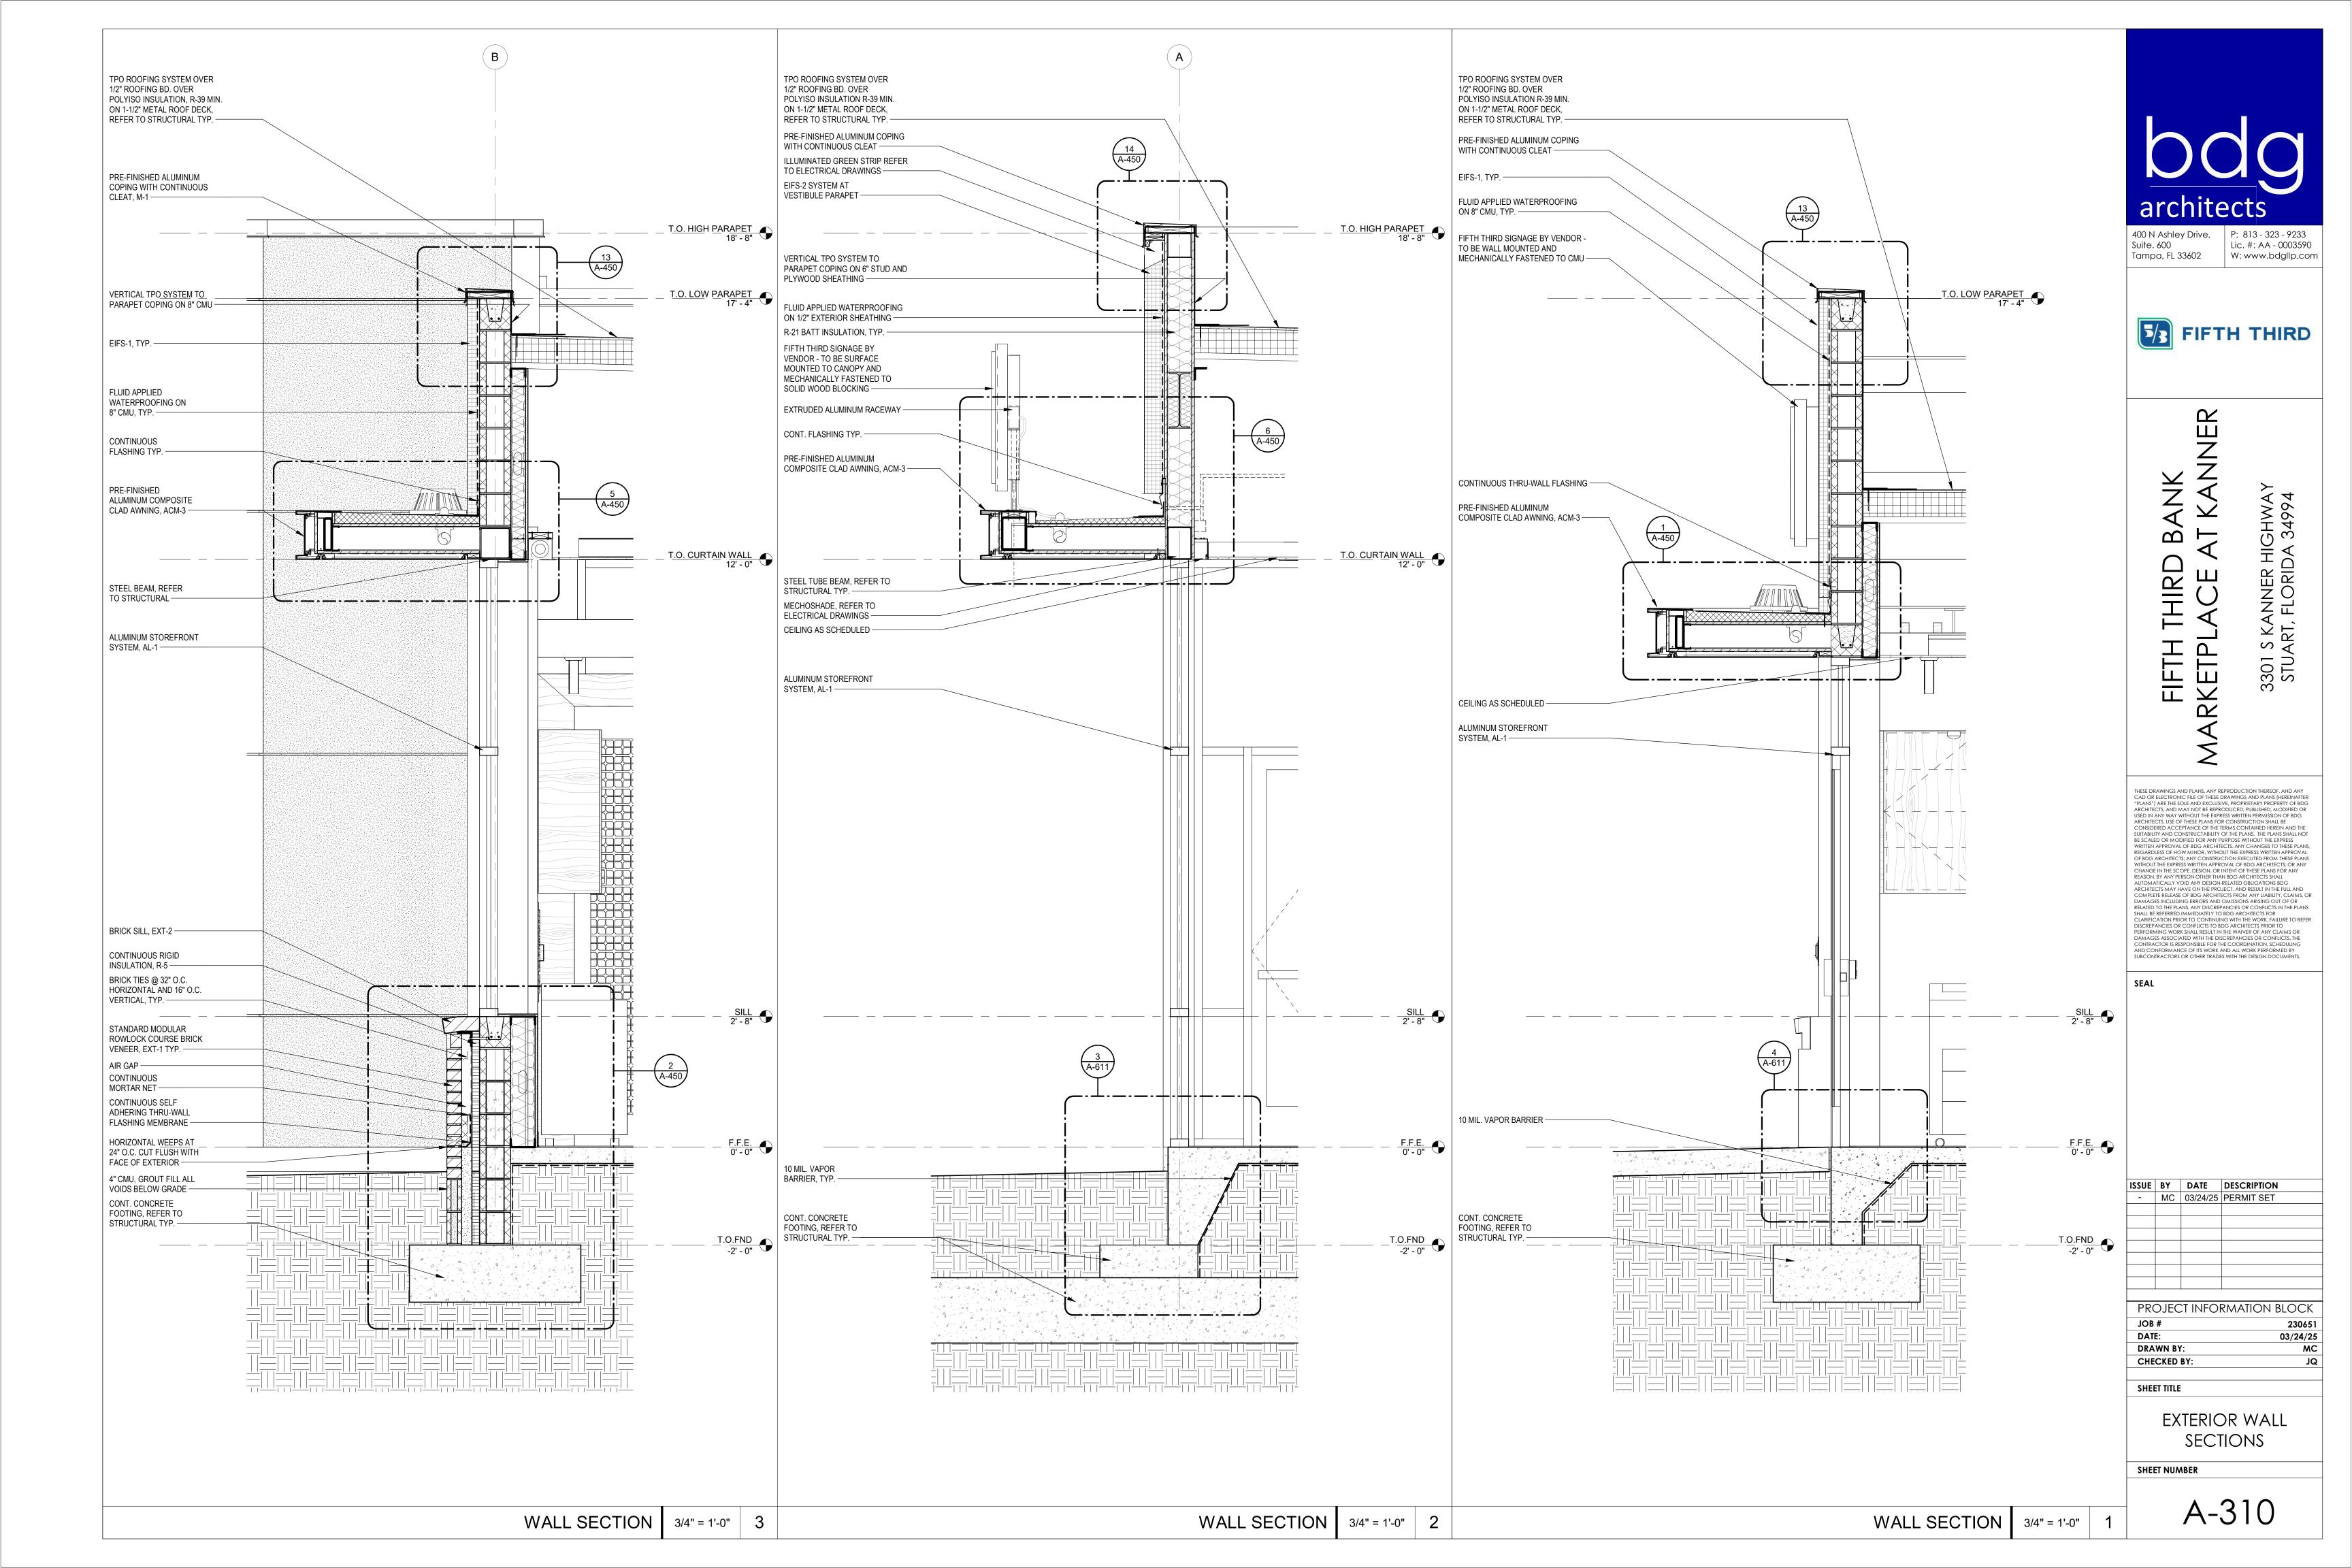
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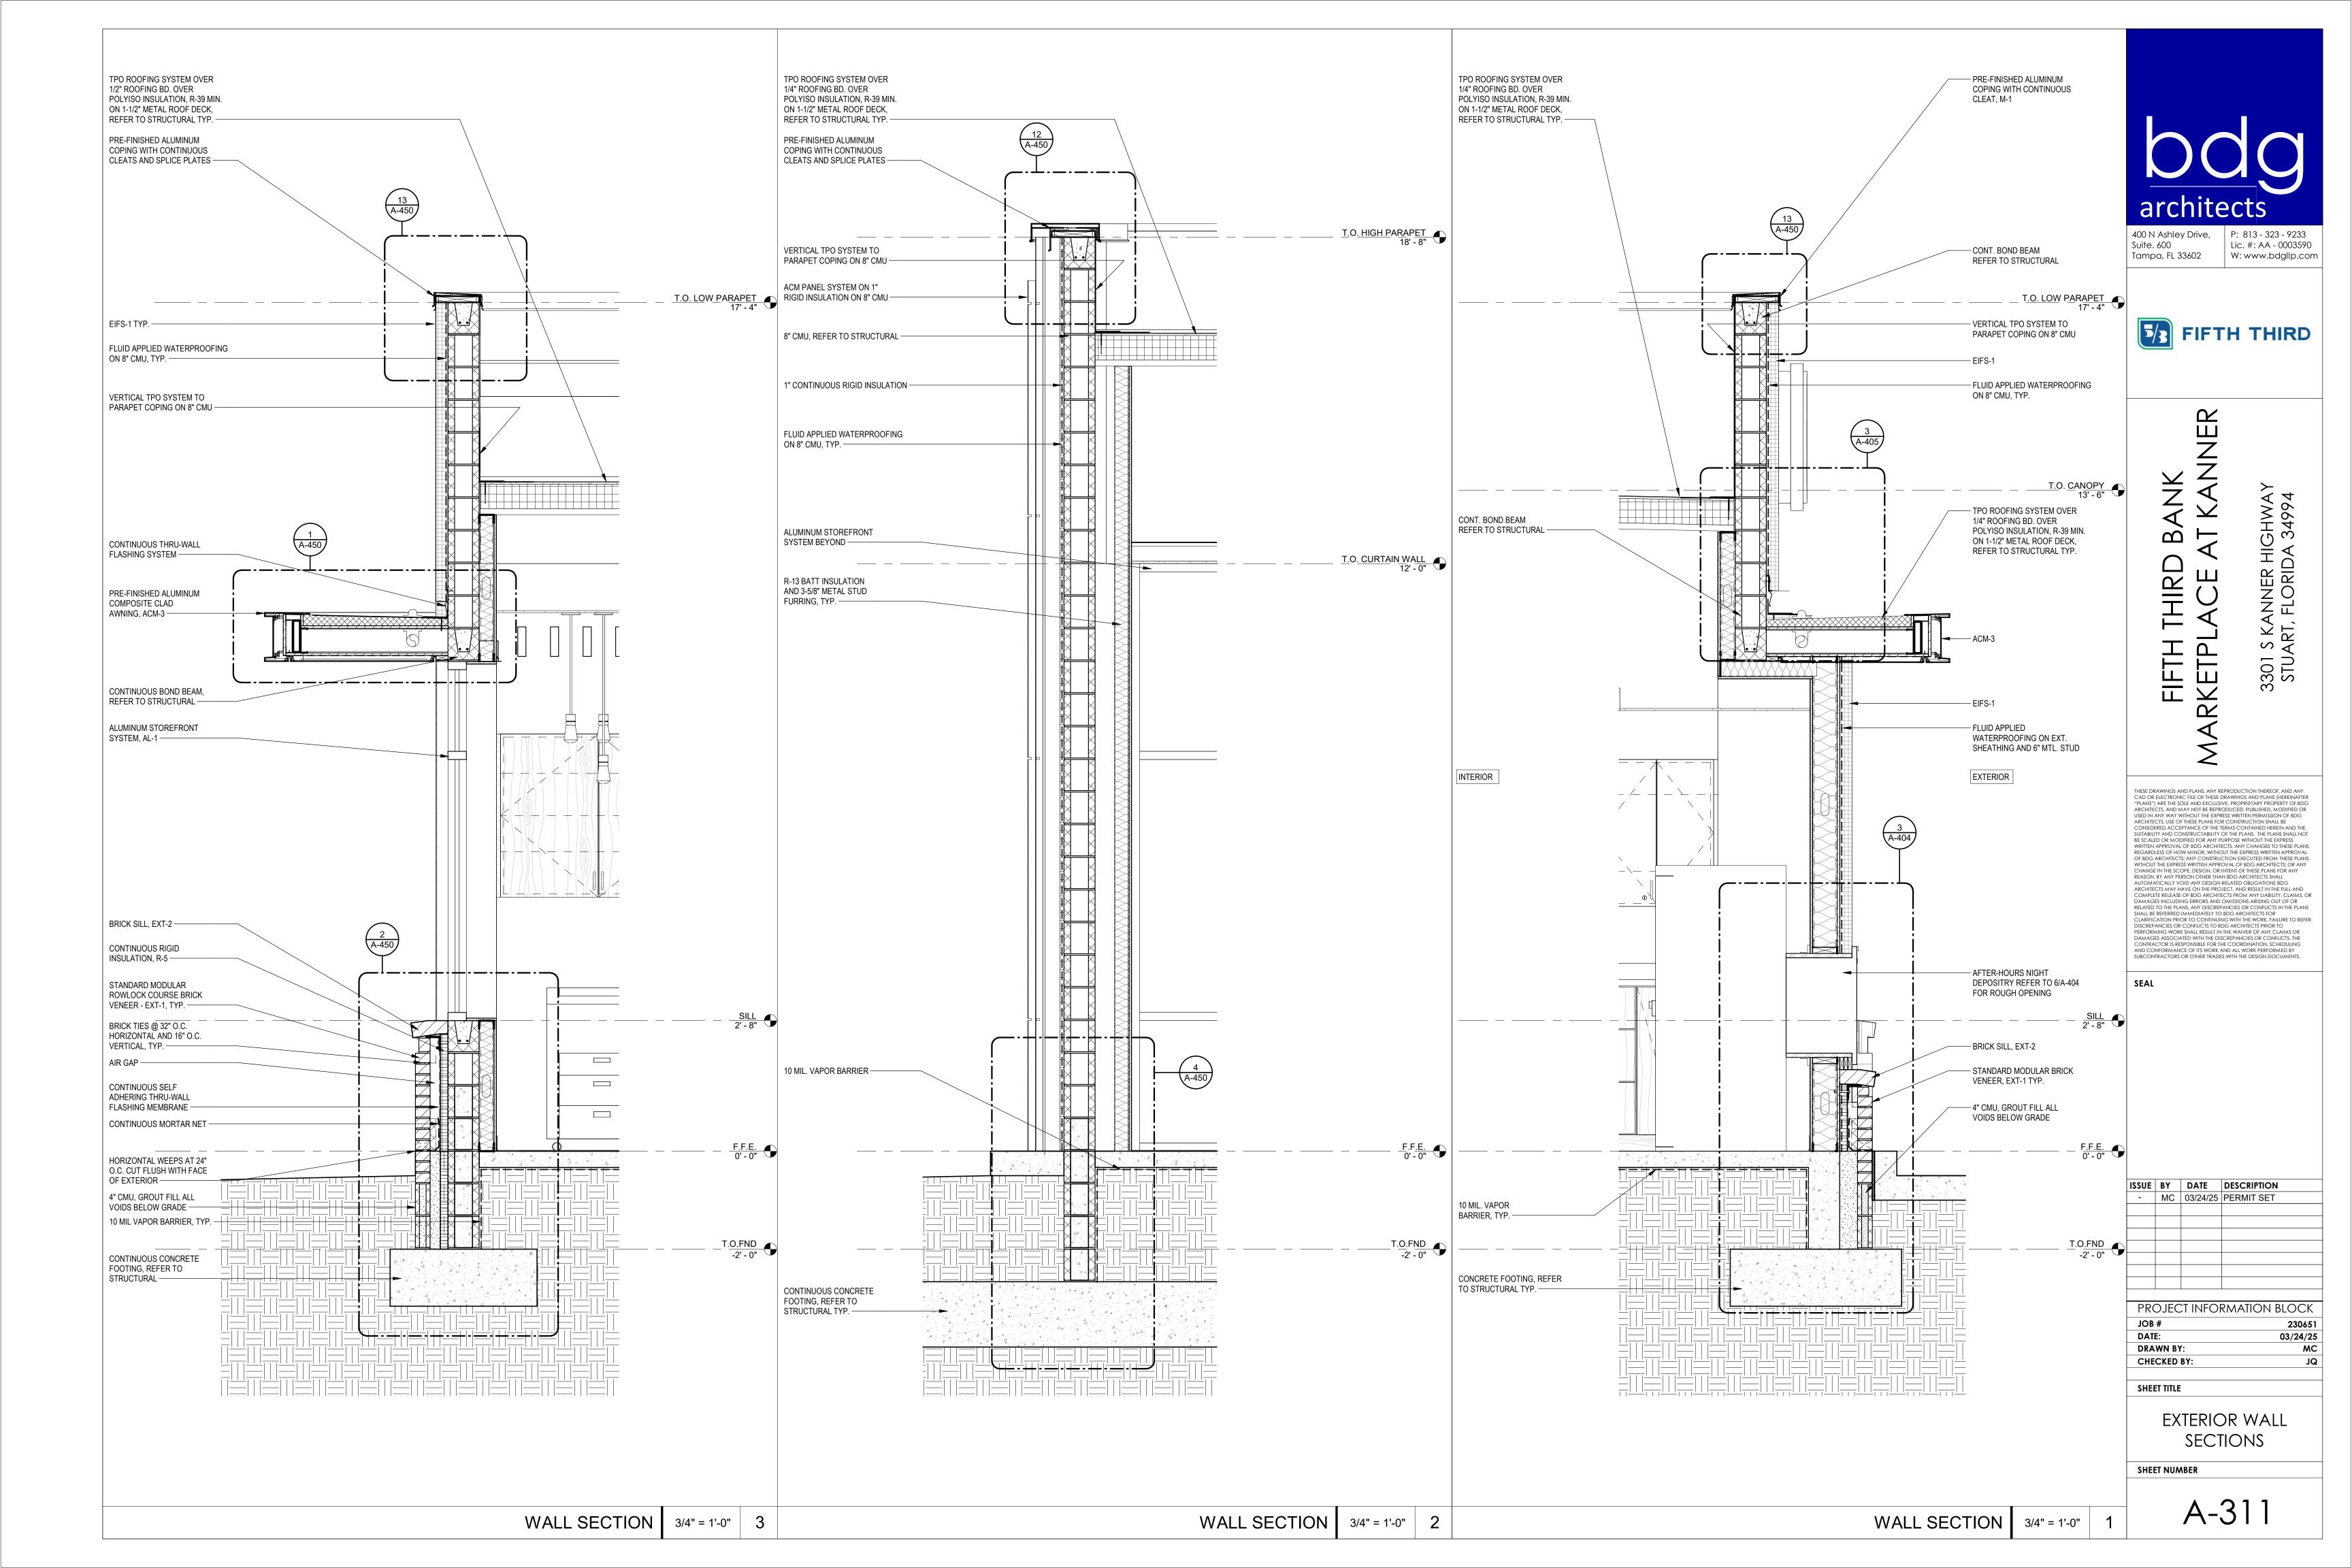
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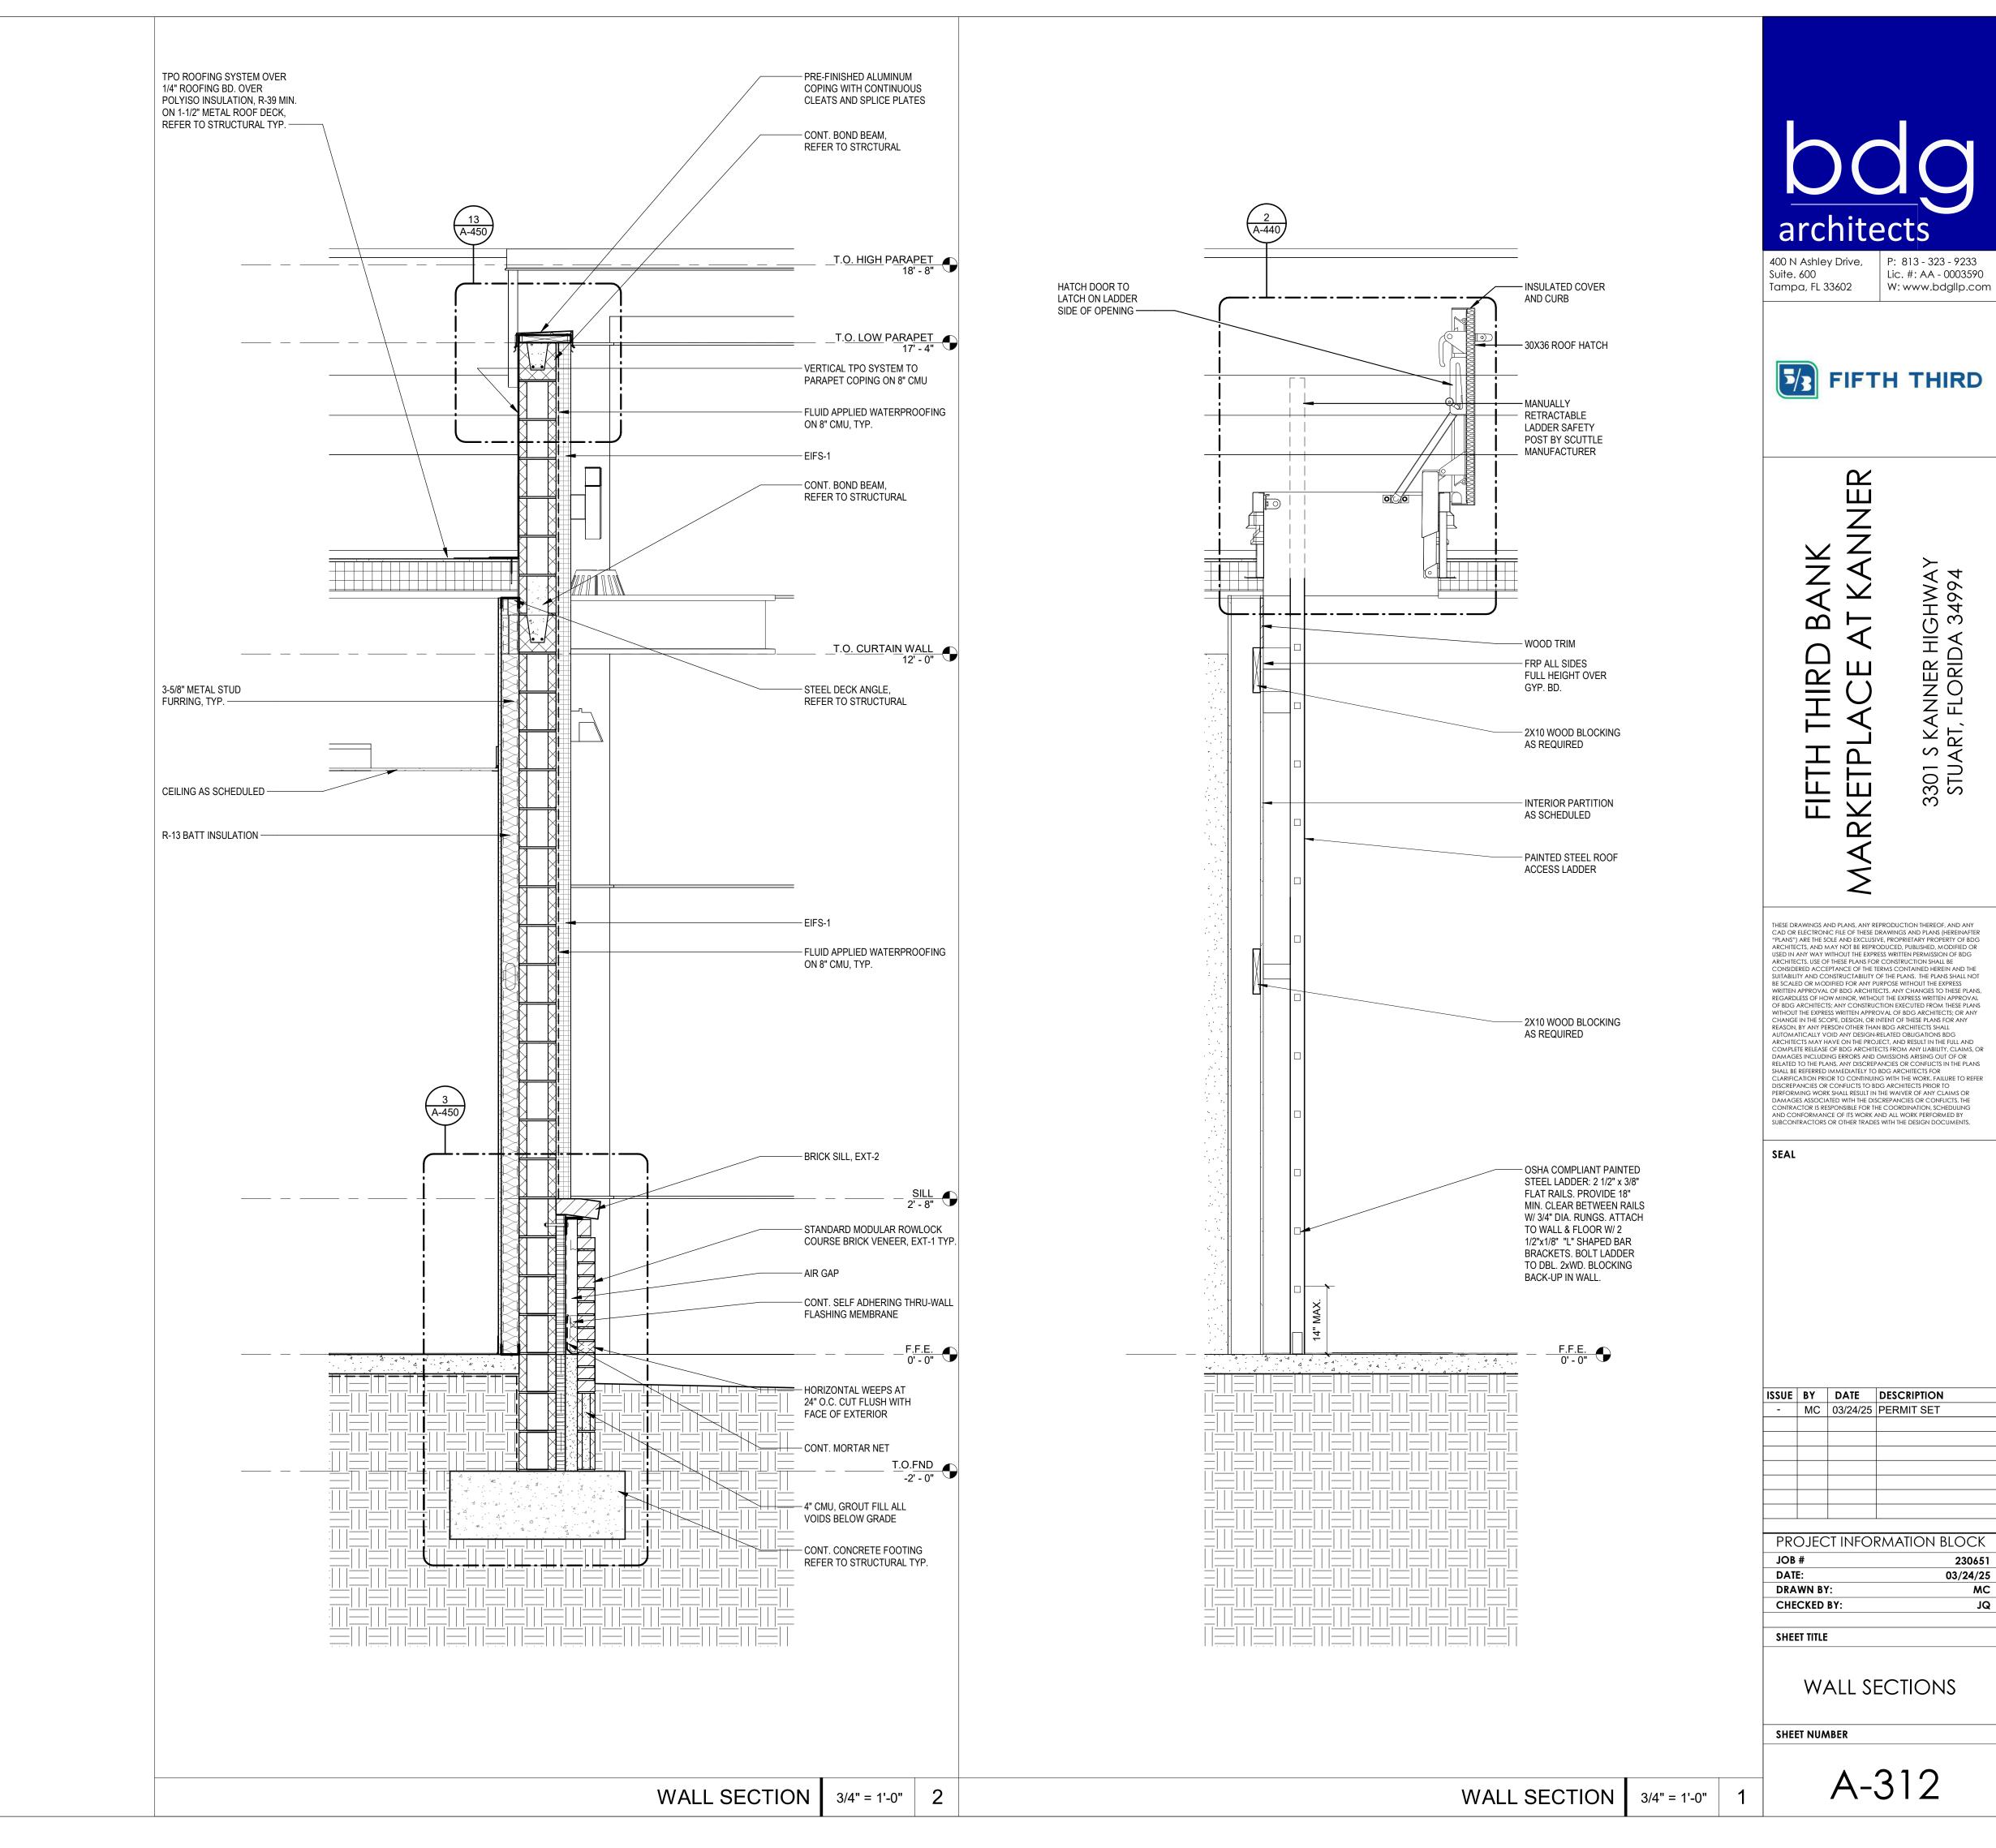
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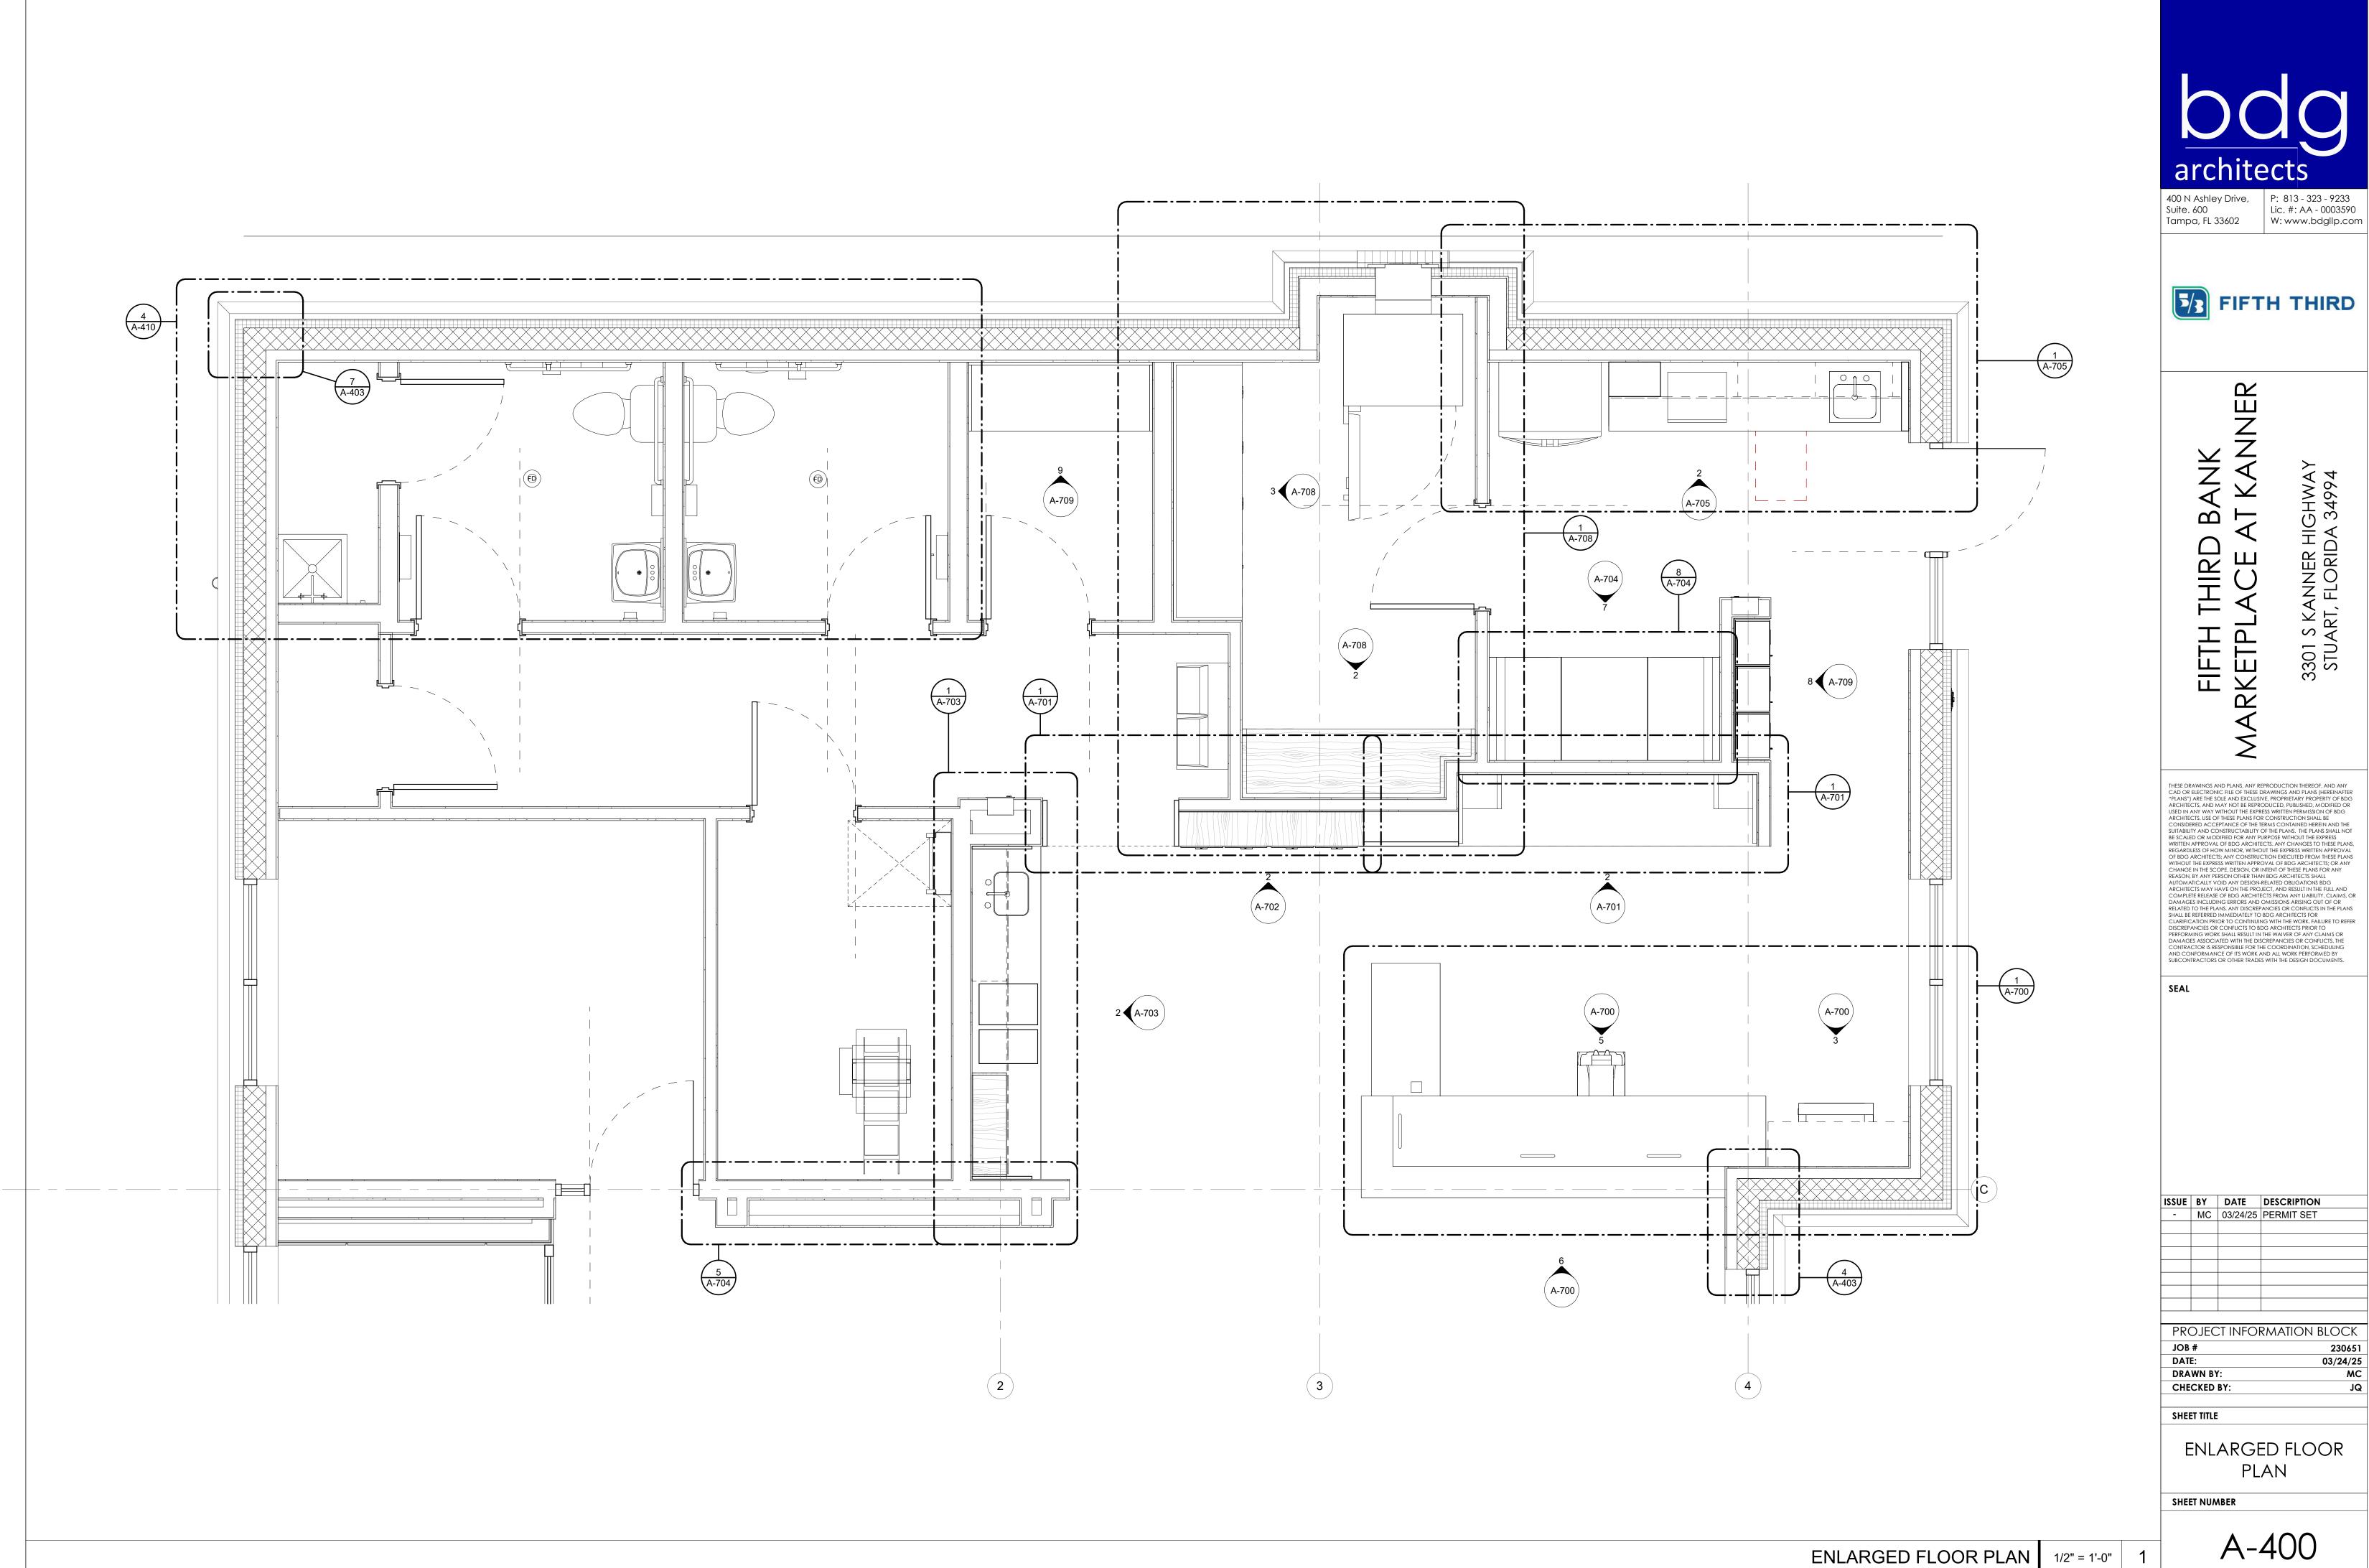













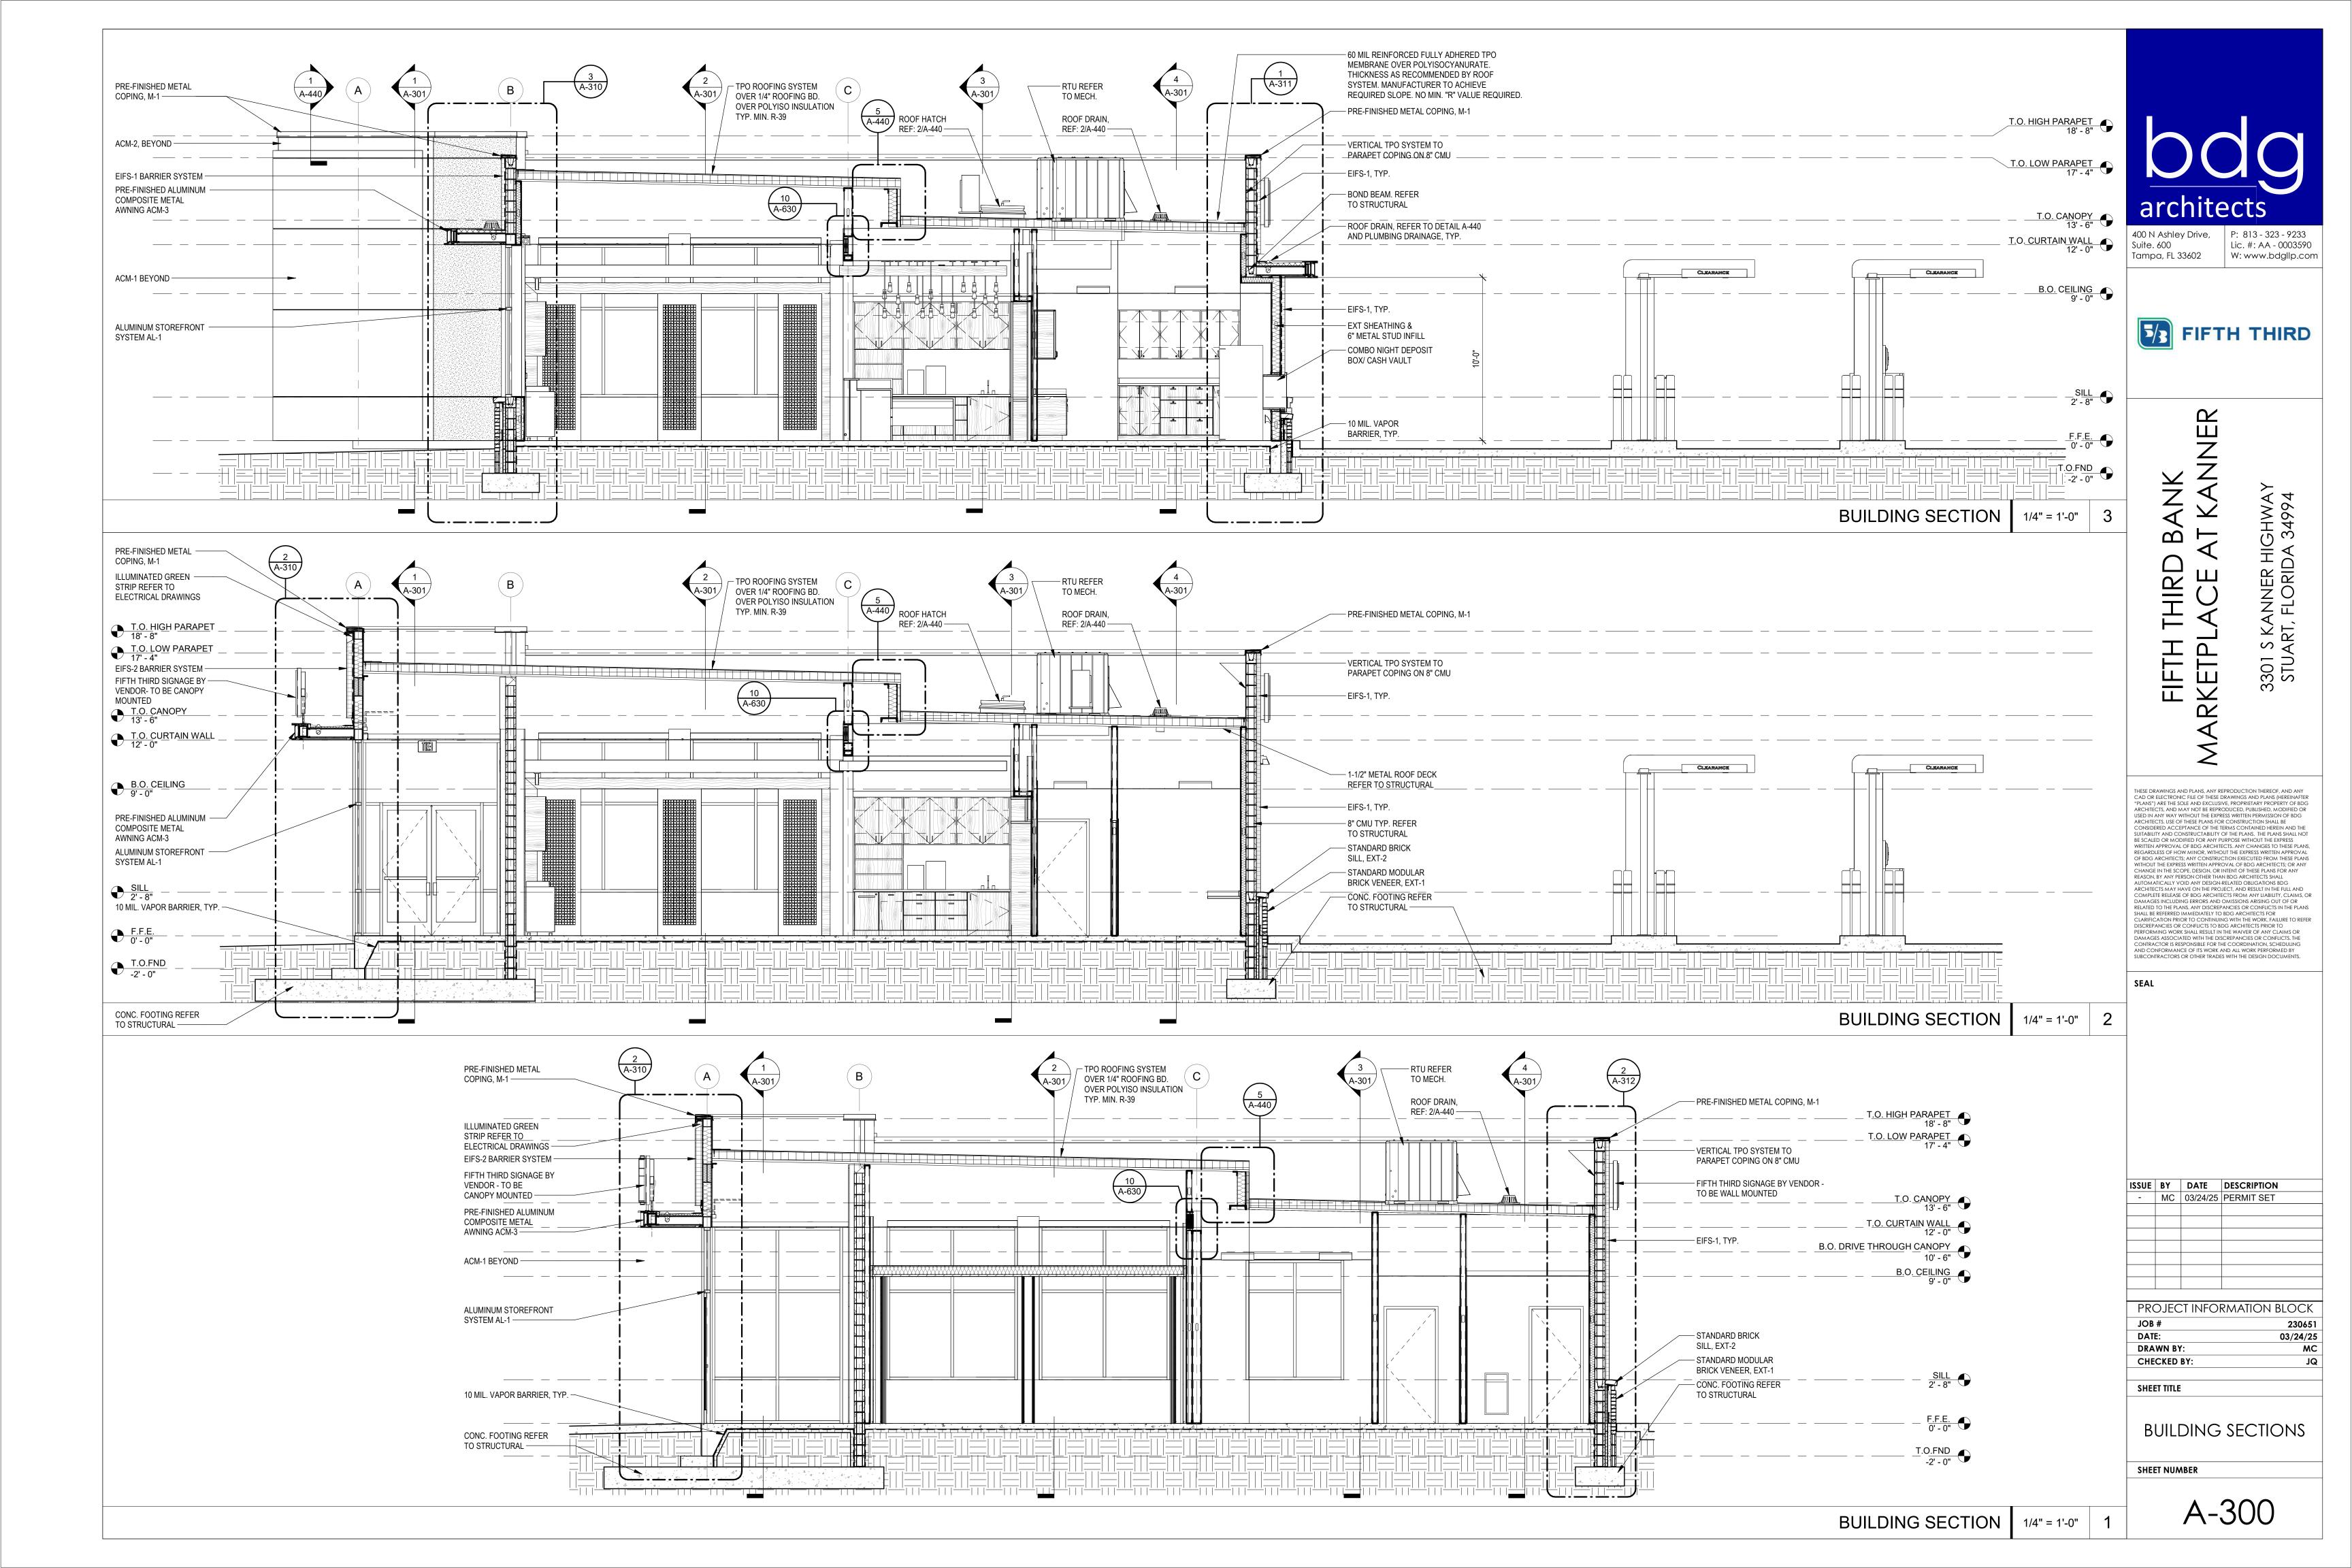



1/2" = 1'-0"

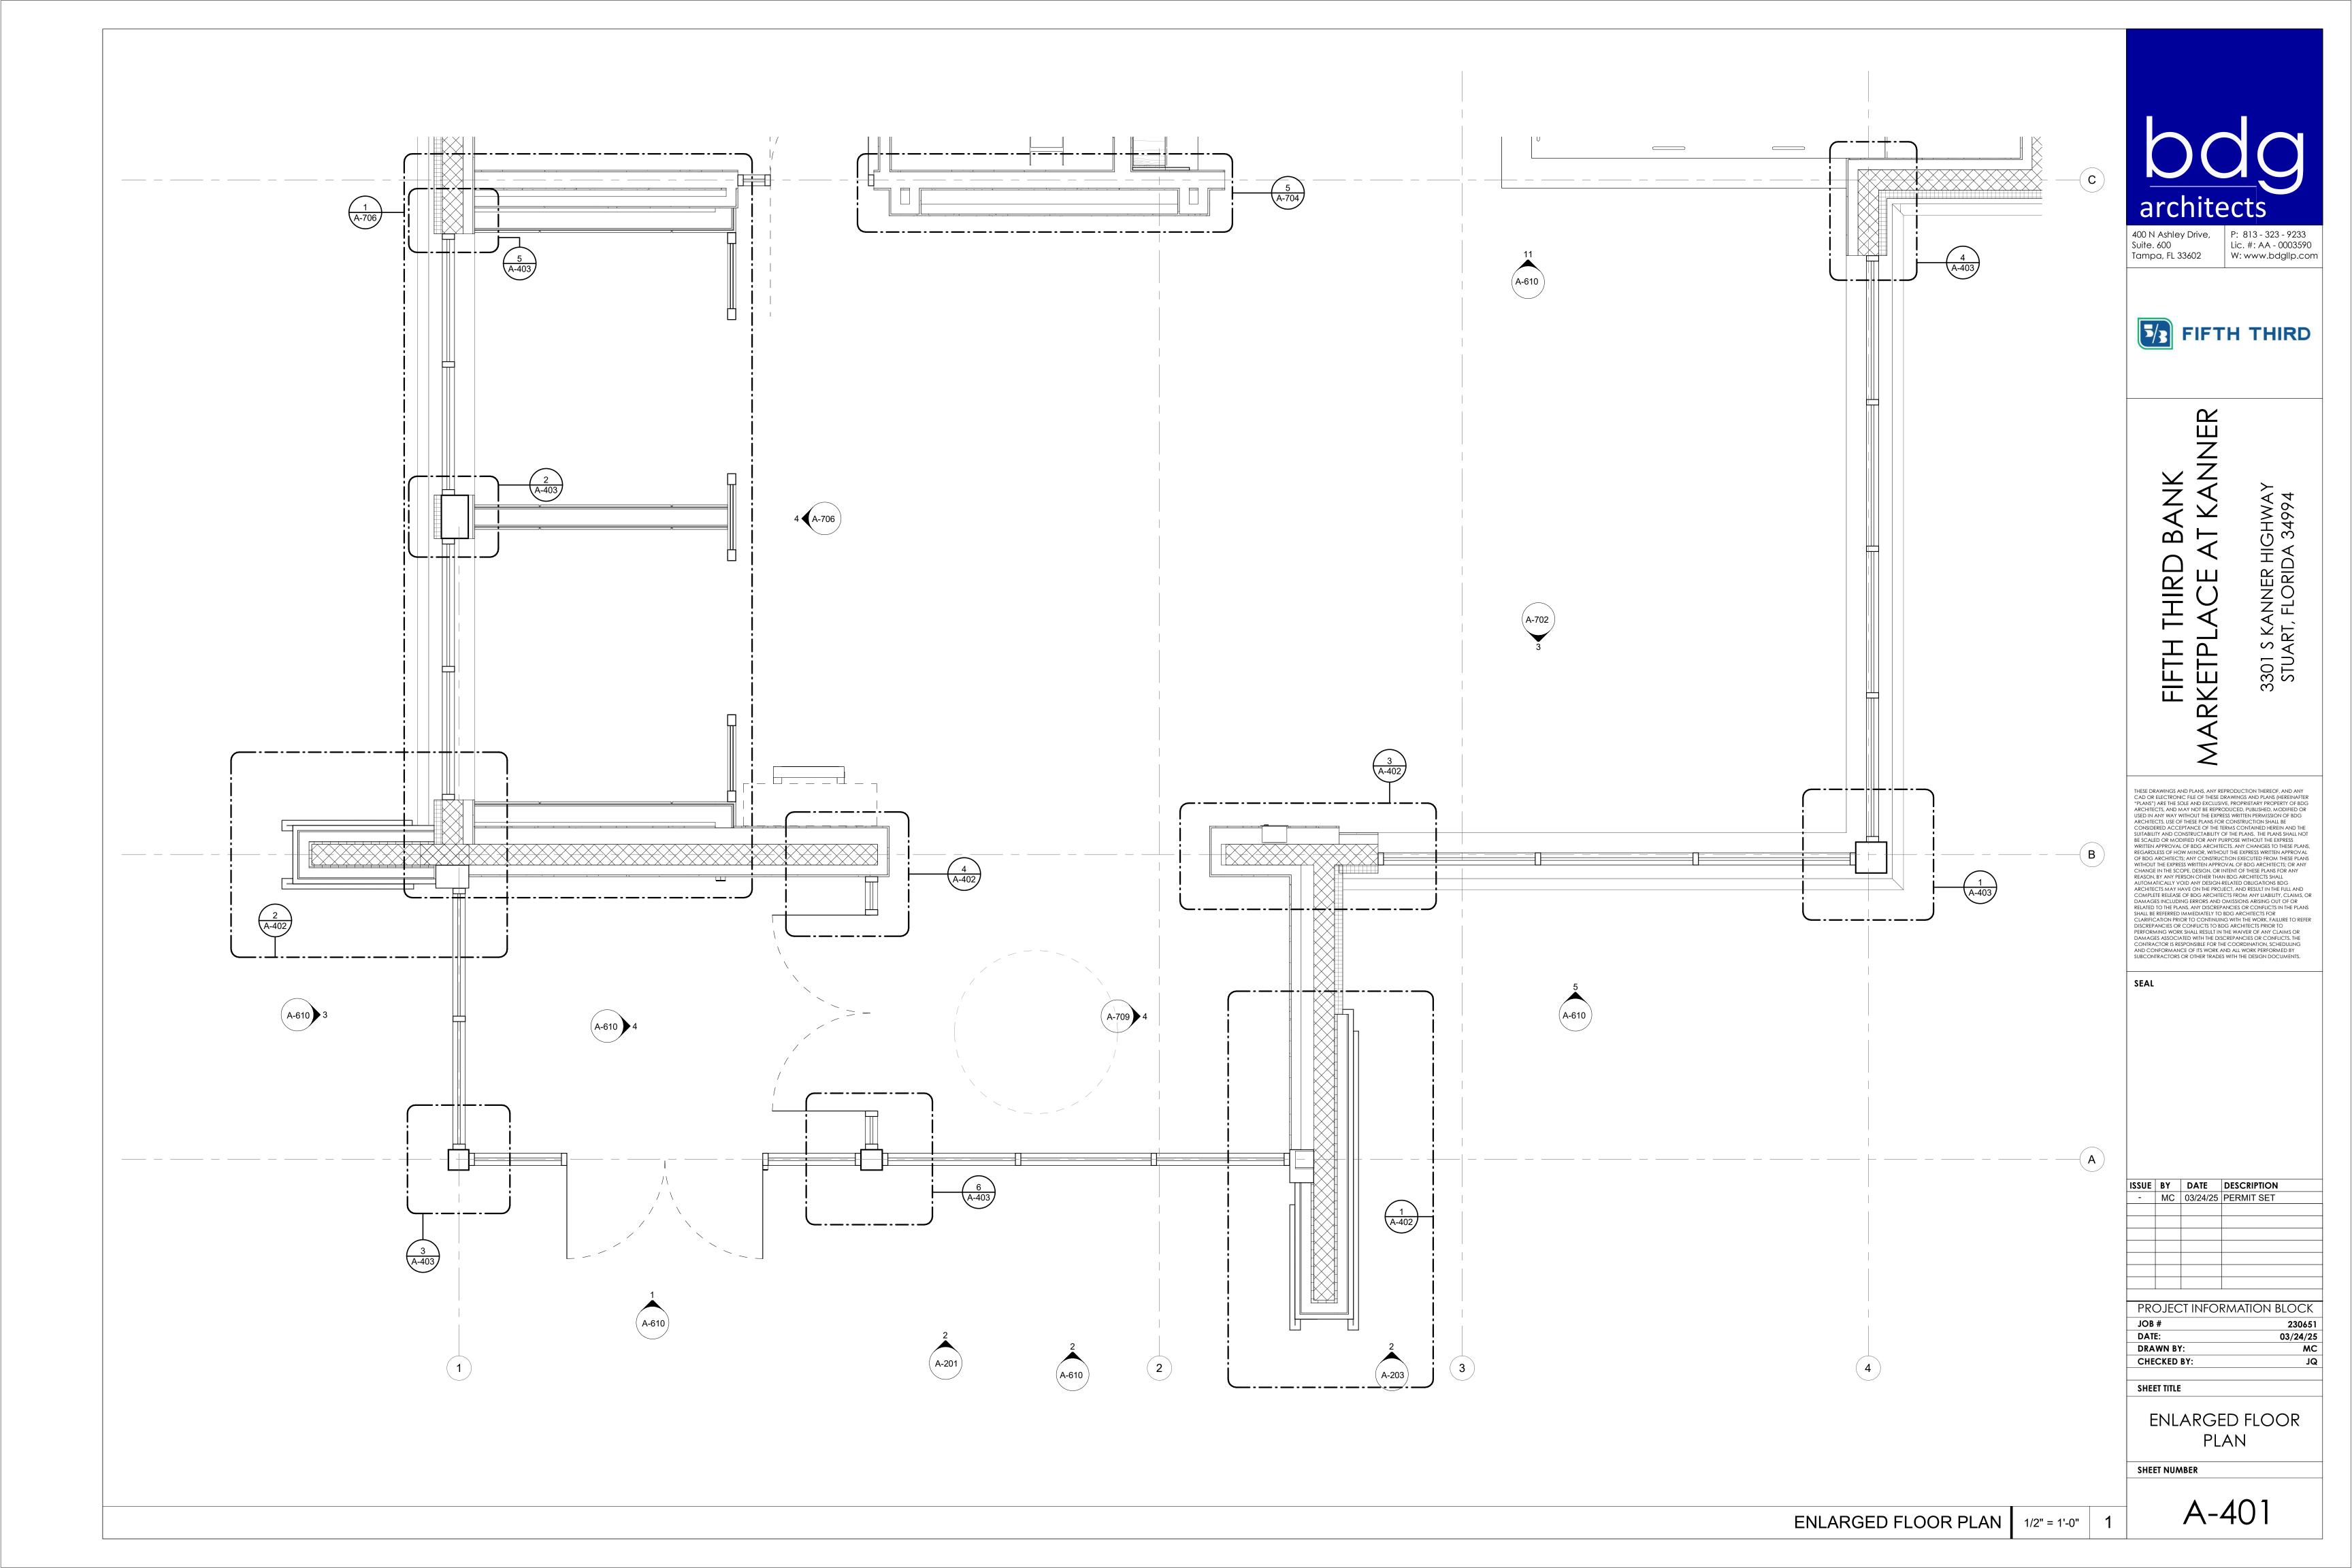


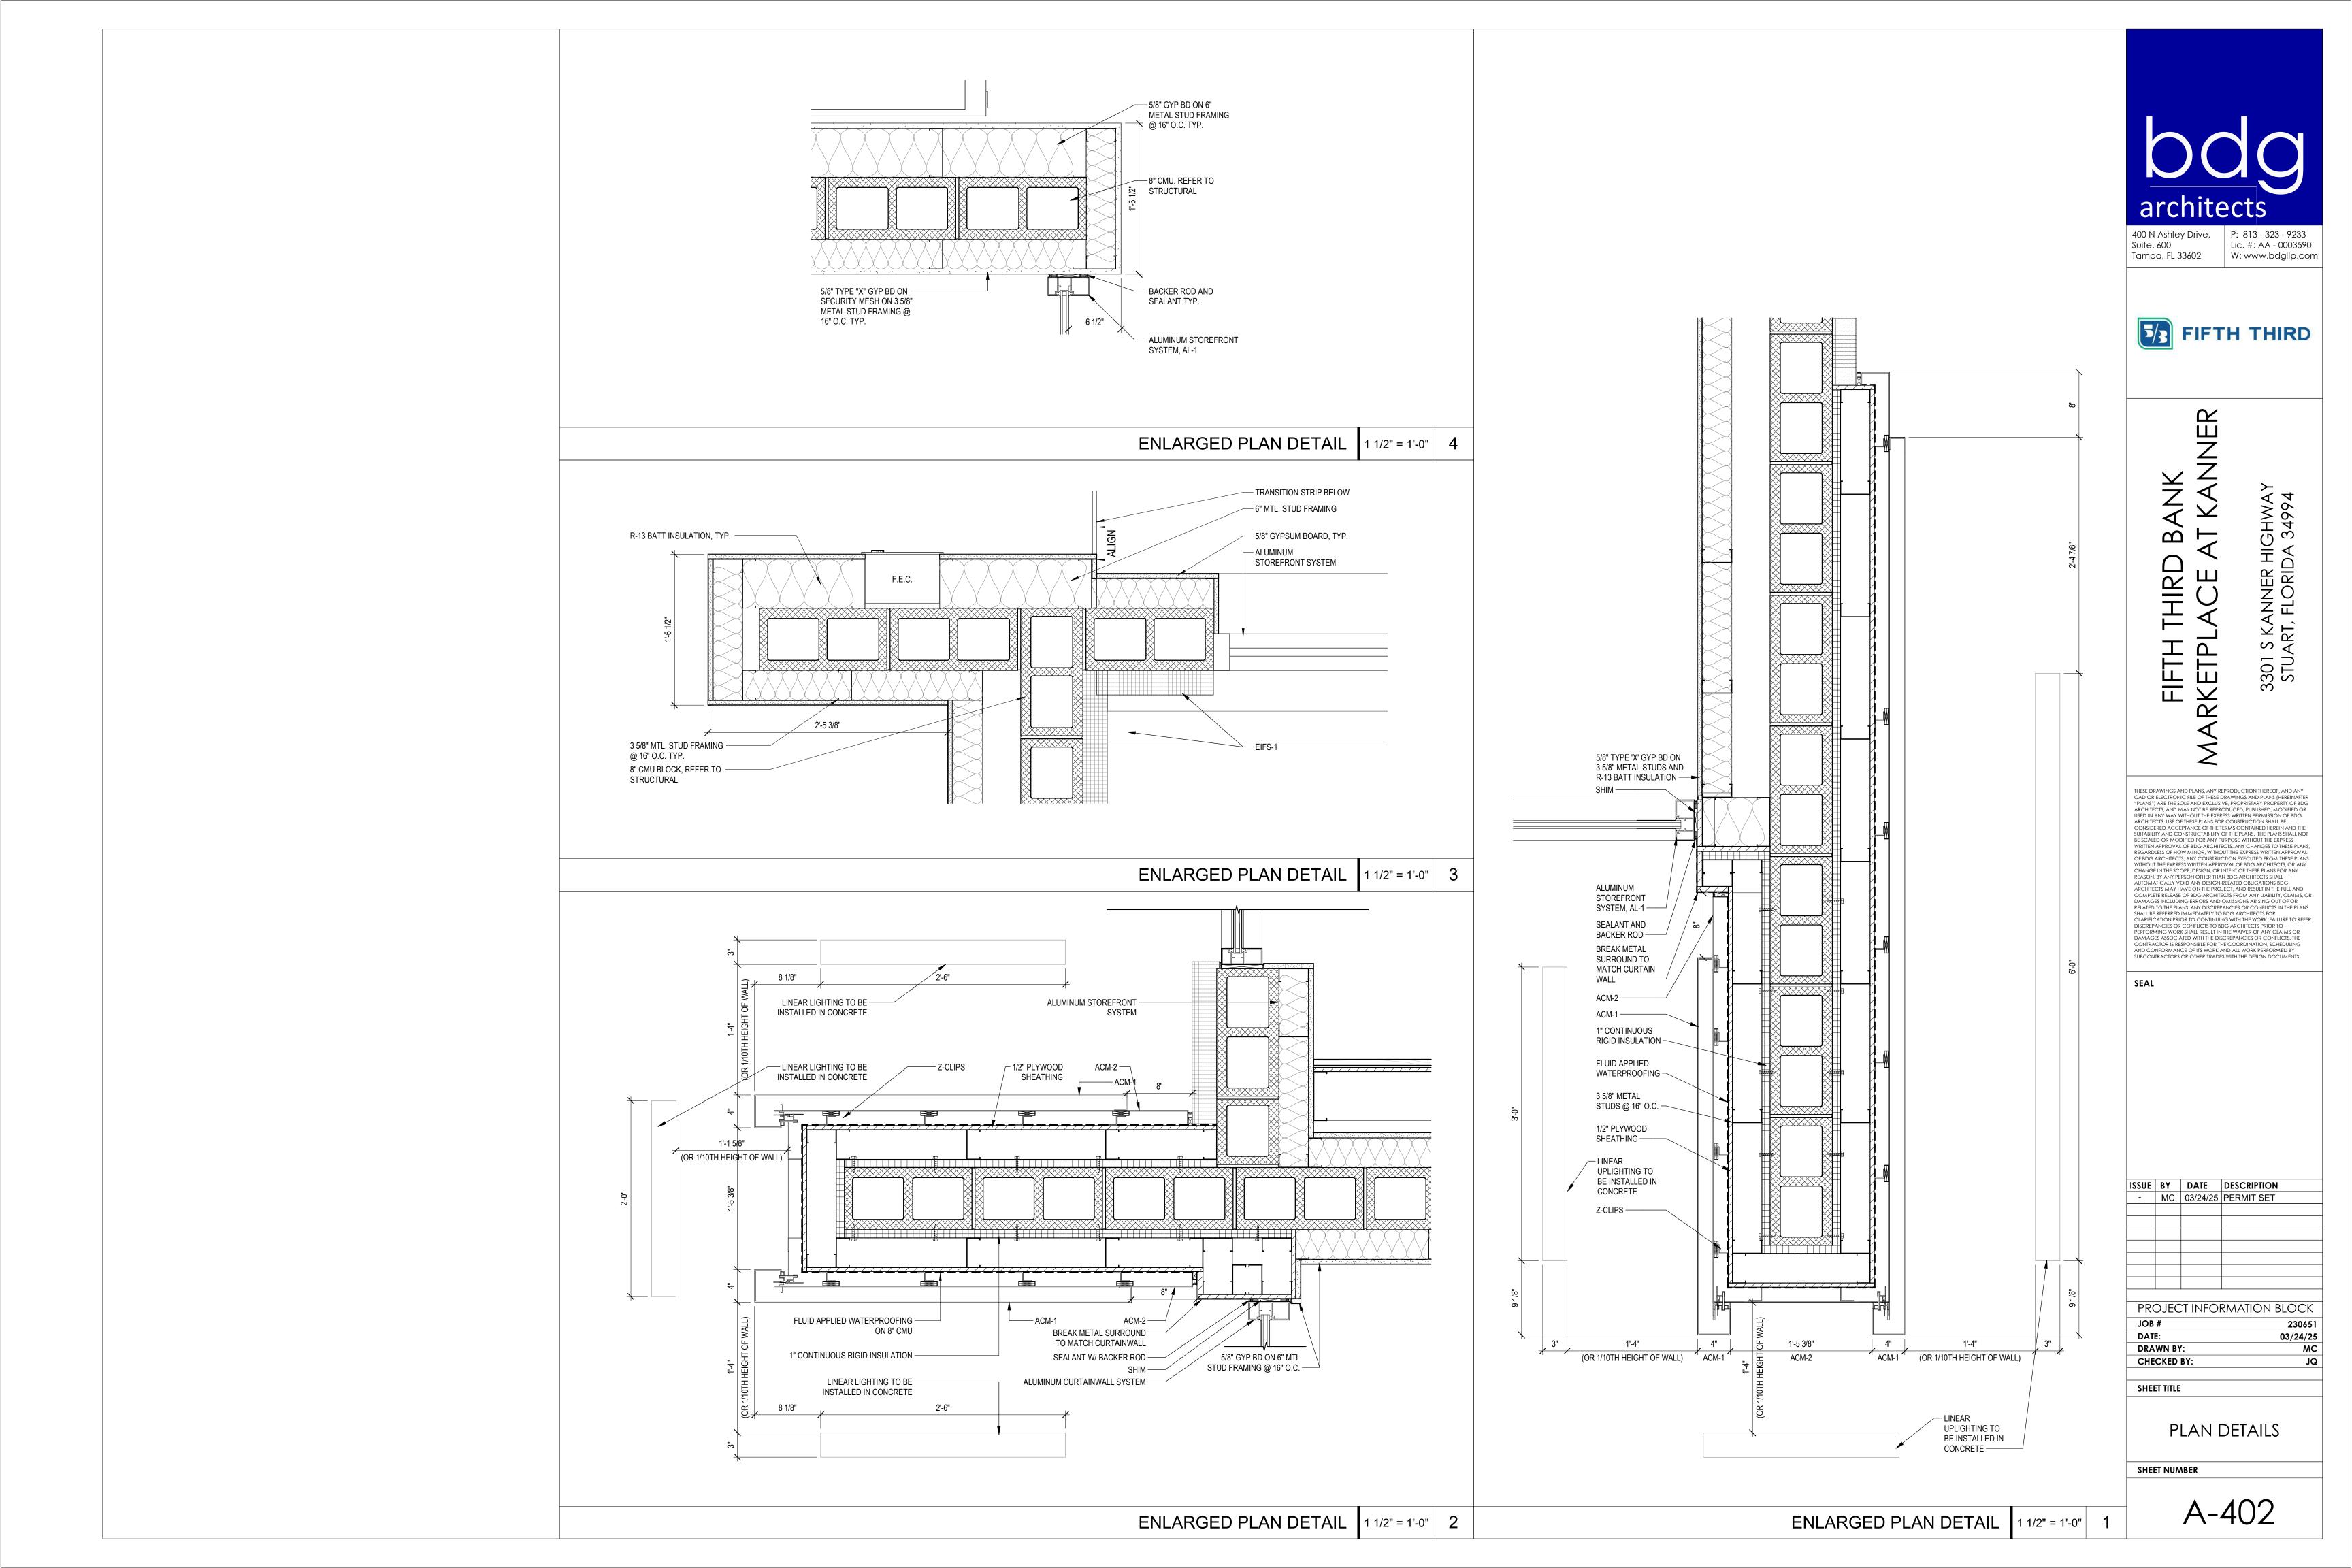


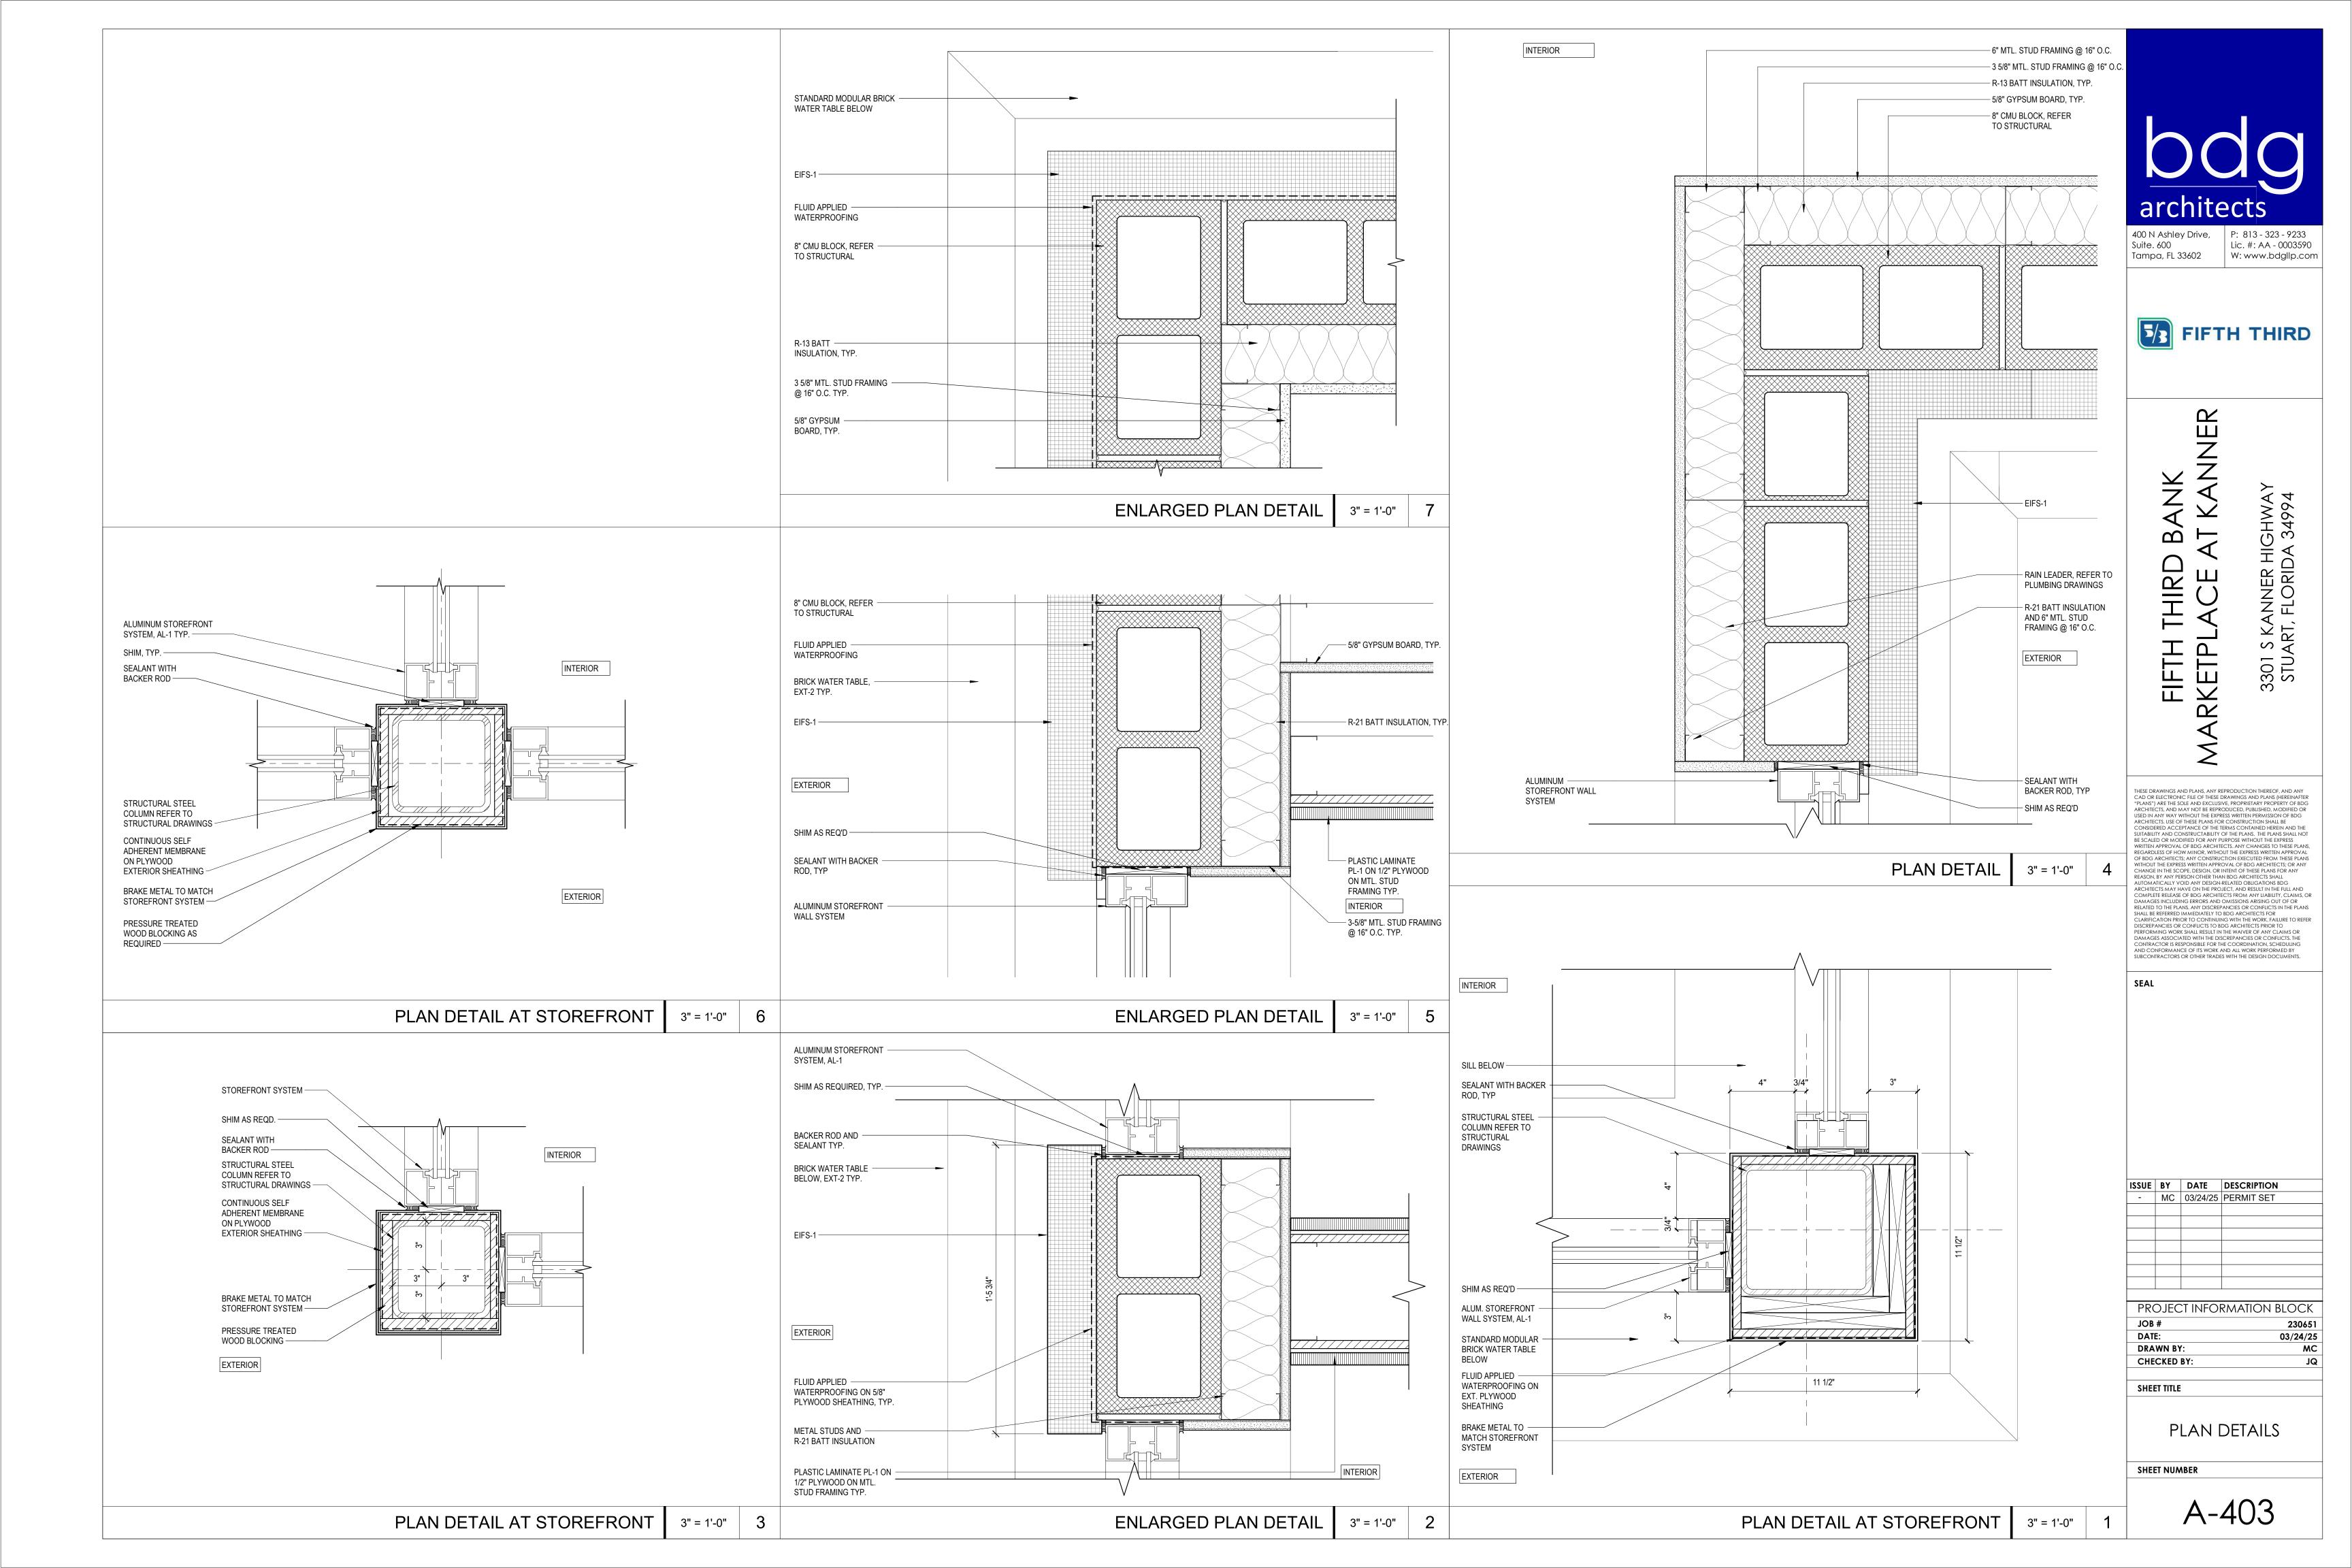


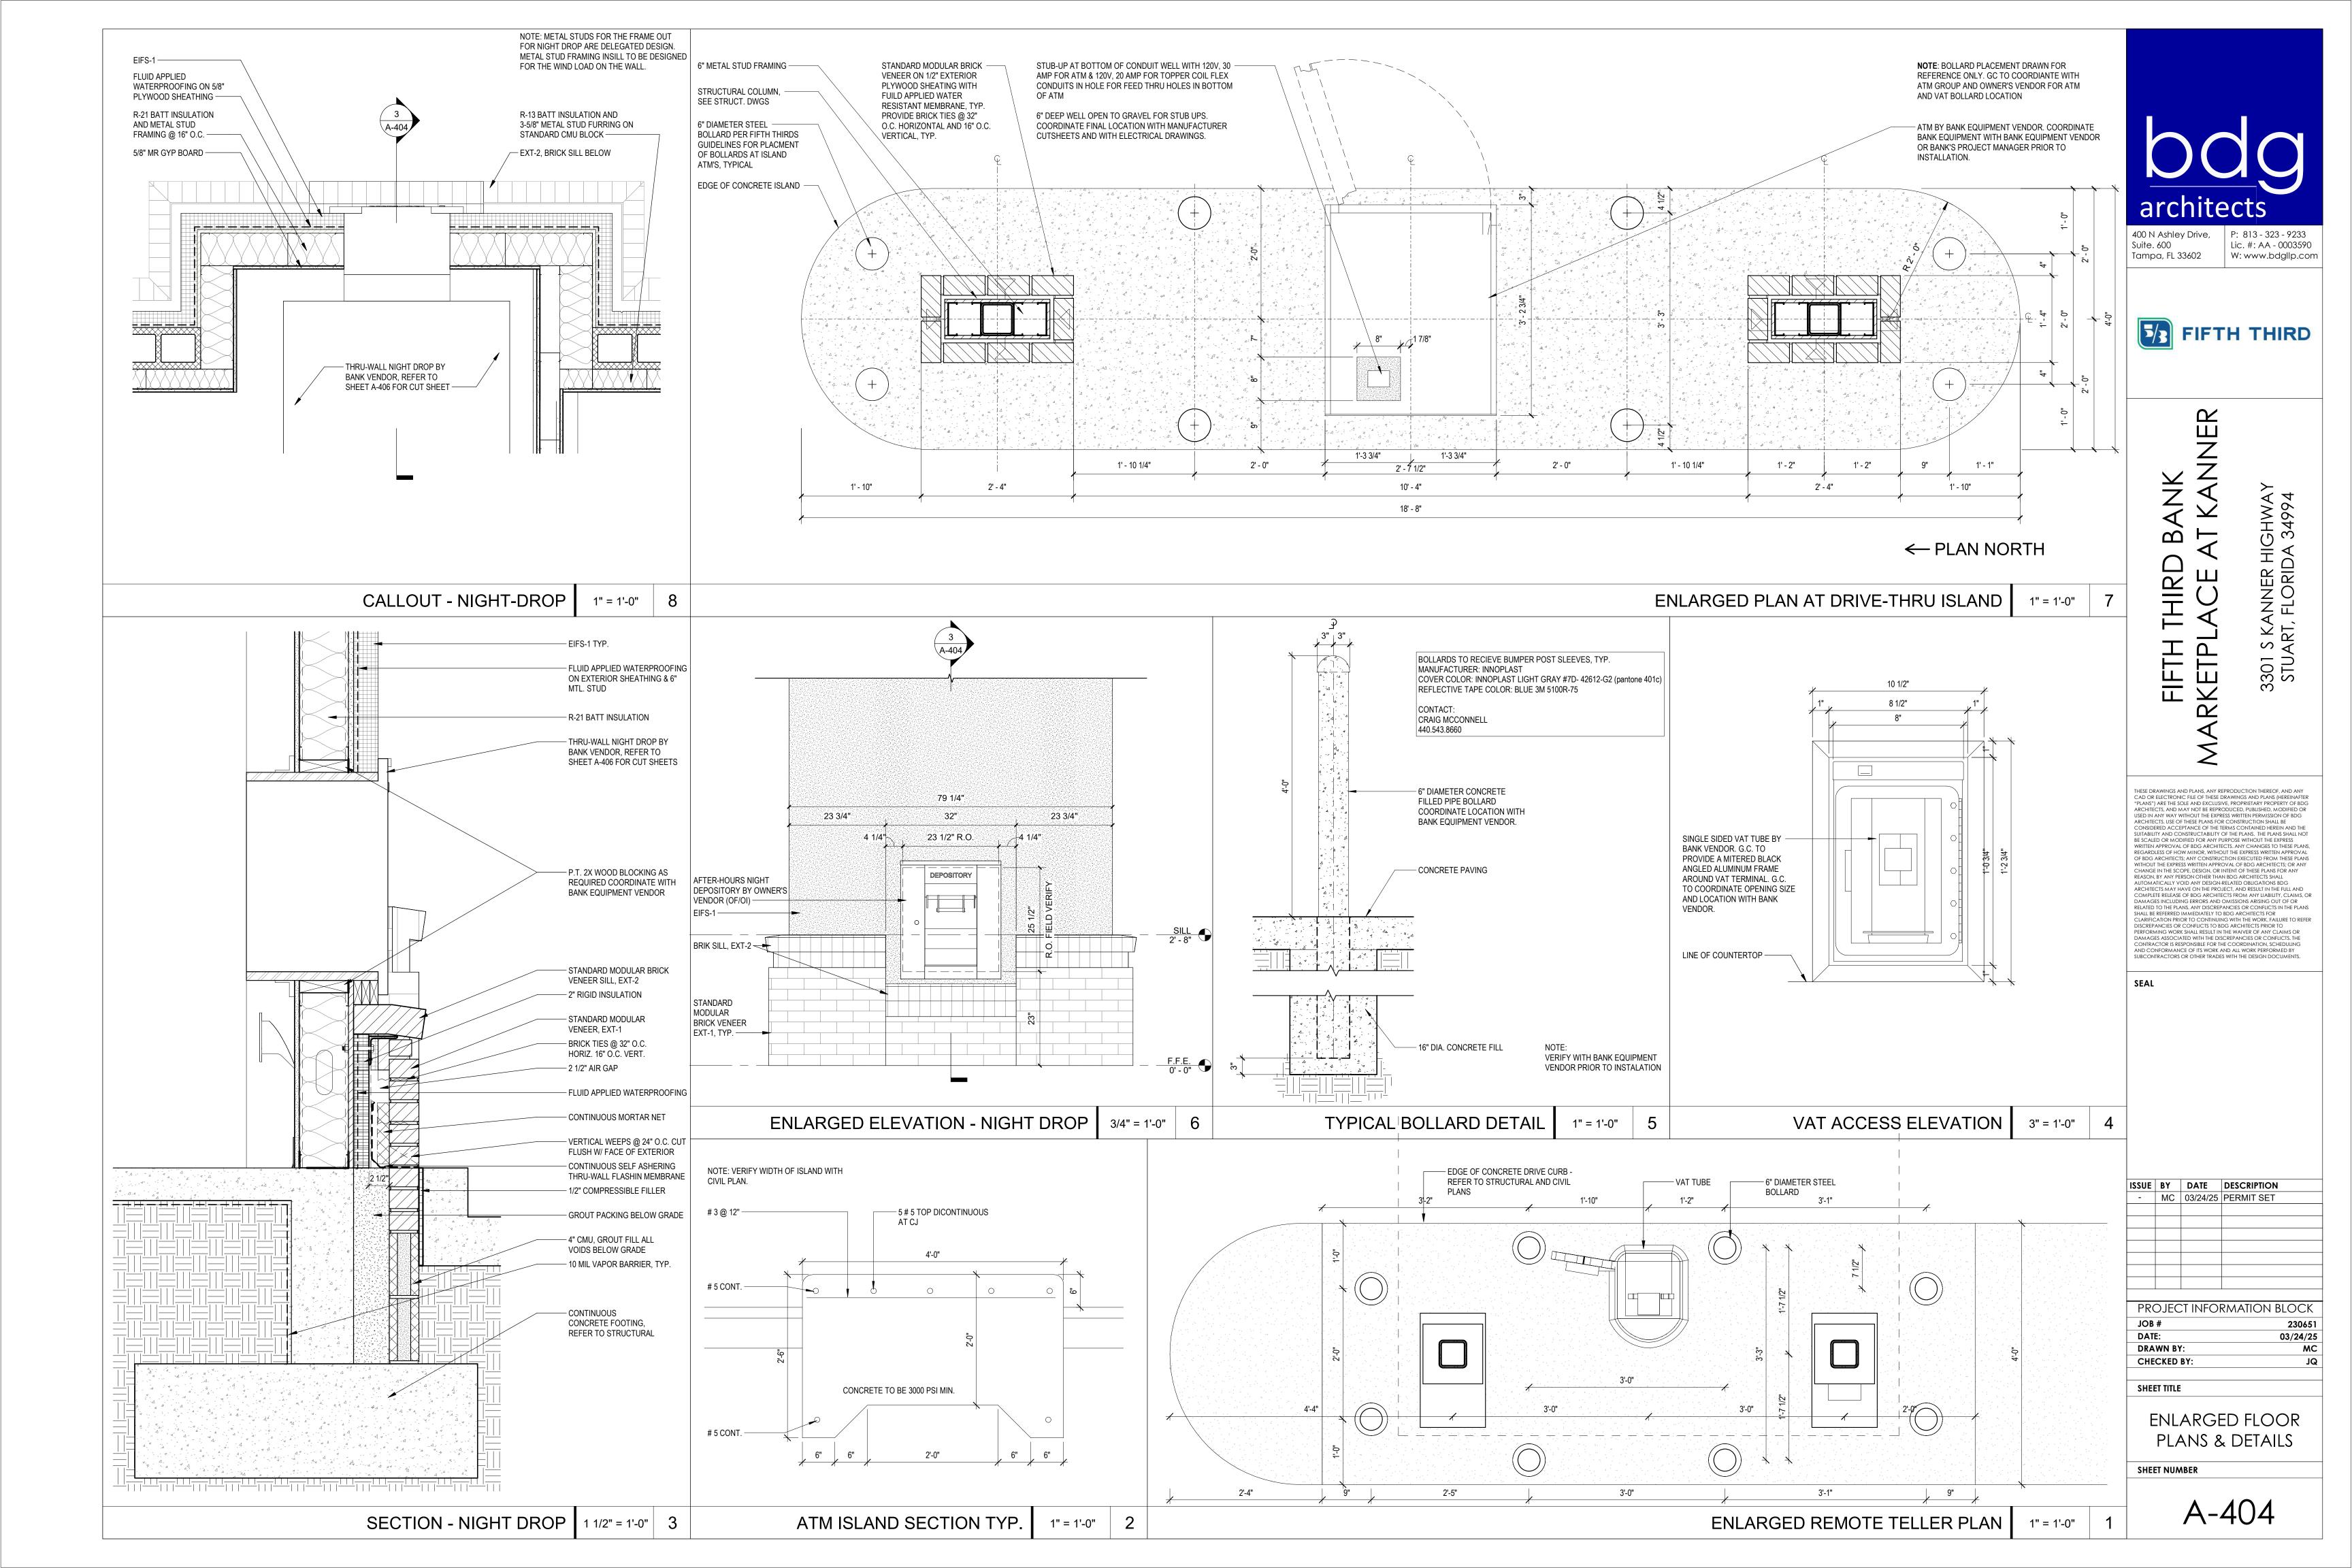


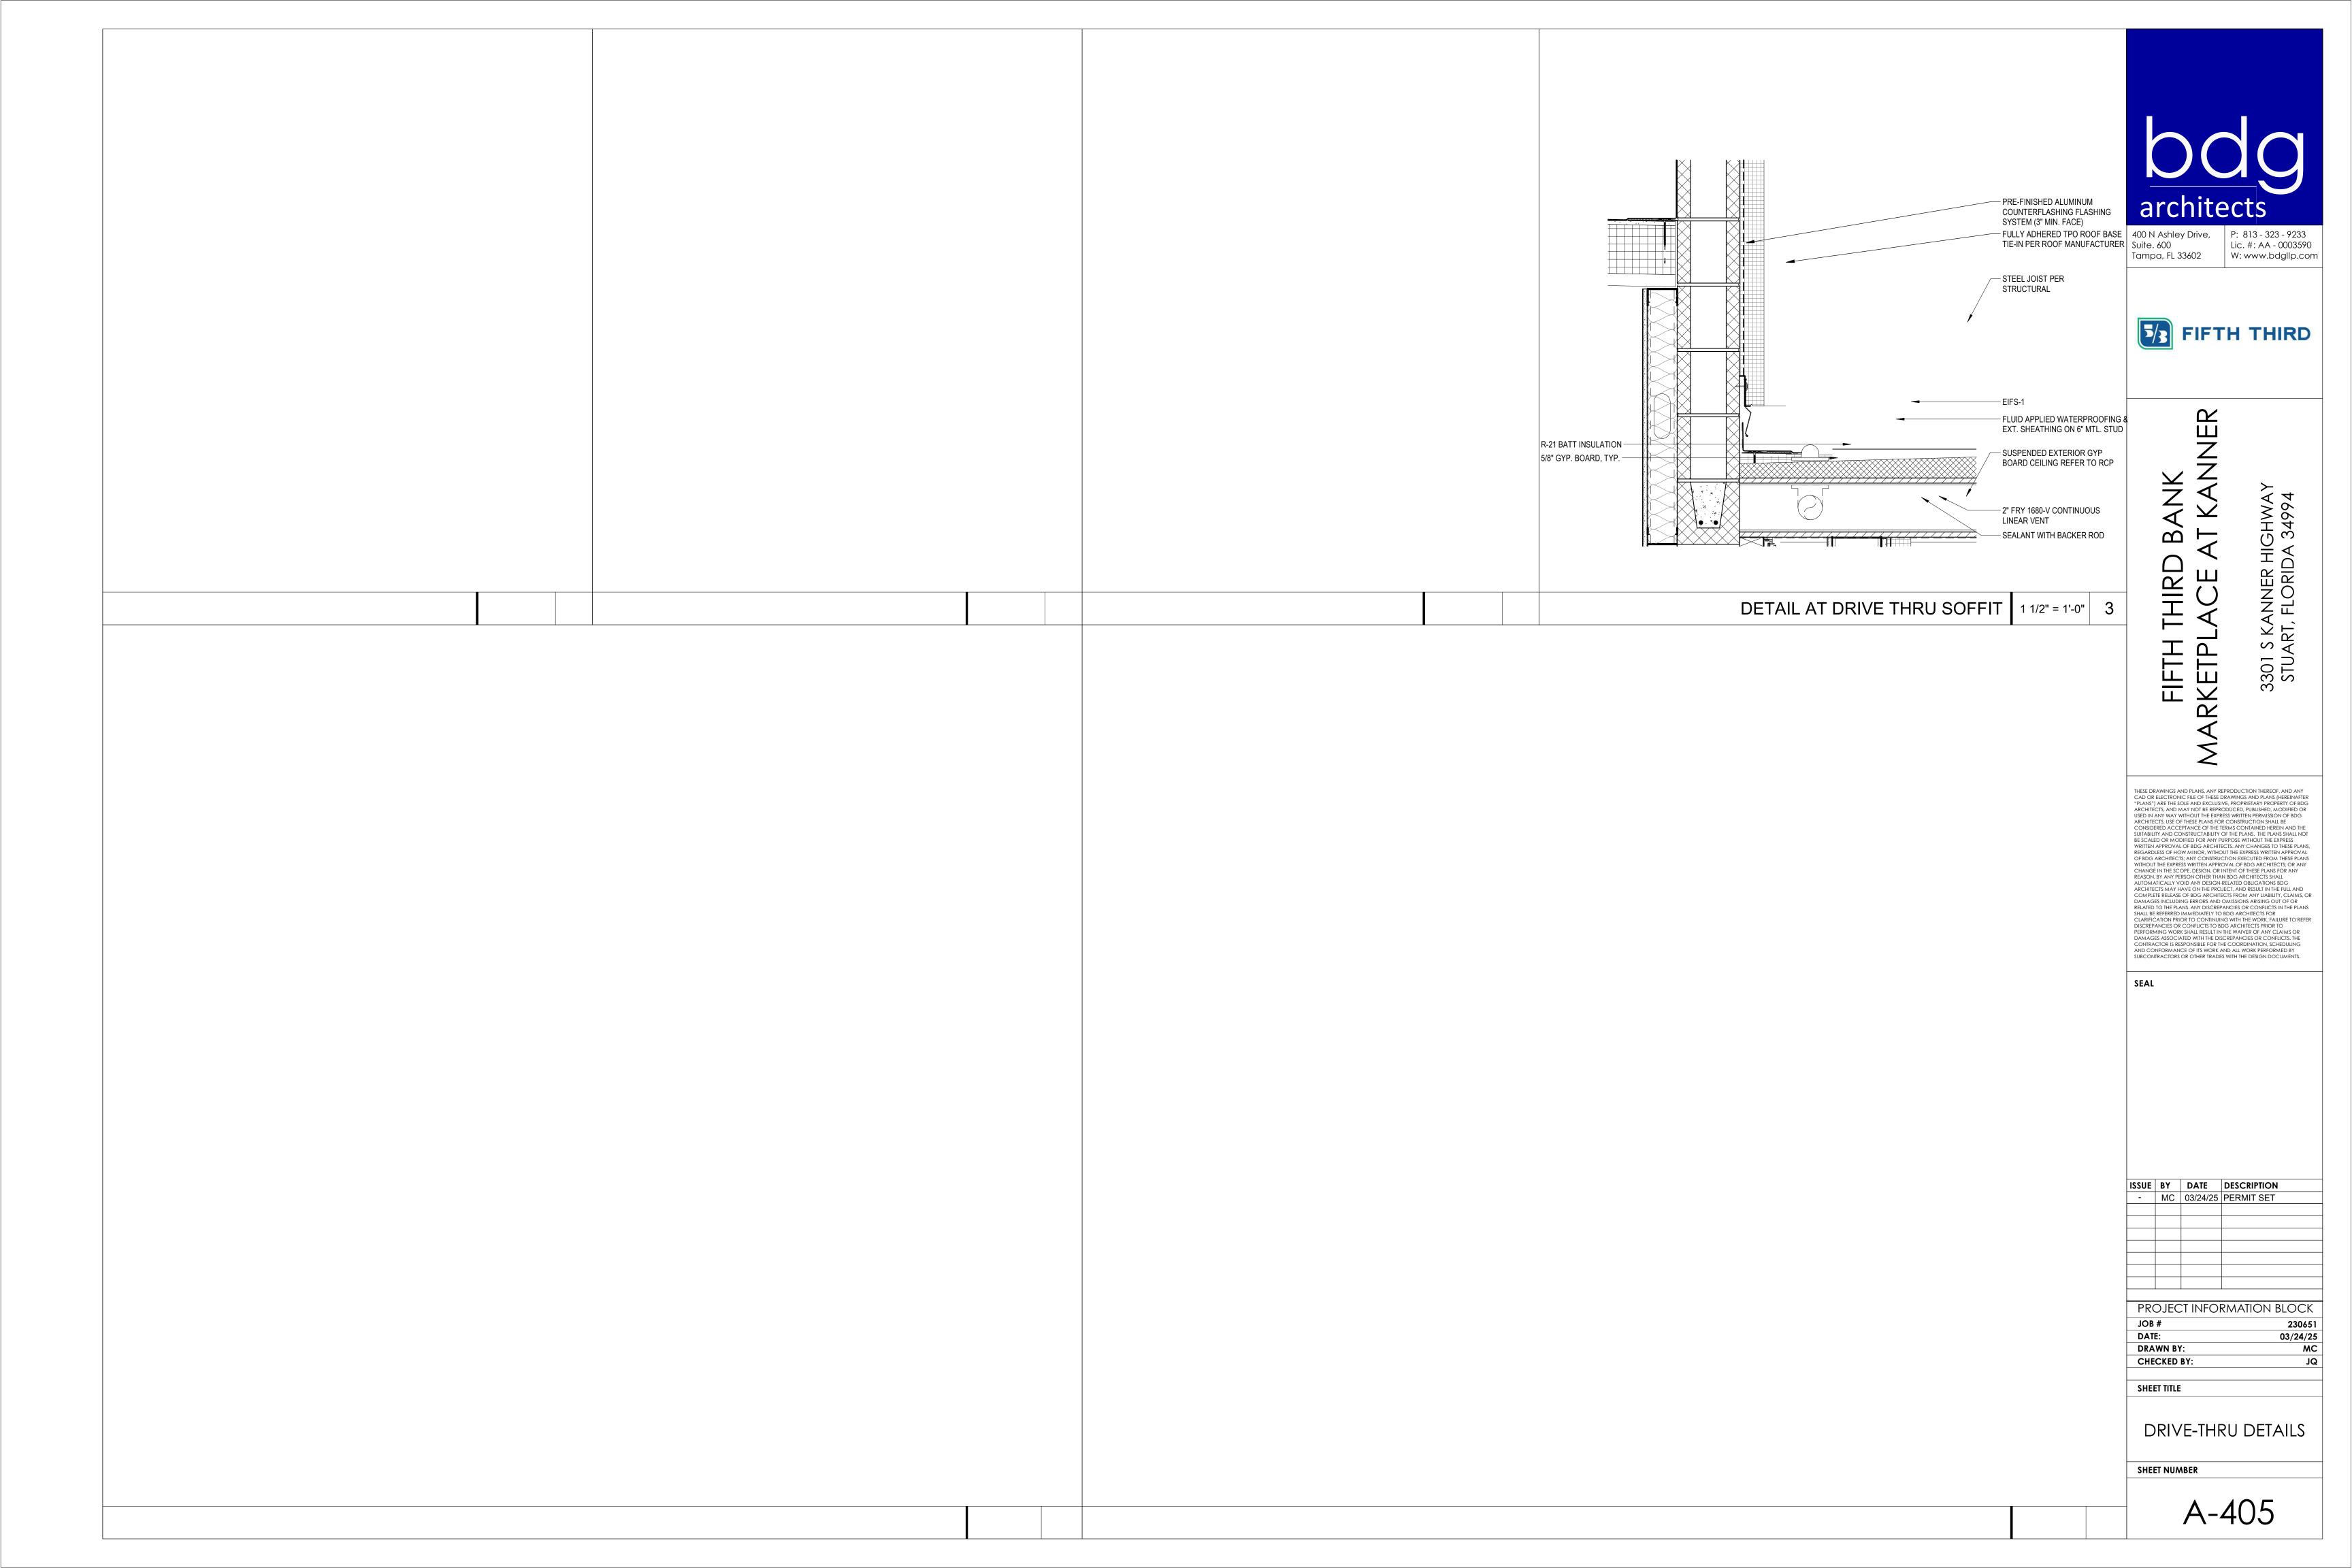

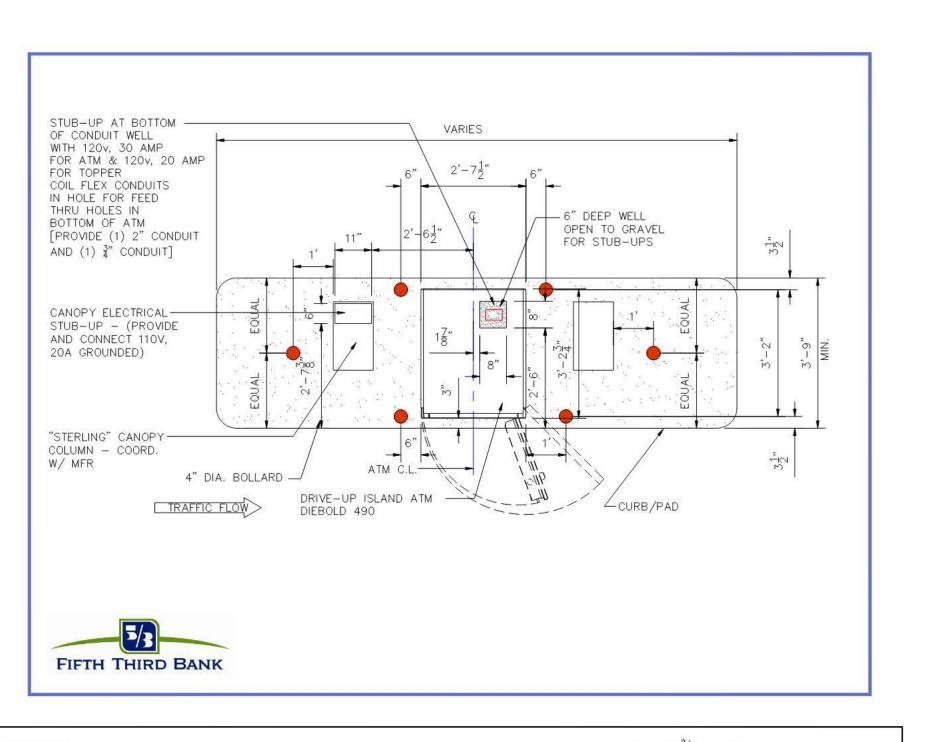


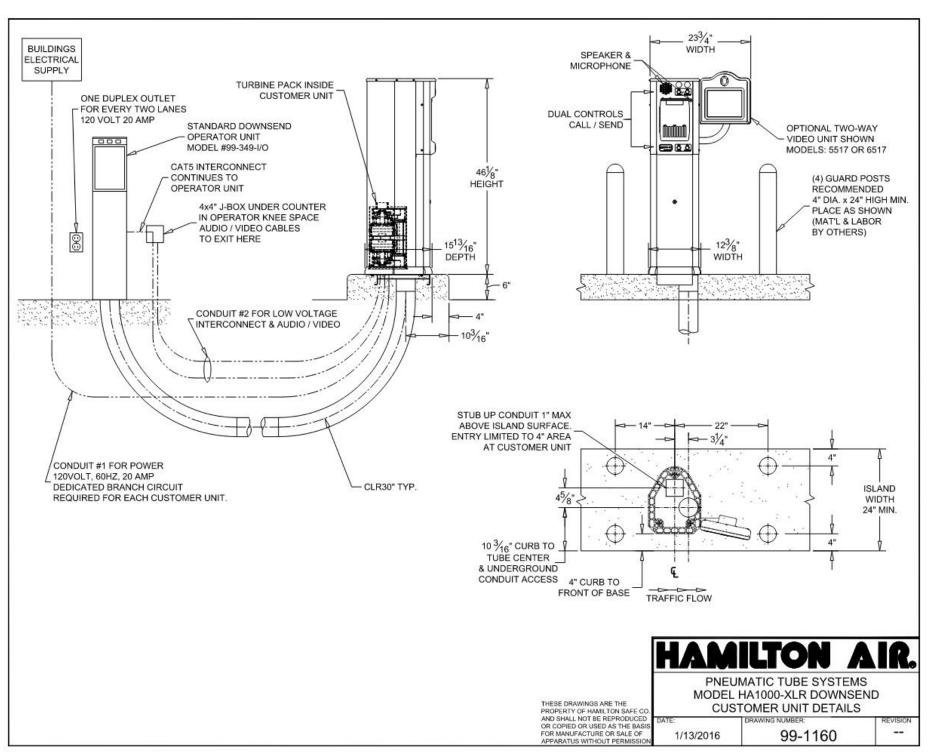


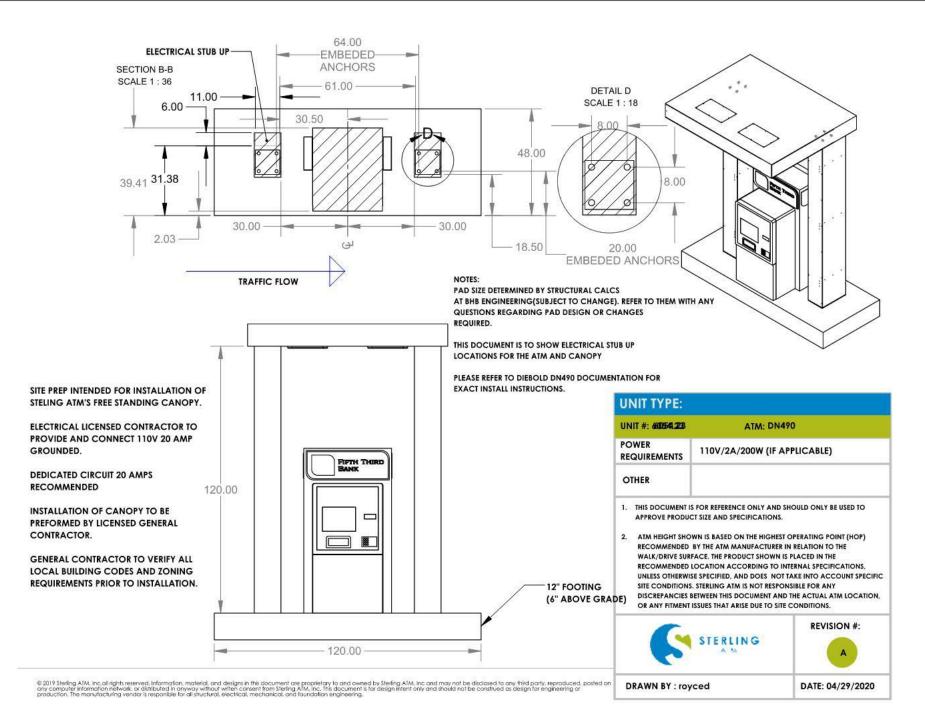


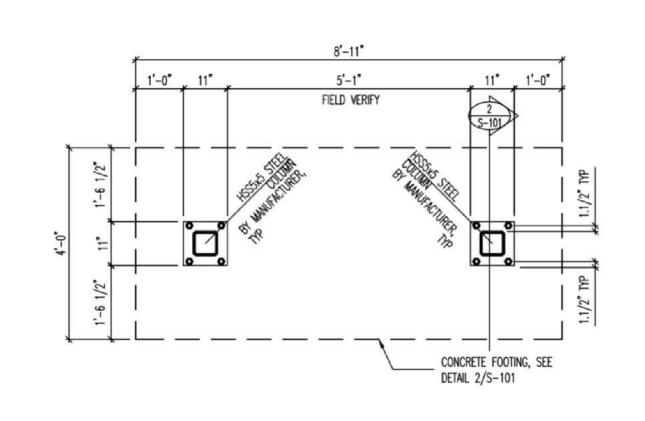





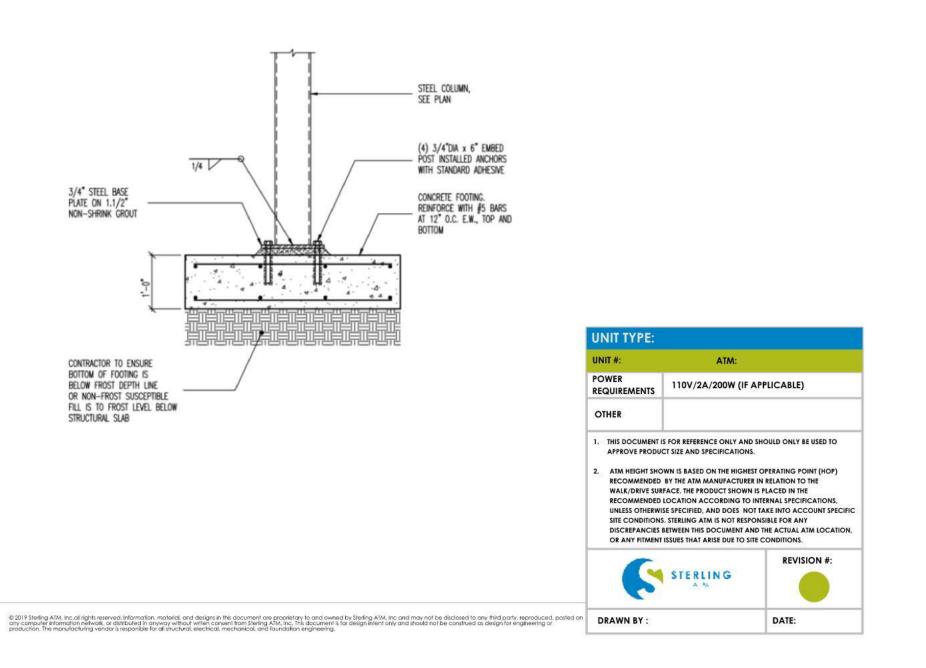

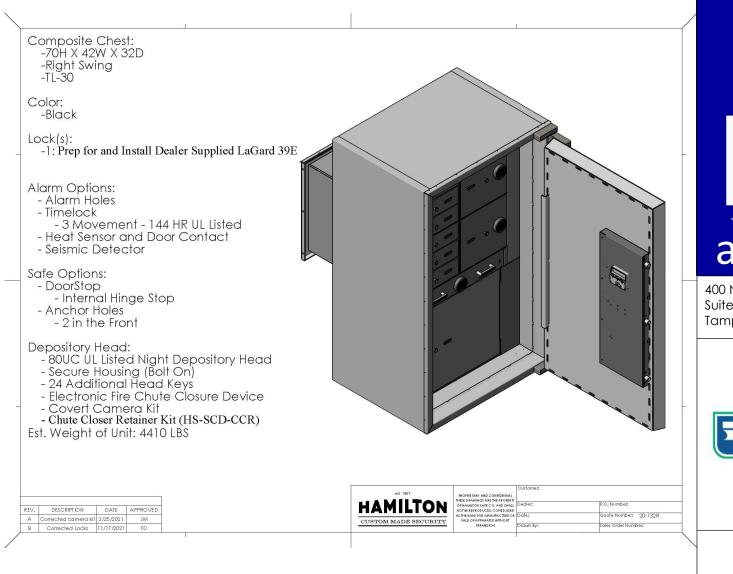

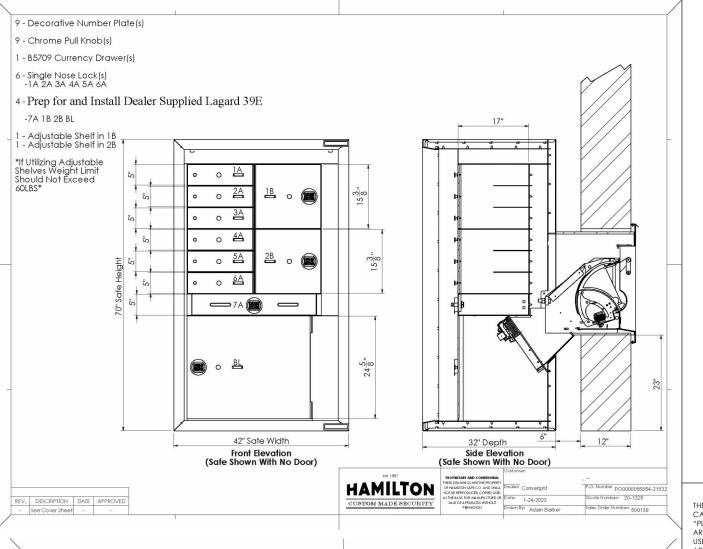

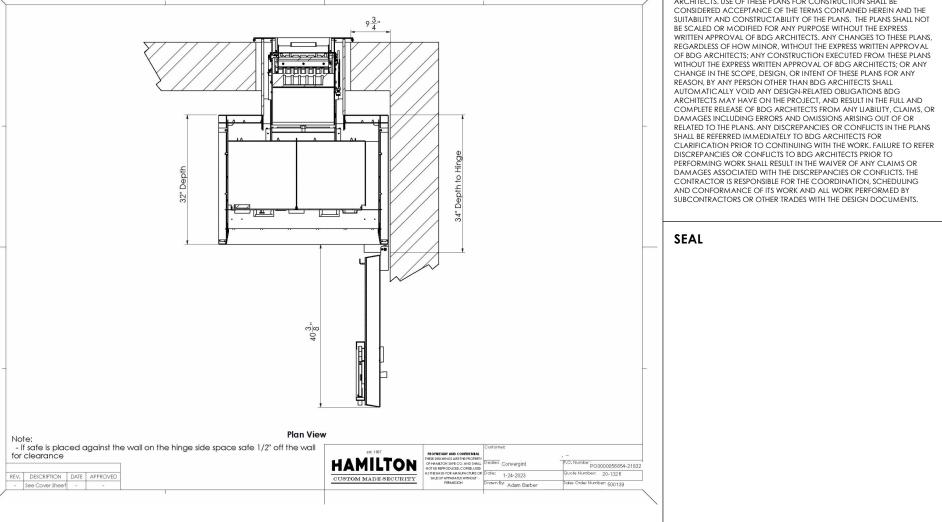

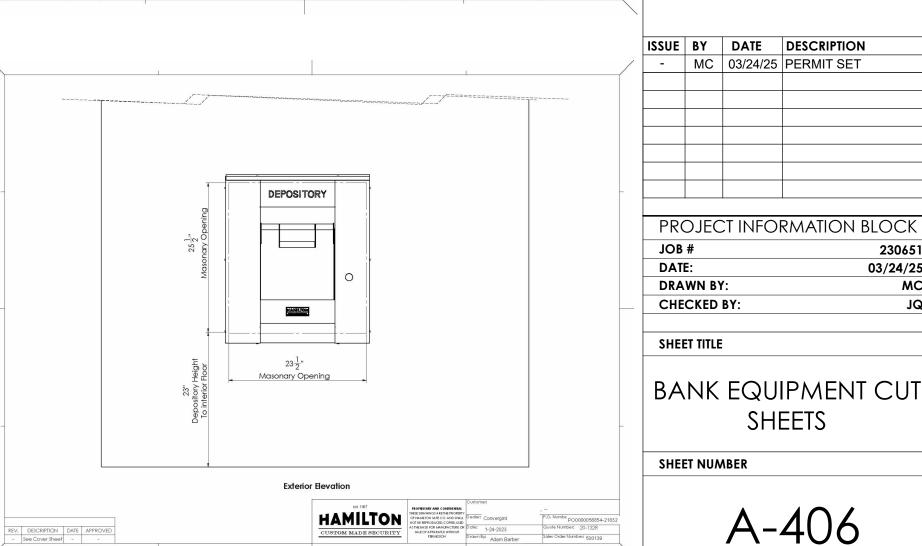

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FIFTH THIRD


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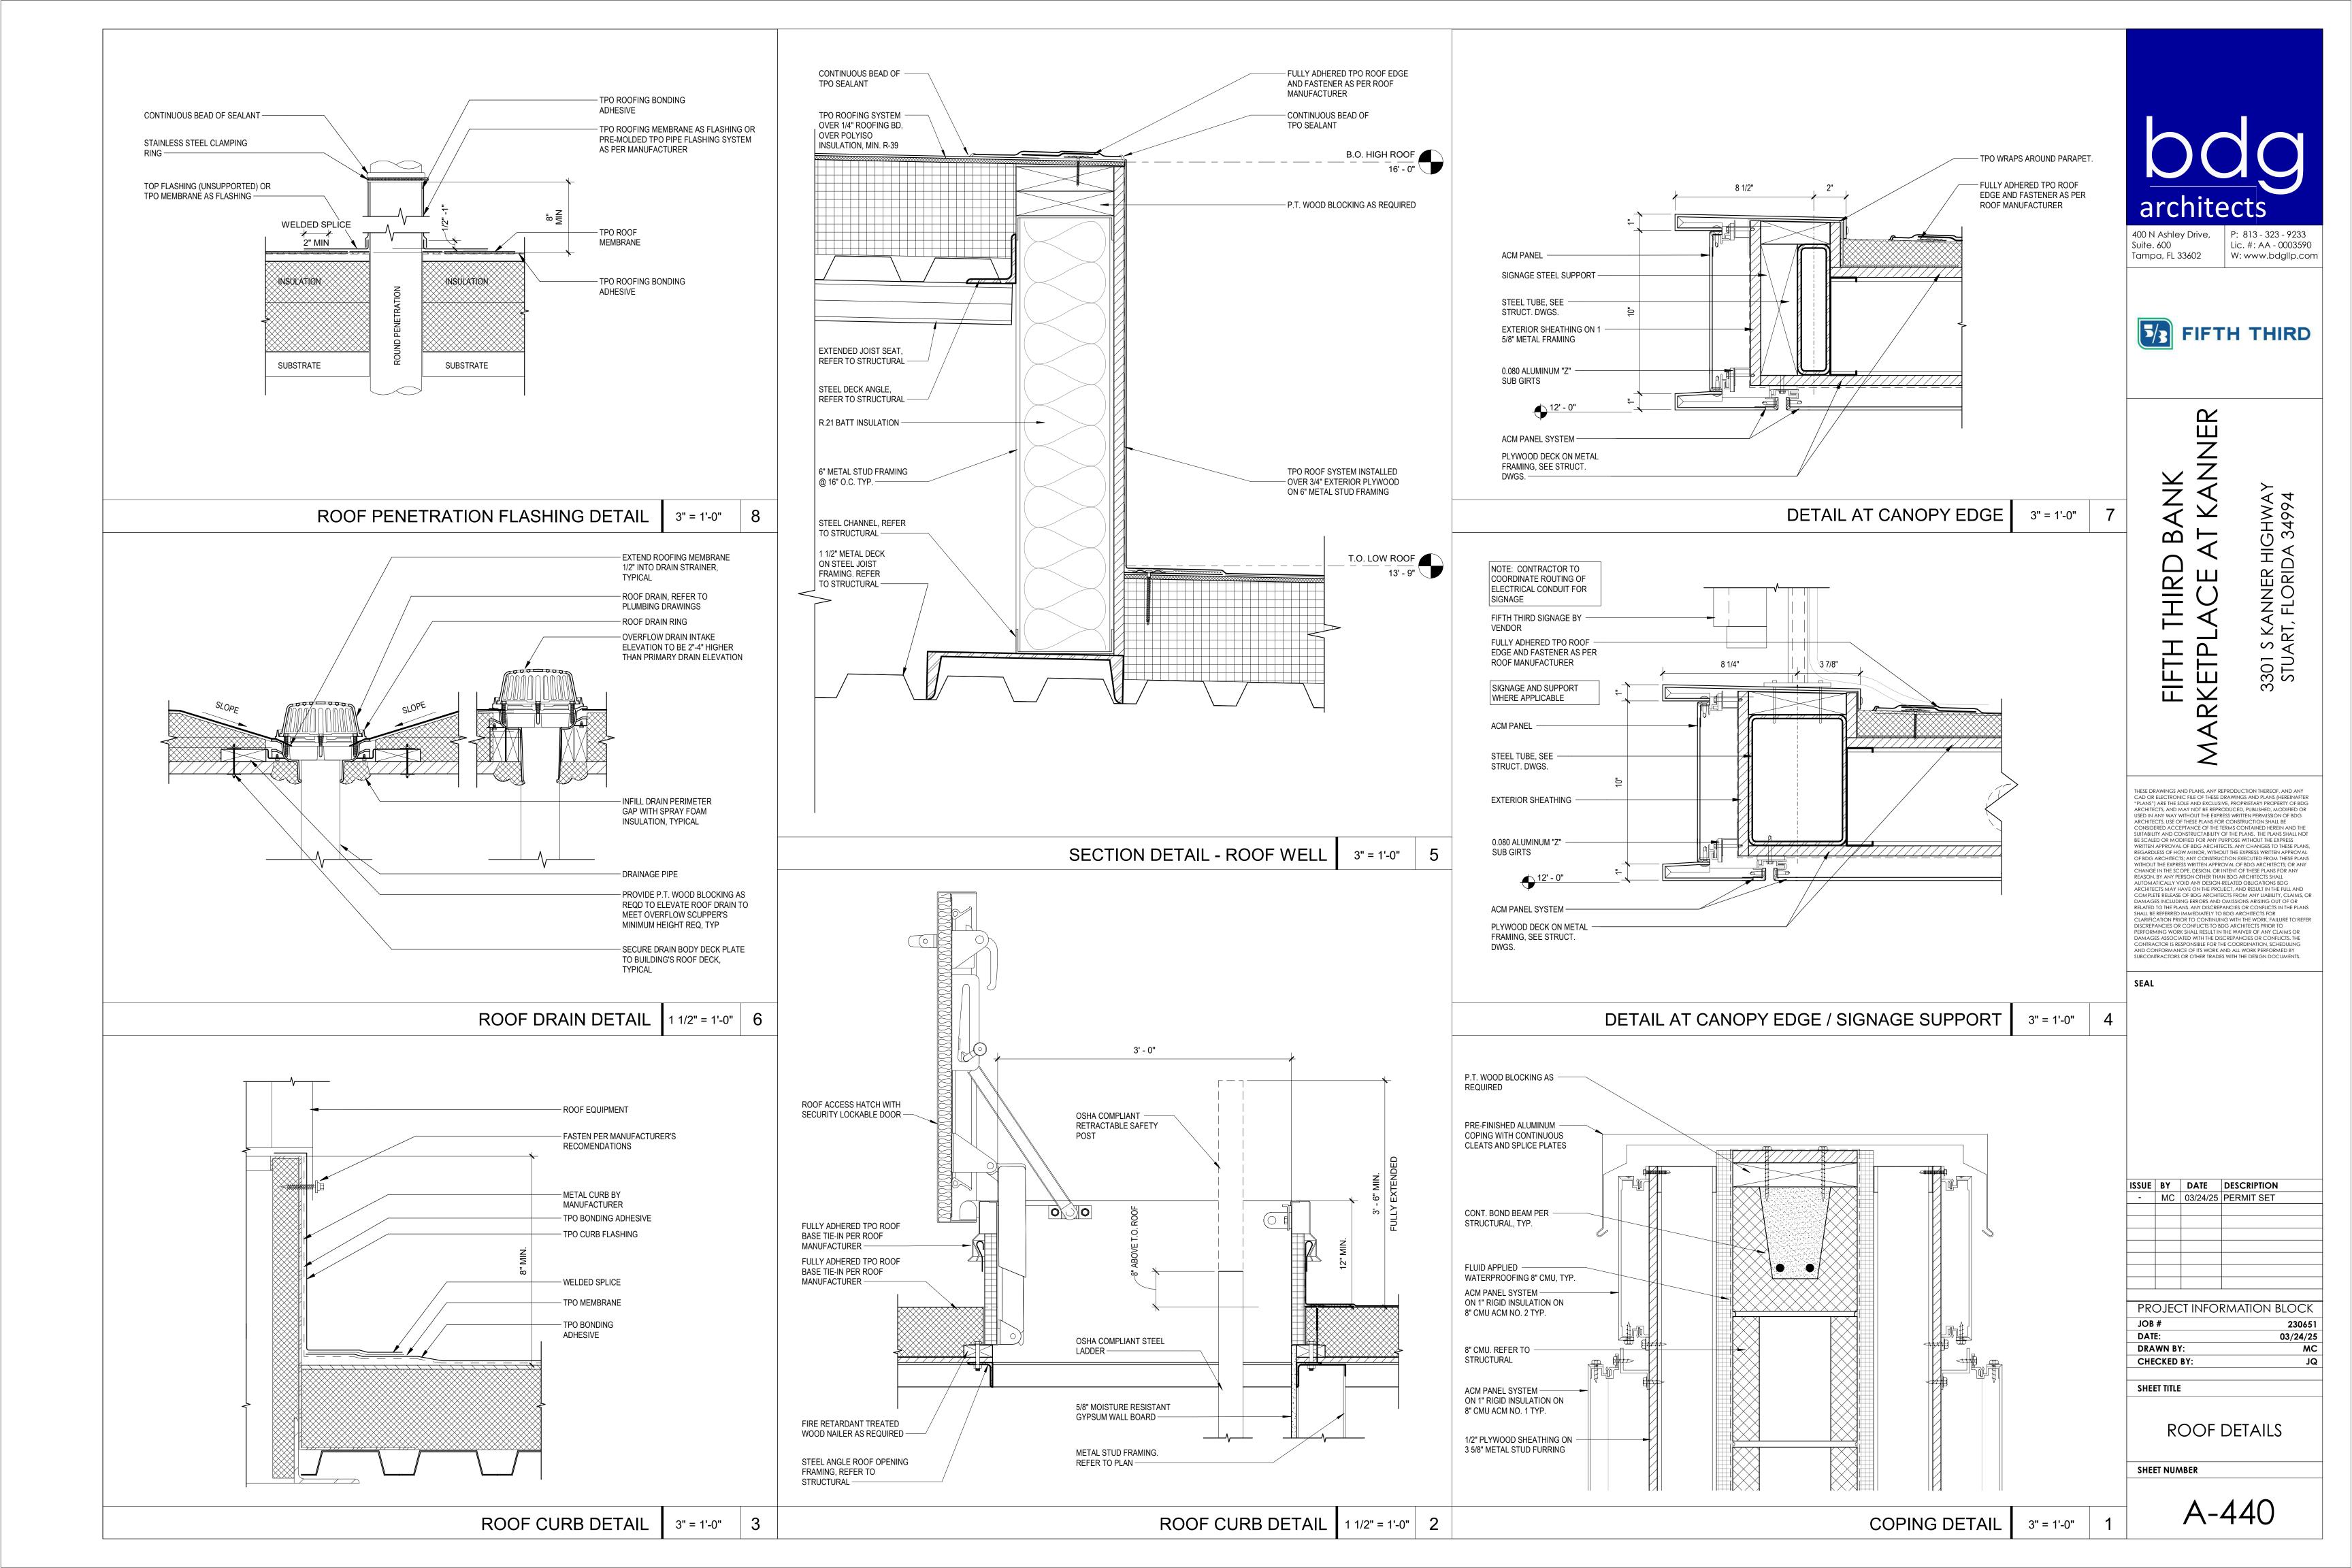
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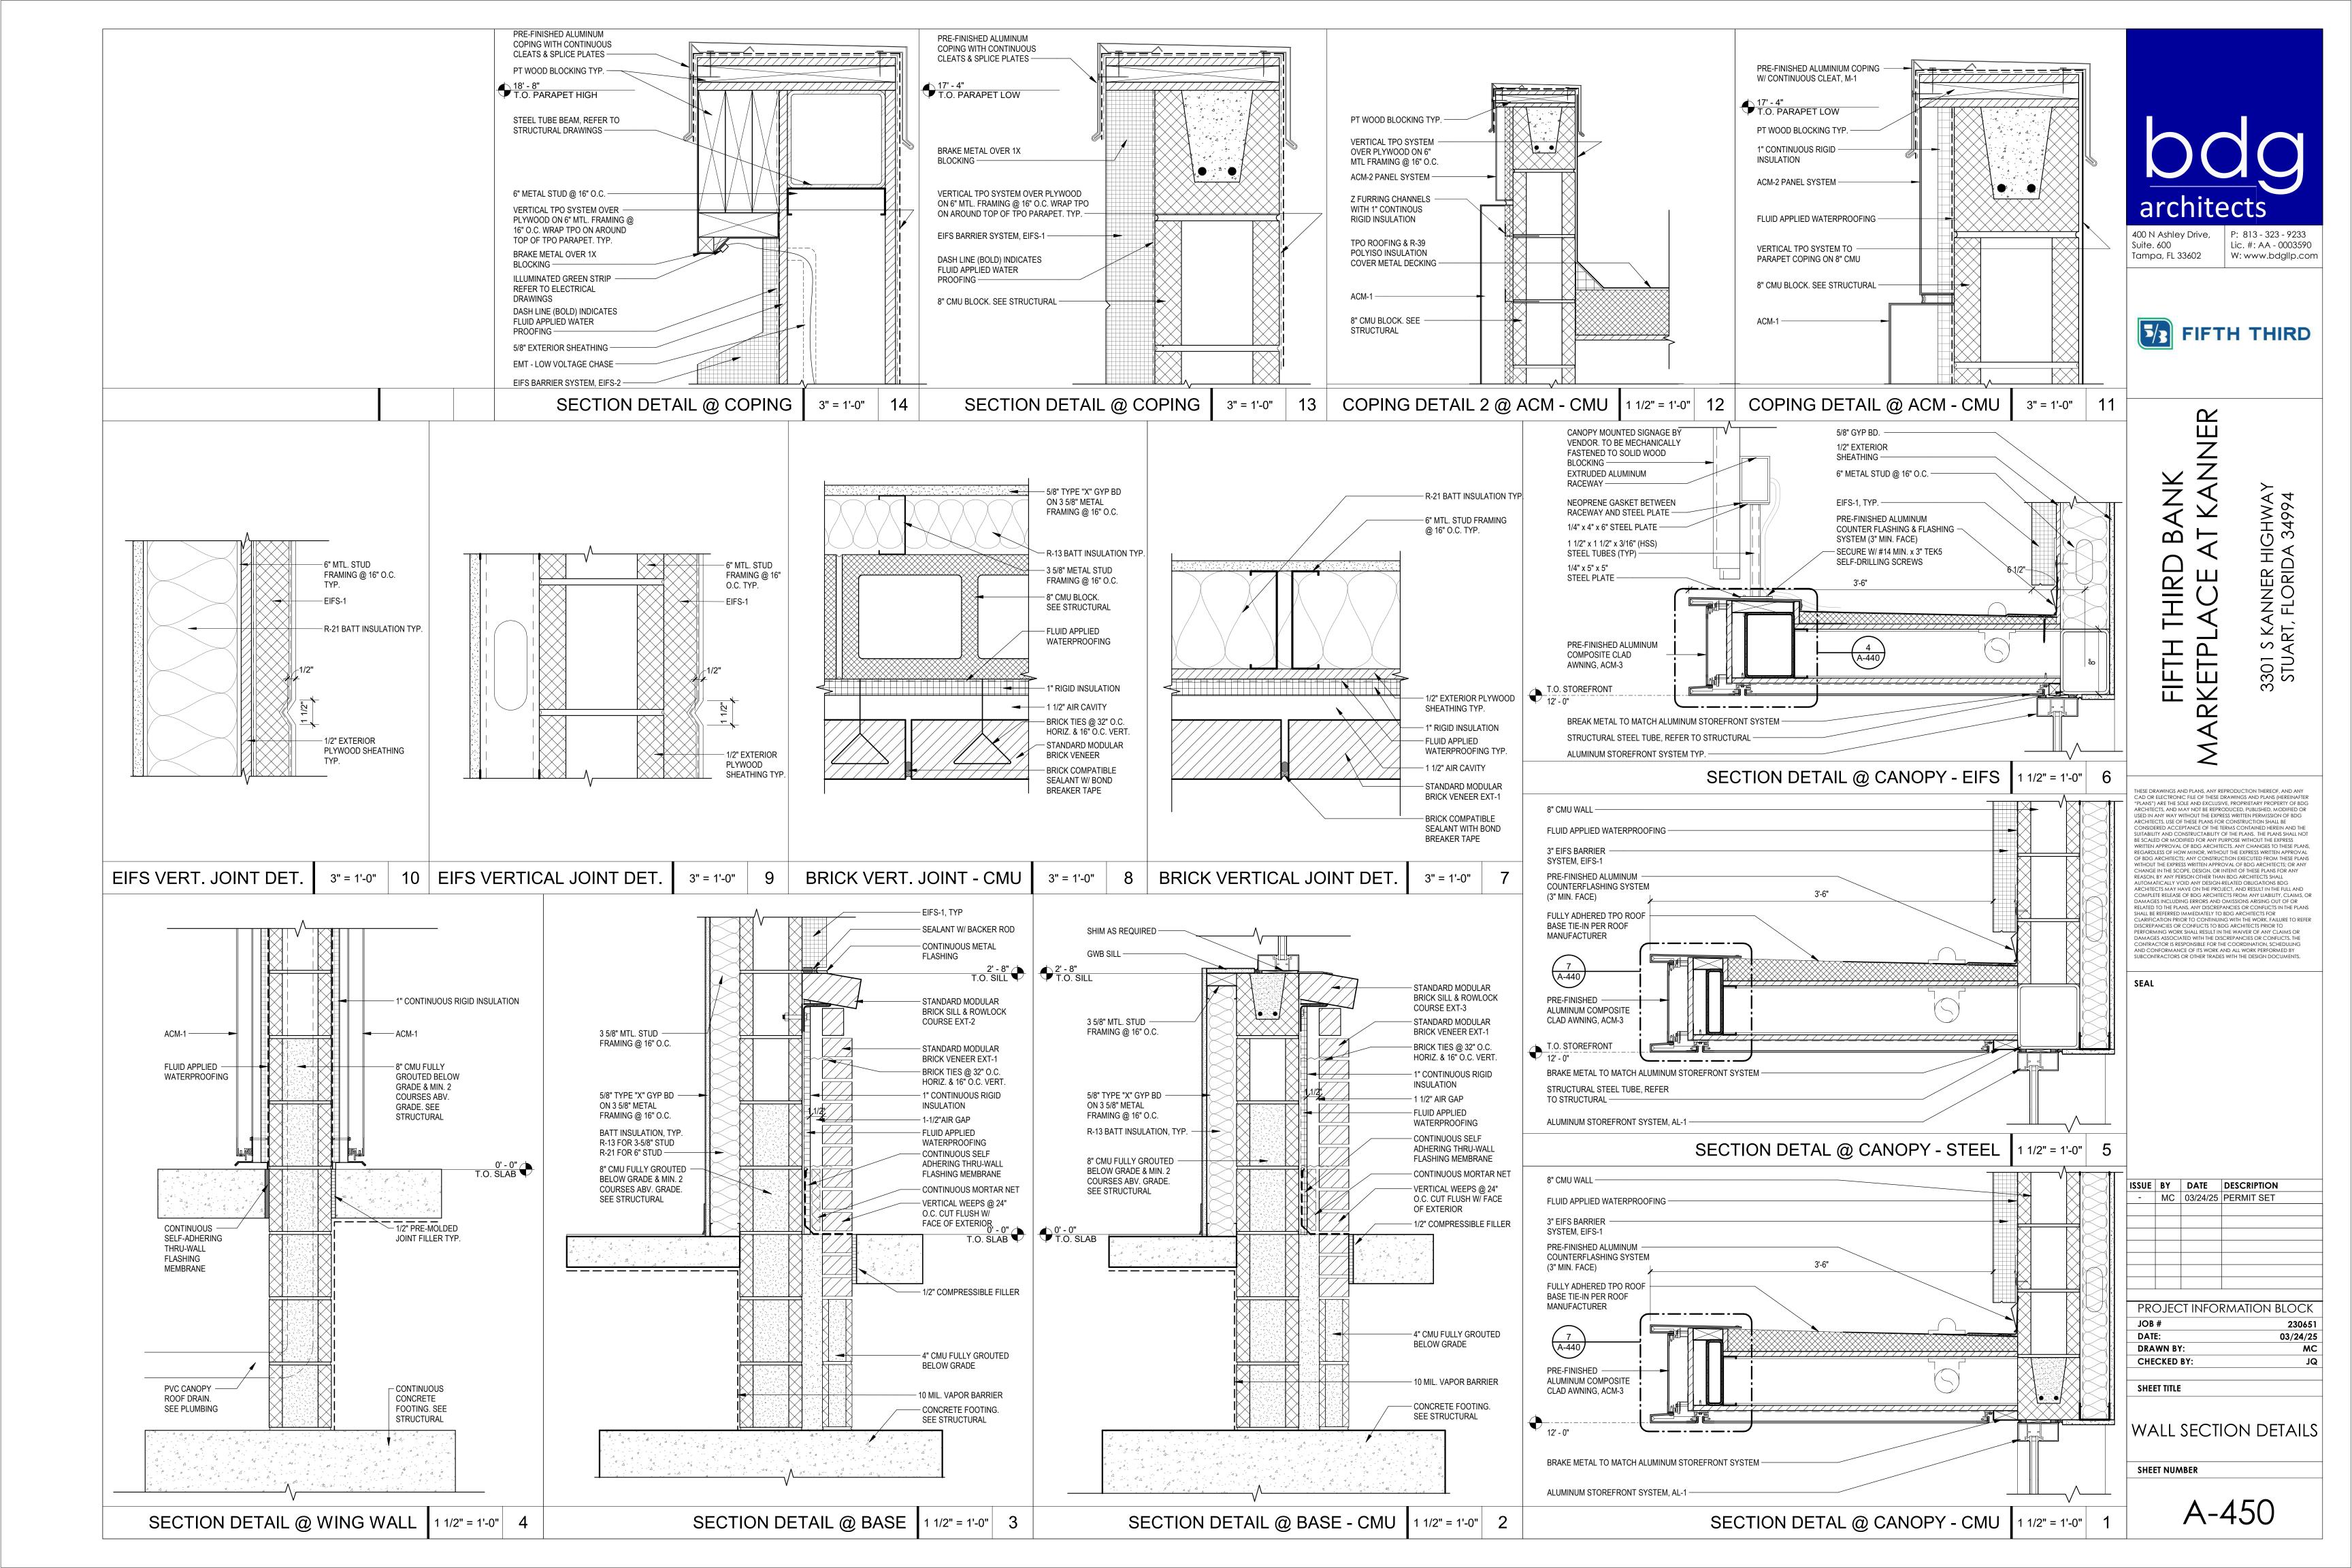
230651

03/24/25

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NOTES: ENTRY BY VALID CREDENTIAL @ READER TO RETRACT LATCHES (BOTH LEAFS) OR MANUAL KEY (ACTIVE LEAF) WHEN LOCKED. FREE EGRESS AT ALL TIMES. PUSH/PULL OPERATION AS REQ'D BY ELECTRONIC DOGGING OF EXIT DEVICES, EITHER TIMED UNLOCK VIA ACCESS CONTROL SYSTEM OR WALL MOUNTED KEYSWITCH. DOOR POSITION SWITCHES TO MONITOR OPENING STATUS. EXIT DEVICES HAVE INTEGRAL RX FEATURE TO SIGNAL EGRESS. AUTO-DOOR OPERATOR & ADA SWITCHES MUST BE INTEGRATED W/ ELECTRONIC EXIT DEVICES. EXTERIOR -A ADA SWITCH IS CONTROLLED BY EXIT DEVICE LATCH MONITOR IN ACTIVE DOOR LEAF. SWITCH ACTIVE ONLY WHEN LATCH IS IN RETRACTED POSITION. VESTIBULE ADA SWITCH ALWAYS ACTIVE-& WILL RELEASE ELECTRIC STRIKE FOR EGRESS. SEE A-110 FOR LOCATIONS OF AUTOMATED DOOR LEAFS & SWITCH LOCATIONS. COORDINATE W/ ELECTRICAL & SECURITY CONTRACTORS.

### EXTERIOR ALUMINUM STOREFRONT - ACCESS CONTROL FUNCTION - ALARMED EGRESS

QT		DESCRIPTION	FINISH	MFR				
1	CONTINUOUS HINGE	CFM-HD1		PE				
1	RIM EXIT DEVICE (NL x LESS DOGGING)		US32D	SA				
1	RIM EXIT DEVICE (NL x LESS DOGGING)	LD 43 HC8804 LESS PULL (FLORIDA ONLY)	US32D	SA				
1	RIM CYLINDER	34 SERIES AS REQ'D	US32D	SA				
1	PERMANENT MEDECO CYLINDER	BY OWNER (INSTALLED BY CONTRACTOR: COORDINATE VERIFY KEYING W/ OWNER)	24	MC				
1	BRIDGE RECTIFIER	2005M3 (12V)		HS				
1	ELEC. STRIKE W/ LATCH MONITOR	9600-LBM (12V) - (FL ONLY)	630	HS				
1	ELEC. STRIKE W/ LATCH MONITOR	9500-LBM (12V)	630	HS				
1	BRIDGE RECTIFIER	2005M3 (12V)		HS				
1	OFFSET PULL	RM201 ` ´	US32D	RO				
1	DOOR CLOSER W/ STOP	281 CPS	EN	SA				
1	BLADE STOP SPACER	581 AS REQ'D	EN	SA				
1	CLOSER MTG PLATE	281D AS REQ'D	EN	SA				
1	THRESHOLD	253x3 AFG FHSL 14SS		PΕ				
2	CREDENTIAL READER	BY DIV 28 (12V)		OT				
1	WIRING HARNESS (FRAME)	QC-C3000P		MK				
1	POWER SUPPLY	BY DIV 28 (12V)		OT				
1	SEALS, SWEEPS & ASTRAGALS	BY ALUMINUM DOOR MFR.		OT				
NO	NOTES: ENITOV BY I/ALID INDLIT @ EYTEDIOD DEADED TO DELEASE ELECTRIC STRIKE & SHLINT							

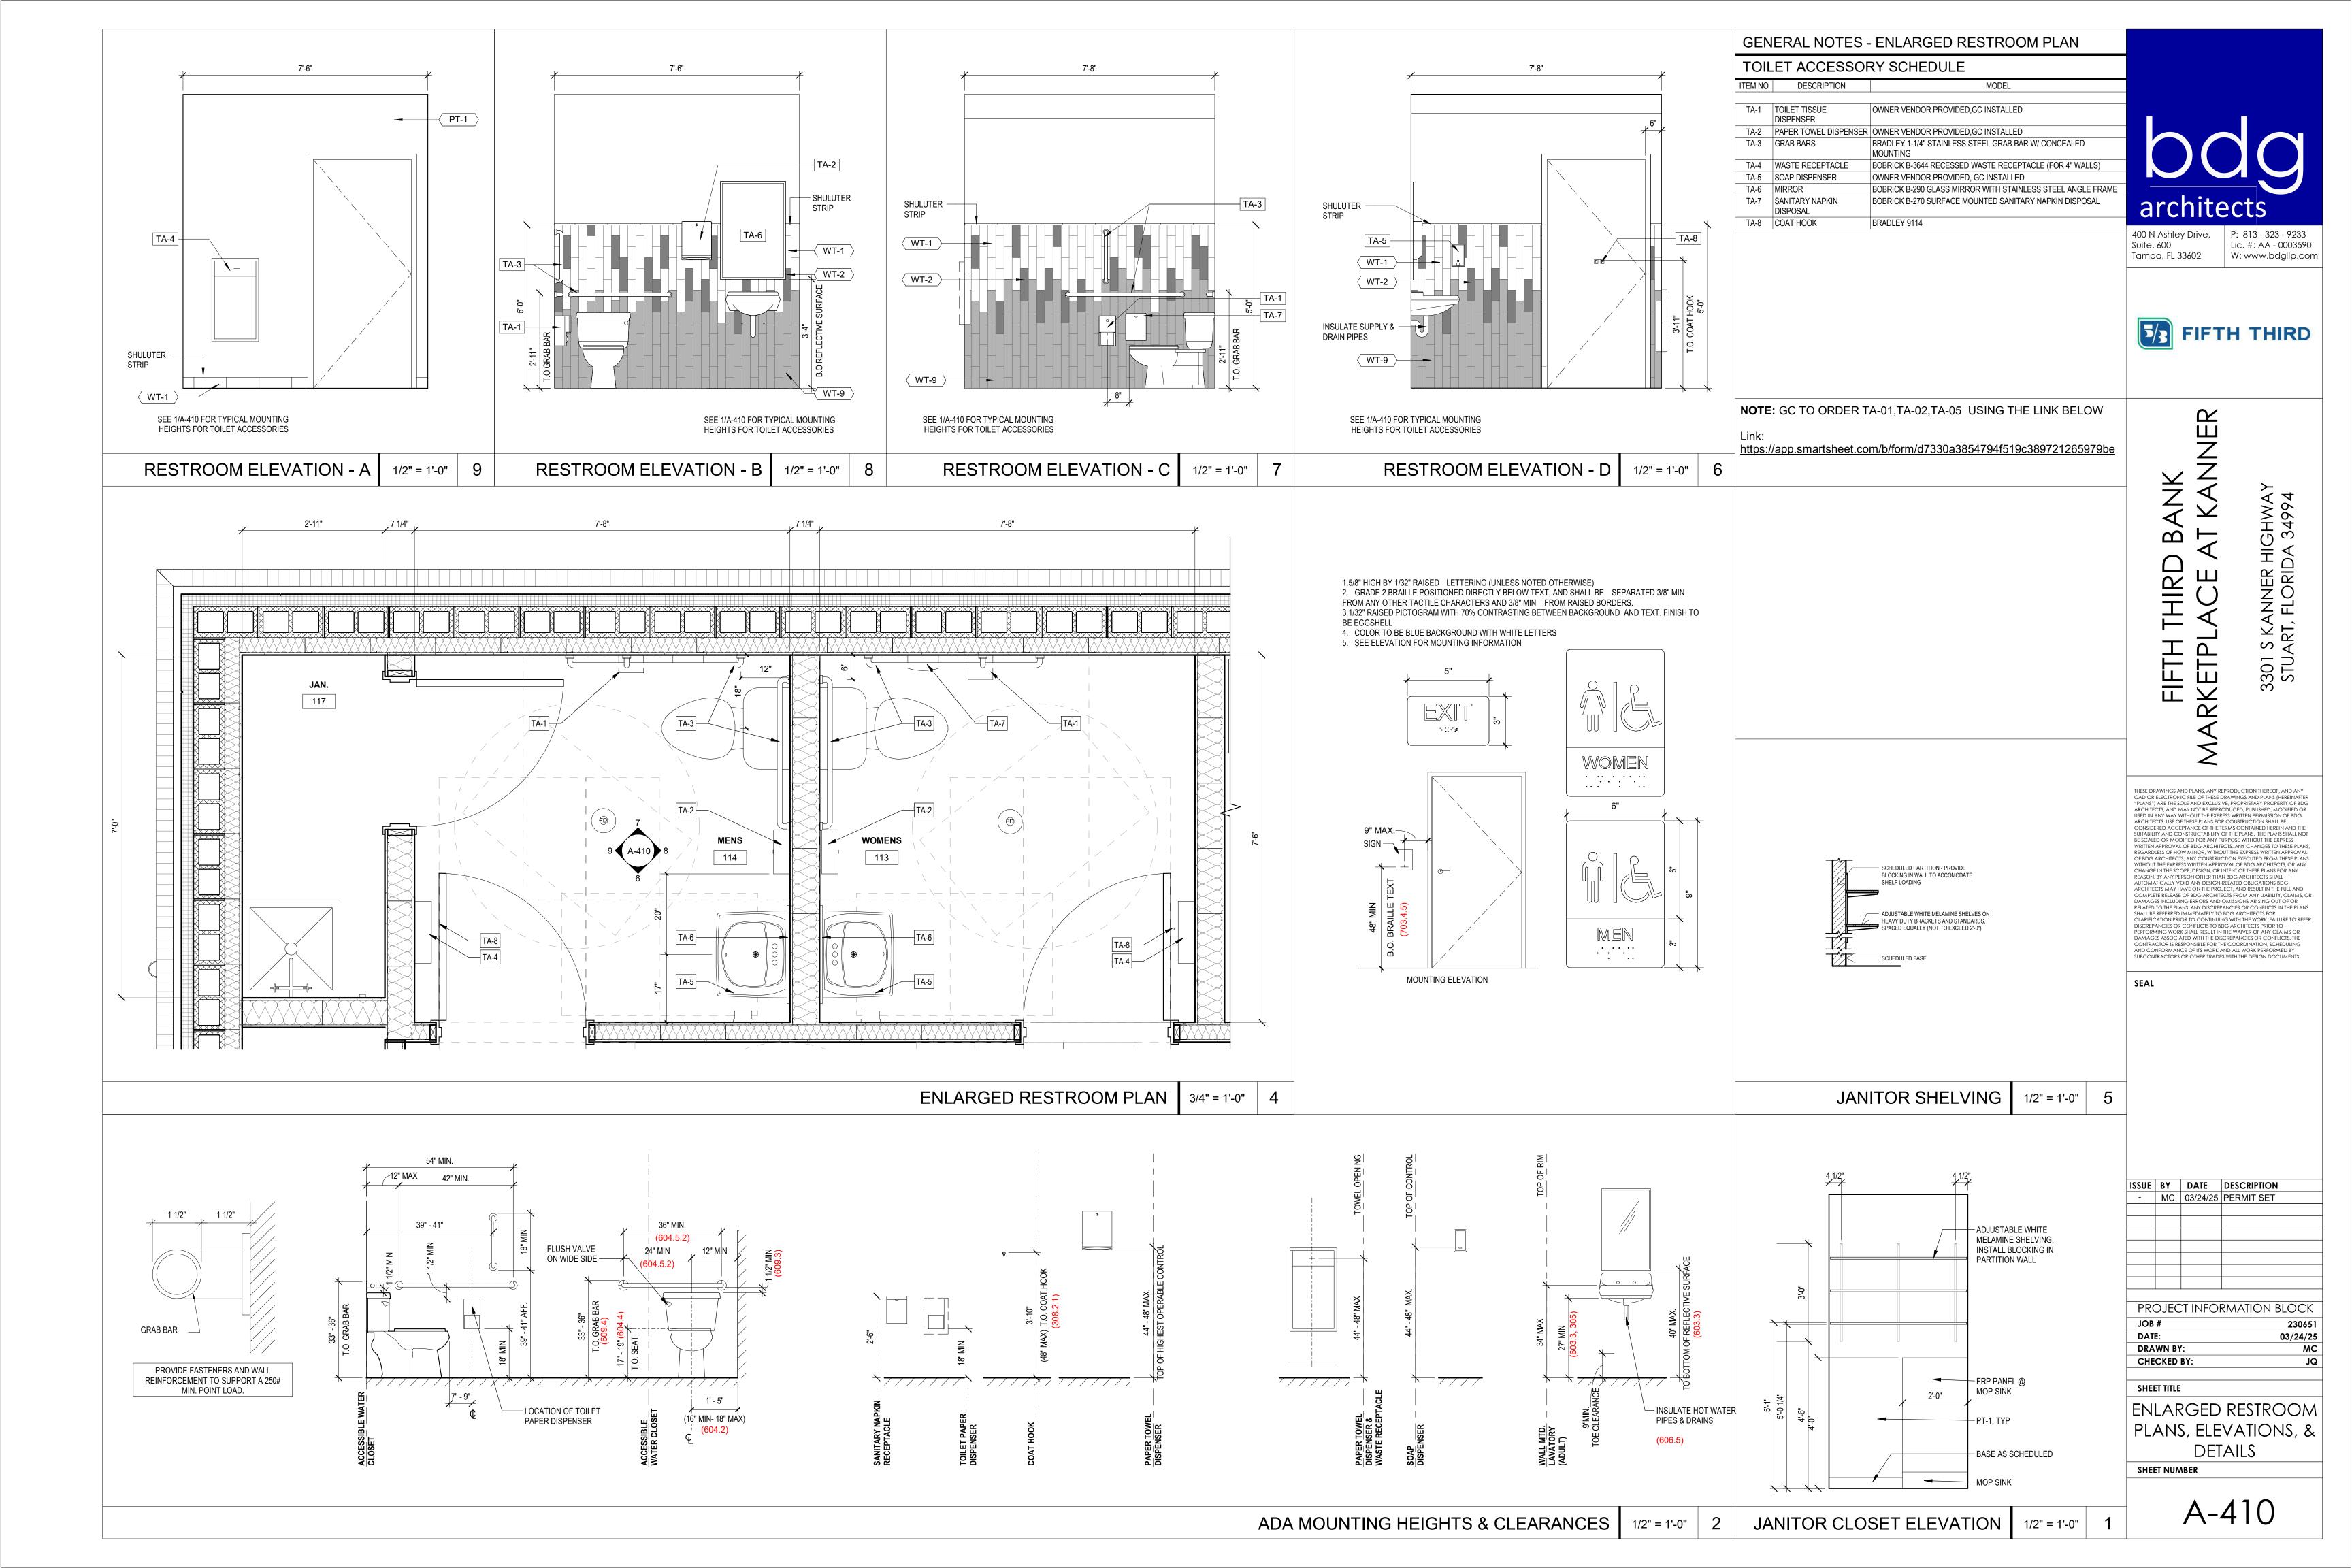NOTES: ENTRY BY VALID INPUT @ EXTERIOR READER TO RELEASE ELECTRIC STRIKE & SHUNT ALARM, OR MANUAL KEY. AUTHORIZED FREE EGRESS BY VALID INPUT @ INTERIOR READER TO DISABLE ALARM FOR MANUAL OPERATION. UNAUTHORIZED, ALARMED FREE EGRESS BY MANUAL PUSH BAR OPERATION TO RETRACT LATCH, TRIGGERING LOCAL & REMOTE ALARMS VIA LATCH MONITOR IN ELECTRIC STRIKE. WALL MOUNTED PIEZO ALARM W/ KEYSWITCH IS ON/OFF/RESET BY KEYED LOCK CYLINDER. LBM FEATURE IN ELECTRIC STRIKE TO MONITOR OPENING STATUS, SHUNTED BY VALID INPUT @ INTERIOR & EXTERIOR READERS. COORDINATE W/ ELECTRICAL &

### INTERIOR ALUMINUM STOREFRONT - PUSH / PULL FUNCTION - AUTO-DOOR

QTY	' ITEM	DESCRIPTION	FINISH	MFR
1	CONTINUOUS HINGE	CFM-HD1		PE
1	PUSH PULL SET	RM251 Mtg-Type 12XHD	US32D	RO
1	CONC OVERHEAD STOP	6-X36	630	RF
1	AUTOMATIC OPENER	6061 (D) - PUSH SIDE	689	NO
2	ADA SWITCH	503 (JAMB)/ 505 (WALL) / 500 (POST) AS REQ'D		NO
1	SEALS, SWEEPS & ASTRAGALS	BY ALÚMINUM DOOR MFR.		OT

NOTES: AUTO DOOR OPERATION BY INTERIOR & VESTIBULE ADA SWITCHES AT ALL TIMES. SEE PLAN SHEET A110 FOR LOCATIONS OF AUTOMATED DOOR LEAF AND SWITCH LOCATIONS. COORDINATE WITH ELECTRICAL AND SECURITY CONTRACTORS.

### ACCESS CONTROL FUNCTION x CLOSER x VIEWERS

ACC	ESS CONTROL FUNCTION X CLOSER X VIE	WERS		
QTY	ITEM	DESCRIPTION	FINISH	М
3	HINGE FULL MORTISE	TA2714 NRP (OUTSWING) TA2714 (INSWING)	US26D	M
1	STOREROOM LOCK	10G04 LL	US26D	SA
1	PERMANENT MEDECO CYLINDER	BY OWNER (INSTALLED BY	24	M
		CONTRACTOR. COORDINATE		
		KEYING W/ OWNER)		
1	BRIDGE RECTIFIER	2005M3 (12V)		HS
1	ELECTRIC STRIKE W/ LATCH MONITOR	5000C-LBM (12V)	630	HS
1	SURFACE CLOSER	281 O / P10 AS REQ'D	EN	SA
1	DOOR STOP	10-336 OVERHEAD/441CU	US26D	R
		FLOOR AS REQ'D		
3	SILENCER	608/609 AS REQ'D		R
1	CREDENTIAL READER	BY DIV 28 (12V)		0.
1	WIRING HARNESS (FRAME)	QC-C3000P		M
1	RX MOTION SENSOR	BY DIV 28 (12V)		Sl
1	POWER SUPPLY	BY DIV 28 (12V)		Ο.
2	DOOR SCOPE/VIEWER	DS1000	626	0.

NOTES: ENTRY BY VALID INPUT @ READER OR MANUAL KEY. FREE EGRESS @ ALL TIMES. LBM FEATURE IN ELECTRIC STRIKE TO MONITOR OPENING STATUS, SHUNTED BY INTERIOR RX MOTION SENSOR IF REQ'D. COORDINATE W/ ELECTRICAL & SECURITY CONTRACTORS.

### ACCESS CONTROL FUNCTION x CLOSER W/ STOP

7,00	Added Control to Notice & Geogle W/ Glor							
QTY	/ ITEM	DESCRIPTION	FINISH	MFR				
3	HINGE FULL MORTISE	TA2714 NRP (OUTSWING)	US26D	MK				
		TA2714 (INSWING)						
1	STOREROOM LOCK	10G04 LL	US26D	SA				
1	PERMANENT MEDECO CYLINDER	BY OWNER (INSTALLED BY	24	MC				
		DIV 087100. COORDINATE &						
		VERIFY KEYING W/ OWNER)						
1	BRIDGE RECTIFIER	2005M3 (12V)		HS				
1	ELEC. STRIKE W/ LATCH MONITOR	5000C-LBM (12V)	630	HS				
1	DOOR CLOSER W/ STOP	281 CPS ` ´	EN	SA				
3	SILENCER	608/609 AS REQ'D		RO				
1	CREDENTIAL READER	BY DIV 28 (12V)		OT				
1	WIRING HARNESS (FRAME)	QC-C3000P		MK				
1	RX MOTION SENSOR	BY DIV 28 (12)		SU				

NOTES: ENTRY BY VALID INPUT @ READER OR MANUAL KEY. FREE EGRESS @ ALL TIMES. LBM FEATURE IN ELECTRIC STRIKE TO MONITOR OPENING STATUS, SHUNTED BY INTERIOR RX MOTION SENSOR IF REQ'D. COORDINATE W/ ELECTRICAL & SECURITY CONTRACTORS.

### ACCESS CONTROL FUNCTION x KICKPLATE (JANITOR CLOSET)

QTY	ITEM	DESCRIPTION	FINISH	MFR
3	HINGE FULL MORTISE	TA2714 NRP (OUTSWING)	US26D	MK
		TA2714 (INSWING) AS REQ'D		
	STOREROOM LOCK	10G04 LL	US26D	SA
	PERMANENT MEDECO CYLINDER	BY OWNER (INSTALLED BY	24	MC
		DIV 087100. COORDINATE &		
		VERIFY KEYING W/ OWNER)		
	BRIDGE RECTIFIER	2005M3 (12V)		HS
	ELEC. STRIKE W/ LATCH MONITOR	5000C-LBM (12V)	630	HS
	KICK PLATE	K1050 10" HGT x CSK x BEV	US32D	RO
	DOOR STOP	10-336 OVERHEAD/	US26D	RO
		441CU FLOOR AS REQ'D		
,	SILENCER	608/609 AS REQ'D		RO
	CREDENTIAL READER	BY DIV 28 (12V)		OT
	WIRING HARNESS (FRAME)	QC-C3000P		MK

NOTES: ENTRY BY VALID INPUT @ READER OR MANUAL KEY. FREE EGRESS @ ALL TIMES. LBM FEATURE IN ELECTRIC STRIKE TO MONITOR OPENING STATUS, IF REQ'D. COORDINATE W/ **ELECTRICAL & SECURITY CONTRACTORS.** 

### SET 10.0 DDI//ACY FUNCTION W/ OCCUPANCY INDICATOR V SEALS (PHONE BOOM)

QTY ITEM  3 HINGE FULL MORTISE  1 PRIVACY LOCK W/ INDICATOR  1 DOOR STOP	DESCRIPTION TA2714 (SIZE PER SPEC) LB V20 8265 LNL 10-336 OVERHEAD/ 441CU FLOOR AS REQ'D	FINISH US26D US26D US26D	
SET 11.0	NOATOD CLOSED		
PRIVACY FUNCTION W/ OCCUPANCY IND	JICATUR X CLUSER		

LB V20 8265 LNL

608/609 AS REQ'D

EN

US26D

US26D

US26D RO

SA

### 281 O / P10 AS REQ'D SURFACE CLOSER 1 DOOR STOP 10-336 OVERHEAD/ 441CU FLOOR AS REQ'D

SILENCER

1 COAT HOOK

PRIVACY LOCK W/ INDICATOR

QTY	ITEM	DESCRIPTION	FINISH	M
3	HINGE, FULL MORTISE	TA2714 (SIZE PER SPEC)	US26D	М
1	PUSH PULL SET	RM251 `	US32D	R
1	CLOSER MTG PLATE	281J	EN	S
1	SURFACE CLOSER	281 O/P10 AS REQ'D	EN	S
1	DOOR STOP	10-336 OVERHEAD/	US26D	R
		441CU FLOOR AS REQ'D		
1	SEALS, SWEEPS & ASTRAGALS	BY ALUMINUM DOOR MFR		0


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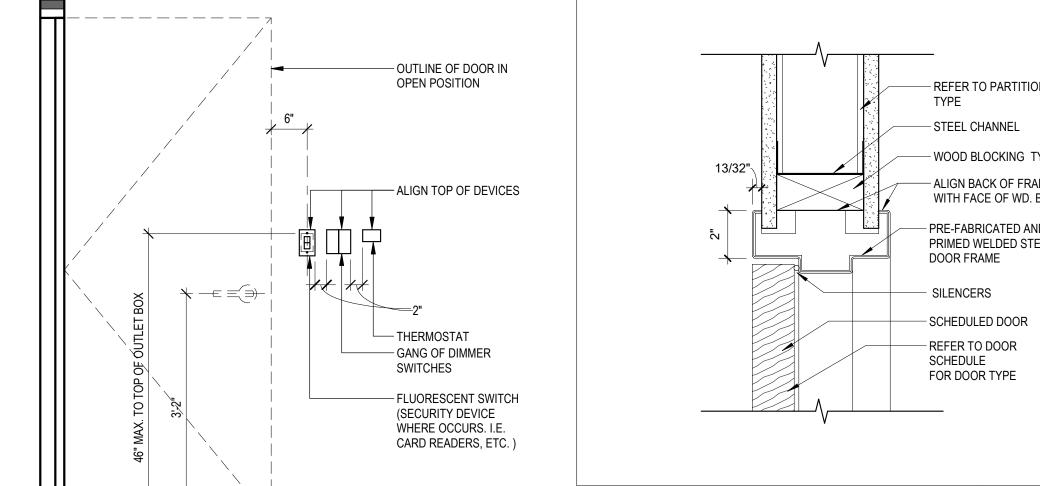
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MC	MEDECO
MK	MCKINNEY
NO	NORTON
OT	OTHER
PE	PEMKO
RF	RIXSON
RO	ROCKWOOD
SA	SARGENT
SU	SECURITRON


			DO	ORS					
		DOOR	SIZ	ZES		DOOR	FRAME	HRDW	
MAR	ROOM NAME	TYPE	WIDTH	HEIGHT	THICKNESS	MATERIAL	MATERIAL	SET NO.	COMMENTS
100	WEATHER VESTIBULE	D	6' - 0"	8' - 0"		GLASS	ALUM	1	CARD READER AND POWER ASSIST BUTTON
101	ENTRY	D	6' - 0"	8' - 0"		GLASS	ALUM	5	CARD READER AND POWER ASSIST BUTTON
105	MEETING ROOM	Е	3' - 0"	7' - 0"		GLASS	ALUM	13	GC COORDINATE WITH fifththirdsupport@dirtt.com
109	EMPLOYEE LOUNGE	Е	3' - 0"	8' - 0"		GLASS	ALUM	3	CARD READER
110	WORK ROOM	С	3' - 0"	7' - 0"		SCW	HM	6	CARD READER; KNOCK-DOWN FRAME
112	PHONE ROOM	В	3' - 0"	7' - 0"		SCW	HM	10	
113	WOMENS	В	3' - 0"	7' - 0"		SCW	HM	11	
114	MENS	В	3' - 0"	7' - 0"		SCW	HM	11	
115	ELEC / IT ROOM	В	3' - 0"	7' - 0"		SCW	HM	8	CARD READER
116	CLO.	В	3' - 0"	7' - 0"		SCW	HM	9	CARD READER
117	JAN.	В	3' - 0"	7' - 0"		SCW	HM	9	CARD READER

### **GENERAL NOTES - DOOR & HARDWARE**

DOOR & FRAME SCHEDULE



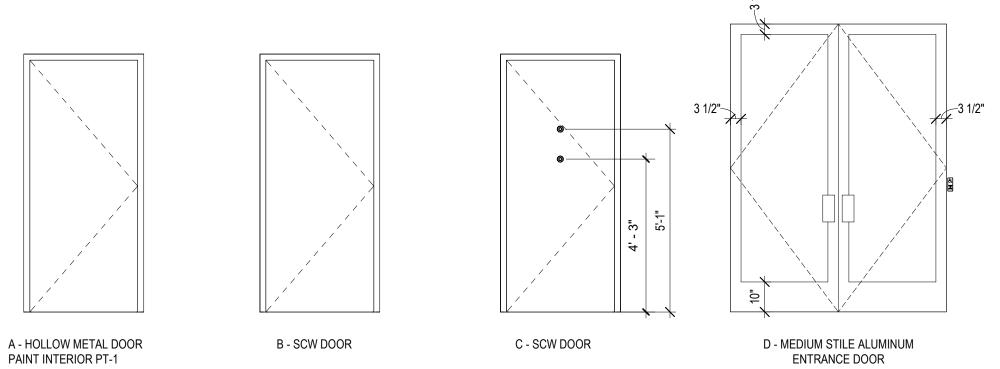

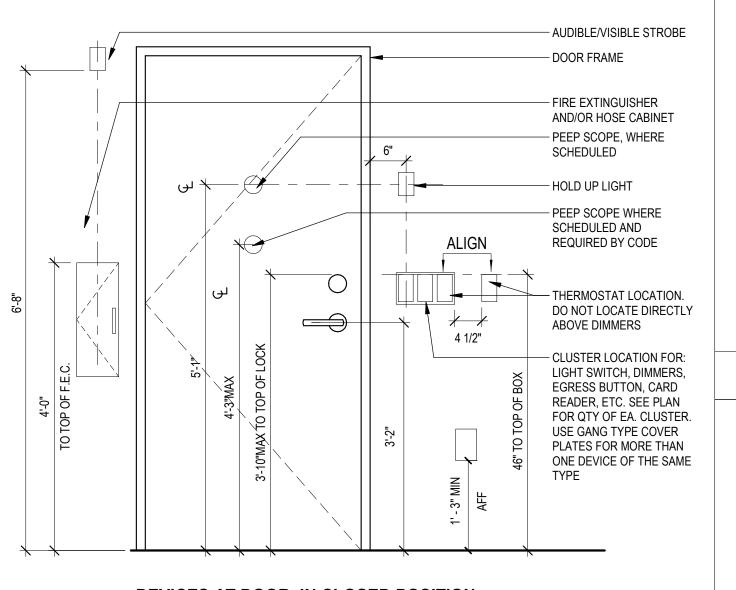


**DEVICES AT DOOR IN OPEN POSITION** 

### **DEVICES AT DOOR IN CLOSED POSITION**


NOTE: ALL DIMENSIONS TO CENTER LINE OF DEVICES U.N.O.; INTERCOM TO BE MOUNTED AT 3'-9" AFF U.N.O.; CENTER ALL DEVICES BELOW SWITCH. ALL OPERABLE PARTS SHALL BE OPERABLE WITH ONE HAND AND SHALL NOT REQUIRE TIGHT GRASPING, PINCHING, OR TWISTING OF THE WRIST WITH A MAX OF 5 LBS. OF FORCE TO OPERATE. A CLEAR SPACE TO BE PROVIDED OF 30" MIN. X 48" MIN.

> TYPICAL MOUNTING HEIGHTS 3/4" = 1'-0" 4

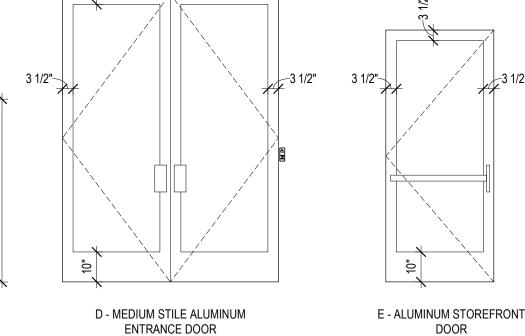


- REFER TO PARTITION - WOOD BLOCKING TYP. - ALIGN BACK OF FRAME WITH FACE OF WD. BLOCK PRE-FABRICATED AND PRIMED WELDED STEEL

### INTERIOR DOOR HEAD 3" = 1'-0"

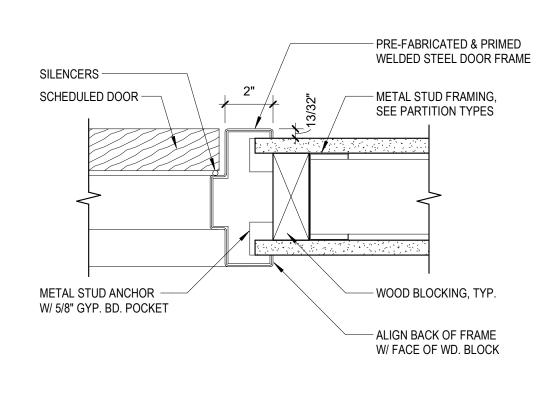

### INTERIOR DOOR JAMB 3" = 1'-0"

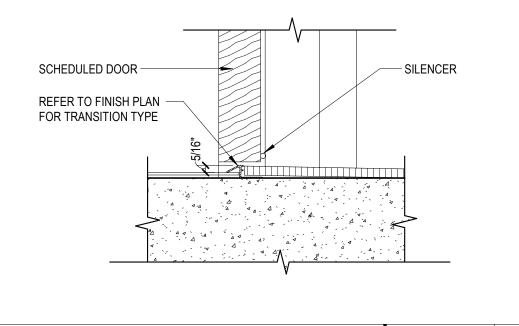

INTERIOR THRESHOLD

3" = 1'-0"

1 DOOR THRESHOLD SHALL BE 1/2" HIGH MAX WITH SLOPE 1:2 MAX. RAISED THRESHOLDS TO COMPLY WITH 302 AND 303 (404.2.5, 302, 303)

GENERAL NOTES - DOOR & HARDWARE

- 2 DOUBLE DOORS AT LEAST (1) ACTIVE LEAF OF A DOORWAY TO PROVIDE 32" MIN CLEAR OPENING
- SWINGING DOOR SURFACES WITHIN 10" FROM FINISH FLOOR MEASURED VERTICALLY TO HAVE A SMOOTH SURFACE ON THE PUSH SIDE EXTENDING THE FULL WIDTH OF THE DOOR. PARTS CREATING HORIZONTAL OR VERICAL JOINTS IN THESE SURFACES TO BE WITHIN 1/16" OF THE SAME PLANE AS THE OTHER. CAVITIES CREATED BY ADDED KICK PLATES SHALL BE CAPPED. EXCEPTIONS: 1) SLIDING DOORS ARE NOT REQUIRED TO COMPLY WITH 404.2.10; 2) TEMPERED GLASS DOORS WITHOUT STILES AND HAVING A BOTTOM RAIL OR SHOE WITH THE TOP LEADING EDGE TAPERED AT 60 DEGREES MINIMUM FROM THE HORIZONTAL SHALL NOT BE REQUIRED TO
- MEET THE 10" BOTTOM SMOOTH SURFACE HEIGHT REQUIREMENT (ADA 404.2.10) 4 DOOR HARDWARE TO BE OPERABLE WITH ONE HAND AND SHALL NOT REQUIRE TIGHT GRASPING PINCHING, OR TWISTING OF THE WRIST (309.4)
- OPERABLE PARTS SUCH AS DOOR HARDWARE TO BE MOUNTED 34" MIN AND 48" MAX AFF. WHERE SLIDING DOORS ARE IN THE FULLY OPEN POSITION, OPERATING HARDWARE SHALL BE EXPOSED AND USABLE FROM BOTH SIDES (404.2.7)
- DOOR CLOSERS TO BE ADJUSTED SO THAT FROM THE OPEN POSITION OF 90 DEGREES, THE TIME REQUIRED TO MOVE THE DOOR TO A POSITION OF 12 DEGREES FROM THE LATCH IS 5 SECONDS
- MIN (404.2.8) 7 THE FORCE FOR PUSHING OR PULLING OPEN A DOOR OR GATE OTHER THAN FIRE DOORS ARE AS FOLLOWS: A) INTERIOR HINGED DOORS AND GATES REQUIRE 5 LBS MAXIMUM FORCE TO OPEN. B) SLIDING AND FOLDING DOORS REQUIRE 5 LBS MAXIMUM FORCE TO OPEN. THESE FORCES DO NOT

APPLY TO THE FORCE REQURIED TO RETRACT LATCH BOLTS OR DISENGAGE OTHER DEVICES

THAT HOLD THE DOOR IN A CLOSED POSITION. (ADA 404.2.9) 8 FIRE DOORS SHALL HAVE A MINIMUM OPENING FORCE ALLOWABLE BY THE APPROPRIATE AUTHORITY.

### DOOR AND WINDOW NOTES

- 1 BASIS OF DESIGN FOR EXTERIOR CURTAIN WALL: KAWNEER CURTAINWALL 1600 SYSTEMS (YKK APPROVED EQUAL)
- 2 BASIS OF DESIGN FOR INTERIOR CURTAIN WALL: KAWNEER TRIFAB 451T VG (YKK APPROVED
- 3 SCW DOOR SPECIFICATIONS: SCW DOORS TO BE OSHKOSH, ROTARY SLICED WHITE BIRCH, FINISH AWI6:600 COLOR: 9133D. NO SUBSTITUTIONS

### HARDWARE NOTES

- 1 UNDERCUT DOORS WITHIN INDIVIDUAL UNITS AS REQUIRED
- 2 REFER TO SPECIFICATIONS FOR DOOR GLAZING
- 3 EXTERIOR HOLLOW METAL DOORS AND GRAMES SHALL BE GALVANIZED
- 4 DOOR SHALL MEET ALL LOCAL WIND SPEED AND IMPACT REQUIREMENTS
- 5 PROVIDE ADA COMPLIANT HARDWARE ON ALL DOORS
- 6 ALL GLAZING SHALL BE TEMPERED GLASS FOR DOORS 7 ALL ALUMINUM STOREFRONT DOORS SHALL BE NATURAL ANODIZED FINISH, .7MILS
- ARCHITECTURAL CLASS I 8 ALL METAL DOORS AND FRAMES SHALL BE PAINTED. SEE SCHEDULE FOR ADDITIONAL
- INFORMATION

### 9 ALL METAL DOORS AND FRAMES SHALL BE 16 GAUGE, WELDED.

### STOREFRONT / GLAZING NOTES

- 1 THE MINIMUM GLAZING PERFORMANCE SHALL BE AS FOLLOWS: U-FACTOR = 0.27-0.29 AND THE SOLAR HEAT GAIN COEFFICIENT = 0.38 - GLAZING BASIS OF DESIGN - PPG SOLAR BAN 60 CLEAR +
- 2 ALL EXTERIOR GLAZING SHALL BE TEMPERED, 1" INSULATED GLAZING.
- 3 ALL INTERIOR WINDOWS SHALL BE TEMPERED ONLY.
- 4 ALL INTERIOR AND EXTERIOR ALUMINUM STOREFRONT SYSTEMS TO BE YKK WITH CLASS I NATURAL ANODIZED FINISH.
- 5 GENERAL CONTRACTOR MUST ADHERE TO 'HOLD TO DIMENSIONS' AS ALL DIMENSIONS ARE CRITICAL.

### TRANSITION NOTES

- 1 FLOOR LEVEL CHANGES GREATER THAN 1/4" SHALL BE BEVELED 1:2 PER ADA
- 2 FLOOR LEVEL CHANGES BETWEEN 1/4" AND 1/2" SHALL BE AT A MAX 1:2 RATIO. MAX VERTICAL SHALL BE 1/4"

### ALL DOOR HARDWARE TO BE PURCHASED FROM LOCKNET OR ALARM DETECTION SYSTEMS, BASED ON THE LOCATION OF THE PROJECT. GC TO PURCHASE THE HARDWARE AND SHIPPED TO THEM OR THEIR TRADE PARTNERS FOR INSTALLATION

### COVERAGE AREAS:

- · ALL OF IL AND NW INDIANA: ALARM DETECTION SYSTEM, dsirek@adsalarm.com
- ALL PROJECTS OUTSIDE OF IL AND NW INDIANA: LOCKNET, 53Retail@LockNet.com

400 N Ashley Drive, P: 813 - 323 - 9233 Suite. 600 Lic. #: AA - 0003590 Tampa, FL 33602 W: www.bdgllp.com





ANNER

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ISSUE BY DATE DESCRIPTION - MC 03/24/25 PERMIT SET

PROJECT INFORMATION BLOCK JOB# 230651 DATE: 03/24/25 DRAWN BY: CHECKED BY:

SHEET TITLE

DOOR SCHEDULE & DETAILS

**SHEET NUMBER** 

