ALDI Inc. - Coconut Crossing, FL

Store No. 50 12850 Northlake Boulevard Coconut Crossing, FL 33412

ARCHITECT'S JOB NUMBER: 22-0267A ISSUE DATE: 07/08/24



SITE PLAN APPROVAL

COUNTY PROJECT NUMBER: ADMN-23-09-0033 AMENDMENT NUMBER: ADMN-25-05-0058

PROJECT SUMMARY

THIS PROJECT CONSISTS OF THE CONSTRUCTION OF A GROUND-UP ONE STORY BUILDING FOR OCCUPANCY BY ALDI FOOD MARKET.

MECHANICAL

ENGINEER OF RECORD:

CIVIL ENGINEER OF RECORD:

Thomas Engineering Group Ryan O. Thomas, PE 6300 NW 31ST Ave. Fort Lauderdale, FL 33309 (954) 202-7000 (954) 202-7070 Fax Contact: Frank Youngman, PE (954) 202-7000 fyoungman@thomaseg.com

STRUCTURAL ENGINEER OF RECORD:

APD Engineering & Architecture, PLLC 615 Fishers Run Victor, NY 14564 Brent Powell, PE, LEED AP (585) 742-2222 (585) 924-4914 Fax Contact: Steven Flint, PE (585) 742-0235 sflint@apd.com

A-504 Exterior Details

A-505 Exterior Details

A-506 Exterior Details

A-507 Exterior Details

A-511 Interior Details

A-512 Interior Details

A-513 Interior Details

A-601 Door Schedules & Details

A-603 | Finish Schedules & Notes

A-602 | Window Elevations & Details

ELECTRICAL **ENGINEER OF RECORD:**

APD Engineering & Architecture, PLLC APD Engineering & Architecture, PLLC 615 Fishers Run 615 Fishers Run Victor, NY 14564 Victor, NY 14564 Kenneth Rea, PE Kenneth Rea, PE (585) 742-2222 (585) 742-2222 (585) 924-4914 Fax (585) 924-4914 Fax Contact: Kenneth Rea, PE Contact: Kenneth Rea, PE (585) 869-9649 (585) 869-9649

krea@apd.com

PROJECT LATITUDE: 26.8118 PROJECT LONGITUDE: -80.2374



LOCATION MAP:

NOTES

krea@apd.com

NOTE: THESE DRAWINGS ARE PART OF THE CONTRACT DOCUMENTS AS DESCRIBED IN THE PROJECT MANUAL; IN ANY AND ALL CONFLICTS BETWEEN THE DRAWINGS AND THE TECHNICAL SPECIFICATIONS, THE MOST STRINGENT REQUIREMENT WILL GOVERN AND THE G.C. SHALL COORDINATE WITH THE ALDI REPRESENTATIVE.

THESE DOCUMENTS ARE FOR THE SOLE PURPOSE OF INITIAL BUILDING PERMIT SUBMITTAL ONLY. ANY COMMENTS, REVISIONS OR CORRECTIONS BASED ON BUILDING DEPARTMENT REVIEW AND/OR BUILDING CODE INTERPRETATION ITEMS ARE THE SOLE RESPONSIBILITY OF THE OWNER AND REGIONAL ARCHITECT WILL NOT BE HELD LIABLE FOR ANY CHANGE ORDERS RESULTING FROM THESE ITEMS. FINAL BID PRICES SHOULD NOT BE SUBMITTED UNTIL THE BUILDING PERMIT HAS BEEN ISSUED.

DRAWINGS ARE BASED ON ALDI VERSION 7.0ER PROTOTYPE RELEASED ON 05.30.24

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SHEET #	SHEET NAME	10/02/24	10/08/24	11/18/24	12/20/24	07/29/25	XX/XX/XX	XX/XX/XX	SHEET #	SHEET NAME	10/02/24	10/08/24	11/18/24	12/20/24	07/29/25	× × × × × × × × × × × × × × × × × × ×	X X / X X / X X	
G-001	Cover Sheet	Х	X	Х	Х				P-001	Plumbing Schedules					Х			ENGINEERING
G-002	Code Review	Х				Х			P-101	Plumbing Floor Plan					Х			ARCHITECTURE
G-003	Accessibility Details					Х			P-102	Plumbing Drainage Location Plan					Х			615 Fishers Run Victor, NY 14564 585.742.2222 - www.apd.com
G-004	Accessibility Details					Х			P-201	Enlarged Plumbing Plans					Х			585./42.2222 - www.apa.com
G-005	Responsibility Schedule - Volume 2					Х			P-301	Isometric Diagrams					Х			Copyright © 2024 APD Engineering & Architecture
G-006	Responsibility Schedule - Appendix A			Х		Х			P-401	Plumbing Details					Х			615 Fishers Run Victor, NY 14564
G-007	Responsibility Schedule - Appendix B					Х			FP-101	Fire Protection Floor Plan					Х			Drawing Alteration It is a violation of law for any person, unless acting under the
									FP-201	Fire Protection Legend & Details								direction of licensed Architect, Professional Engineer, Landscape Architect, or Land Surveyor to alter any item on this document in any way. Any licensee who alters this document is required by law to affix his or her seal and to add the notation "Altered By" followed by his or
S-001	General Structural Notes (GSN)					Х	_											her signature and the specific description of the alteration or revision. DO NOT SCALE PLANS
S-101	Foundation Plan					Х			H-001	HVAC Schedules, Symbols & Notes	X				Х			Copying, Printing, Software and other processes required to produce these prints can stretch or shrink the actual paper or layout.
S-102	Slab Plan					,,	_		H-101	HVAC Floor Plan					X			Therefore, scaling of this drawing may be inaccurate. Contact APD E&A with any need for additional dimensions or clarifications.
	Roof Framing Plan					Х	_		05.101	Cita Linking Flanking at Dlaw								4
S-112	High Roof & Canopy Framing Plans					,,	-		SE-101	Site Lighting Electrical Plan					,,			_
S-301	Foundation Details					X	_		E-001	Electrical Material List & Notes	 		X	\ <u></u>	X			4
S-302	Foundation Details					X			E-101	Lighting Plan	X		X	Х	X			_
S-303	Foundation Details					X	+		E-102	Lighting Schedules & Diagrams			X		X			-
S-304 S-401	Foundation Details Steel Framing Sections & Details					X	-		E-201 E-301	Electrical Plan Enlarged Electrical Plans			X		<u>^</u>			-
S-401	Steel Framing Sections & Details					^	+		E-401	One-Line Diagram & Details			Λ Χ		<u>^</u>			Issued: Date:
S-403	Steel Framing Sections & Details								E-402	Electrical Panel Schedules			X		<u>х</u>			A Issued for Permit 07/08/24
S-404	Steel Framing Sections & Details					Х			E-501	Electrical Details			X		<u>х</u>			B Issued for Bid 07/29/25
S-405	Steel Framing Sections & Details						+		E-502	Electrical Details			X		X			D
S-406	Steel Framing Sections & Details					Х			2 002	Electrical Berails								- E
S-407	Steel Framing Sections & Details					Х	+		CLP-10	Fire Alarm Conduit Plan					X			Revisions: Date:
																		2 AHJ Responses 10/08/24
A-001	General Notes, Symbols, & Abbrev.					Х												3 Owner Changes 11/18/24
A-101	Floor Plan	X		Х		Х			- De	ferred Submittals								4 AHJ Responses 12/20/24 5 Owner Changes 07/29/25
A-102	Keyed Notes Plan			X		Х				Fire Suppression System Drawings								6
A-111	Reflected Ceiling Plan			Х		Х				Fire Alarm System Drawings								8
A-121	Roof Plan			Х		Х				Security System Drawings								9
A-131	Operations Plan			Х		Х												10
A-201	Exterior Elevations		Х		Х	Х			Rof	erence Drawings								12
A-202	Exterior Elevations		Х		Х	Х				erence Diawings								PROJECT ARCHITECT/ENGINEER
A-211	Interior Elevations					Х			R0.0	General Notes and Specifications								Daniel Sargent PROJECT LEAD
A-212	Interior Elevations					Х			R1.0	Fixture Floor Plan								John Lynch
A-213	Interior Elevations					Х			R2.0	Refrigeration Plumbing Floor Plan								
A-214	Interior Elevations					Х			R3.0	Refrigeration Mechanical Floor Plan								NOT FOR
A-215	Interior Elevations					Х			R3.1	Piping Floor Plan, Legend, Roof Detail								
A-216	Interior Elevations			X		Х			R4.0	Refrigeration Electrical Floor Plan								CONSTRUCTION
A-301	Wall Sections					Х			R4.1	EMS Ethernet Cabling								Seal Seal
A-302	Wall Sections					Х		_	R4.2	EMS RS485 Cabling								
A-303	Wall Sections					Х			R4.3	EMS Details								ALDINC.
A-304	Wall Sections					X	_		R4.4	EMS Details	-					_	-	1171 North State Road 7 Royal Palm Beach, FL 33411
A-305	Wall Sections					X			R5.0	Case and Box Evaporator Details	-					_	-	(561) 640-8000
A-306	Wall Sections				_	X	_		R6.0	Fluid Cooler & Pump Station Details						_		ALDI Inc. Store #: 50
A-307	Wall Sections			.,	_	X		_	R6.1	Pump Station Details	-					+	+	Coconut Crossing, FL 🔬
A-401	Enlarged Plans			X	_	X			R7.0	Refrigeration Piping Details	-						-	12850 Northlake Boulevard
	Enlarged Plans Exterior Details					X	_	-	R7.1	Refrigeration Piping Details	-					+	-	Palm Beach Gardens, FL 33412
	Exterior Details				_	X					<u> </u>					+	-	Palm Beach County
A-502 A-503	Exterior Details Exterior Details				_	X	+			+	-					+	+	Project Name & Location:
	Exterior Details					\ \ \ \ \ \											+	

Drawing Name: Prototype: Project No. V7.08 LHRD GROUND UP

Cover Sheet

Drawn By:

Scale:

22-0267A

G-001 Drawing No. As Noted

PROJECT INFORMATION:

THE BUILDING IS IN COMPLIANCE WITH THE:
FLORIDA BUILDING CODE 8TH EDITION (2023) BUILDING
FLORIDA BUILDING CODE 8TH EDITION (2023) ACCESSIBILITY
FLORIDA BUILDING CODE 8TH EDITION (2023) ENERGY CONSERVATION
FLORIDA BUILDING CODE 8TH EDITION (2023) MECHANICAL
FLORIDA BUILDING CODE 8TH EDITION (2023) PLUMBING
FLORIDA BUILDING CODE 8TH EDITION (2023) FUEL GAS
2020 NATIONAL ELECTRICAL CODE (NFPA 70)

FLORIDA FIRE PREVENTION CODE 8TH EDITION (2023)

NFPA 101, 2021 - WITH FLORIDA AMENDMENTS

NFPA 241, 2019

BUILDING PLANNING (CHAPTER 3,4,5,6)	:	
OCCUPANCY CLASSIFICATION (302.0 - 312.0)	MIXED OCCUPANO (ALLOWABLE)	CY GROUP M & S-2 (ACTUAL)
NUMBER OF STORIES (TABLE 504.4):	2	1
BUILDING HEIGHT (TABLE 504.3):	60'-0''	28'-10"
BUILDING AREA - \$1 (TABLE 506.2):	36,000	
FRONTAGE INCREASE (I_F) (506.3.3):	1,899	
MAXIMUM ALLOWABLE SQUARE FOOTAGE (A_{A}):	37,899	20,387

BUILDING AREA (506): STREET FRONTAGE INCREASE:

ROOF CONSTRUCTION:

BUILDING PERIMETER:

 BUILDING PERIMETER FRONTING ON A STREET OR UNOCCUPIED SPACE:
 INCREASE TO MAX. ALLOWABLE AREA (I_f):
 282'-5"

AREA INCREASE CALCULATOR												
	BASE AREA AREA INCREASE											
$\mathbf{A}_{\mathbb{A}}$	$\mathbf{A}_{ extsf{T}}$	(NS * I _F) / 100										
$\mathbf{A}_{\mathbb{A}}$	36,000	1,899										

TYPES OF CONSTRUCTION (CHAPTER 6) CONSTRUCTION CLASSIFICATION:

FIRE-RESISTANCE RATING REQUIREMENTS: (TABLE 601)	
PRIMARY STRUCTURAL FRAME:	0 HR
BEARING WALLS	

EXTERIOR: 0 HR.
INTERIOR: 0 HR.
NONBEARING WALLS AND PARTITIONS
EXTERIOR: 0 HR.
INTERIOR: 0 HR.
FLOOR CONSTRUCTION: 0 HR.

0 HR.

NOT REQUIRED

NOT REQUIRED

FIRE SEPARATION DISTANCE = X (feet) (TABLE 705.5) LESS THAN 5':

LESS THAN 5': 2 HR.
GREATER THAN OR EQUAL TO 5', LESS THAN 10': 1 HR.
GREATER THAN OR EQUAL TO 10', LESS THAN 30': 0 HR.
EQUAL TO OR GREATER THAN 30': 0 HR.

FIRE AND SMOKE PROTECTION FEATURES: (CHAPTER 7) FIRE-RESISTANCE RATING OF STRUCTURAL MEMBERS (704): EXTERIOR WALLS (705):

NOT REQUIRED NOT REQUIRED EXTERIOR WALLS (705): FIRE WALLS (706): NOT REQUIRED **NOT REQUIRED** FIRE BARRIERS (707): FIRE PARTITIONS (708): **NOT REQUIRED** SMOKE BARRIERS (709) NOT REQUIRED SMOKE PARTITIONS (710): NOT REQUIRED FLOOR AND ROOF ASSEMBLIES (711): **NOT REQUIRED** VERTICAL OPENINGS (712): NOT REQUIRED SHAFT ENCLOSURES (713): NOT REQUIRED PENETRATIONS (714): NOT REQUIRED JOINTS AND VOIDS (715): NOT REQUIRED OPENING PROTECTIVES (716): NOT REQUIRED DUCTS AND AIR TRANSFER OPENINGS (717): **NOT REQUIRED** CONCEALED SPACES (718): PROVIDED

INTERIOR FINISHES AND DECORATIVE MATERIALS (CHAPTER 8)

FIRE-RESISTANCE REQUIREMENTS FOR PLASTER (719):

THERMAL-AND SOUND-INSULATING MATERIALS (720):

	WALL AND C			MENTS									
BY OCCUPANCY (TABLE 803.11)													
		Sprinklerei)	NON	SPRINKLERE	5							
OCCUPANCY/ GROUP	INTERIOR EXIT STAIRWAYS AND RAMPS AND EXIT PASSAGEWAYS	CRRIDORS AND ENCLOSURE FOR EXIT ACCCESS STAIRWAYS AND RAMPS	ROMS AND ENCLOSED SPACES	INTERIOR EXIT STAIRWAYS AND RAMPS AND EXIT PASSAGEWAYS	CRRIDORS AND ENCLOSURE FOR EXIT ACCCESS STAIRWAYS AND RAMPS	ROMS AND ENCLOSED SPACES							
B, E, M, R-1	В	С	С	Α	В	С							
Ç				R	R								

FIRE PROTECTION SYSTEMS (CHAPTER 9) **AUTOMATIC SPRINKLER SYSTEMS (903):** (REQUIRED) YES (PROVIDED) YES STANDPIPE SYSTEM (905): (REQUIRED) NO (PROVIDED) NO PORTABLE FIRE EXTINGUISHERS (906): (REQUIRED) YES (PROVIDED) YES FIRE ALARM AND DETECTION SYSTEMS (907): (REQUIRED) NO (PROVIDED) YES EMERGENCY ALARM SYSTEMS (908): (REQUIRED) NO (PROVIDED) NO (REQUIRED) NO (PROVIDED) NO SMOKE CONTROL SYSTEMS (909): SMOKE AND HEAT REMOVAL(910): (REQUIRED) NO (PROVIDED) NO FIRE COMMAND CENTER (911): (REQUIRED) NO (PROVIDED) NO FIRE DEPARTMENT CONNECTIONS (912): (REQUIRED) YES (PROVIDED) YES

MEANS OF EGRESS (CHAPTER 10) OCCUPANT LOAD (1004):

OCCUPANCY LOADS	(FBC 1004.0 TABLE 1004	4.5 & NFPA 101 TABLE 7.3.	1.2)
OCCUPANCY USE	SQUARE FEET/ OCCUPANT	TOTAL OCCUPANCY SQUARE FOOTAGE	OCCUPANTS
MERCANTILE	30	12,935	432
BUSINESS	150	1,004	7
STORAGE / STOCK	300	4,553	16
TOTAL OCCUPANT LOAD			455

MEANS OF EGRESS SIZING (1005):

	(A)	(1	3)	EXIT WIDTH (IN.)*						
USE GROUP OR SPACE	NT	EGRESS	WIDTH		ED WIDTH	ACTUAL WIDTH				
DESCRIPTION		PER OC	CUPANT	•	ON 1005)	SHOW	N ON			
DESCRIPTION	OCCUP LOAD BY	(SECTION	v 1005.3)	(A	(X B)	PLANS				
	000	STAIR	LEVEL	STAIR	LEVEL	STAIR	LEVEL			
MERCANTILE	432	0.3	0.2	129.6	86.4	.==				
BUSINESS	7	0.3	0.2	2.1	1.4	SEE G-002 EGRESS PLAN FOR ACTUAL WIDTHS				
STORAGE	16	0.3	0.2	4.8	3.2					
TOTAL:	455	0.3	0.2	136.5	91.0	1, (3, 6, 12, 11)				

* Where more than one exit, or access to more than one exit, is required, the means of egress shall be configured such that the loss of one exit or access to one exit shall not reduce the available capacity to less than 50 percent of the total required capacity (Section 1005.5)

NUMBER OF EXITS AND EXIT ACCESS DOORWAYS (1006):
COMMON PATH OF EGRESS TRAVEL (TABLE 1006.2.1):

ACCESSIBLE MEANS OF EGRESS (1009) & FBC ACCESSIBILITY CODE: DOOR WIDTH (1010.1.1):

MINIMUM CLEAR OPENING:

MAXIMUM DOOR LEAF:
PANIC AND FIRE EXIT HARDWARE (1010.2.9):

EXIT SIGNS (1013.1):
HANDRAILS (1014.2):

GUARDS (1015.3):

MAXIMUM TRAVEL DISTANCE TO AN EXIT (TABLE 1017.2):

MINIMUM CORRIDOR WIDTH (1020.3):

MAXIMUM DEAD END CORRIDOR DISTANCE (1020.5):

ACCESSIBILITY (FBC-A CHAPTERS 2 & 9)

CHECK-OUT AISLES (TABLE 227.2 & 904):

EMPLOYEE MANNED: (REQUIRED) 1 (PROVIDED) 4 SELF CHECKOUT (SCO): (REQUIRED) 2 (PROVIDED) 6

42" H. IF ADJACENT GRADE IS GREATER THAN 30"

44" / 60" FOR H.C. TURN AROUND (AT 200' INTERVALS)

50' (SPRINKLERED) WHEN MORE THAN ONE EXIT IS REQUIRED

250' MERCANTILE 400' STORAGE (SRPINKLERED)

(REQUIRED) 3 (PROVIDED) 4

34" H. MIN., 38" H. MAX.

75' MERCANTILE 100' STORAGE

(REQUIRED) YES (PROVIDED) YES

(REQUIRED) NO (PROVIDED) YES

(REQUIRED) YES (PROVIDED) YES

PLUMBING FIXTURE REQUIREMENTS:

MINIMUM NO. OF REQUIRED PLUMBING FIXTURES (FBCPC TABLE 2902.1)												
OCCUPANCY/	1	CLOSETS NALS)	LAVA	TORIES	TUBS/ WERS	KING	ОТНЕК					
GROUP	MALE	FEMALE	MALE	FEMALE	BATH' SHO\	DRIN FOUN	IO					
MERCANTILE (REQUIRED)	1 PEI	R 500	1 PEF	R 750		1 PER 1,000	1 SERVICE SINK					
MERCANTILE (PROVIDED)	1+1	1+1	1	1		2	1 SERVICE SINK					

AREA SUMMARY (FOR REFERENCE ONLY)


	COCONUT CROSSING, FL ARE	
OCCUPANCY USE	ROOM NAME	SQUARE FOOTAGE
MERCANTILE (M)	SALES / VESTIBULE	12,623
	UNISEX 2	96
	UNISEX 1	96
	HALL	120
SUBTOTAL (MERCANTILE)		12,935
BUSINESS (B)	OFFICE	258
	BREAK ROOM	309
	eCOMMERCE	401
	CLOSET	36
SUBTOTAL (BUSINESS)		1004
STORAGE / STOCK (S-2)	BACKROOM	2,568
	COOLER	1,338
	FREEZER	647
SUBTOTAL (STORAGE / STO	CK)	4,553
SUBTOTAL (OCCUPANCIES)	18,492
EXTERIOR /INTERIOR WALLS	S / UNOCCUPIED SPACE	908
BUILDING SQUARE FOOTA	GE	19,400
EXTERIOR CANOPY		987
TOTAL SQUARE FOOTAGE	(INCLUDING CANOPY)	20,387

NOTE:
THIS FACILITY DOES NOT CONTAIN A BAKERY, A BUTCHER, A
DELI, OR A FISH COUNTER. ALL FOOD IS PREPACKAGED
AND THERE IS NO ON-SITE FOOD PREPARATION.

NOTE:
A RADIO SIGNAL STRENGTH SURVEY IS TO BE PROVIDED PRIOR TO FINAL TO VERIFY MINIMUM EMERGENCY RESPONDER RADIO COVERAGE HAS BEEN MET. IF A BDA SYSTEM IS DEEMED TO BE NEEDED, A SEPARATE PERMIT IS REQUIRED FOR THE INSTALLATION.

NOTE:
SEPARATE PERMITS ARE REQUIRED FOR FIRE ALARM, FIRE
SPRINKLER, AND ACCESS CONTROL/CARD READER SYSTEMS.

NOTE:
A TRUSS PLACARD WILL BE PROVIDED IN ACCORDANCE
WITH FLORIDA STATUE 633.01 (1).

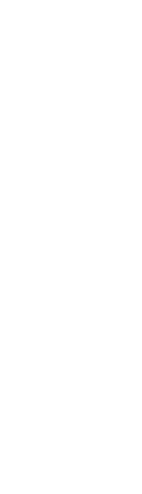

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ENGINEERING

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APD Engineering & Architecture
615 Fishers Run
Victor, NY 14564

Drawing Alteration

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	Issued:	Date:
	Issued for Permit	07/08/24
	Issued for Bid	07/29/25
)		
	Revisions:	Date:
	AHJ Responses	10/02/24
	Owner Changes	11/18/24
	Owner Changes	07/29/25

12 PROJECT ARCHITECT/ENGINEER

Daniel Sargent

PROJECT LEAD

John Lynch



ALDI | Seal

| Seal
| Seal
| Seal
| Seal
| Seal
| Seal
| Seal
| Seal

ALDI Inc. Store #: 50 Coconut Crossing, FL 12850 Northlake Boulevard

(561) 640-8000

Palm Beach Gardens, FL 33412
Palm Beach County

Project Name & Location:

Code Review

Drawing Name:
Prototype:


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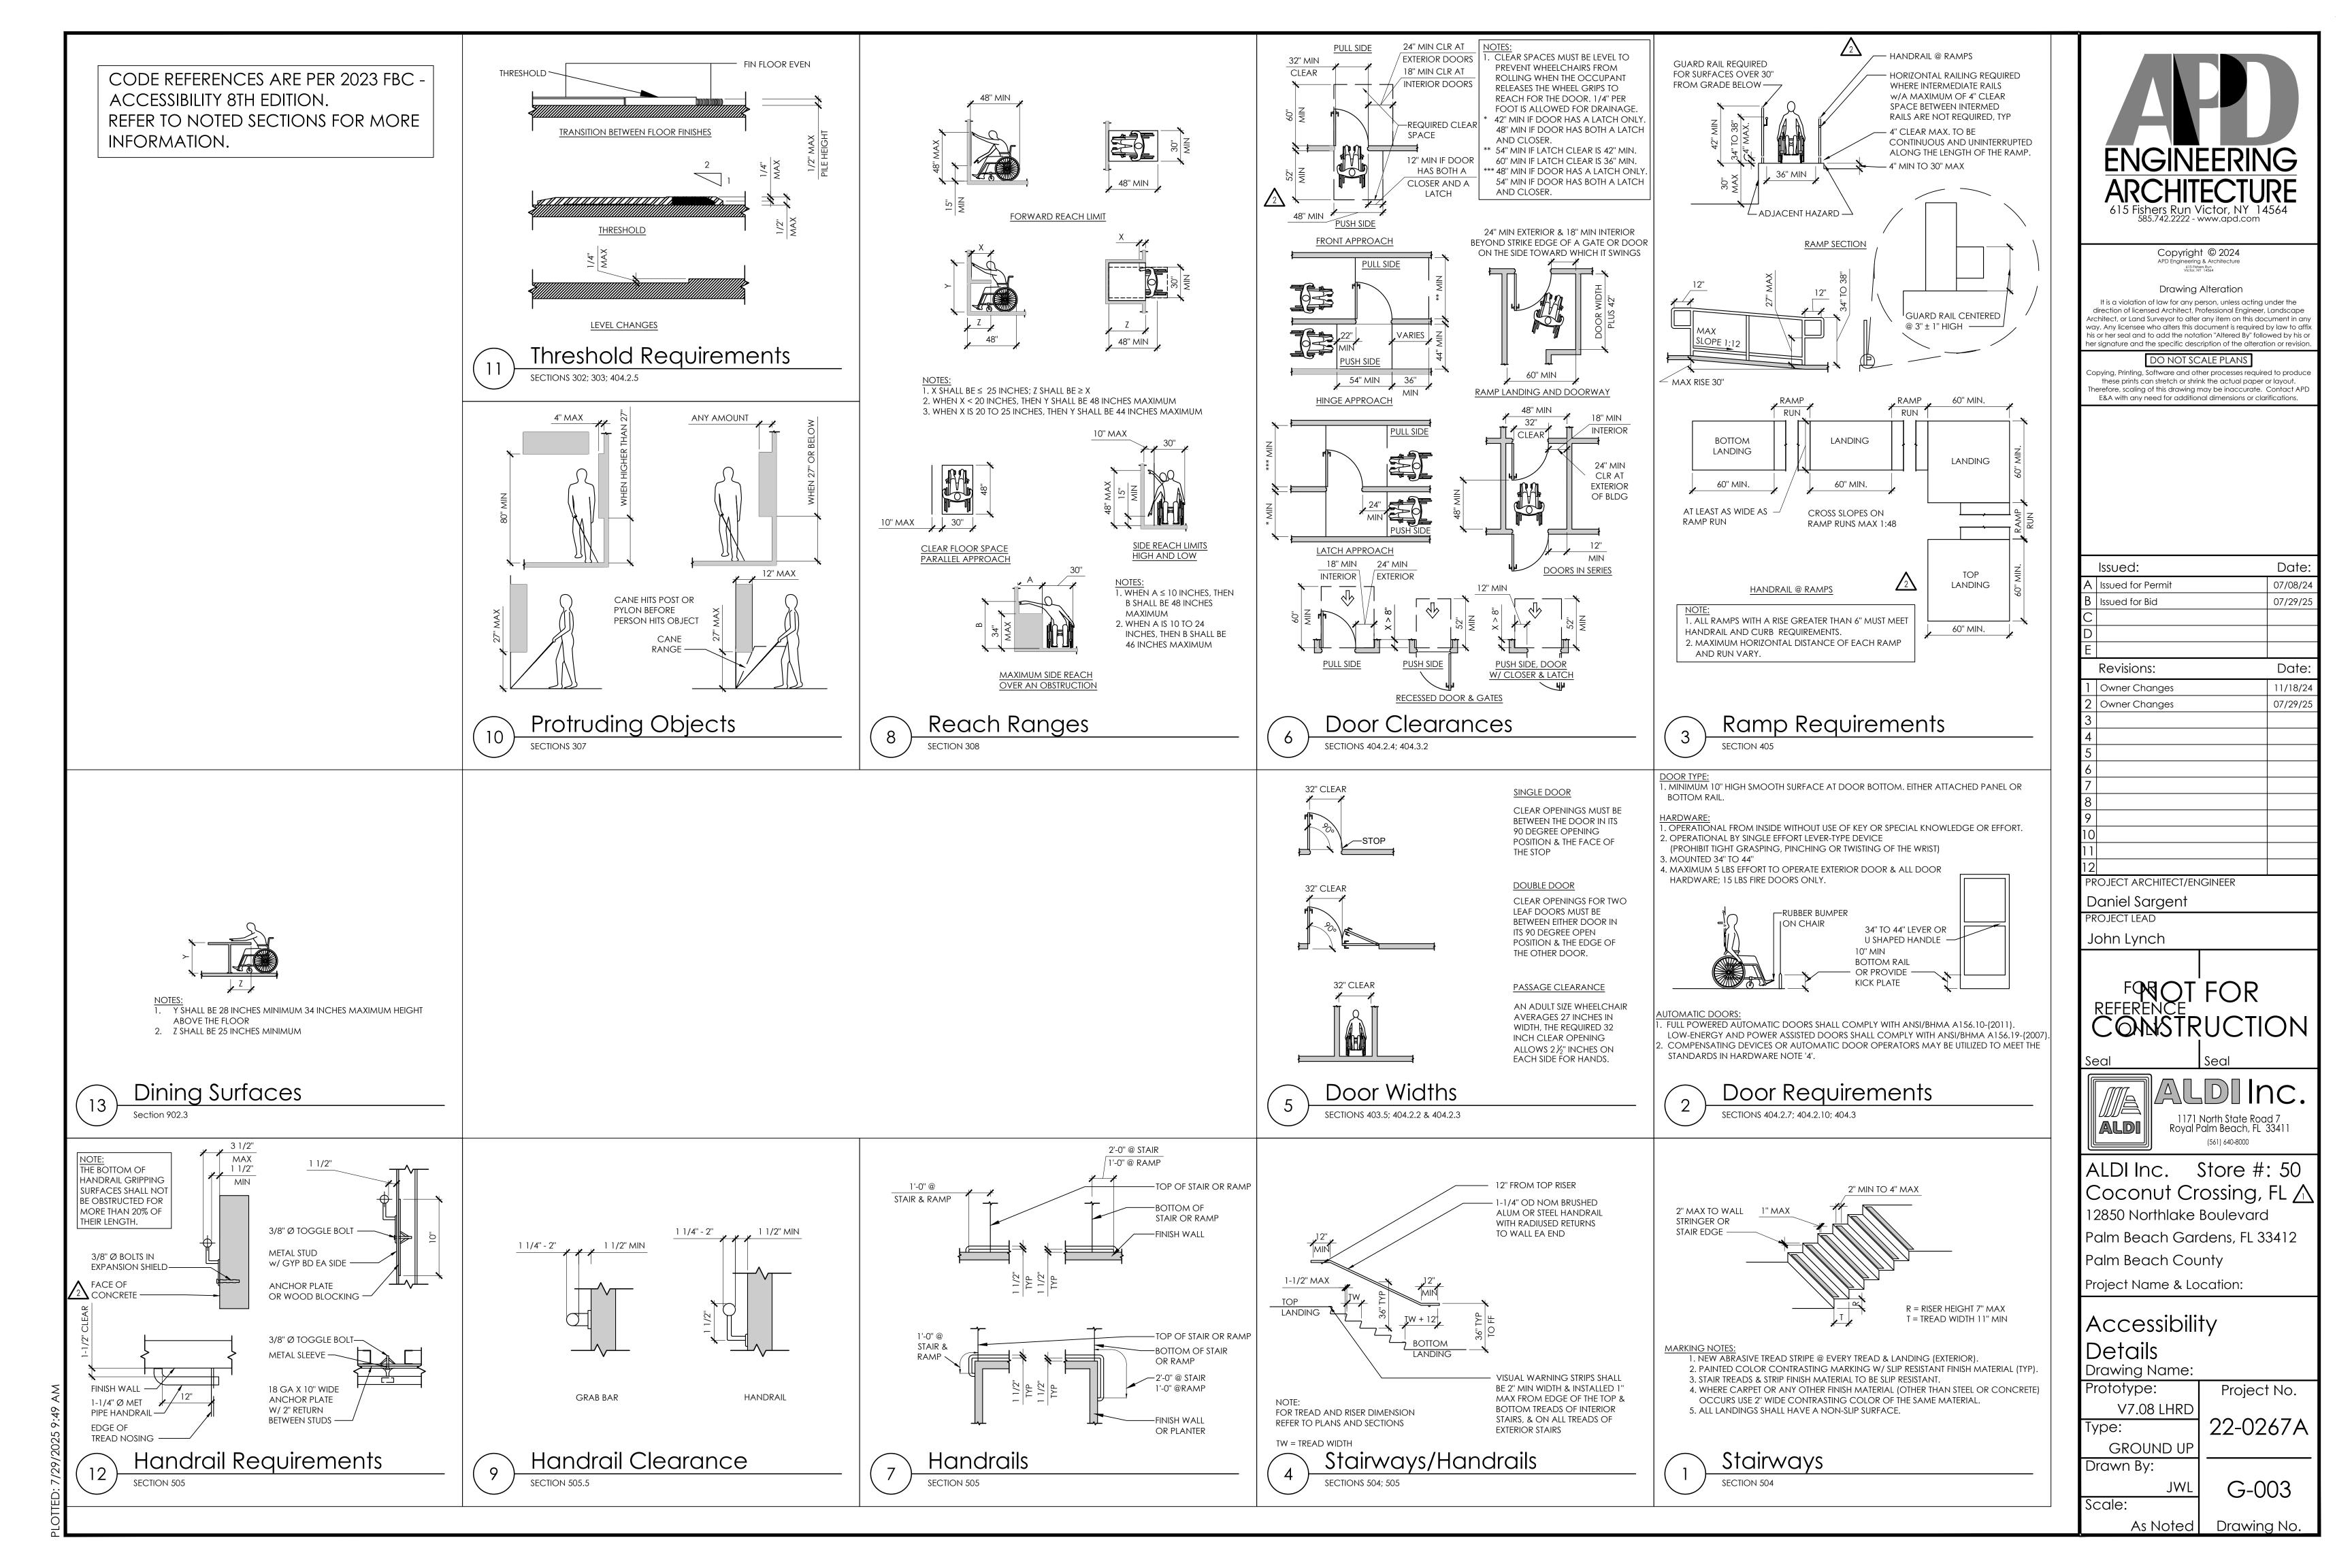
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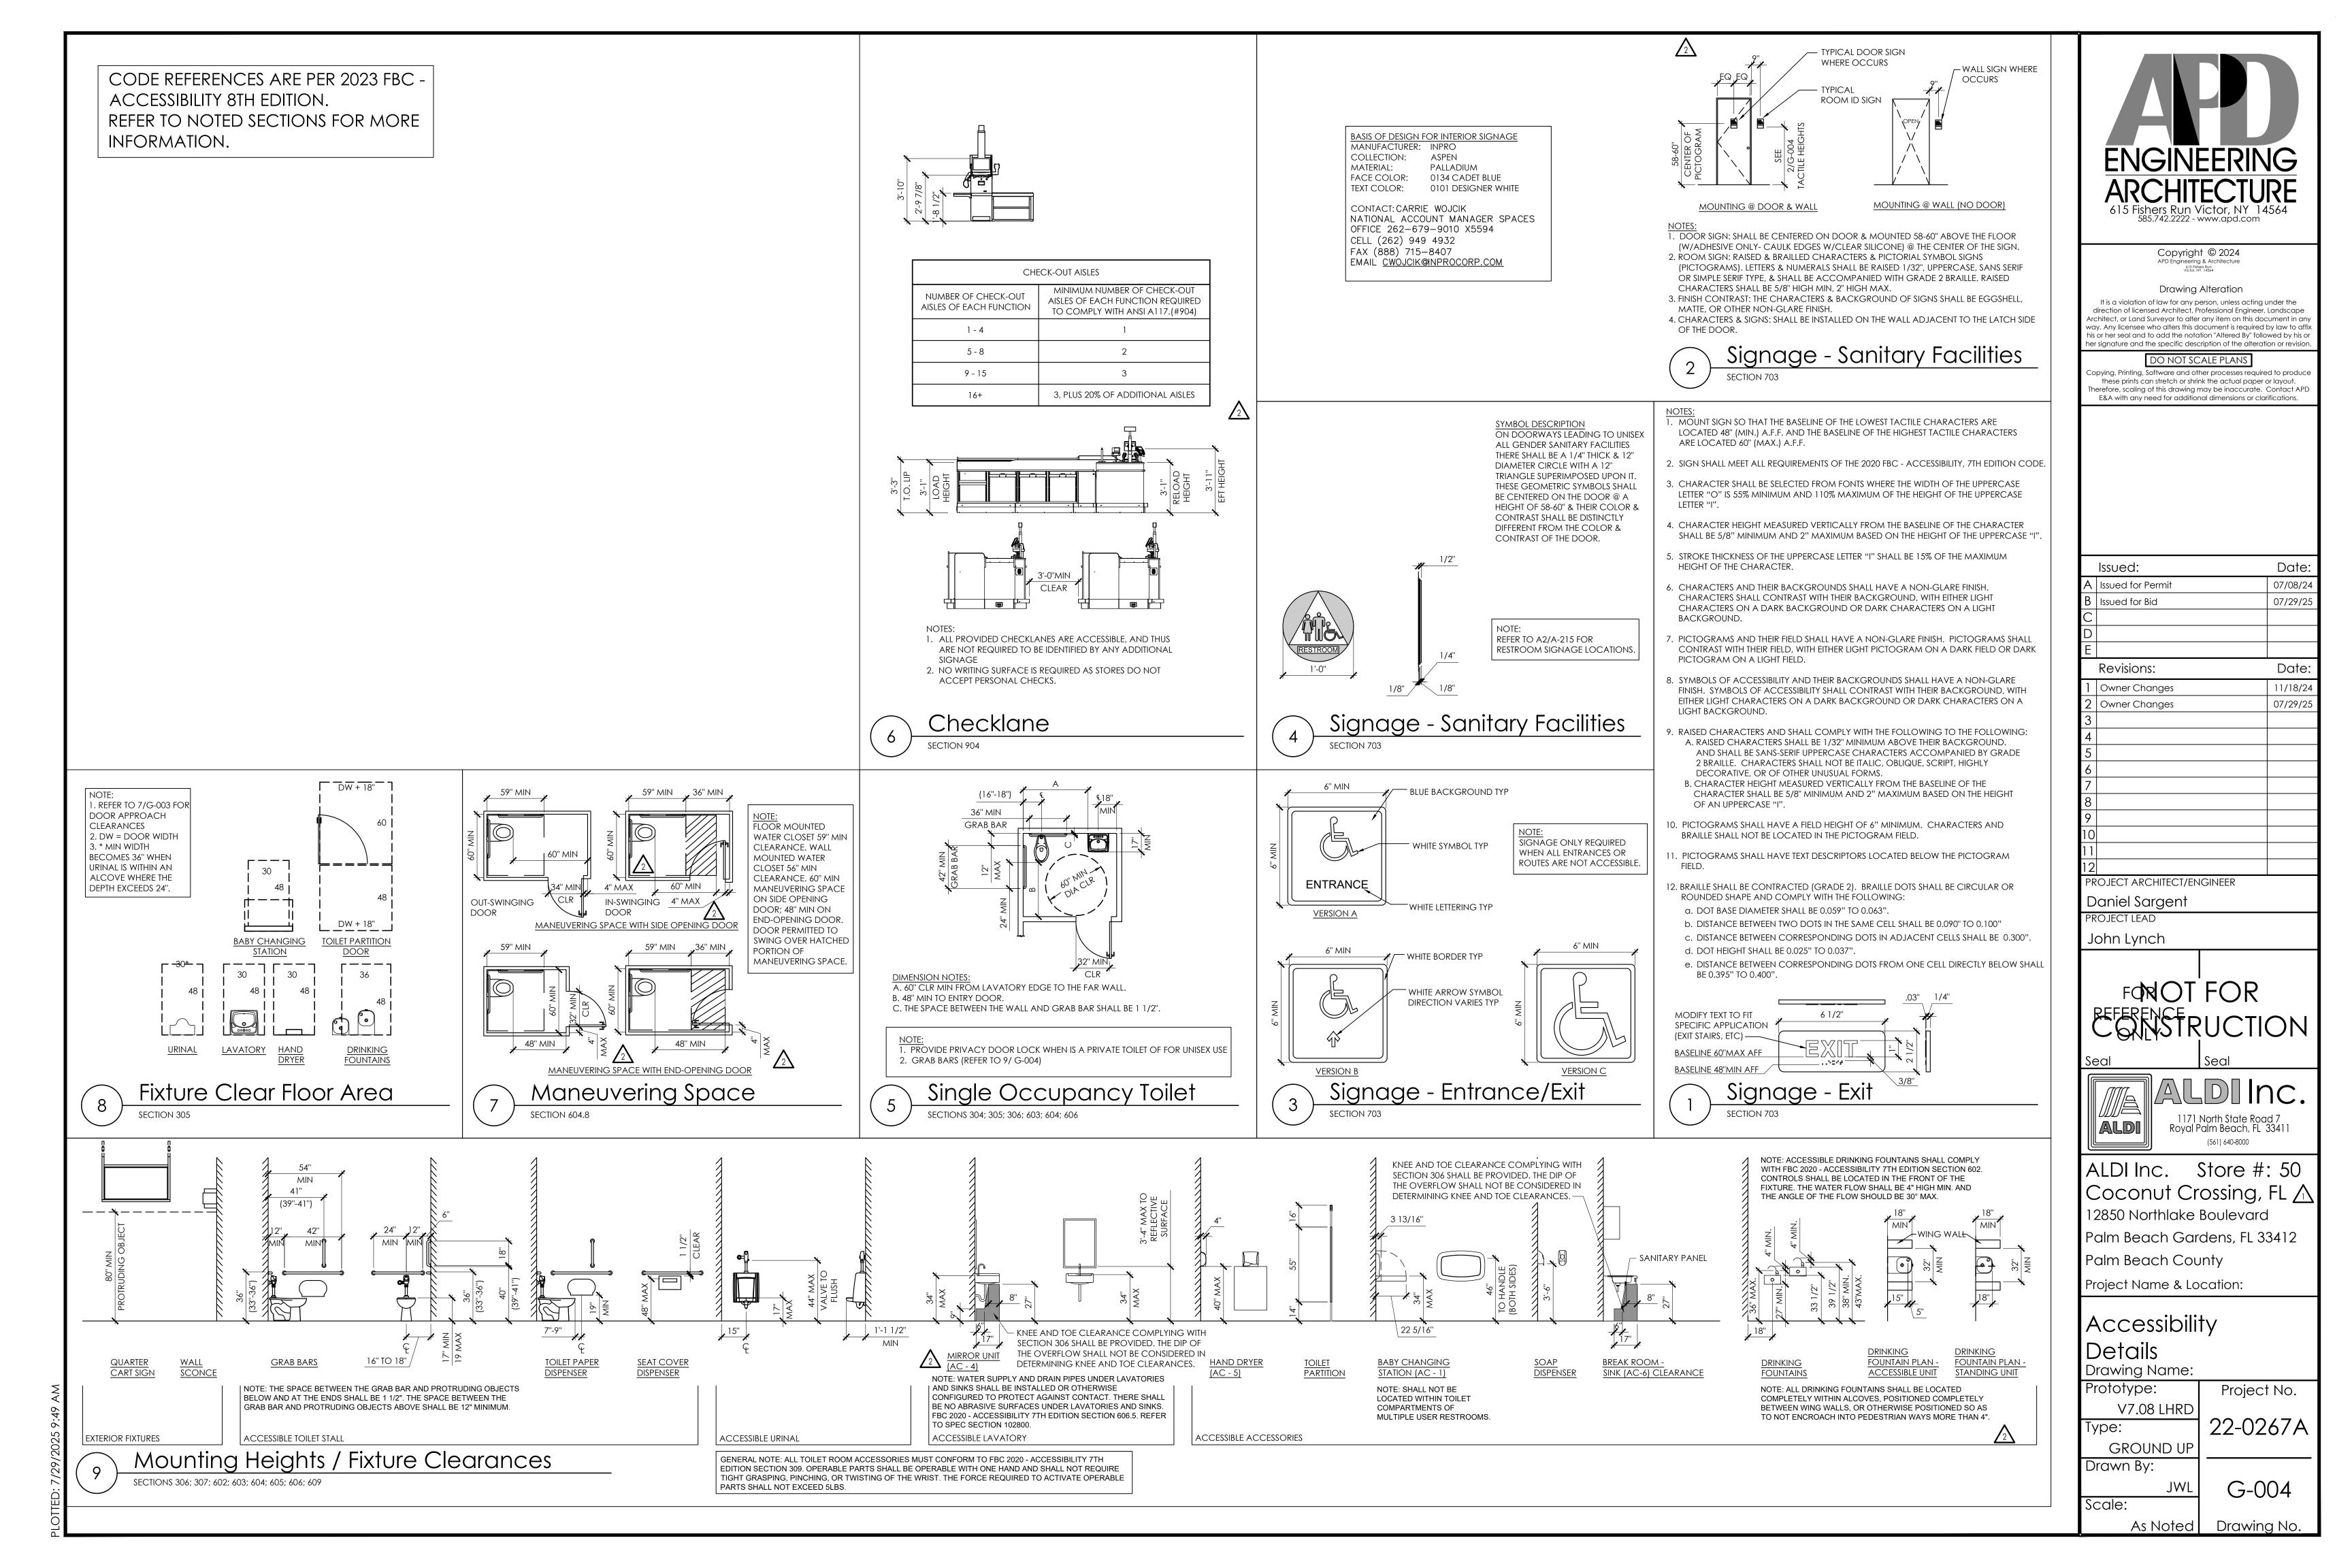
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JWL
Scale:

JWL G-002

As Noted Drawing No.





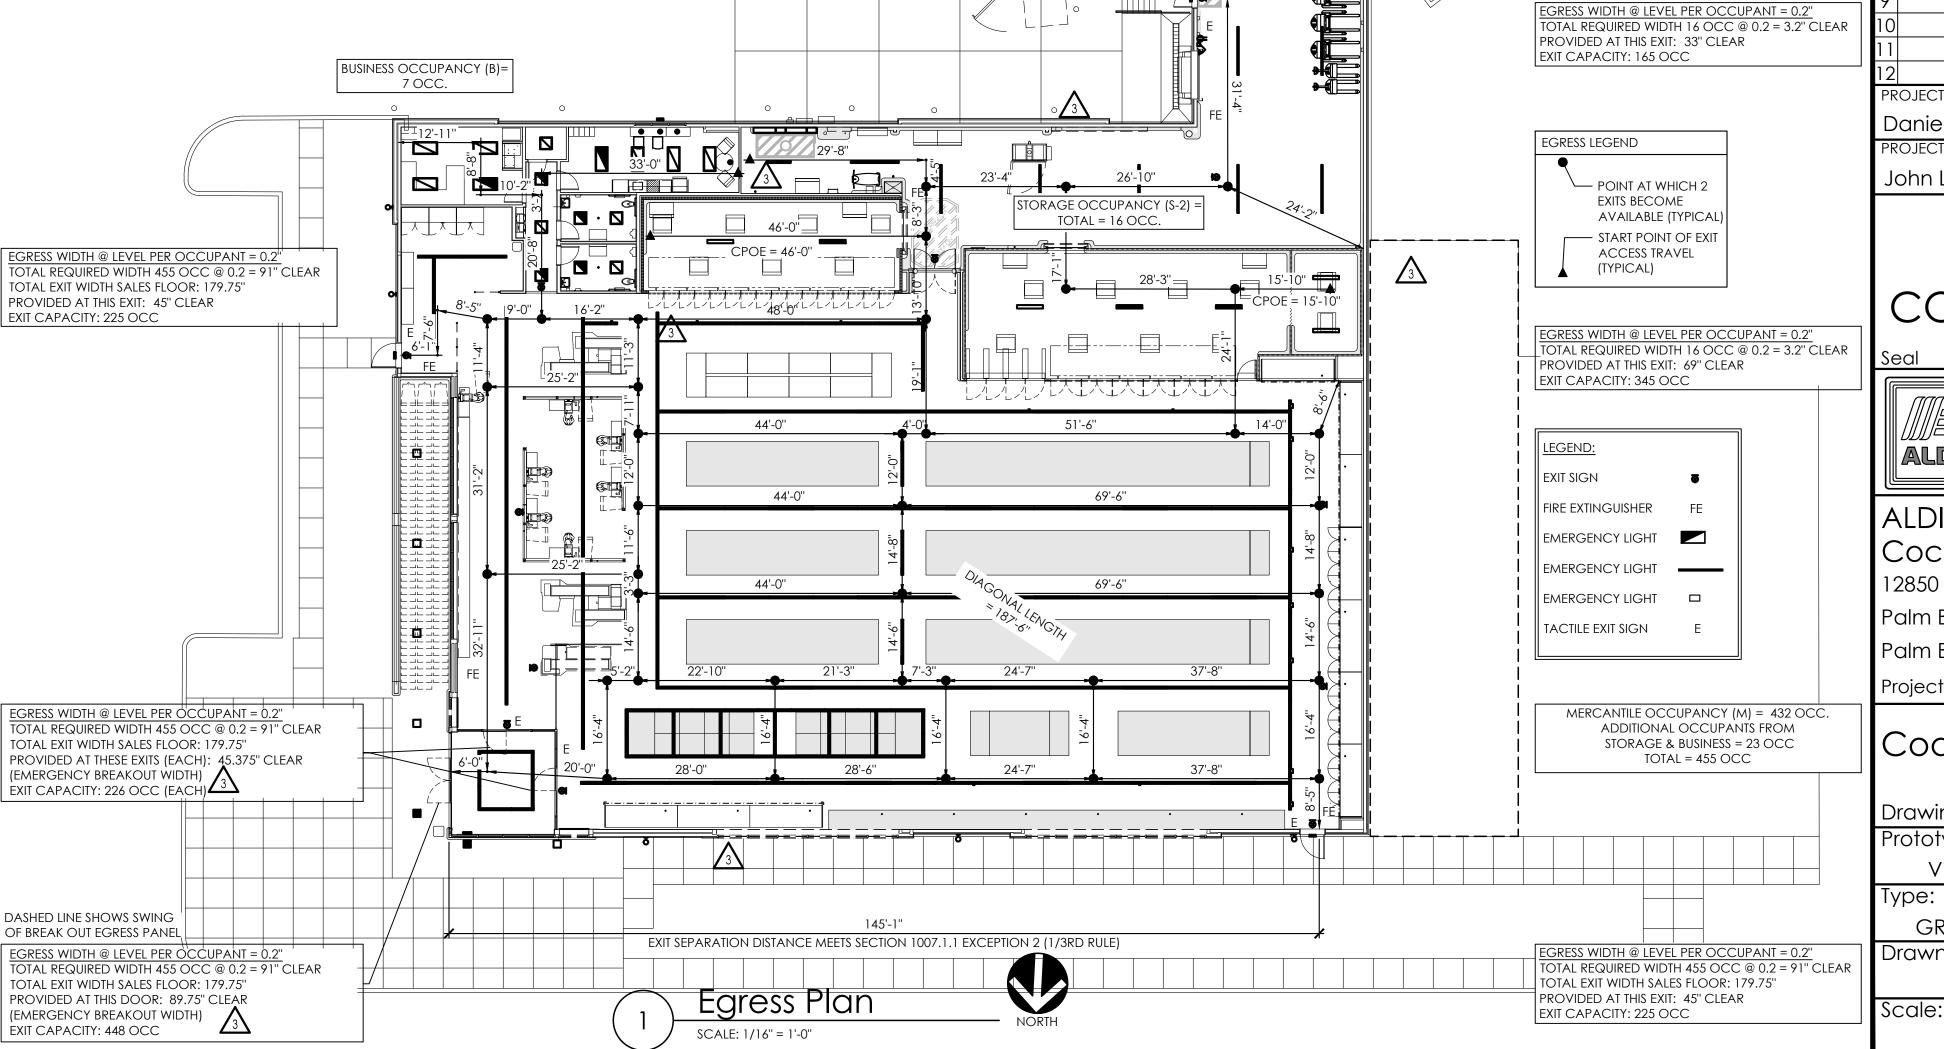

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ANY MACH CONCISE 148 18		REGUIREMENTS]									WITH COMMISSIONING AND FINAL FUNCTIONAL TESTING.
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MINISTRATION MINI	047300							X	Х					CULTURED STONE: BORAL
MINISTRATION MINI														
MANORISO ALUMINIAM MEDI-RECORDE MEDI-RECORD	DIVISION 0	5 - METALS												
REPUTY DOOR PROJECTORS	055000	METAL FABRICATIONS												
MECHICAL PRINCE No.								х	х					TARPENING - LAFOLLETTE CO
CARDAN SET 1.0			Х					X	х					MCCUE CORPORATION
RE ROOM MOINTING RE ROOM RE ROOM MOINTING RE ROOM RE			Х					X	х					MCCUE CORPORATION
Sec. SIGOR MOUNTED No. N		BR: FLOOR MOUNTED	х					Х	Х					MCCUE CORPORATION
NOT ACCESS LADDER		BR-C: FLOOR MOUNTED	х					х	х					MCCUE CORPORATION
SISSE STANLINGS STEED SIMPLY SERVICES OF A SQUIRED FOR LADDES OVER 20 HIGH POR OSHA REQUIREMENTS SIMPLY SHAPE BALL COLUMN COVERS COLUMN CO						 		x	х					
BUMBER BAIL														CAGE IS REQUIRED FOR LADDERS OVER 20' HIGH PER OSHA REQUIREMENTS
DIVISION DI - WOCD, PLASTICS, AND COMPOSITES SEE PROJECT MANUAL FOR LIST OF APPROVED MANUFACTURESS	0.57000	BUMPER RAIL						X	X					TARPENING - LAFOLLETTE CO
DIVISION 80 - WOOD, FLATICS, AND COMPOSITES	057000				1									TARRENING LAFOLIETTE CO
DAMA- PROPERTY DATE DA		COLUMN COVERS							^					TARPENING - LAPOLLETTE CO
DAMA- PROPERTY DATE DA														
DIVISION 07 - THERMAL AND MOISTURE PROTECTION 072100 THERMAL INSULATION	DIVISION 0	6 - WOOD, PLASTICS, AND CO	MPOSITES		11						ì		ı	
Transmission Thermal insulation	066400	PLASTIC PANELING						Х	Х					SEE PROJECT MANUAL FOR LIST OF APPROVED MANUFACTURERS
Transmission Thermal insulation														
Dearling Thermal insulation	DIVISION 0	7 - THERMAL AND MOISTURE P	ROTECTIO	N										
POLYTRETHANS SPRAY FOAM INSULATION ICTORNE INC. OR DEMILEC INC. POLYTRETHANS SPRAY FOAM INSULATION ICTORNE INC. OR DEMILEC INC. POLYTRETHANS SPRAY FOAM INSULATION ICTORNE INC. OR DEMILEC INC. POLYTRETHANS SPRAY FOAM INSULATION ICTORNE INC. OR DEMILEC INC. POLYTRETHANS SPRAY FOAM INSULATION ICTORNE INC. OR DEMILEC INC. POLYTRETHANS SPRAY FOAM INSULATION ICTORNE INC. OR DEMILEC INC. POLYTRETHANS SPRAY FOAM INSULATION ICTORNE INC. POLYTRETHAN INC. POLYTRETHAN INC. POLYTRETHAN INC. POLYTRE SPRAY JURING INC. POLYTRETHAN INC. POLYTRE SPRAY JURING INC. POLYTRETHAN INC. POLYTRE SPRAY JURI PRESEN ALUMINING COPPORATION INC. POLYTRETHAN INC. POLYT	072100	THERMAL INSULATION				l		x	x					
Maria Sufficient Maria Price Maria Pri					-									POLYURETHANE SPRAY FOAM INSULATION: ICYNENE INC. OR DEMILEC INC.
074444 FIBER CEMENT WALL PANELS X														THIS ITEM MAY BE PROVIDED BY OWNER - COORDINATE ROOFING SCOPE OF WORK WITH OWNER
OF 201 SHEET METAL FLASHING AND TRIM														
ALDI GC ROOFING NSTRUCTIONS								X	_ x					FIDER CEMENT WALL PANELS: NICHIHA USA INC.
DIVISION OF - FINISHES			IKIM											
DIVISION 08 - OPENINGS	079999							X	X	X				WHEN APPLICABLE, PHOTOVOLTAIC SYSTEM WILL BE PROVIDED BY ALDI VENDOR. GC IS TO COORDINATE
DIVISION 08 - OPENINGS 083613	DRAWING	PIPE BOOT CURB						Х	х					PATE COMPANY, THE OR ROOF PRODUCTS AND SYSTEMS (RPS)
083613 SECTIONAL OH DOORS	DRAWING	UNIT CURB						X	Х					PATE COMPANY, THE OR ROOF PRODUCTS AND SYSTEMS (RPS)
083613 SECTIONAL OH DOORS														
083800 MPACT TRAFFIC DOORS	DIVISION 0	8 - OPENINGS												
OBBOOD GLAZING	083613	SECTIONAL OH DOORS						х	х					
DIVISION 09 - FINISHES	083800	IMPACT TRAFFIC DOORS	х					х	х					CHASE DOORS (SENNECA HOLDINGS)
DIVISION 09 - FINISHES 093000 TILING GLAZED OR PORCELAIN X X X X CERAMIC TILE: DALTILE / AMERICAN OLEAN 095113 ACOUSTICAL PANEL CEILINGS ACOUSTICAL PANEL X X X X ARMSTRONG WORLD INDUSTRIES, INC. 096513 RESILIENT BASE AND ACCESSORIES VB-1: VINYL BASE X X X X X X ROPPE CORPORATION 099100 PAINTING X X X X X X X PAINT: SHERWIN-WILLIAMS DRAWWING WB-1: WOOD PANELS	088000	GLAZING						Х	х					
093000 TILING			JI.	1	JI	1	<u>ı </u>	<u> </u>	L		1	1	1	, contract to the contract to
093000 TILING	DIVISION O	9 - FINISHES												
GLAZED OR PORCELAIN X														
095113 ACOUSTICAL PANEL CEILINGS ACOUSTICAL PANEL CEILING SYSTEM X X X	3,000		Х					×	x					CERAMIC TILE: DALTILE / AMERICAN OLEAN
ACOUSTICAL PANEL CEILING SYSTEM X X X X ARMSTRONG WORLD INDUSTRIES, INC. 096513 RESILIENT BASE AND ACCESSORIES VB-1: VINYL BASE X X X ROPPE CORPORATION 099100 PAINTING X X X X PAINT: SHERWIN-WILLIAMS DRAWING WB 1: WOOD PANELS X X X X ARMSTRONG WORLD INDUSTRIES, INC.	095112			L	JL	<u> </u>	<u> </u>			-	_ 		<u> </u>	Samuel Communication of the Co
096513 RESILIENT BASE AND ACCESSORIES VB-1: VINYL BASE X X X X X X X X X X X X X X	3,3113	ACOUSTICAL PANEL				T		×	x					ARMSTRONG WORLD INDUSTRIES, INC.
VB-1: VINYL BASE X X ROPPE CORPORATION 099100 PAINTING X X X PAINT: SHERWIN-WILLIAMS DRAWING WP. 1: WOOD PANELS X X X ARCHSYSTEMS OR HARDWARE BARGAINS	096513				JL	<u> </u>	1		<u> </u>			<u> </u>		<u> </u>
099100 PAINTING X X X PAINT: SHERWIN-WILLIAMS DRAWING WR 1: WOOD PANELS X X X X ARCHSYSTEMS OR HARDWARE BARGAINS								x	х					ROPPE CORPORATION
DRAWING WR 1: WOOD PANELS Y A RCHSYSTEMS OR HARDWARE BARGAINS	099100													
														ARCHSYSTEMS OR HARDWARE BARGAINS

		NATIONAL ACCOUNT PRICING	EXISTING		ALDI	l 	GENERAL CONTRACTOR			LA	ND L	ORD	
SPEC SECTION	ELEMENT			FURNISHED	INSTALLED	COORDINATE	FURNISHED	INSTALLED	COORDINATE	FURNISHED	INSTALLED	COORDINATE	REMARKS
DIVISION 1	0 - SPECIALTIES												
101400	SIGNAGE												
	HANDICAPPED PARKING						х	Х					
	REST ROOM & ENTRY EXIT						Х	Х					INPRO - CONTACT: JOHN KAISER, JKAISER@INPROCORP.COM, 800-222-5556 X.5468 RE: G-004
102600	WALL, DOOR AND EQUIPMEN	IT PROTEC	CTION		_						_		
	GUIDANCE RAILING	Х					х	Х					MCCUE CORPORATION
	EQUIPMENT GUARDRAIL	Х					Х	Х					MCCUE CORPORATION
102800	TOILET, BATH AND LAUNDRY	ACCESSO	ORIES										
	AC-1: BABY CHANGING STATION	Х					Х	Х					KOALA KARE PRODUCTS
	AC-2: PAPER TOWEL DISPENSER						х	х					SIMPLEHUMAN
	AC-3: GRAB BAR						Х	Х					BOBRICK WASHROOM EQUIPMENT, INC. OR BRADLEY CORPORATION
	AC-4: MIRROR UNIT						Х	Х					BOBRICK WASHROOM EQUIPMENT, INC. OR BRADLEY CORPORATION
	AC-5: HAND DRYER AND WALL GUARD	х					х	х					EXCEL DRYER INC.
	AC-6: UNDERLAVATORY GUARD						Х	Х					PLUMBEREX SPECIALTY PRODUCTS, INC. OR IPS CORPORATION
102813	MISCELLANEOUS ACCESSOR	IES		JI	1		JI	•	ı	JI		<u> </u>	
	DISPLAY MOUNTING RAIL	l	1		T		x	x			T	T	ADVANTUS GRIP-A-STRIP. LOCATED IN BREAK ROOM. COORDINATE FINAL LOCATION WITH ALDI
		ļ	<u> </u>	<u> </u>						- <u>-</u> -		 - -	CONSTRUCTION REPRESENTATIVE SEE PROJECT MANUAL FOR LIST OF APPROVED MANUFACTURERS
104416	FIRE EXTINGUISHERS						X	X	Х				MOUNT IN COMPLIANCE WITH REQUIREMENTS OF AUTHORITY HAVING JURISDICTION MOUNT IN COMPLIANCE WITH REQUIREMENTS OF AUTHORITY HAVING JURISDICTION
DRAWING	KNOX BOX						X	X	Х				RE: A-201
DIVISION 1	1 - EQUIPMENT												
111300	LOADING DOCK EQUIPMENT												
	DOCK LEVELER AND	l	1		T		x	х			Τ	T	SEE PROJECT MANUAL FOR LIST OF APPROVED MANUFACTURERS
	CONTROLS				+								MARVEL EQUIPMENT COMPANY (MEC)
	DOCK SEAL DOCK TRACK GUARD			 			X	X					DURAFLEX
]		J]	1		J	1		JI
DIVISION 1:	2 - FURNISHINGS												
124840	FLOOR MATS AND FRAMES	Х					х	Х			T	T	CONSTRUCTION SPECIALTIES
DRAWING	TR-1: TRASH RECEPTACLE						х	х					DAWN ENTERPRISES RE: A-603
	,	J (J (-1				J!			
DIVISION 2	1 - FIRE SUPPRESSION												
210500	COMMON WORK RESULTS FOR FIRE SUPPRESSION						Х	Х			T	T	A CRITERIA DRAWING IS PART OF DRAWING SET. ENGINEERED FIRE SUPPRESSION DRAWINGS TO BE PROVIDED BY GC AND SUBCONTRACTOR AND SUBMITTED TO AHJ FOR REVIEW AND APPROVAL.
	TOR TIRE SOLT RESSION	JL		<u> </u>	<u> </u>		JL		<u>I</u>	<u> </u>	1		TROVIDED BY GC AND SUBCONTRACTOR AND SUBMITTED TO ANS TOR REVIEW AND ATTROVAL.
DIVISION 2	2 - PLUMBING												
220500	COMMON WORK RESULTS	l		T	T	T	х	Х			T	T	
220300	FOR PLUMBING					1		_ ^					
DIVIGION O	A LIFATING VENTUATING AN		ONDITI	ONUN.									
	3 - HEATING, VENTILATING, AN COMMON WORK RESULTS				_ T			V			1		
230500	FOR HVAC				(DTIL 1)	, 	Х	Х					
237414	PACKAGED, OUTDOOR, DEHU		1		Τ	- 	1				1		AES INDUSTRIES, INC.
	RTU-1 ROOF CURB						X	Х	Х				REFER TO G-006 FOR RTU-1 UNIT, TEMPERATURE AND HUMIDITY SENSOR SCOPE
238126	SPLIT-SYSTEM AIR-CONDITION	NERS	7	1	T	1	1		I	1	1	1	٦
	UNIT CONDENSATE DRAIN REFRIGERATION						X	X					
DRAWING	CONDENSER SUPPORT CURB						Х	Х					AES INDUSTRIES, INC.
DIVISION 2	6 - ELECTRICAL	1		1			1		,	1		_	
260500	COMMON WORK RESULTS FOR ELECTRICAL						Х	Х					SEE PROJECT MANUAL FOR LIST OF APPROVED MANUFACTURERS
265100	INTERIOR LIGHTING												
	FSG LIGHTING PACKAGE	Х					х	Х					FSG LIGHTING
265600	EXTERIOR LIGHTING			J	1		· I	•		J	'		41
	FSG LIGHTING PACKAGE	Х					х	х					FSG LIGHTING
	IO (EATON) UP LIGHTING	х					х	Х					IO (EATON) LIGHTING
DRAWING	CHIME						Х	Х					
DRAWING	POWERPOLE - GONDOLA AND SPOT MERCHANDISER						х	Х					
	AND SECT WERCHANDISEK	JL		JL	1		JL	1	[JL	1		JI.
DIVIDENCE	7												
	7 - COMMUNICATIONS	1	7	1	Τ		1 -	_	_	1	Τ	T	GC TO PROVIDE ROOF MAST ASSEMBLY, BALLAST, AND CONDUIT THROUGH ROOF.
DKAWING	ROOF MAST						Х	Х	X				REFER TO G-007 'DIVISION 27 - COMMUNICATIONS_ROOF MAST - ANTENNA' FOR ANTENNA SCOPE

RESPONSIBILITY SCHEDULE



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APD Engineering & Architecture

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Victor, NY 14564

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В	Issued for Bid	07/29/2
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	Revisions:	Date
1	Owner Changes	11/18/2
2	Owner Changes	07/29/2
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PR	OJECT ARCHITECT/ENGINEER	
D	aniel Sargent	
PR	OJECT LEAD	

NOT FOR CONSTRUCTION

John Lynch

1171 North State Road 7 Royal Palm Beach, FL 33411

ALDI Inc. Store #: 50
Coconut Crossing, FL 12850 Northlake Boulevard

Palm Beach Gardens, FL 33412 Palm Beach County

Project Name & Location:

Responsibility
Schedule - Volume 2
Drawing Name:
Prototype: Project No.

V7.08 LHRD 22-0267A

GROUND UP

Drawn By:

JW
Scale:

JWL G-005
:
As Noted Drawing No.

NOTE:

THE RESPONSIBILITY SCHEDULE IS MEANT TO PROVIDE AN OVERVIEW OF OWNER FURNISHED AND OWNER PROVIDED ITEMS. THIS IS NOT MEANT TO REPLACE THE GC OBLIGATIONS WITHIN THE DRAWINGS AND SPECIFICATIONS.

FURNISHED AND CONTRACT VENDOR INFORMATION FO CHANDISER BASE N T K PLASTICS, AND COMPOSITES RCHITECTURAL RK RK	OR IN			COORDINATE	FURNISHED	INSTALLED	COORDINATE	FURNISHED	INSTALLED	COORDINATE	REMARKS
TURNISHED AND CONTRACT VENDOR INFORMATION FOR CHANDISER BASE IN T PLASTICS, AND COMPOSITES RCHITECTURAL	 	STALLE ON SH	ED ARENC	DLOGY	<u>'</u>			FURNISHED	INSTALLED	COORDINATE	REMARKS
CHANDISER BASE IN T K PLASTICS, AND COMPOSITES RCHITECTURAL	 	X X				х					
CHANDISER BASE T T K PLASTICS, AND COMPOSITES RCHITECTURAL		X X				х					
T K PLASTICS, AND COMPOSITES RCHITECTURAL		х				х					
T K PLASTICS, AND COMPOSITES RCHITECTURAL		-		х							KPI
PLASTICS, AND COMPOSITES RCHITECTURAL		х				Х	х				NEW MILLENNIUM - NATIONAL ACCOUNTS PROGRAM MANAGER JILL ENGERMAN JILL.ENGERMAN@NEWMILL.COM (260.969.3502)
RCHITECTURAL v	<u> </u>][1	Х		Х	Х				NEW MILLENNIUM - NATIONAL ACCOUNTS PROGRAM MANAGER JILL ENGERMAN JILL.ENGERMAN@NEWMILL.COM (260.969.3502)
		x				x					RIDDLEY RETAIL FIXTURES, INC.
<u> </u>											
O FRAME X		x				x					DH PACE: ALDIDOORS@DHPACE.COM SELECT DOOR FRAMES TO BE PREPARED TO RECEIVE ALARMED EXIT DEVICE EQUIPMENT - REFER TO A-601
									<u> </u>	<u> </u>	FOR APPLICABLE DOOR FRAMES. DH PACE: ALDIDOORS@DHPACE.COM
DWARE X		Х				Х					RE: A-601
TIES .											
IGNAGE											
'NO PARKING' X		Х				Х					SBPI GRAPHICS <u>OR</u> OFF THE WALL COMPANY, LLC
SCREEN WALL X		Х				Х					OFF THE WALL COMPANY, LLC IF SHOWN ON PLANS
MOUNTED X		Х				Х					MULTIDECK UNITS HAVE AN INTEGRAL FASCIA FOR SIGNAGE ATTACHMENT LPB VALANCE LOCATED ABOVE COOLER / FREEZER DOORS (KPI OR RIDDLEY)
NTED X		X				Х					SBPI GRAPHICS OR OFF THE WALL COMPANY, LLC
CREEN WALL X		Х				Х					OFF THE WALL COMPANY, LLC
CE SCREEN WALL X		X				Х					OFF THE WALL COMPANY, LLC
IGNAGE]										<u>JL</u>
EXTERIOR X		X				х					
]			<u> </u>	<u> </u>	<u>I</u>	I <u> </u>			JI
HARGER X		х				х					CROWN EQUIPMENT CORPORATION
R AND LENS (FOR M FLOOR MAGE AT IMPACT		x				х					FACILITY SOLUTIONS GROUP
Х		Х				Х					HAYMAN SAFE
x		х				х					HAYMAN SAFE
CHANDISER X		Х				Х					AHT COOLING SYSTEMS USA INC.
CE AND SHELVING, I AND EPW/SS AS		х				x					REB
	FRAME X DWARE X DWARE X ES GNAGE NO PARKING' X CREEN WALL X MOUNTED X CREEN WALL X CREEN WALL X GNAGE EXTERIOR X EOUS SPECIALTIES AND EQUITY IARGER X A AND LENS (FOR A FLOOR A AGE AT IMPACT X HANDISER X CE AND SHELVING, AND EPW/SS	FRAME X DWARE X ES GNAGE NO PARKING' X CREEN WALL X NIED X CREEN WALL	FRAME X X DWARE X X ES GNAGE NO PARKING' X X CREEN WALL X X AOUNTED X X CREEN WALL X X CREEN W	FRAME X X DWARE X X ES GNAGE NO PARKING' X X CREEN WALL X X NIED X X CREEN WALL X X GNAGE EXTERIOR X X EOUS SPECIALTIES AND EQUIPMENT IARGER X X A FLOOR A FLOOR A AGE AT IMPACT X X X HANDISER X X X X HANDISER X X CE AND SHELVING, AND EPW/SS X X	FRAME	FRAME	FRAME	FRAME	FRAME	FRAME	FRAME

		10			_	_			RE	SPO	NSI	BILI1	Y SCHEDULE
		NATIONAL ACCOUNT PRICING	EXISTING		ALDI			ENERA NTRAC		LA	ND LC		
SPEC SECTION	ELEMENT			FURNISHED	INSTALLED	COORDINATE	FURNISHED	INSTALLED	COORDINATE	FURNISHED	INSTALLED	COORDINATE	REMARKS
DIVISION 12	2 - FURNISHINGS												
123200	MANUFACTURED CASEWORK	(RIDDLEY RETAIL FIXTURES, INC.
	CABINETS	Х		х				Х					KPI <u>OR</u> RIDDLEY
	CHECKLANES	Х		х				Х					KPI <u>OR</u> RIDDLEY
	FILE CABINETS	х		Х				Х					KPI <u>OR</u> RIDDLEY
	LOCKERS	х		х				Х					KPI <u>OR</u> RIDDLEY
	MANAGER'S ORGANIZATION DESK	Х		Х				Х					KPI <u>OR</u> RIDDLEY
	SACKING COUNTER AND MOUNTING BRACKET	Х		Х				Х					KPI <u>OR</u> RIDDLEY
	SALES FLOOR GONDOLAS	Х		Х				Х					KPI <u>Or</u> riddley
	SCO WALL	Х		Х				Х					RIDDLEY
DRAWING	BREAKROOM MIRROR	х		Х				Х					
	CHECKLANE CHAIRS	X		X				.,		ll l		I	
DRAWING	CHECKLANE CHAIRS	^	<u> </u>	<u> </u>				Х					DAUPHIN <u>OR</u> KDI DESIGN (VIA SEATING)
DRAWING	QUARTER CART SIGN 2 - PLUMBING	X		x			x	X	x				OWNER FURNISHES GRAPHIC (SBPI GRAPHICS <u>OR</u> OFF THE WALL COMPANY, LLC) GC FURNISHES FRAME (WHEN APPLICABLE)
DIVISION 22	QUARTER CART SIGN 2 - PLUMBING BREAKROOM SINK	X		x									OWNER FURNISHES GRAPHIC (SBPI GRAPHICS OR OFF THE WALL COMPANY, LLC)
DRAWING DIVISION 22 DRAWING DIVISION 23	QUARTER CART SIGN 2 - PLUMBING BREAKROOM SINK 3 - HEATING, VENTILATING, AN	X	 DNDITI	X				x	х				OWNER FURNISHES GRAPHIC (SBPI GRAPHICS OR OFF THE WALL COMPANY, LLC) GC FURNISHES FRAME (WHEN APPLICABLE) SINK FURNISHED BY OWNER WITH MILLWORK PACKAGE
DIVISION 22 DRAWING DIVISION 23 237413	QUARTER CART SIGN 2 - PLUMBING BREAKROOM SINK 3 - HEATING, VENTILATING, AND PACKAGED, OUTDOOR, CEN	TRAL-STAT	 ONDITION R	X	 G OP UNI	 ITS (RTU	 J-2 & F	X X					OWNER FURNISHES GRAPHIC (SBPI GRAPHICS OR OFF THE WALL COMPANY, LLC) GC FURNISHES FRAME (WHEN APPLICABLE) SINK FURNISHED BY OWNER WITH MILLWORK PACKAGE SINK IS PREINSTALLED UNDER COUNTER
DIVISION 22 DRAWING DIVISION 23 237413	QUARTER CART SIGN 2 - PLUMBING BREAKROOM SINK 3 - HEATING, VENTILATING, AND PACKAGED, OUTDOOR, CEN	TRAL-STAT	ONDITION R	ONING		TS (RTU	 J-2 & F	X X RTU-3)					OWNER FURNISHES GRAPHIC (SBPI GRAPHICS OR OFF THE WALL COMPANY, LLC) GC FURNISHES FRAME (WHEN APPLICABLE) SINK FURNISHED BY OWNER WITH MILLWORK PACKAGE SINK IS PREINSTALLED UNDER COUNTER TRANE
DIVISION 22 DRAWING DIVISION 23 237413	QUARTER CART SIGN 2 - PLUMBING BREAKROOM SINK 3 - HEATING, VENTILATING, AND PACKAGED, OUTDOOR, CEN RTU-2 RTU-3	TRAL-STAT	ONDITION R	ONING	 	 ITS (RTU	 J-2 & F	X X					OWNER FURNISHES GRAPHIC (SBPI GRAPHICS OR OFF THE WALL COMPANY, LLC) GC FURNISHES FRAME (WHEN APPLICABLE) SINK FURNISHED BY OWNER WITH MILLWORK PACKAGE SINK IS PREINSTALLED UNDER COUNTER
DIVISION 22 DRAWING DIVISION 23 237413	QUARTER CART SIGN 2 - PLUMBING BREAKROOM SINK 3 - HEATING, VENTILATING, AND PACKAGED, OUTDOOR, CEN RTU-2 RTU-3 PACKAGED, OUTDOOR, DEHI	TRAL-STAT X UMIDIFICA	ONDITION R	ONING COOFTG X X UNIT (RTU-1)	 ITS (RTU	J-2 & F	X X RTU-3) X X	x x x				OWNER FURNISHES GRAPHIC (SBPI GRAPHICS OR OFF THE WALL COMPANY, LLC) GC FURNISHES FRAME (WHEN APPLICABLE) SINK FURNISHED BY OWNER WITH MILLWORK PACKAGE SINK IS PREINSTALLED UNDER COUNTER TRANE TRANE TRANE
DIVISION 22 DRAWING DIVISION 23 237413	QUARTER CART SIGN 2 - PLUMBING BREAKROOM SINK 3 - HEATING, VENTILATING, AND PACKAGED, OUTDOOR, CEN RTU-2 RTU-3 PACKAGED, OUTDOOR, DEHI RTU-1 TEMPERATURE AND	TRAL-STAT X X UMIDIFICA	ONDITION R	ONING OOFTG X X UNIT (RTU-1)	ITS (RTU	J-2 & F	X X X X X	x				OWNER FURNISHES GRAPHIC (SBPI GRAPHICS OR OFF THE WALL COMPANY, LLC) GC FURNISHES FRAME (WHEN APPLICABLE) SINK FURNISHED BY OWNER WITH MILLWORK PACKAGE SINK IS PREINSTALLED UNDER COUNTER TRANE TRANE
DIVISION 22 DRAWING DIVISION 23 237413	QUARTER CART SIGN 2 - PLUMBING BREAKROOM SINK 3 - HEATING, VENTILATING, AN PACKAGED, OUTDOOR, CEN RTU-2 RTU-3 PACKAGED, OUTDOOR, DEHI RTU-1	X TRAL-STAT X X UMIDIFICA X	ONDITION R	ONING COOFTG X X UNIT (RTU-1)	 ITS (RTU	J-2 & F	X X RTU-3) X X	x x x				OWNER FURNISHES GRAPHIC (SBPI GRAPHICS OR OFF THE WALL COMPANY, LLC) GC FURNISHES FRAME (WHEN APPLICABLE) SINK FURNISHED BY OWNER WITH MILLWORK PACKAGE SINK IS PREINSTALLED UNDER COUNTER TRANE TRANE TRANE
DIVISION 22 DRAWING DIVISION 23 237413 237414	QUARTER CART SIGN 2 - PLUMBING BREAKROOM SINK 3 - HEATING, VENTILATING, AND PACKAGED, OUTDOOR, CEN RTU-2 RTU-3 PACKAGED, OUTDOOR, DEHI RTU-1 TEMPERATURE AND HUMIDITY SENSORS	X TRAL-STAT X X UMIDIFICA X	ONDITION R	ONING OOFTG X X UNIT (RTU-1)	ITS (RTU	J-2 & F	X X X X X	x				OWNER FURNISHES GRAPHIC (SBPI GRAPHICS OR OFF THE WALL COMPANY, LLC) GC FURNISHES FRAME (WHEN APPLICABLE) SINK FURNISHED BY OWNER WITH MILLWORK PACKAGE SINK IS PREINSTALLED UNDER COUNTER TRANE TRANE TRANE TRANE TRANE TRANE LG ELECTRONICS U.S.A., INC. RE: MECH DWGS - THIS PIECE OF EQUIPMENT IS ORDERED BY GC, AND ALDI IS DIRECT BILLED FOR COST OF
DIVISION 22 DRAWING DIVISION 23 237413 237414	QUARTER CART SIGN 2 - PLUMBING BREAKROOM SINK 3 - HEATING, VENTILATING, AN PACKAGED, OUTDOOR, CEN RTU-2 RTU-3 PACKAGED, OUTDOOR, DEHI RTU-1 TEMPERATURE AND HUMIDITY SENSORS SPLIT-SYSTEM AIR-CONDITION DUCTLESS SPLIT-FAN COIL	TRAL-STAT X UMIDIFICA X	ONDITION R	ONING ONING X X UNIT (X		ITS (RTU	J-2 & F	X X X X X	x x x x				OWNER FURNISHES GRAPHIC (SBPI GRAPHICS OR OFF THE WALL COMPANY, LLC) GC FURNISHES FRAME (WHEN APPLICABLE) SINK FURNISHED BY OWNER WITH MILLWORK PACKAGE SINK IS PREINSTALLED UNDER COUNTER TRANE TRANE TRANE TRANE LG ELECTRONICS U.S.A., INC. RE: MECH DWGS - THIS PIECE OF EQUIPMENT IS ORDERED BY GC, AND ALDI IS DIRECT BILLED FOR COST OF EQUIPMENT. INSTALLATION OF EQUIPMENT UNDER GC CONTRACT. LG ELECTRONICS U.S.A. INC.
DIVISION 22 DRAWING DIVISION 23 237413 237414	QUARTER CART SIGN 2 - PLUMBING BREAKROOM SINK 3 - HEATING, VENTILATING, AND PACKAGED, OUTDOOR, CEN RTU-2 RTU-3 PACKAGED, OUTDOOR, DEHI RTU-1 TEMPERATURE AND HUMIDITY SENSORS SPLIT-SYSTEM AIR-CONDITION DUCTLESS SPLIT-FAN COIL UNIT (FCU-1)	X ITRAL-STAT X X UMIDIFICA X NERS	TION R TION TION TION TION TION TION TION TION	X ONING OOFTG X X UNIT (X X			J-2 & F	X X X X X	x		 		OWNER FURNISHES GRAPHIC (SBPI GRAPHICS OR OFF THE WALL COMPANY, LLC) GC FURNISHES FRAME (WHEN APPLICABLE) SINK FURNISHED BY OWNER WITH MILLWORK PACKAGE SINK IS PREINSTALLED UNDER COUNTER TRANE TRANE TRANE TRANE TRANE TRANE TRANE TRANE TRANE LG ELECTRONICS U.S.A., INC. RE: MECH DWGS - THIS PIECE OF EQUIPMENT IS ORDERED BY GC, AND ALDI IS DIRECT BILLED FOR COST OF EQUIPMENT. INSTALLATION OF EQUIPMENT UNDER GC CONTRACT. LG ELECTRONICS U.S.A. INC. RE: MECH DWGS - THIS PIECE OF EQUIPMENT IS ORDERED BY GC, AND ALDI IS DIRECT BILLED FOR COST OF EQUIPMENT. INSTALLATION OF EQUIPMENT UNDER GC CONTRACT. LG ELECTRONICS U.S.A. INC. RE: MECH DWGS - THIS PIECE OF EQUIPMENT IS ORDERED BY GC, AND ALDI IS DIRECT BILLED FOR COST OF
DIVISION 22 DRAWING DIVISION 23 237413 237414 238126	QUARTER CART SIGN 2 - PLUMBING BREAKROOM SINK 3 - HEATING, VENTILATING, AN PACKAGED, OUTDOOR, CEN RTU-2 RTU-3 PACKAGED, OUTDOOR, DEHI RTU-1 TEMPERATURE AND HUMIDITY SENSORS SPLIT-SYSTEM AIR-CONDITION UNIT (FCU-1) HEAT PUMP (HP-1)	X ITRAL-STAT X X UMIDIFICA X NERS	TION R TION TION TION TION TION TION TION TION	X ONING OOFTG X X UNIT (X X			J-2 & F	X X X X X	x		 		OWNER FURNISHES GRAPHIC (SBPI GRAPHICS OR OFF THE WALL COMPANY, LLC) GC FURNISHES FRAME (WHEN APPLICABLE) SINK FURNISHED BY OWNER WITH MILLWORK PACKAGE SINK IS PREINSTALLED UNDER COUNTER TRANE TRANE TRANE TRANE TRANE TRANE TRANE TRANE TRANE LG ELECTRONICS U.S.A., INC. RE: MECH DWGS - THIS PIECE OF EQUIPMENT IS ORDERED BY GC, AND ALDI IS DIRECT BILLED FOR COST OF EQUIPMENT. INSTALLATION OF EQUIPMENT UNDER GC CONTRACT. LG ELECTRONICS U.S.A. INC. RE: MECH DWGS - THIS PIECE OF EQUIPMENT IS ORDERED BY GC, AND ALDI IS DIRECT BILLED FOR COST OF EQUIPMENT. INSTALLATION OF EQUIPMENT UNDER GC CONTRACT. LG ELECTRONICS U.S.A. INC. RE: MECH DWGS - THIS PIECE OF EQUIPMENT IS ORDERED BY GC, AND ALDI IS DIRECT BILLED FOR COST OF EQUIPMENT INSTALLATION OF EQUIPMENT IS ORDERED BY GC, AND ALDI IS DIRECT BILLED FOR COST OF
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DIVISION 23 237414 237414 238126 DIVISION 26 265100 DRAWING	QUARTER CART SIGN 2 - PLUMBING BREAKROOM SINK 3 - HEATING, VENTILATING, AND PACKAGED, OUTDOOR, CEN RTU-2 RTU-3 PACKAGED, OUTDOOR, DEHI RTU-1 TEMPERATURE AND HUMIDITY SENSORS SPLIT-SYSTEM AIR-CONDITION UNIT (FCU-1) HEAT PUMP (HP-1) 5 - ELECTRICAL NORDEON INTERIOR	X ND AIR CC TRAL-STAT X X UMIDIFICA X NERS X	TION R TION R TION TION TIO	X ONING OOFTG X X UNIT (X X				х х х х х	x x x x x x		 		OWNER FURNISHES GRAPHIC (SBPI GRAPHICS OR OFF THE WALL COMPANY, LLC) GC FURNISHES FRAME (WHEN APPLICABLE) SINK FURNISHED BY OWNER WITH MILLWORK PACKAGE SINK IS PREINSTALLED UNDER COUNTER TRANE TRANE TRANE TRANE TREFER TO G-005 FOR RTU-1 ROOF CURB SCOPE LG ELECTRONICS U.S.A., INC. RE: MECH DWGS - THIS PIECE OF EQUIPMENT IS ORDERED BY GC, AND ALDI IS DIRECT BILLED FOR COST OF EQUIPMENT. INSTALLATION OF EQUIPMENT UNDER GC CONTRACT. LG ELECTRONICS U.S.A. INC. RE: MECH DWGS - THIS PIECE OF EQUIPMENT UNDER GC CONTRACT. LG ELECTRONICS U.S.A. INC. RE: MECH DWGS - THIS PIECE OF EQUIPMENT UNDER GC CONTRACT. LG ELECTRONICS U.S.A. INC. RE: MECH DWGS - THIS PIECE OF EQUIPMENT UNDER GC CONTRACT.



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Victor, NY 14564

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	Revisions:	Date
1	Owner Changes	11/18/
2	Owner Changes	07/29/
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12		
PR	OJECT ARCHITECT/ENGINEER	
D	aniel Sargent	
PR	OJECT LEAD	

NOT FOR CONSTRUCTION

John Lynch

ALDI Inc. Store #: 50 Coconut Crossing, FL 🛆 12850 Northlake Boulevard

Palm Beach Gardens, FL 33412

Palm Beach County

Project Name & Location:

Responsibility Schedule -Appendix A
Drawing Name:
Prototype:

V7.08 LHRD

22-0267A GROUND UP

Drawn By: Scale:

G-006 As Noted Drawing No.

Project No.

NOTE:

THE RESPONSIBILITY SCHEDULE IS MEANT TO PROVIDE AN OVERVIEW OF OWNER FURNISHED AND OWNER PROVIDED ITEMS. THIS IS NOT MEANT TO REPLACE THE GC OBLIGATIONS WITHIN THE DRAWINGS AND SPECIFICATIONS.

		1	1	1			1		RE	SPC	ONSI	BILI	TY SCHEDULE	\Box
		NATIONAL ACCOUNT PRICING	EXISTING		ALDI	l		SENER. NTRAC		LA	ND LC	ORD		
SPEC SECTION	ELEMENT			FURNISHED	INSTALLED	COORDINATE	FURNISHED	INSTALLED	COORDINATE	FURNISHED	INSTALLED	COORDINATE	REMARKS	
	B - OWNER PROVIDED (FURNIS				A DENI		,	•	•	•	•	•		$\overline{\exists}$
	DIX B IN THE VENDOR INFORM. 13 - CONCRETE	AIION FO	LDER	ON 3H	AKENG	<u>JLUG 1</u>	<u>(</u>							\exists
033544	DIAMOND POLISHED CONCRETE FINISHING	Х		х	х				х				COORDINATE WITH ALDI CONSTRUCTION REPRESENTATIVE	
DIVISION 0	7 - THERMAL AND MOISTURE P	ROTECTIC)N											
075416	KEE ROOFING		<u> </u>	х	х				x				FIBERTITE: KEE ROOFING	\dashv
	ROOF INSULATION			X	X				X				SEE THERMAL INSULATION SCHEDULE ON A-603 FOR DESIRED R-VALUE	-/
075419	PVC ROOFING			X	X				X					\dashv
	ROOF INSULATION			X	X				X				SEE THERMAL INSULATION SCHEDULE ON A-603 FOR DESIRED R-VALUE	+
076200	SHEET METAL FLASHING AND			х	Х				х				DRIP EDGE AND FASCIA CAP: SEE ROOFER'S SCOPE OF WORK	\exists
	TRIM SCUPPER			x	X				X				SEE ROOFER'S SCOPE OF WORK	\dashv
077200	ROOF ACCESSORIES		<u>]</u>][JI			JL	\exists
	ROOF HATCH WALKWAY]	х	х				x					\dashv
	PADS ROOF HATCH			X	Х				X				BABCOCK-DAVIS	\dashv
	ROOF HATCH SAFETY RAILING SYSTEM			х	х				х				SAFEPRO SAFETY	
DIVISION 0	8 - OPENINGS													\neg
084229	AUTOMATIC ENTRANCES													
	AUTODOOR SYSTEM AND TRANSOM FRAMING	х		х	х				х				AUTOMATIC ENTRANCE DOOR SYSTEM: STANLEY ACCESS TECHNOLOGIES. AUTO DOOR SYSTEM IS FURNISHED & INSTALLED BY ALDI. TRANSOM FRAMING IS FURNISHED AND INSTALLED BY GC.GC TO CONFIRM WITH OWNER THAT DOOR SUPPLIER VERIFIES R.O. SIZE BEFORE FABRICATION OF DOORS.	
	GLAZING IN AUTODOOR AND TRANSOM						х	Х	х				GLAZING FOR BI-PARTING ENTRANCE DOOR IS FURNISHED & INSTALLED WITH THE DOOR BY ALDI. ALL OTH GLAZING FURNISHED AND INSTALLED BY GC	:R
	ECOMMERCE DOOR OPERATOR	X		Х	Х				X					4
DIVISION 0	9 - FINISHES													
DIVISION 1	0 - SPECIALTIES													
101400	EXTERIOR SIGNAGE													\dashv
	LOGO	Х	I	х	х	T			х	T	T	T	PERSONA SIGN	\dashv
	MONUMENT / PYLON	X	 	X	X				X	 			PERSONA SIGN	\dashv
102800	TOILET, BATH AND LAUNDRY		<u> </u>	JL	1	1	JL	<u> </u>		JL	1	1	JI.	\dashv
	TOILET PAPER DISPENSER)	х	х	T			х	T	T	T		\dashv
	SOAP DISPENSER			X	X				X	 			 	\dashv_{\perp}
10/11	MISCELLANEOUS SPECIALTIES]		1 - 1	1	J <u>L</u>	<u> </u>	1	JL	1	1		+
0000	SMART SAFE	X]	x	T			х		T	T	T	LOOMIS	\dashv
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	i					$\overline{}$			$\overline{}$				
		NATIONAL ACCOUNT PRICING	EXISTING		ALDI			ENERA NTRAC		LA	ND LO	RD	
SPEC SECTION	ELEMENT			FURNISHED	INSTALLED	COORDINATE	FURNISHED	INSTALLED	COORDINATE	FURNISHED	INSTALLED	COORDINATE	REMARKS
DIVISION 11	1 - EQUIPMENT												
114000	FOODSERVICE EQUIPMENT												
	COMPRESSOR/CONDENSER	Х		Х	х				Х				GC TO PROVIDE STRUCTURAL SUPPORT FOR EQUIPMENT MOUNTING SEE REFRIGERATION DRAWINGS FOR ADDITIONAL REQUIREMENTS
	COOLER/FREEZER - DOOR - CUSTOMER	Х		Х	х				Х				THERMOSEAL
	COOLER/FREEZER - DOOR - SERVICE	Х		Х	х				Х				
	COOLER/FREEZER - EVAPORATORS	х	 	х	х								
	COOLER/FREEZER - LIGHTING	Х	 		х		Х						COOLER AND FREEZER LIGHTING FURNISHED BY GC AND INSTALLED BY REFRIGERATION CONTRACTOR
	COOLER/FREEZER -		ļ	X	х								
	OCCUPANCY SENSORS COOLER/FREEZER -	Х	l	X	х				Х				
	WALK-IN BOX FLOOR SCRUBBER	X	 	X	х								TENNANT
	MULTI-DECK UNIT	X	 	X	Х								SEE REFRIGERATION DRAWINGS FOR VENDOR
	MULTI-DECK UNIT -		 	X	Х								
	PALLET JACKS / STACKERS	x	l	X	X								CROWN, RAYMOND, OR GLOBAL INDUSTRIAL ETC.
	REFRIGERATION EQUIPMENT		 	^ 			х	х					
	DISCONNECT REFRIGERATION REMOTE			X	Х				X				SEE REFRIGERATION DRAWINGS IF APPLICABLE
	SCO (SELF CHECKOUT) UNIT			x	x				x				DIEBOLD NIXDORF CONTRACTOR RESPONSIBLE FOR PROVIDING POWER AND DATA CONNECTION POINTS TO UNIT VIA POWERPOLES AND/OR WALL CHASE
RAWING	WASTE COMPACTOR AND DE	STRUCTO!	RS	IL									FOWERFOLES AND/OR WALL CHASE
	BALER	Х		х	х				Х				BACE
	BALER DISCONNECT SWITCH						х	х					COORDINATE FINAL DISCONNECT LOCATION TO BE ON POWER SUPPLY SIDE OF BALER
	3 - HVAC												
IVISION 23				1					$\overline{}$				
IVISION 23	IAQ IONIZATION UNIT	X		Х	х				Х				UNIT TO BE SHIPPED W/ SIEMENS INDUSTRY, INC ORDER AND INSTALLED BY REFRIGERATION CONTRACTOR
													UNIT TO BE SHIPPED W/ SIEMENS INDUSTRY, INC ORDER AND INSTALLED BY REFRIGERATION CONTRACTOR
IVISION 25	5 - INTEGRATED AUTOMATION ENERGY MANAGEMENT SYSTE		 										UNIT TO BE SHIPPED W/ SIEMENS INDUSTRY, INC ORDER AND INSTALLED BY REFRIGERATION CONTRACTOR
IVISION 25	5 - INTEGRATED AUTOMATION			x x	x				X				UNIT TO BE SHIPPED W/ SIEMENS INDUSTRY, INC ORDER AND INSTALLED BY REFRIGERATION CONTRACTOR SIEMENS INDUSTRY, INC.
IVISION 25	5 - INTEGRATED AUTOMATION ENERGY MANAGEMENT SYSTE	EM											
IVISION 25	5 - INTEGRATED AUTOMATION ENERGY MANAGEMENT SYSTE	EM X] 	X	x				x				SIEMENS INDUSTRY, INC.
IVISION 25	5 - INTEGRATED AUTOMATION ENERGY MANAGEMENT SYSTE HVAC LIGHTING REFRIGERATION	EM X		X X	X				X X				SIEMENS INDUSTRY, INC. SIEMENS INDUSTRY, INC.
IVISION 25	5 - INTEGRATED AUTOMATION ENERGY MANAGEMENT SYSTE HVAC LIGHTING REFRIGERATION 7 - COMMUNICATIONS	EM X X X		X X X	X X X				X X X				SIEMENS INDUSTRY, INC. SIEMENS INDUSTRY, INC. DANFOSS
IVISION 25	5 - INTEGRATED AUTOMATION ENERGY MANAGEMENT SYSTE HVAC LIGHTING REFRIGERATION 7 - COMMUNICATIONS	EM X		X X	X				X X				SIEMENS INDUSTRY, INC. SIEMENS INDUSTRY, INC. DANFOSS MIDDLE ATLANTIC PRODUCTS
IVISION 25 RAWING IVISION 27 RAWING	5 - INTEGRATED AUTOMATION ENERGY MANAGEMENT SYSTE HVAC LIGHTING REFRIGERATION 7 - COMMUNICATIONS	EM X X X		X X X	X X X				X X X				SIEMENS INDUSTRY, INC. SIEMENS INDUSTRY, INC. DANFOSS MIDDLE ATLANTIC PRODUCTS ALDI TO PROVIDE ANTENNA REFER TO G-005 'DIVISION 27 - COMMUNICATIONS_ROOF MAST' FOR ROOF MAST ASSEMBLY, BALLAST, AI
IVISION 25 PRAWING PRAWING	5 - INTEGRATED AUTOMATION ENERGY MANAGEMENT SYSTE HVAC LIGHTING REFRIGERATION 7 - COMMUNICATIONS I.T. RACK ROOF MAST - ANTENNA SECURITY MONITOR -	EM X X X		X X X	X X X				x x x				SIEMENS INDUSTRY, INC. SIEMENS INDUSTRY, INC. DANFOSS MIDDLE ATLANTIC PRODUCTS ALDI TO PROVIDE ANTENNA
DIVISION 27 DRAWING DRAWING	5 - INTEGRATED AUTOMATION ENERGY MANAGEMENT SYSTE HVAC LIGHTING REFRIGERATION 7 - COMMUNICATIONS I.T. RACK ROOF MAST - ANTENNA	EM		X X X	X				X				SIEMENS INDUSTRY, INC. SIEMENS INDUSTRY, INC. DANFOSS MIDDLE ATLANTIC PRODUCTS ALDI TO PROVIDE ANTENNA REFER TO G-005 'DIVISION 27 - COMMUNICATIONS_ROOF MAST' FOR ROOF MAST ASSEMBLY, BALLAST, AN



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В	Issued for Bid	07/29/25
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	Revisions:	Date:
1	Owner Changes	11/18/24
2	Owner Changes	07/29/25
3		
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11		
12		
PR	OJECT ARCHITECT/ENGINEER	
D	aniel Sargent	

NOT FOR CONSTRUCTION



John Lynch

Coconut Crossing, FL 🛆 12850 Northlake Boulevard

ALDI Inc. Store #: 50

Palm Beach Gardens, FL 33412 Palm Beach County

Project Name & Location:

Responsibility Schedule -Appendix B
Drawing Name:
Prototype:

Project No. V7.08 LHRD 22-0267A


GROUND UP Drawn By:

G-007 Scale:

As Noted Drawing No.

NOTE:

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GENERAL CONSTRUCTION NOTES

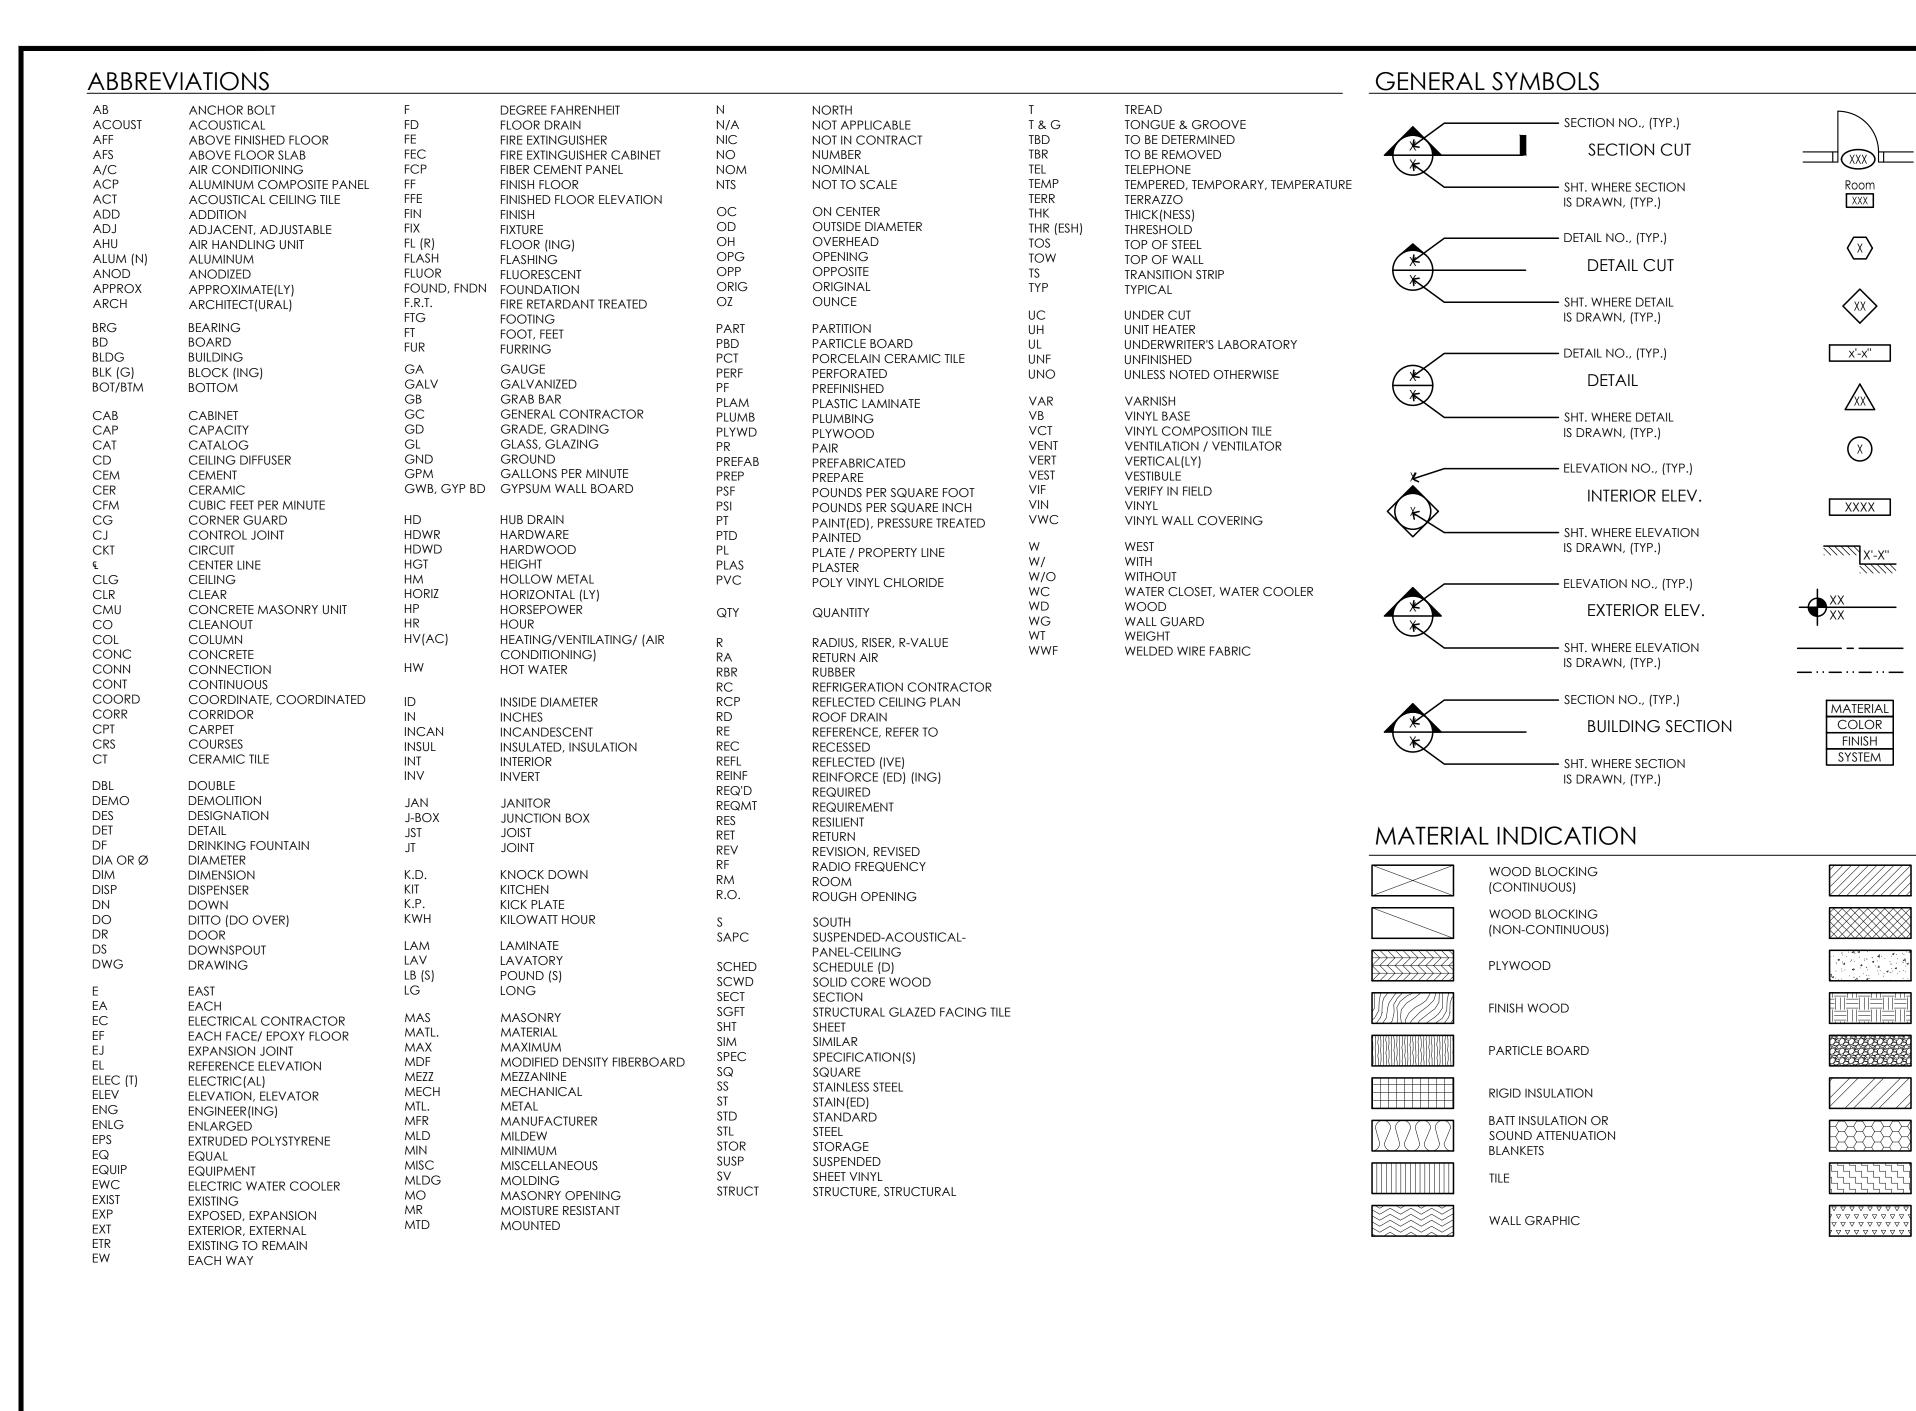DOOR NUMBER

ROOM NUMBER

WINDOW/GLAZING

CEILING HEIGHT

REVISION TAG

MISCELLANEOUS

FINISH TAG - SEE

CENTER LINE

INTERIOR WALL

FINISH TAG

BRICK

CONCRETE

GRAVEL

GRADE/EARTH

EXPANDING

WALKOFF MAT

FIRE WALL

FOAM INSULATION

DRAWING A-603

ELEVATION CHANGE

SPOT ELEVATION TAG

CONTROL JOINT LINE

CONCRETE MASONRY UNIT

KEY NOTE

NUMBER

TAG

1. ALL CONSTRUCTION SHALL CONFORM TO THE CODES LISTED ON G-002

ANY WORK PROVIDED BY OWNER AND BY OTHERS.

- A. THE CODES, RULES, AND REGULATIONS OF THE STATE IN WHICH THE WORK IS BEING PERFORMED. B. NFPA REQUIREMENTS AS WELL AS TO STANDARDS OF UNDERWRITERS LABORATORIES INC., AND LOCAL UTILITY CO. C. CONTRACTOR SHALL BE RESPONSIBLE FOR SECURING ALL PERMITS AS REQUIRED TO PROVIDE THE NEW CONSTRUCTION.
- 2. CONTRACTOR SHALL VISIT THE SITE AND EXAMINE EXISTING CONDITIONS PRIOR TO SUBMITTING BIDS. BIDS SHALL INCLUDE PROVISIONS FOR A COMPLETE JOB BASED ON THE DESIGN INTENT SHOWN ON THE DRAWINGS. FIELD VERIFY ALL DIMENSIONS & CONDITIONS PRIOR TO START OF WORK AND REPORT ALL DISCREPANCIES TO THE ARCHITECT / ENGINEER.
- 3. WHEN COMPARING THE DRAWINGS AND SPECIFICATIONS; THE DRAWINGS GOVERN SPECIFICATIONS FOR QUANTITY AND LOCATION, AND SPECIFICATIONS GOVERN DRAWINGS FOR QUALITY AND PERFORMANCE. IN THE EVENT OF
- AMBIGUITY IN QUANTITY OR QUALITY, THE GREATER QUANTITY AND SUPERIOR QUALITY SHALL GOVERN. CONTRACTOR SHALL BE FULLY RESPONSIBLE FOR ALL COORDINATION AS REQUIRED INCLUDING COORDINATION WITH
- A. REFER TO HVAC, PLUMBING, & ELECTRICAL DRAWINGS FOR WORK PERFORMED BY THOSE TRADES.
- 5. THE OWNER SHALL DESIGNATE STAGING AND STORAGE AREAS OF THE SITE FOR USE BY CONTRACTOR DURING CONSTRUCTION. CONTRACTOR SHALL KEEP THE PREMISES AND SURROUNDING AREA FREE FROM ACCUMULATION OF WASTE OF RUBBISH MATERIALS, CONTRACTOR'S TOOLS, CONSTRUCTION EQUIPMENT, MACHINERY, AND SURPLUS
- 6. AREAS OF THE SITE AND ANY EXISTING CONSTRUCTION TO REMAIN, AND IF DAMAGED DURING CONSTRUCTION SHALL BE RESTORED TO THE ORIGINAL CONDITION (AT NO ADDITIONAL COST TO THE OWNER.)
- 7. CONTRACTOR SHALL PROVIDE ALL PROTECTION OF THE WORK THROUGHOUT CONSTRUCTION AS REQUIRED AND PER CODE.
- 8. PROVIDE A SELF-LEVELING CEMENTITIOUS UNDERLAYMENT WHERE PATCHING COMPOUNDS DO NOT MEET MANUFACTURER REQUIREMENTS FOR SUBSTRATE PREPARATION.
- 9. PAINTING INCLUDES WALLS, SOFFITS, DOOR FRAMES, HOLLOW METAL DOORS, ALL EXPOSED SURFACES, AND ALL SURFACE MOUNTED ITEMS AS REQUIRED TO PROVIDE A FINISHED PRODUCT.
- 10. CONTRACTOR TO VERIFY LOCATIONS OF ALL WALL MOUNTED ITEMS AND PROVIDE SOLID BLOCKING FOR MOUNTING.
- 11. REFER TO FINISH PLANS & NOTES FOR TYPES AND EXTENT OF FINISHES.
- 12. REFER TO PROJECT MANUAL APPENDIX 'A' FOR ALL ITEMS FURNISHED BY OWNER AND INSTALLED BY CONTRACTOR.
- 13. REFER TO PROJECT MANUAL APPENDIX 'B' FOR ALL ITEMS PROVIDED BY OWNER.



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PR	OJECT ARCHITECT/ENGINEER	
D	aniel Sargent	

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PROJECT LEAD

John Lynch



Coconut Crossing, FL 🛆 12850 Northlake Boulevard

Palm Beach Gardens, FL 33412

Palm Beach County

Project Name & Location:

ALDI Inc.

General Notes, Symbols, & Abbrev.

Drawing Name: Prototype:

Project No. 22-0267A

Drawn By:


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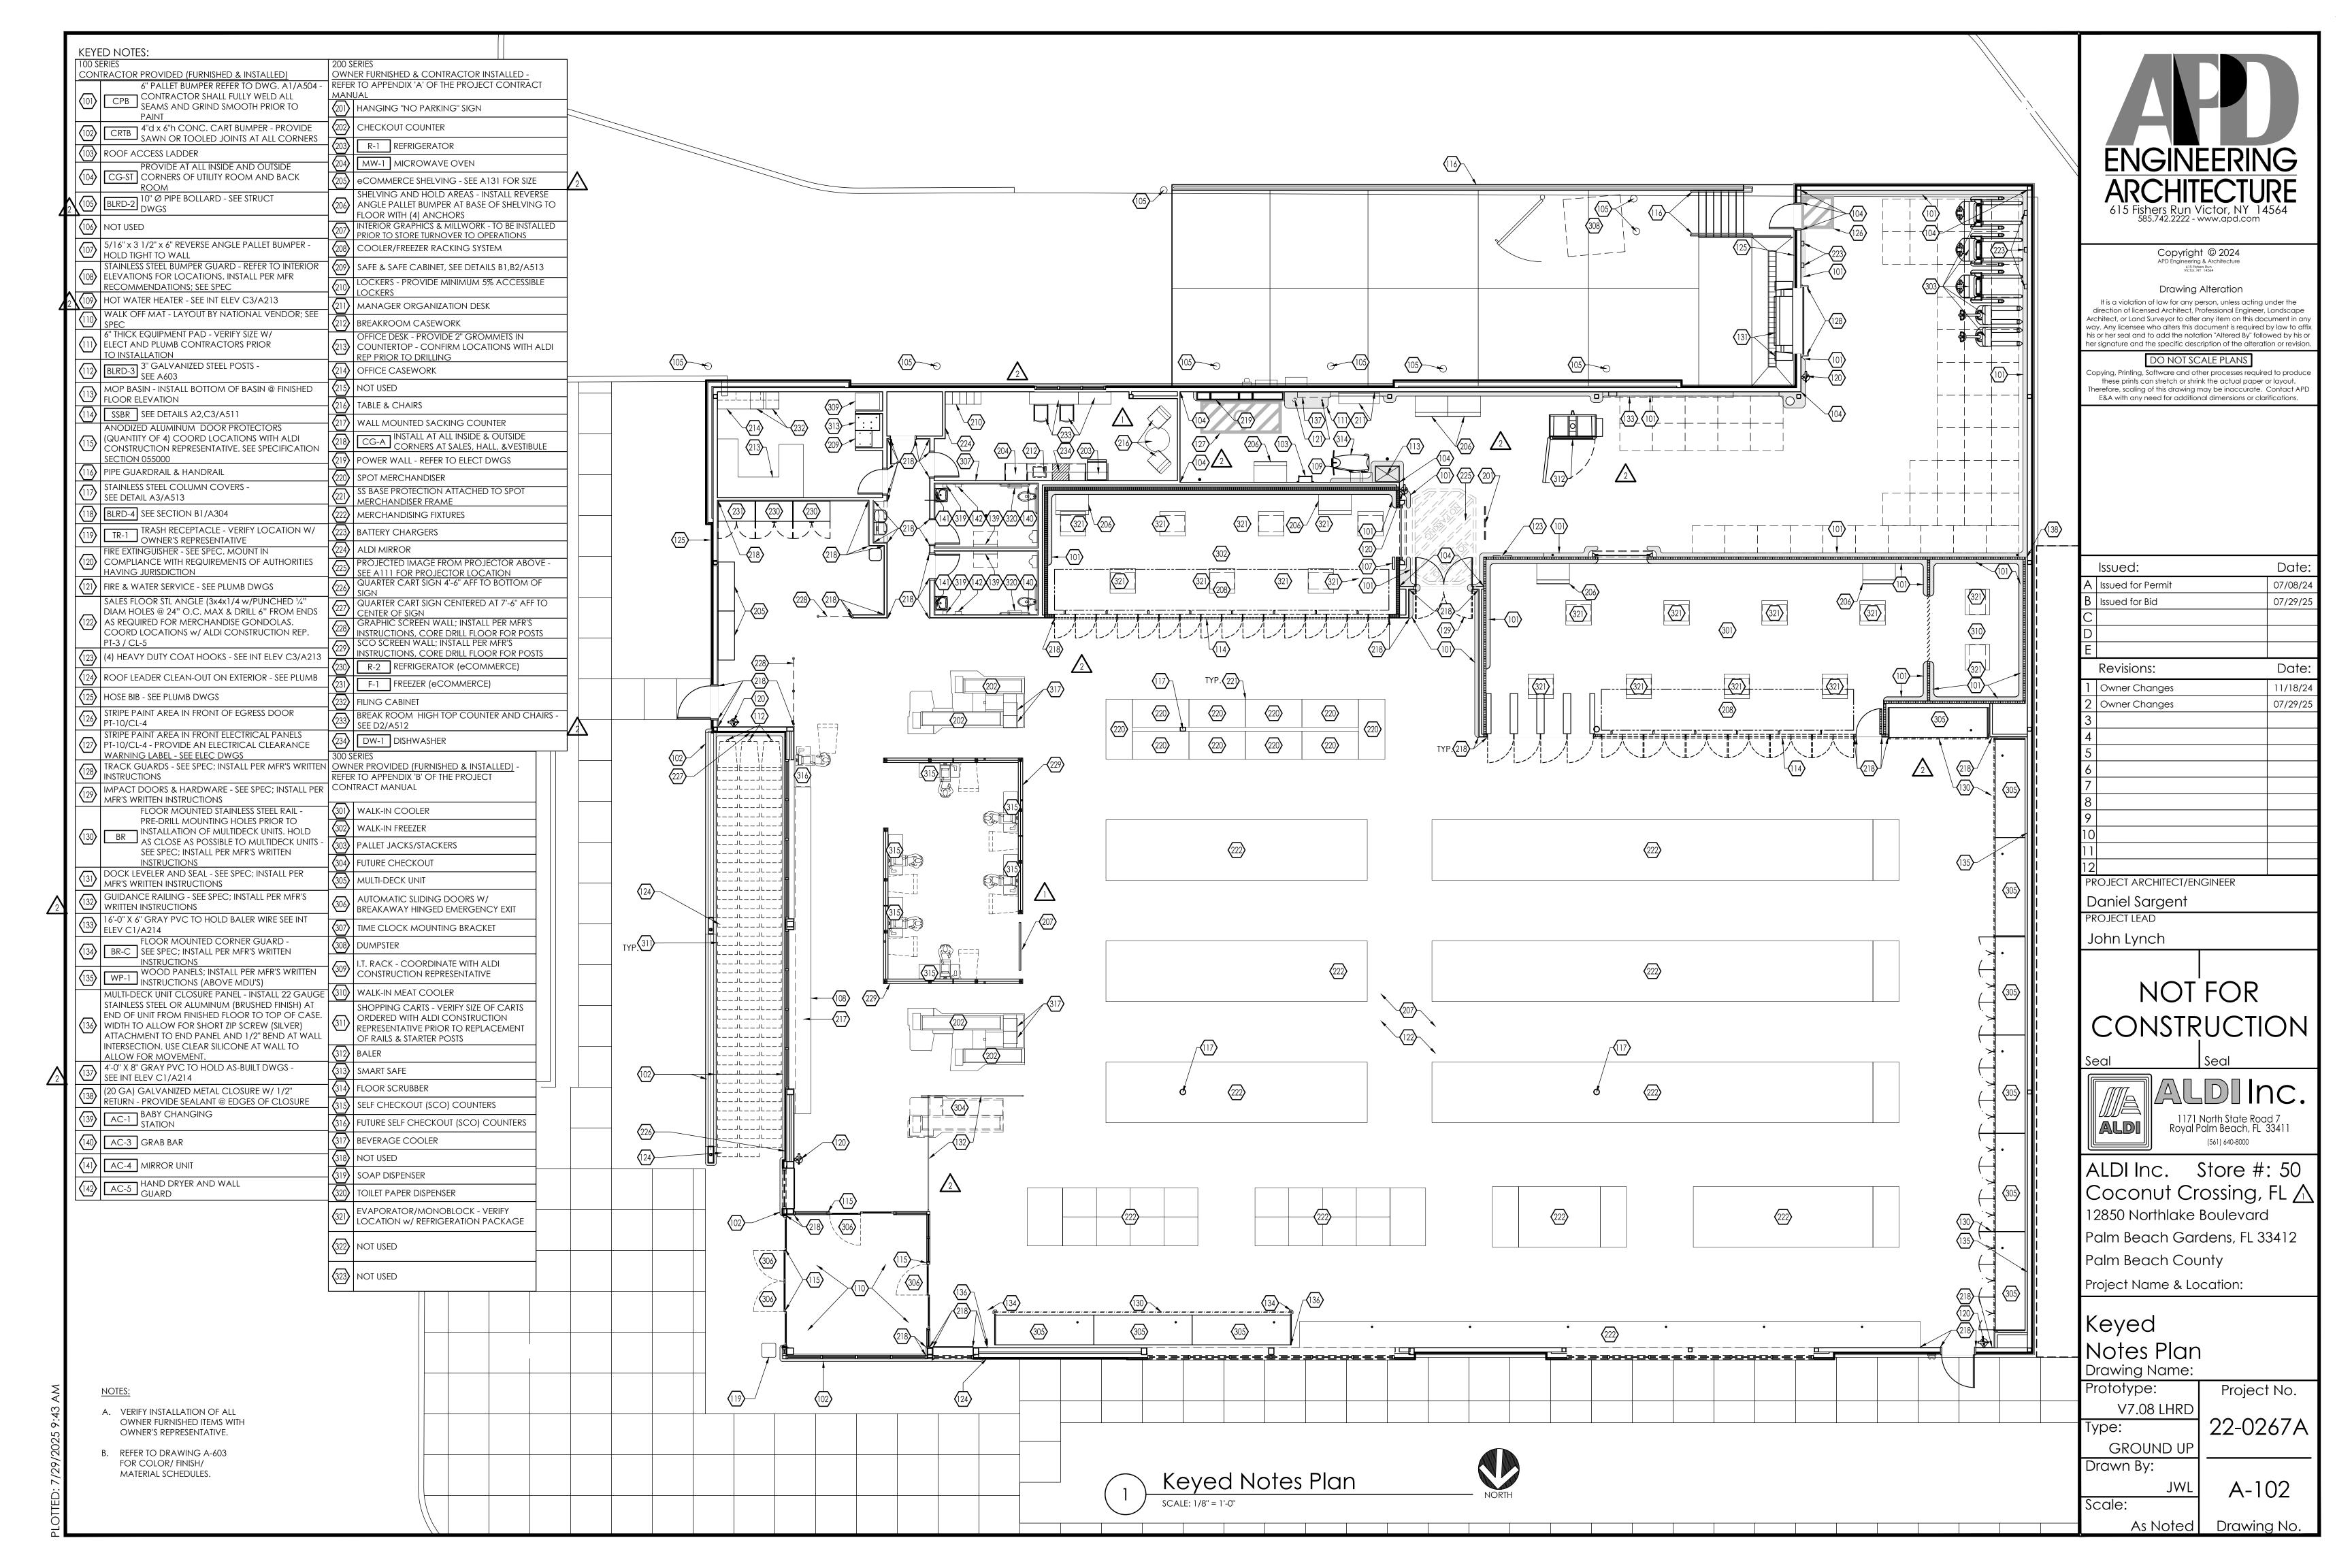
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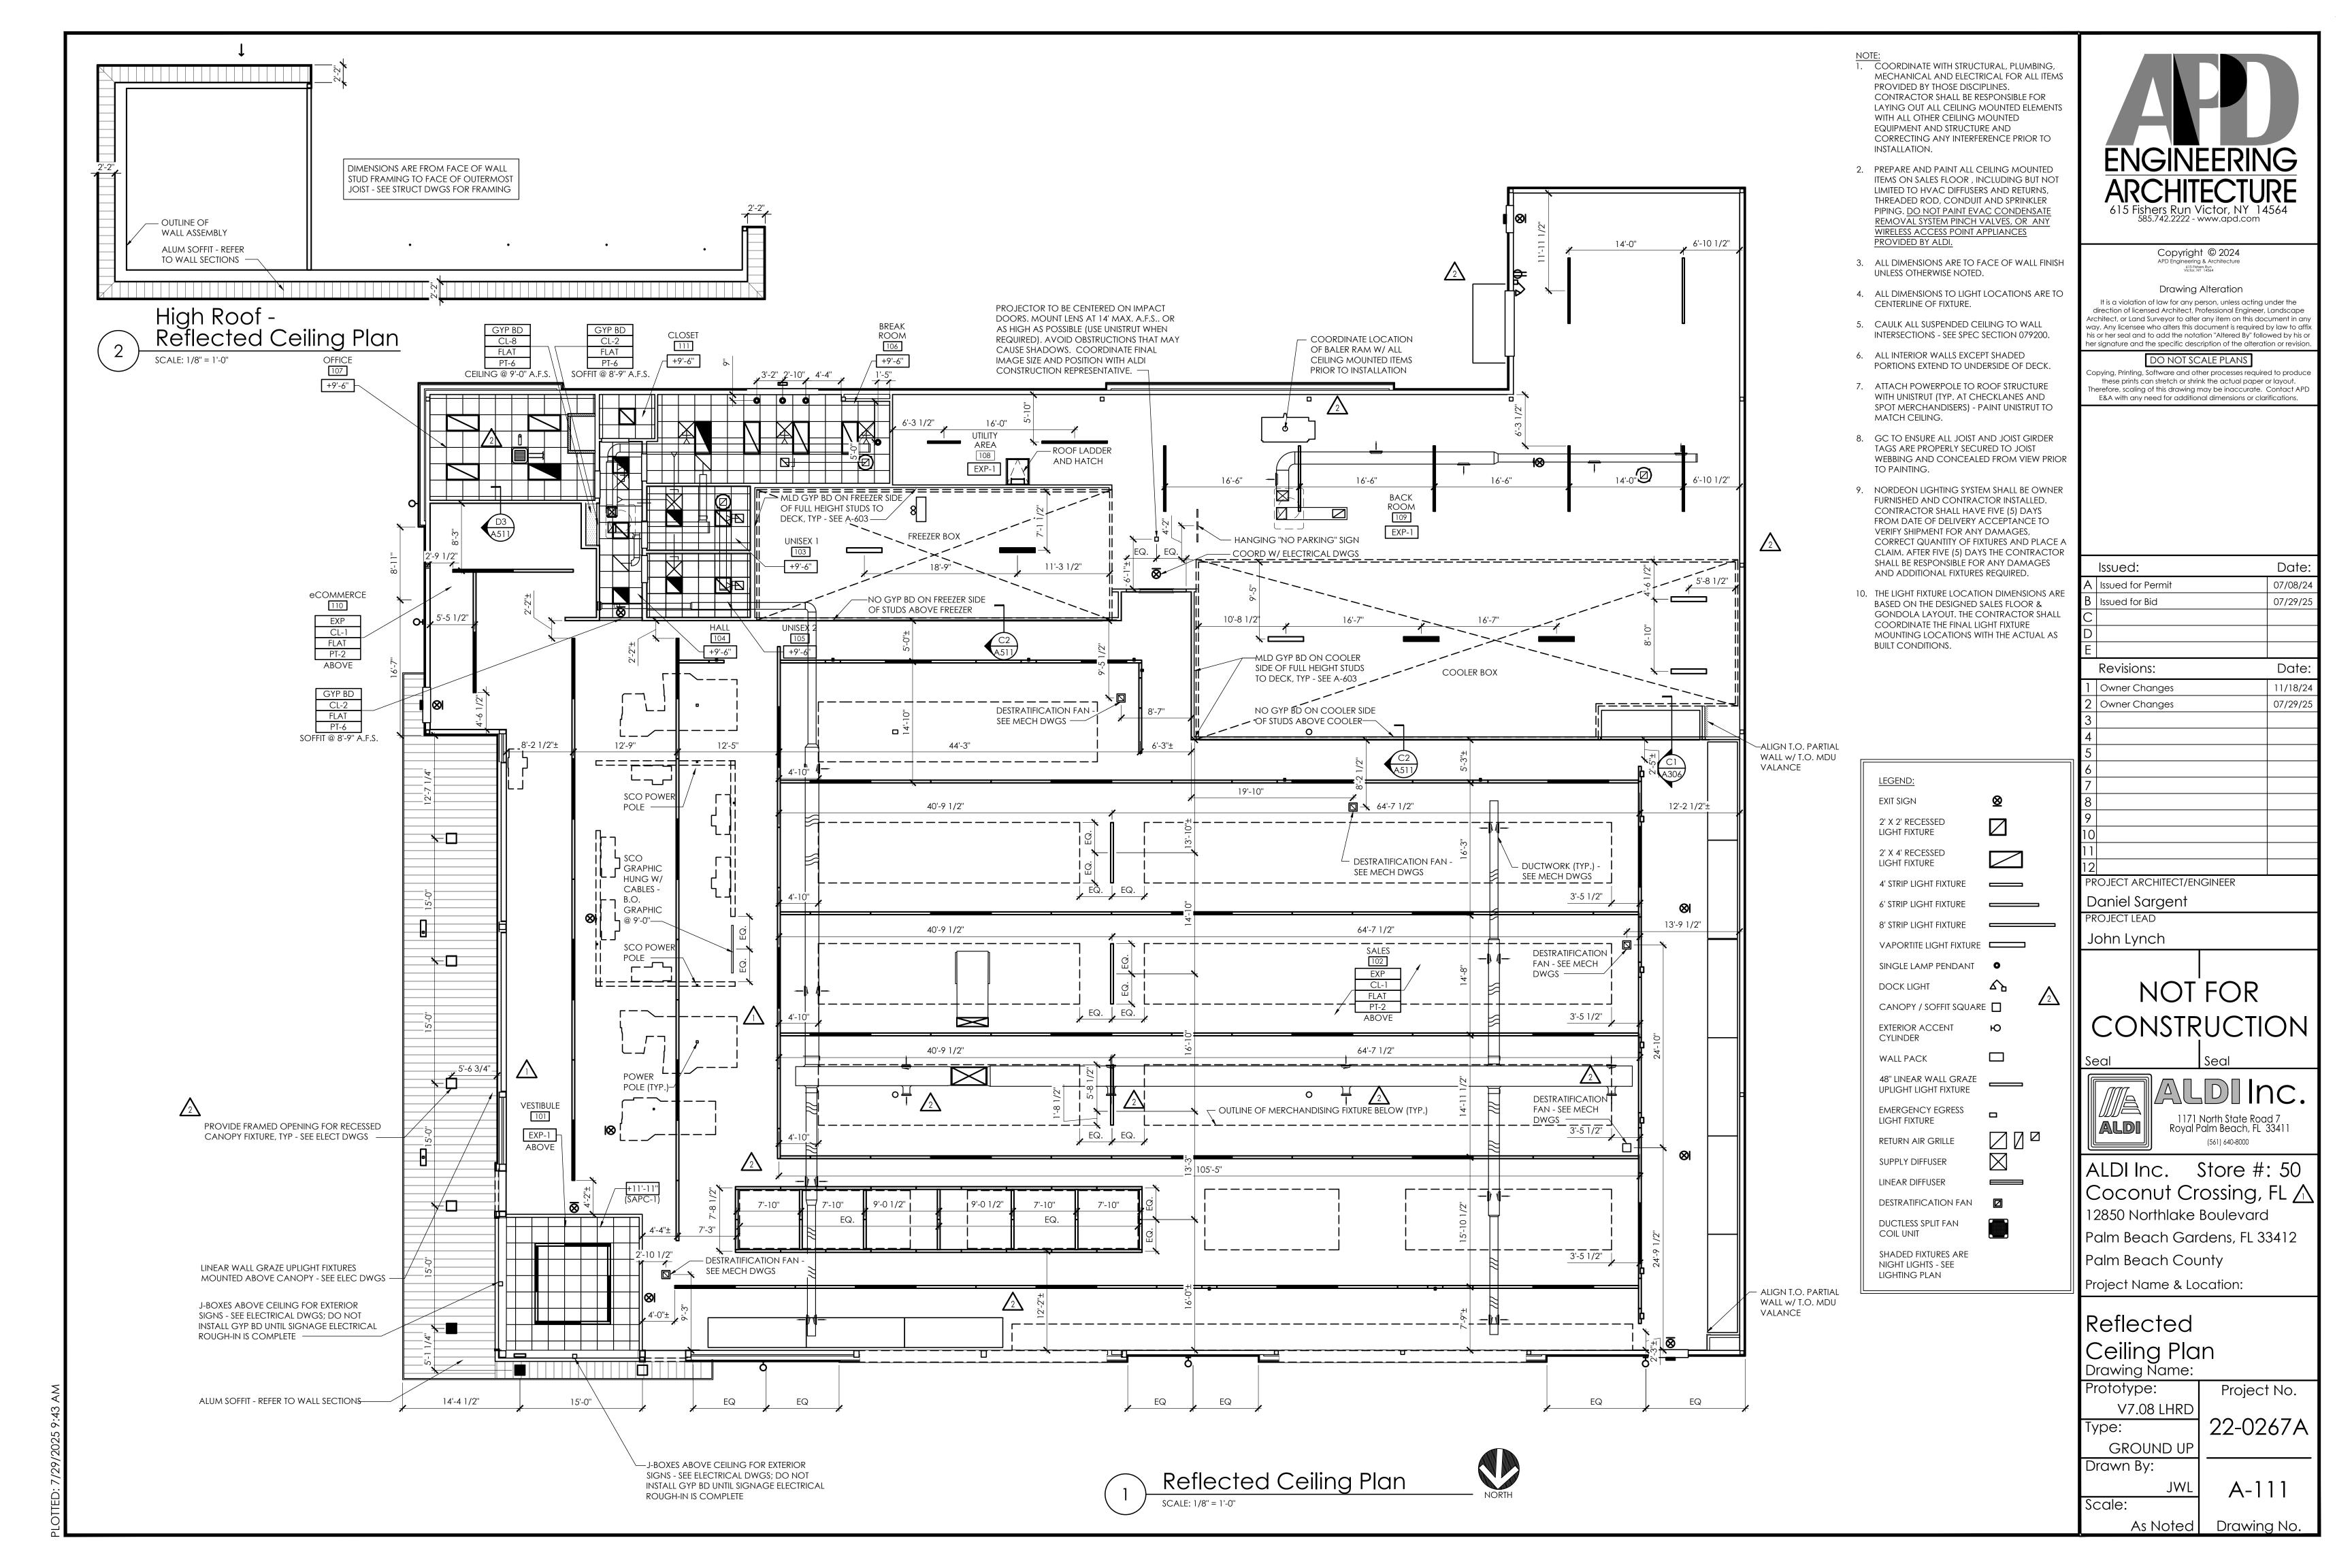
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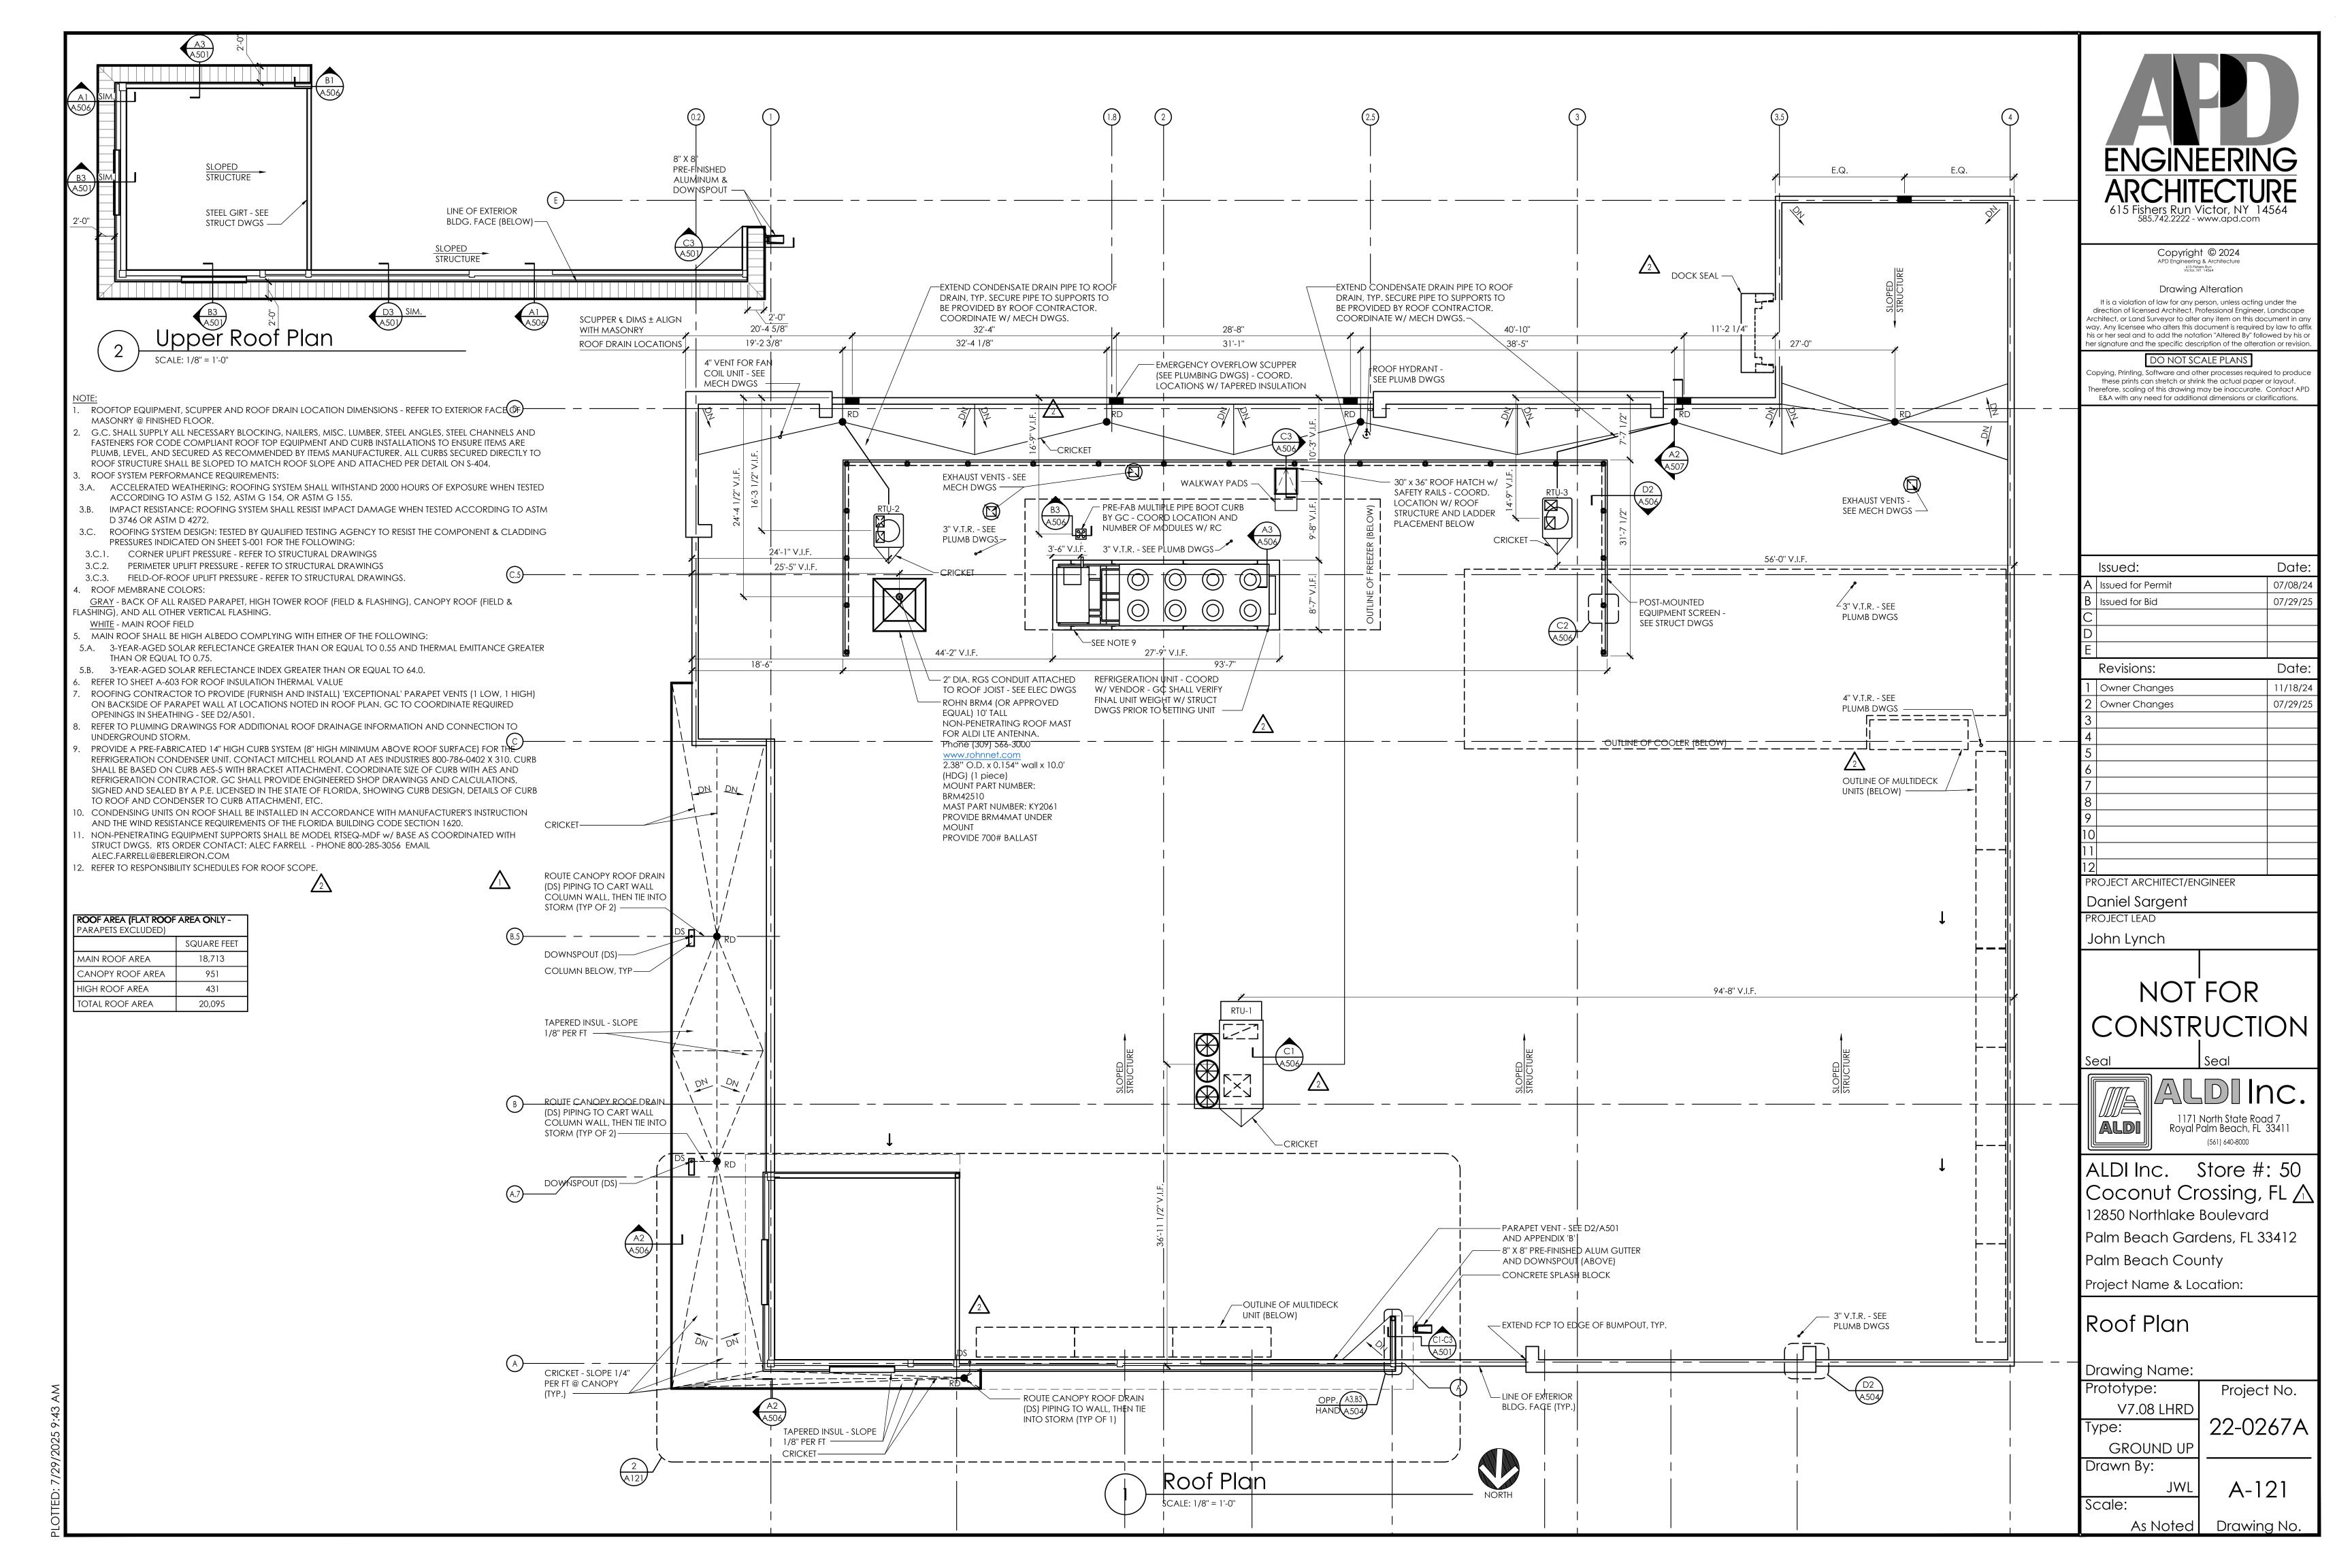
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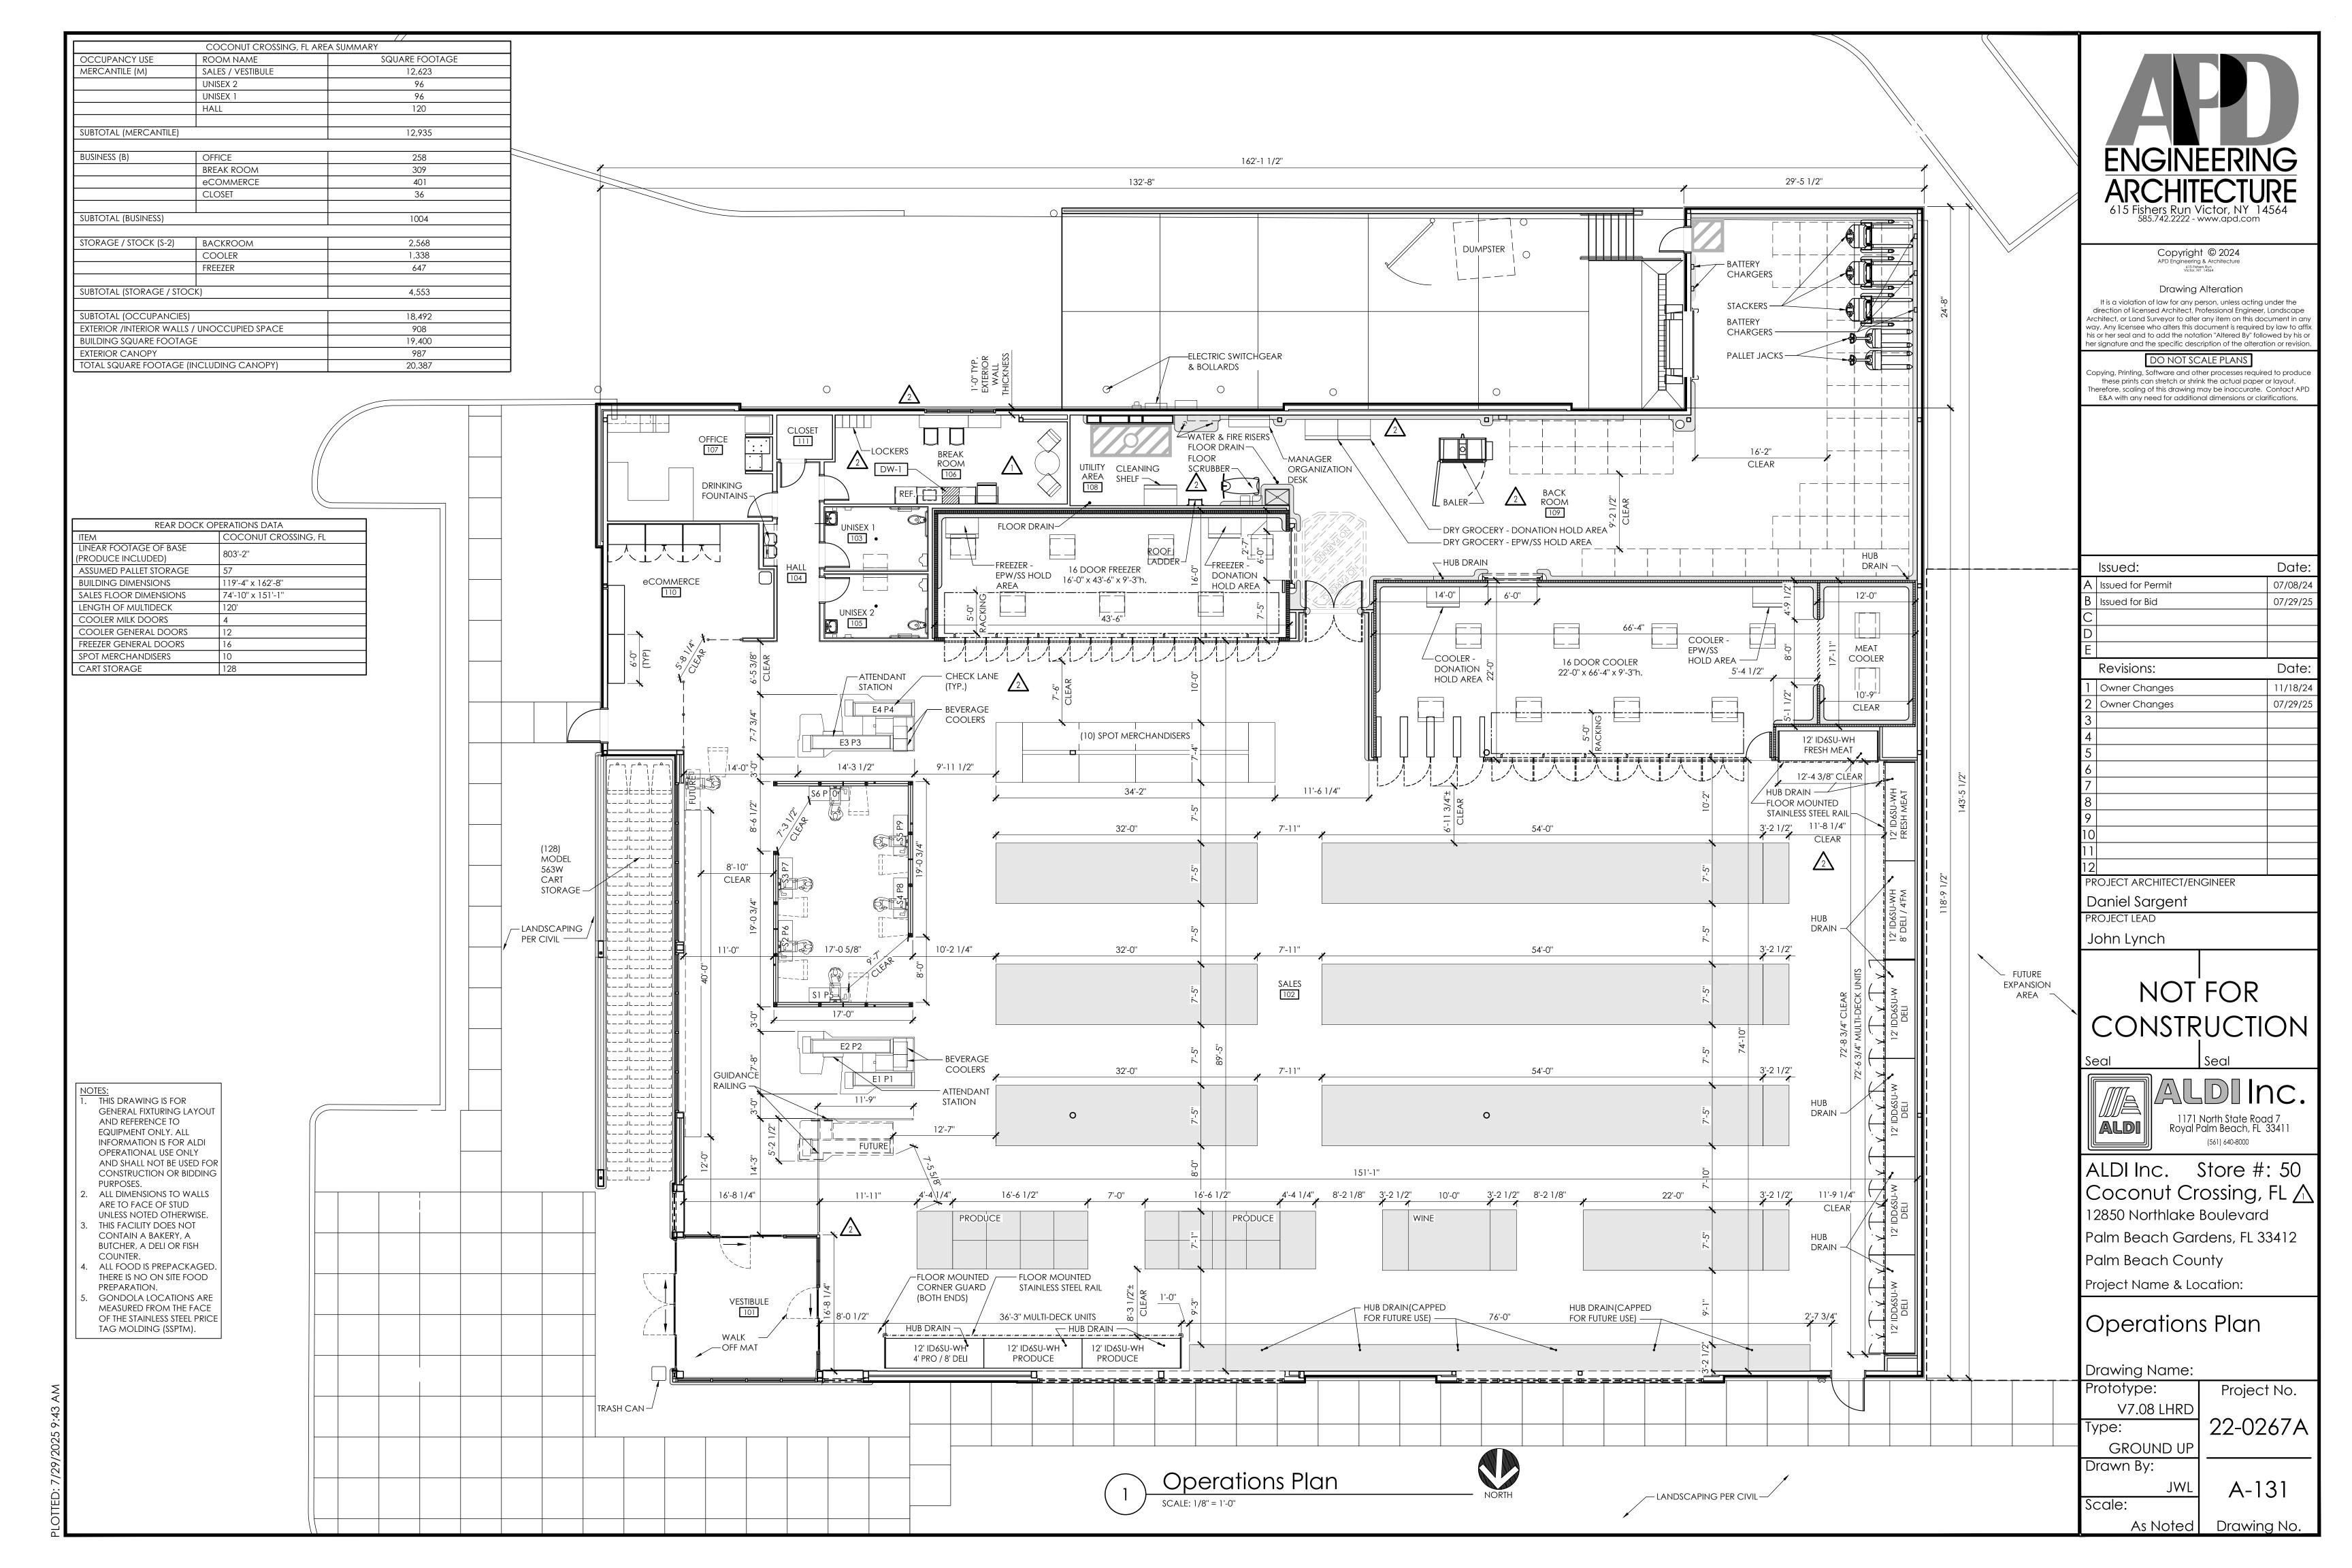
As Noted Drawing No.









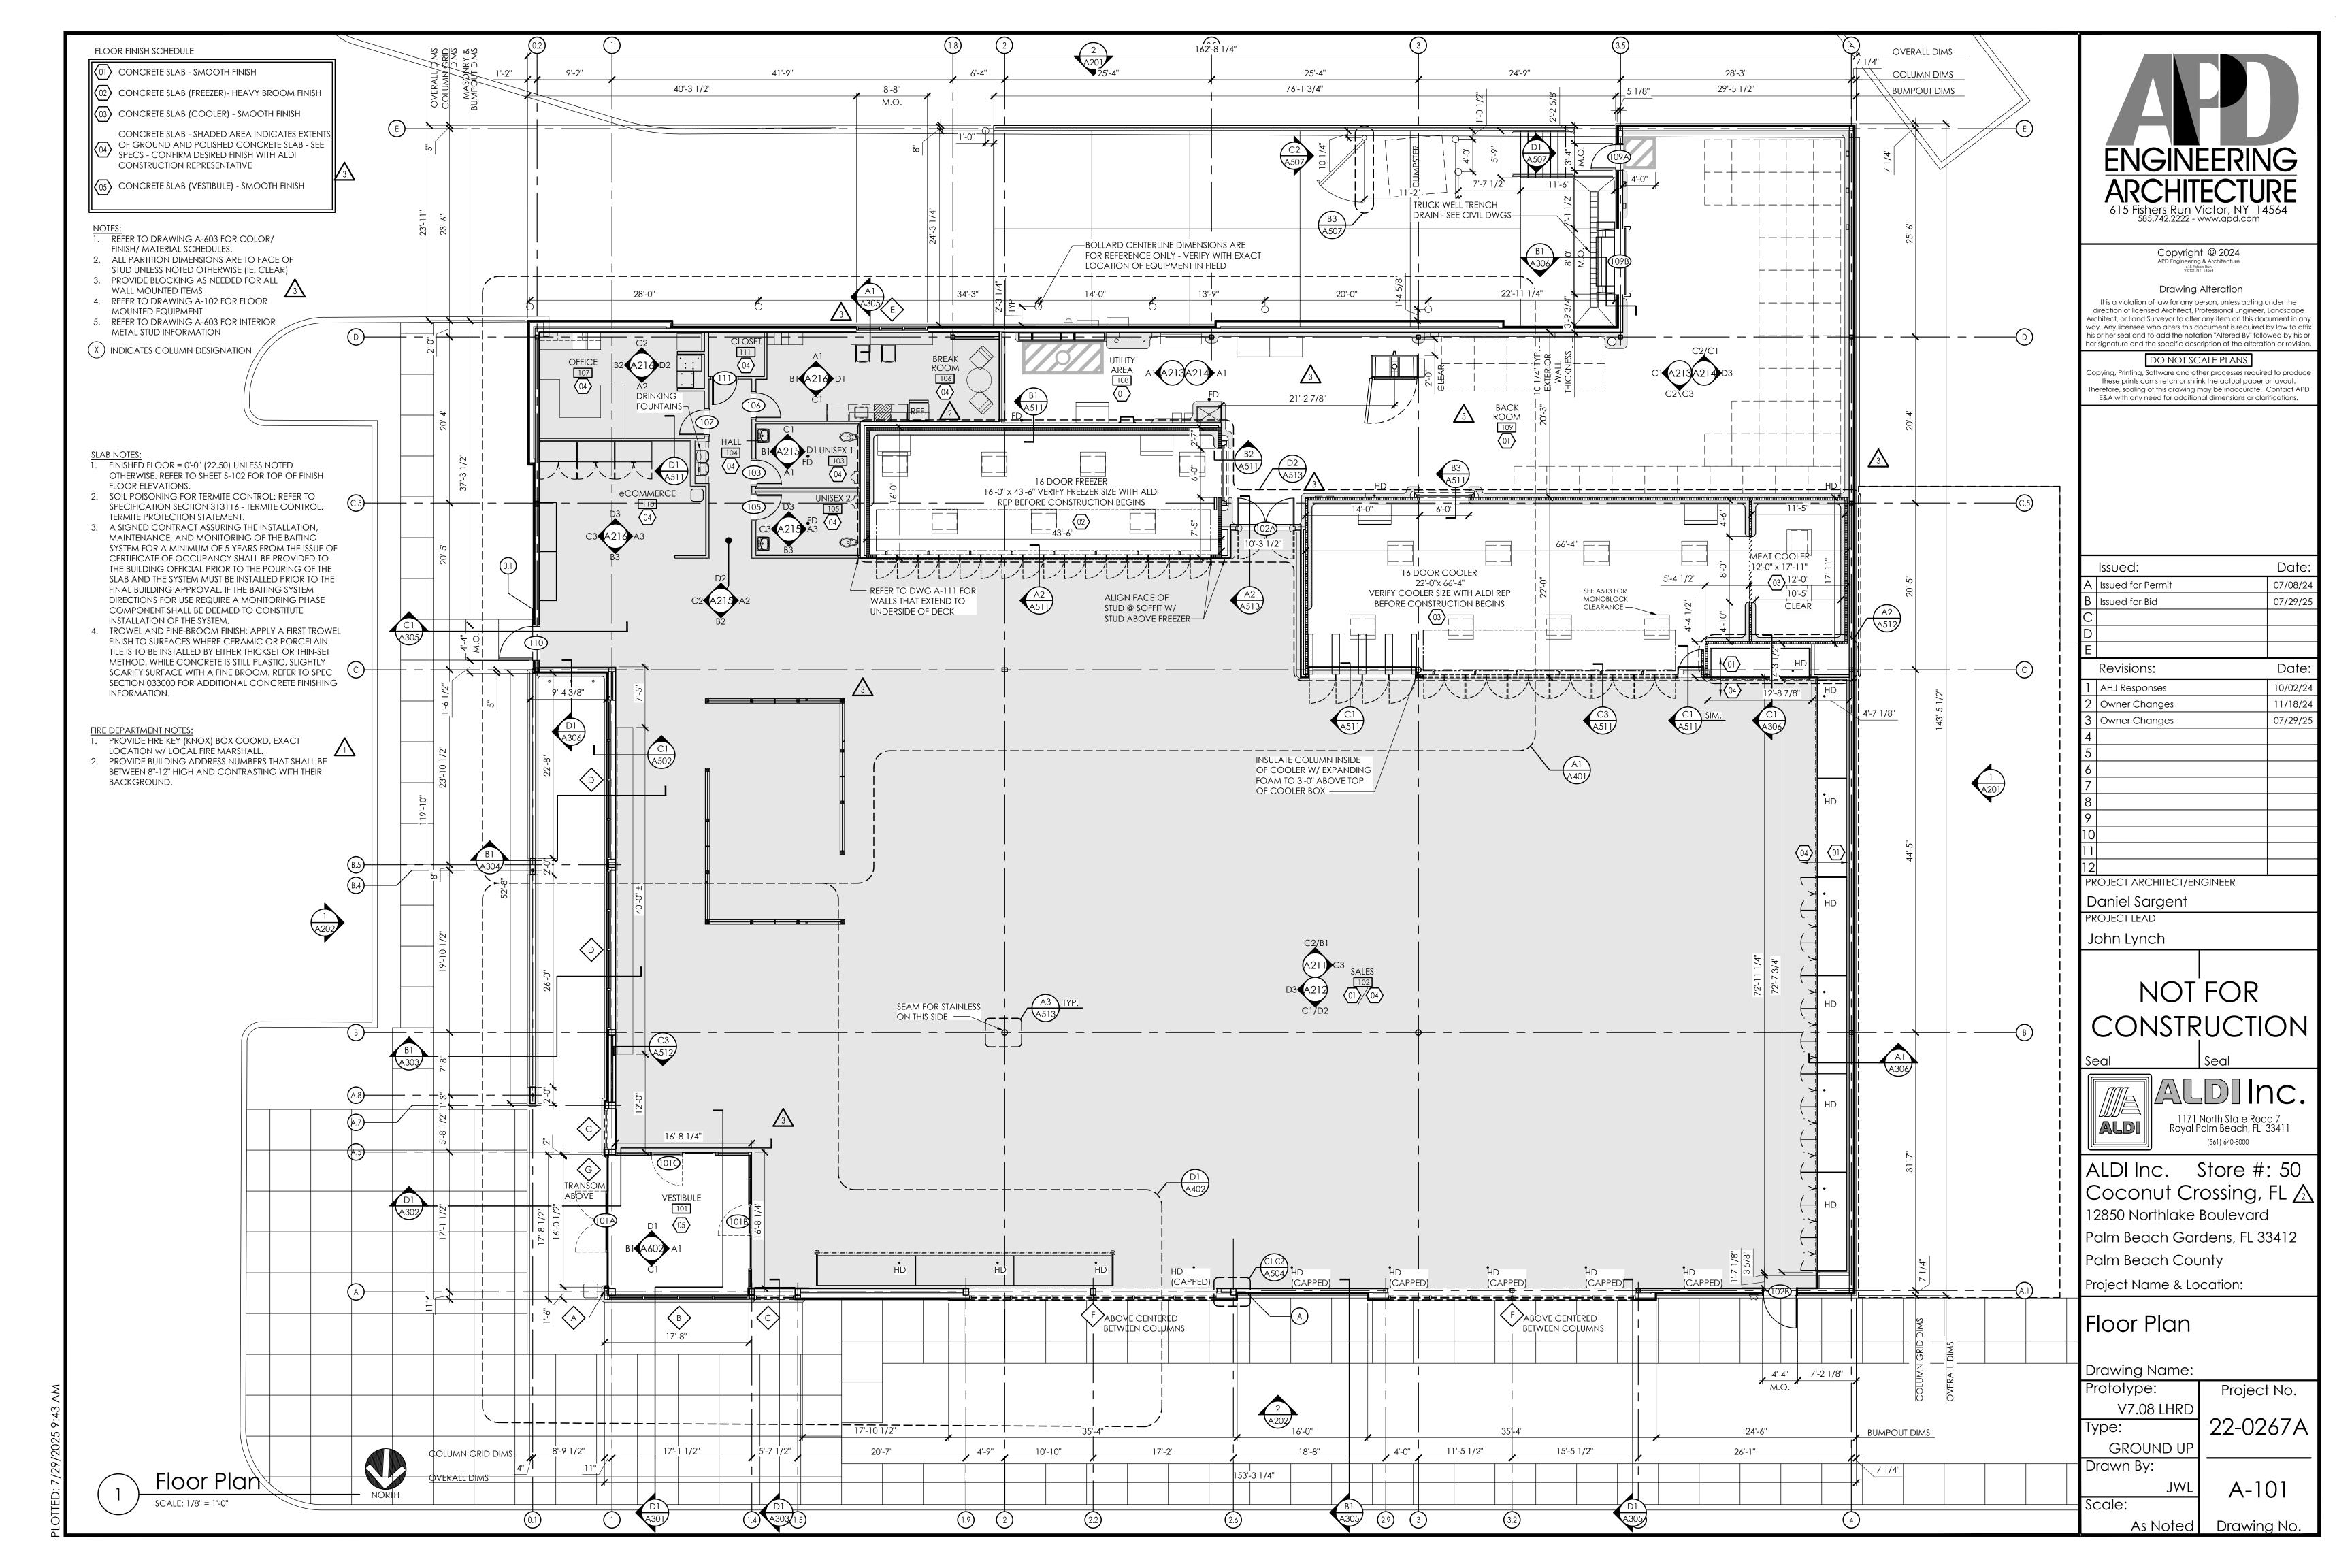

		EXTERIOR FII	NISH SCHEDULE
KEY	MATERIAL / MFG.	COLOR / NO.	NOTES
Al	PREFINISHED METAL ROOF EDGE TERMINATION	A1- SILVER - AT HIGH ROOF & CANOPY A1b - AGED BRONZE - AT NICHIHA A1c - GRANITE - AT EIFS	SEE SPECIFICATIONS APPENDIX 'B'
(A2)	MASONRY STONE VENEER (MSV) / BORAL CULTURED STONE	PROFIT LEDGESTONE - SOUTHWEST BLEND	
(A3)	PREFINISHED ALUM. SILL FLASHING	A3- BRIGHT SILVER A3a - PETERSEN ALUMINUM - 'AGED BRONZE'	SEE SPEC FOR ADDITIONAL INFO; NOTE AGED BRONZE IS CUSTOM COLOR PAINT ON POST FORMED ALUMINUM.
(A4)	ALUMINUM STOREFRONT SYSTEM	ANODIZED ALUM.	RE: DWG. A602
(A5)	MEMBRANE ROOFING	GRAY	TOP OF SLOPED ROOF, CANOPY ROOF, AND BACK OF RAISED ROOF PROJECTIONS - SEE SPECIFICATIONS APPENDIX 'B'
(A6)	METAL SOFFIT PANELS	SOLID PANELS - SILVER METALLIC	RE: DWG. A301-A304
(A7)	EXTERIOR PAINT		RE: DWG. A603
(A8)	POST MOUNTED GREEN SCREEN	FACTORY FINISH	GREEN SCREEN WELDED WIRE TRELLIS SYSTEM - SEE SPEC.
(A9)	ALUMINUM COMPOSITE PANEL	BRIGHT SILVER	PROVIDE PANEL JOINTS AS SHOWN - PROVIDE ONE PIECE TIGHT FIT EXTRUDED MOLDING INSTALLATION SYSTEM WITH CENTER REVEAL TRIM BETWEEN PANELS AND J TRIM AT PANEL EDGES.
(A10)	NICHIHA FIBER CEMENT EXTERIOR CLADDING	VINTAGEWOOD 'BARK'	CONTACT NICHIHA AT 770-805-9466 FOR ORDERING. SEE SPEC FOR TRIM REQUIREMENTS AND ADDITIONAL INFO. ALL INCLUDED TRIM ('H', 'J', 'L', CORNER, ETC) TO MATCH FCP
(A11)	BLRD-2	PT-19 / CL-4	RE: DWG A603
(A12)	BLRD-4		RE: DWG A603
(A13)	GUARD RAIL TYPE "A"	GALVANIZED STEEL	RE: DETAIL B2/A507
(A14)	GUARD RAIL TYPE "B"	GALVANIZED STEEL	RE: DETAIL B2/A507
(A15)	BLRD-3	GALVANIZED	RE: DWG A603
(A16)	DOCK LEVELER / SEAL AND BUMPERS	LEVELER - FACTORY FINISH / SEAL AND BUMPERS - FACTORY FINISH - BLACK	RE: DETAIL 9/A601 FOR CONDITION BEHIND SEAL
(A17)	MASONRY CONTROL JOINT		MAX 20' OC
(A18)	16" OVERFLOW SCUPPER	PT-19 / CL-9	RE. DWG. A2/A507
(A19)	WATER TABLE-SILL / CULTURED STONE	16"X20"X2"-2 3/4" (AT PEAK) FLAGSTONE / CHAMPAGNE	SEE SPEC FOR ADDITIONAL INFORMATION; RE: DWG B3b/A503
(A20)	ALDI TOWER SIGN	BY SIGN VENDOR	VERIFY SIGN SIZE PRIOR TO FRAMING OPENING SEE DETAIL B2/A505
(A21)	CRTB	NATURAL	RE: DWG A603 - SEE STRUCTURAL DWGS
(A22)	KNOX BOX	FACTORY FINISH	CONFIRM TYPE AND LOCATION WITH LOCAL FIRE MARSHAL
(A23)	AUTO DOOR SYSTEM & TRANSOM	ANODIZED ALUMINUM	RE. DWG A601 & A602

SIGNAGE

DESCRIPTION

NORTH TOWER SIGN

EAST TOWER SIGN

TOTAL SIGNAGE


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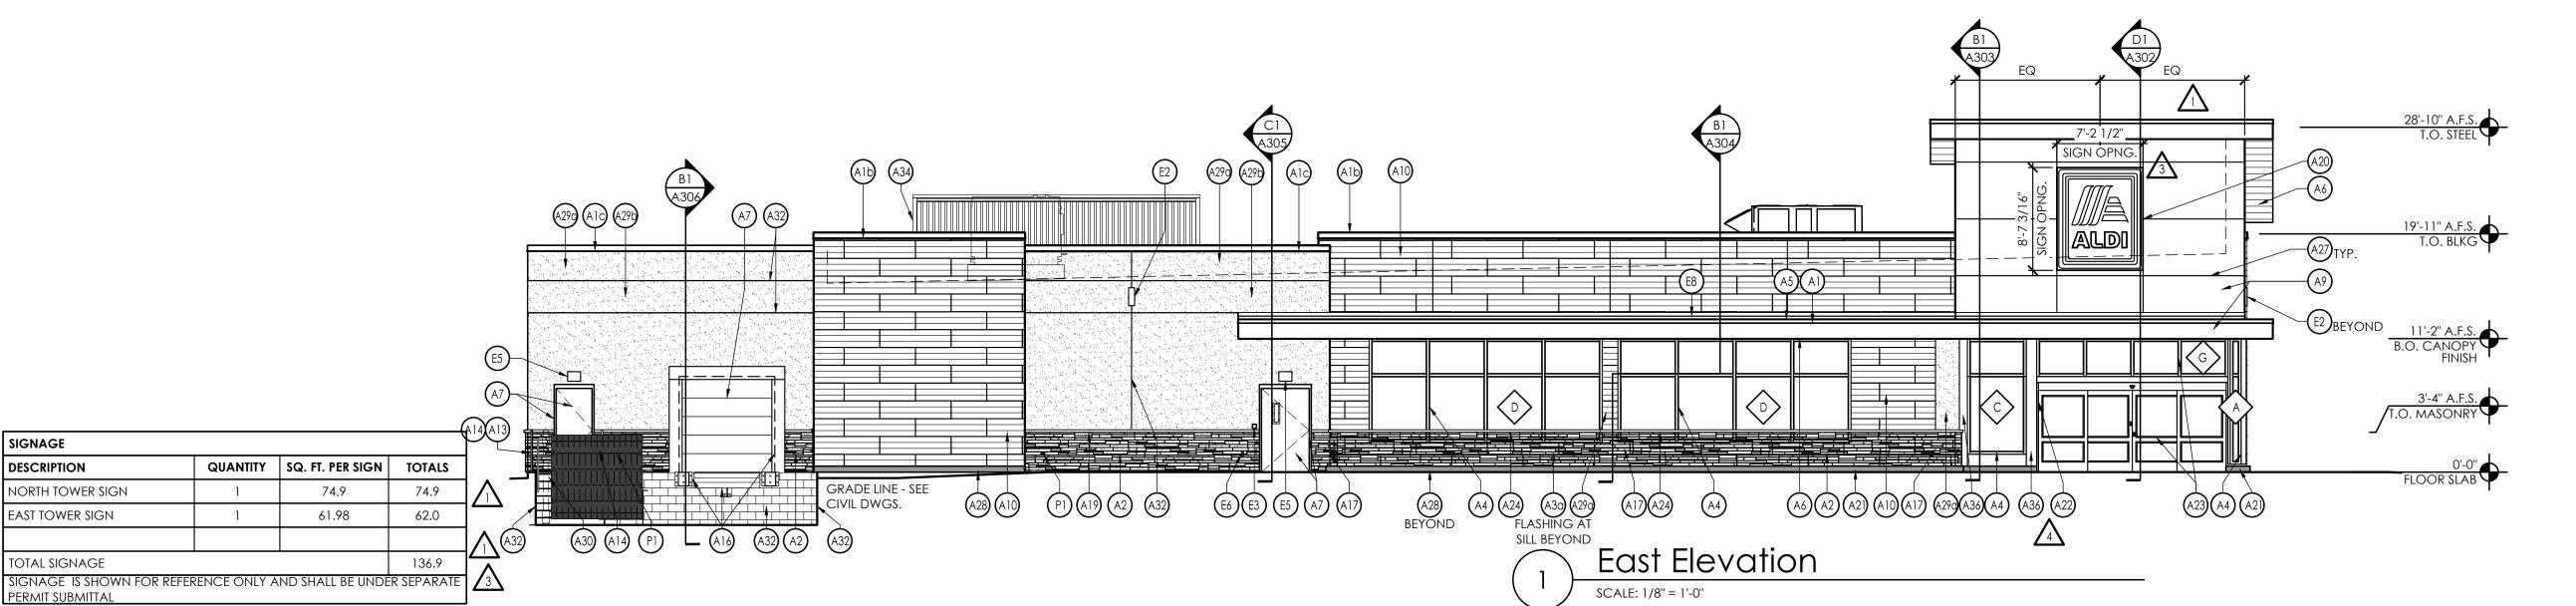
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136.9

61.98

		EXTERIOR F	INISH SCHEDULE
KEY	MATERIAL / MFG.	COLOR / NO.	NOTES
(A24)	SLOPED WALL CAP / CULTURED STONE	16"X20"X2"-2 3/4" (AT PEAK) FLAGSTONE / CHAMPAGNE	SEE SPEC FOR ADDITIONAL INFORMATION
(A25)	8" X 8" PRE-FINISHED ALUM GUTTER	MATCH PREFINISHED METAL COPING	RE: DETAIL C3/A501
(A26)	8" X 8" PRE-FINISHED ALUM DOWNSPOUT	MATCH PREFINISHED METAL COPING	RE: DETAIL C3/A501 TERMINATE AT CONC. SPLASH BLOCK
(A27)	ACP H/J TRIM / JOINT COVER		TYPICAL AT EDGES AND BUTT JOINTS OF ACP
(A28)	FIBER CEMENT PANEL BASE FLASHING	PETERSEN ALUMINUM - 'AGED BRONZE'	
(A29)	DRYVIT SYSTEMS, INC EXTERIOR INSULATION FINISH SYSTEM	A29a - MATCH DRYVIT COLOR #104 - 'DOVER SKY' A29b - MATCH DRYVIT COLOR #449 - 'BUCKSKIN'	SEE SPEC FOR ADDITIONAL INFO
(A30)	DUMPSTER GATE	CLAM SHELL	RE. DWG A507
(A31)	NICHIHA CONTROL JOINT WITH "H" CLIP		
(A32)	3/4" ESTHETIC EIFS "V" GROVE		
(A33)	EIFS EXPANSION JOINT		MAX 75' OC
(A34)	MECHANICAL SCREEN	PT-19 / PAINT COLOR TO MATCH DRYVIT COLOR #104 DOVER SKY	SEE STRUCT DWGS
(A35)	SMOOTH FACE CMU		PROVIDE SMOOTH FACE CMU FROM FINISHED FLOOR TO FOOTING INSIDE FULL INSIDE PERIMETER OF TRUCK WELL
(A36)	ALUMINUM BRAKE METAL CLOSURE	ANODIZED ALUM.	RE. DWG. A505
El	NOT USED		
E2	WALL SCONCE	FACTORY FINISH	MOUNT @ 14'-8" A.F.S.; RE: DWG. A111 FOR DIMENSIONS
E3	JUNCTION BOX WITH COVER FOR FUTURE CARD READER		MOUNT CENTERED @ 46" A.F.S., SEE ELEC DWGS
E4	UTILITY METERING & C.T.	FACTORY FINISH	SEE ELECTRICAL DWGS
(E5)	EXTERIOR WALL PACK	FACTORY FINISH	MAN DOORS - MOUNT @ 8'-0" A.F.S., BREAK ROOM WINDOW @ 10'-0" A.F.S. TRUCK WELL - MOUNT @ 12'-0" A.F.S. (SIDE DOCK ONLY)
<u>E6</u>	EXTERIOR DUPLEX RECEPTACLE	FACTORY FINISH	MOUNT @ 1'-6" A.F.S. IN 4" SQUARE J-BOX
E7	GENERATOR QUICK CONNNECT	FACTORY FINISH	SEE ELECT DWGS
Fl	MOTOR GONG	FACTORY FINISH	SEE FIRE PROTECTION DWGS
Pl	HOSE BIB	FACTORY FINISH	SEE PLUMBING DWGS
XX	GLAZING KEY		RE: DWG A602
VXX	ALIGN KEY		A: ALIGN NICHIHA PANEL JOINTS AND WINDOW MULLIONS B: ALIGN ALUMINUM COMPOSITE PANEL JOINTS AND NICHIHA PANEL JOINTS C: ALIGN NICHIHA PANEL JOINTS, ALUMINUM COMPOSITE PANEL JOINTS, AND WINDOW MULLIONS





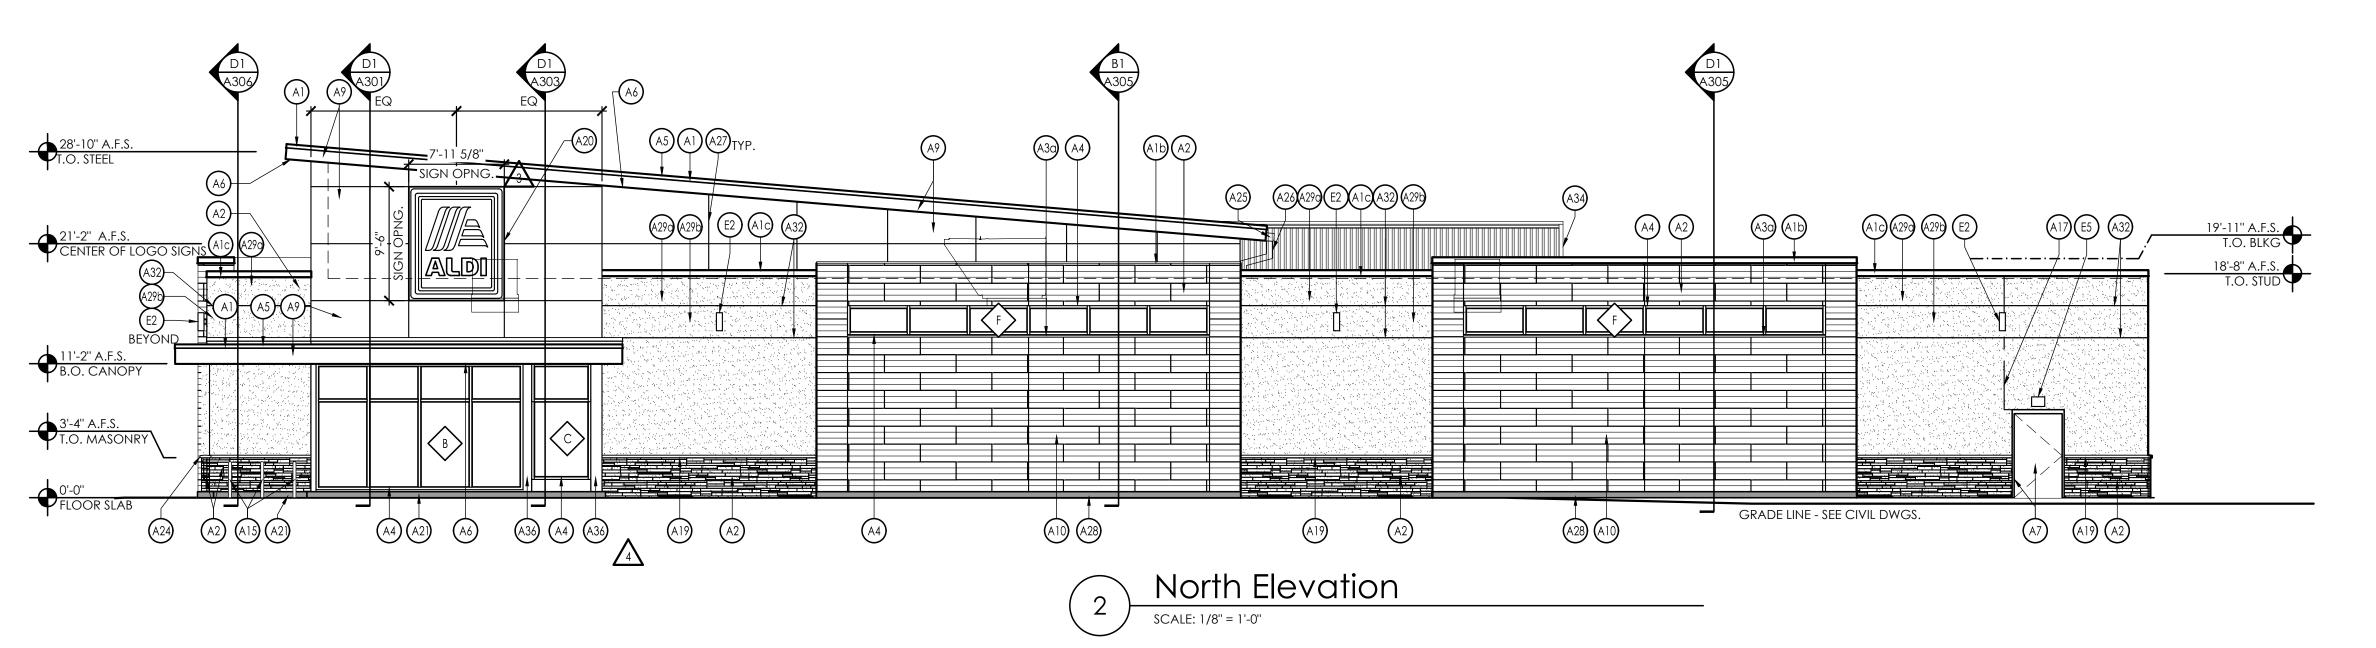

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ALDI Inc.

Daniel Sargent
PROJECT LEAD

John Lynch

1171 North State Road 7 Royal Palm Beach, FL 33411

Store #: 50

Coconut Crossing, FL 🛕 12850 Northlake Boulevard

Palm Beach Gardens, FL 33412 Palm Beach County

Project Name & Location:

Exterior Elevations

Drawing Name:
Prototype: Project No.

V7.08 LHRD GROUND UP

Drawn By: Scale:

A-201

22-0267A

As Noted Drawing No.

		EXTERIOR FIR	NISH SCHEDULE
KEY	MATERIAL / MFG.	COLOR / NO.	NOTES
Al	PREFINISHED METAL ROOF EDGE TERMINATION	A1- SILVER - AT HIGH ROOF & CANOPY A1b - AGED BRONZE - AT NICHIHA A1c - GRANITE - AT EIFS	SEE SPECIFICATIONS APPENDIX 'B'
(A2)	MASONRY STONE VENEER (MSV) / BORAL CULTURED STONE	PROFIT LEDGESTONE - SOUTHWEST BLEND	
(A3)	PREFINISHED ALUM. SILL FLASHING	A3- BRIGHT SILVER A3a - PETERSEN ALUMINUM - 'AGED BRONZE'	SEE SPEC FOR ADDITIONAL INFO; NOTE AGED BRONZE IS CUSTOM COLOR PAINT ON POST FORMED ALUMINUM.
(A4)	ALUMINUM STOREFRONT SYSTEM	ANODIZED ALUM.	RE: DWG. A602
(A5)	MEMBRANE ROOFING	GRAY	TOP OF SLOPED ROOF, CANOPY ROOF, AND BACK OF RAISED ROOF PROJECTIONS - SEE SPECIFICATIONS APPENDIX 'B'
(A6)	METAL SOFFIT PANELS	SOLID PANELS - SILVER METALLIC	RE: DWG. A301-A304
(A7)	EXTERIOR PAINT		RE: DWG. A603
(A8)	POST MOUNTED GREEN SCREEN	FACTORY FINISH	GREEN SCREEN WELDED WIRE TRELLIS SYSTEM - SEE SPEC.
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(A10)	NICHIHA FIBER CEMENT EXTERIOR CLADDING	VINTAGEWOOD 'BARK'	CONTACT NICHIHA AT 770-805-9466 FOR ORDERING. SEE SPEC FOR TRIM REQUIREMENTS AND ADDITIONA INFO. ALL INCLUDED TRIM ('H', 'J', 'L', CORNER, ETC) TO MATCH FCP
(A11)	BLRD-2	PT-19 / CL-4	RE: DWG A603
(A12)	BLRD-4		RE: DWG A603
(A13)	GUARD RAIL TYPE "A"	GALVANIZED STEEL	RE: DETAIL B2/A507
(A14)	GUARD RAIL TYPE "B"	GALVANIZED STEEL	RE: DETAIL B2/A507
(A15)	BLRD-3	GALVANIZED	RE: DWG A603
(A16)	DOCK LEVELER / SEAL AND BUMPERS	LEVELER - FACTORY FINISH / SEAL AND BUMPERS - FACTORY FINISH - BLACK	RE: DETAIL 9/A601 FOR CONDITION BEHIND SEAL
(A17)	MASONRY CONTROL JOINT		MAX 20' OC
(A18)	16" OVERFLOW SCUPPER	PT-19 / CL-9	RE. DWG. A2/A507
(A19)	WATER TABLE-SILL / CULTURED STONE	16"X20"X2"-2 3/4" (AT PEAK) FLAGSTONE / CHAMPAGNE	SEE SPEC FOR ADDITIONAL INFORMATION; RE: DWG B3b/A503
(A20)	ALDI TOWER SIGN	BY SIGN VENDOR	VERIFY SIGN SIZE PRIOR TO FRAMING OPENING SEE DETAIL B2/A505
(A21)	CRTB	NATURAL	RE: DWG A603 - SEE STRUCTURAL DWGS
(A22)	KNOX BOX	FACTORY FINISH	CONFIRM TYPE AND LOCATION WITH LOCAL FIRE MARSHAL
(A23)	auto door system & transom	ANODIZED ALUMINUM	RE. DWG A601 & A602

SIGNAGE

DESCRIPTION

NORTH TOWER SIGN

EAST TOWER SIGN

TOTAL SIGNAGE


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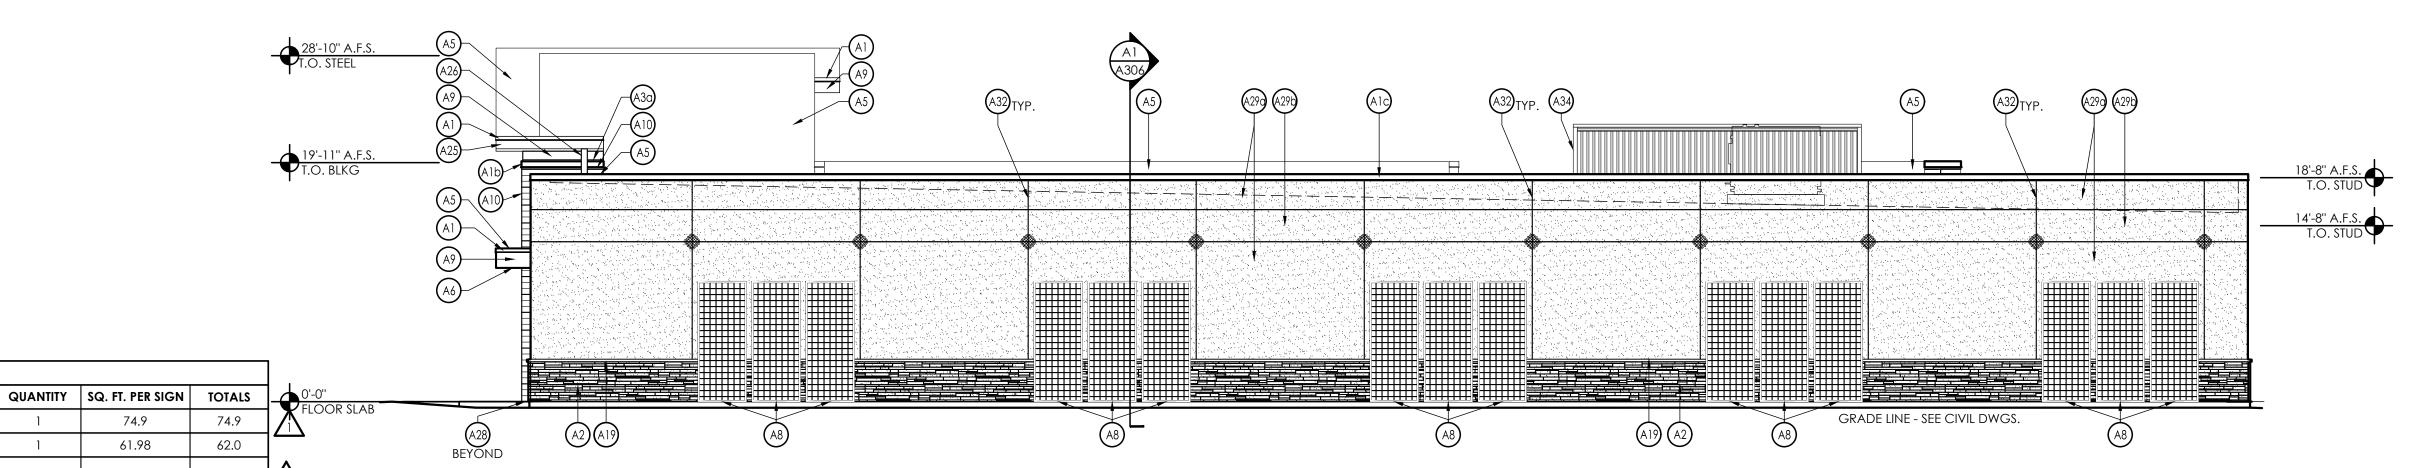
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136.9

SIGNAGE IS SHOWN FOR REFERENCE ONLY AND SHALL BE UNDER SEPARATE PERMIT SUBMITTAL

		EXTERIOR F	INISH SCHEDULE
KEY	MATERIAL / MFG.	COLOR / NO.	NOTES
(A24)	SLOPED WALL CAP / CULTURED STONE	16"X20"X2"-2 3/4" (AT PEAK) FLAGSTONE / CHAMPAGNE	SEE SPEC FOR ADDITIONAL INFORMATION
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(A26)	8" X 8" PRE-FINISHED ALUM DOWNSPOUT	MATCH PREFINISHED METAL COPING	RE: DETAIL C3/A501 TERMINATE AT CONC. SPLASH BLOCK
(A27)	ACP H/J TRIM / JOINT COVER		TYPICAL AT EDGES AND BUTT JOINTS OF ACP
(A28)	FIBER CEMENT PANEL BASE FLASHING	PETERSEN ALUMINUM - 'AGED BRONZE'	
(A29)	DRYVIT SYSTEMS, INC EXTERIOR INSULATION FINISH SYSTEM	A29a - MATCH DRYVIT COLOR #104 - 'DOVER SKY' A29b - MATCH DRYVIT COLOR #449 - 'BUCKSKIN'	SEE SPEC FOR ADDITIONAL INFO
(A30)	DUMPSTER GATE	CLAM SHELL	RE. DWG A507
A31)	NICHIHA CONTROL JOINT WITH "H" CLIP		
A32	3/4" ESTHETIC EIFS "V" GROVE		
A33	EIFS EXPANSION JOINT		MAX 75' OC
(A34)	MECHANICAL SCREEN	PT-19 / PAINT COLOR TO MATCH DRYVIT COLOR #104 DOVER SKY	SEE STRUCT DWGS
A35)	SMOOTH FACE CMU		PROVIDE SMOOTH FACE CMU FROM FINISHED FLOOR TO FOOTING INSIDE FULL INSIDE PERIMETER OF TRUCK WELL
(A36)	ALUMINUM BRAKE METAL CLOSURE	ANODIZED ALUM.	RE. DWG. A505
El	NOT USED		
E2	WALL SCONCE	FACTORY FINISH	MOUNT @ 14'-8" A.F.S.; RE: DWG. A111 FOR DIMENSIONS
E3	JUNCTION BOX WITH COVER FOR FUTURE CARD READER		MOUNT CENTERED @ 46" A.F.S., SEE ELEC DWGS
E4	UTILITY METERING & C.T.	FACTORY FINISH	SEE ELECTRICAL DWGS
E5	EXTERIOR WALL PACK	FACTORY FINISH	MAN DOORS - MOUNT @ 8'-0" A.F.S., BREAK ROOM WINDOW @ 10'-0" A.F.S. TRUCK WELL - MOUNT @ 12'-0" A.F.S. (SIDE DOCK ONLY)
<u>E6</u>	EXTERIOR DUPLEX RECEPTACLE	FACTORY FINISH	MOUNT @ 1'-6" A.F.S. IN 4" SQUARE J-BOX
E7	GENERATOR QUICK CONNNECT	FACTORY FINISH	SEE ELECT DWGS
Fl	MOTOR GONG	FACTORY FINISH	SEE FIRE PROTECTION DWGS
Pl	HOSE BIB	FACTORY FINISH	SEE PLUMBING DWGS
XX	GLAZING KEY		RE: DWG A602
VXX/	ALIGN KEY		A: ALIGN NICHIHA PANEL JOINTS AND WINDOW MULLIONS B: ALIGN ALUMINUM COMPOSITE PANEL JOINTS AND NICHIHA PANEL JOINTS C: ALIGN NICHIHA PANEL JOINTS, ALUMINUM COMPOSITE PANEL JOINTS, AND WINDOW MULLIONS



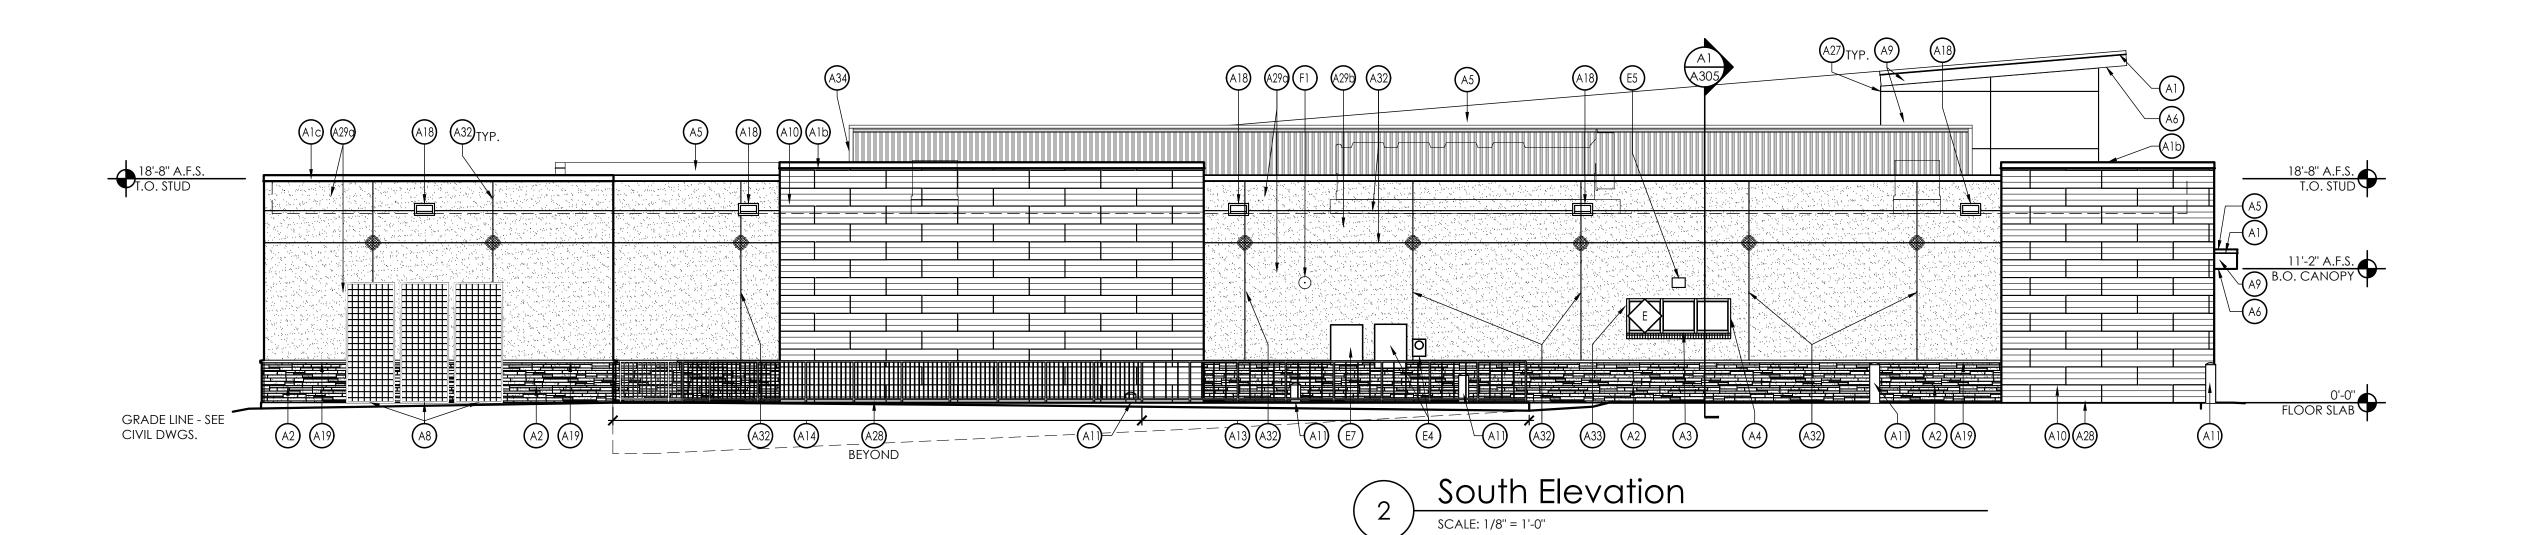

West Elevation

SCALE: 1/8" = 1'-0"

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3	AHJ Responses	12/2
4	Owner Changes	07/2
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ALDI Inc.

Daniel Sargent

PROJECT LEAD

John Lynch

1171 North State Road 7 Royal Palm Beach, FL 33411

Store #: 50

Coconut Crossing, FL 🛕 12850 Northlake Boulevard

Palm Beach Gardens, FL 33412 Palm Beach County

Project Name & Location:

Exterior Elevations Drawing Name:


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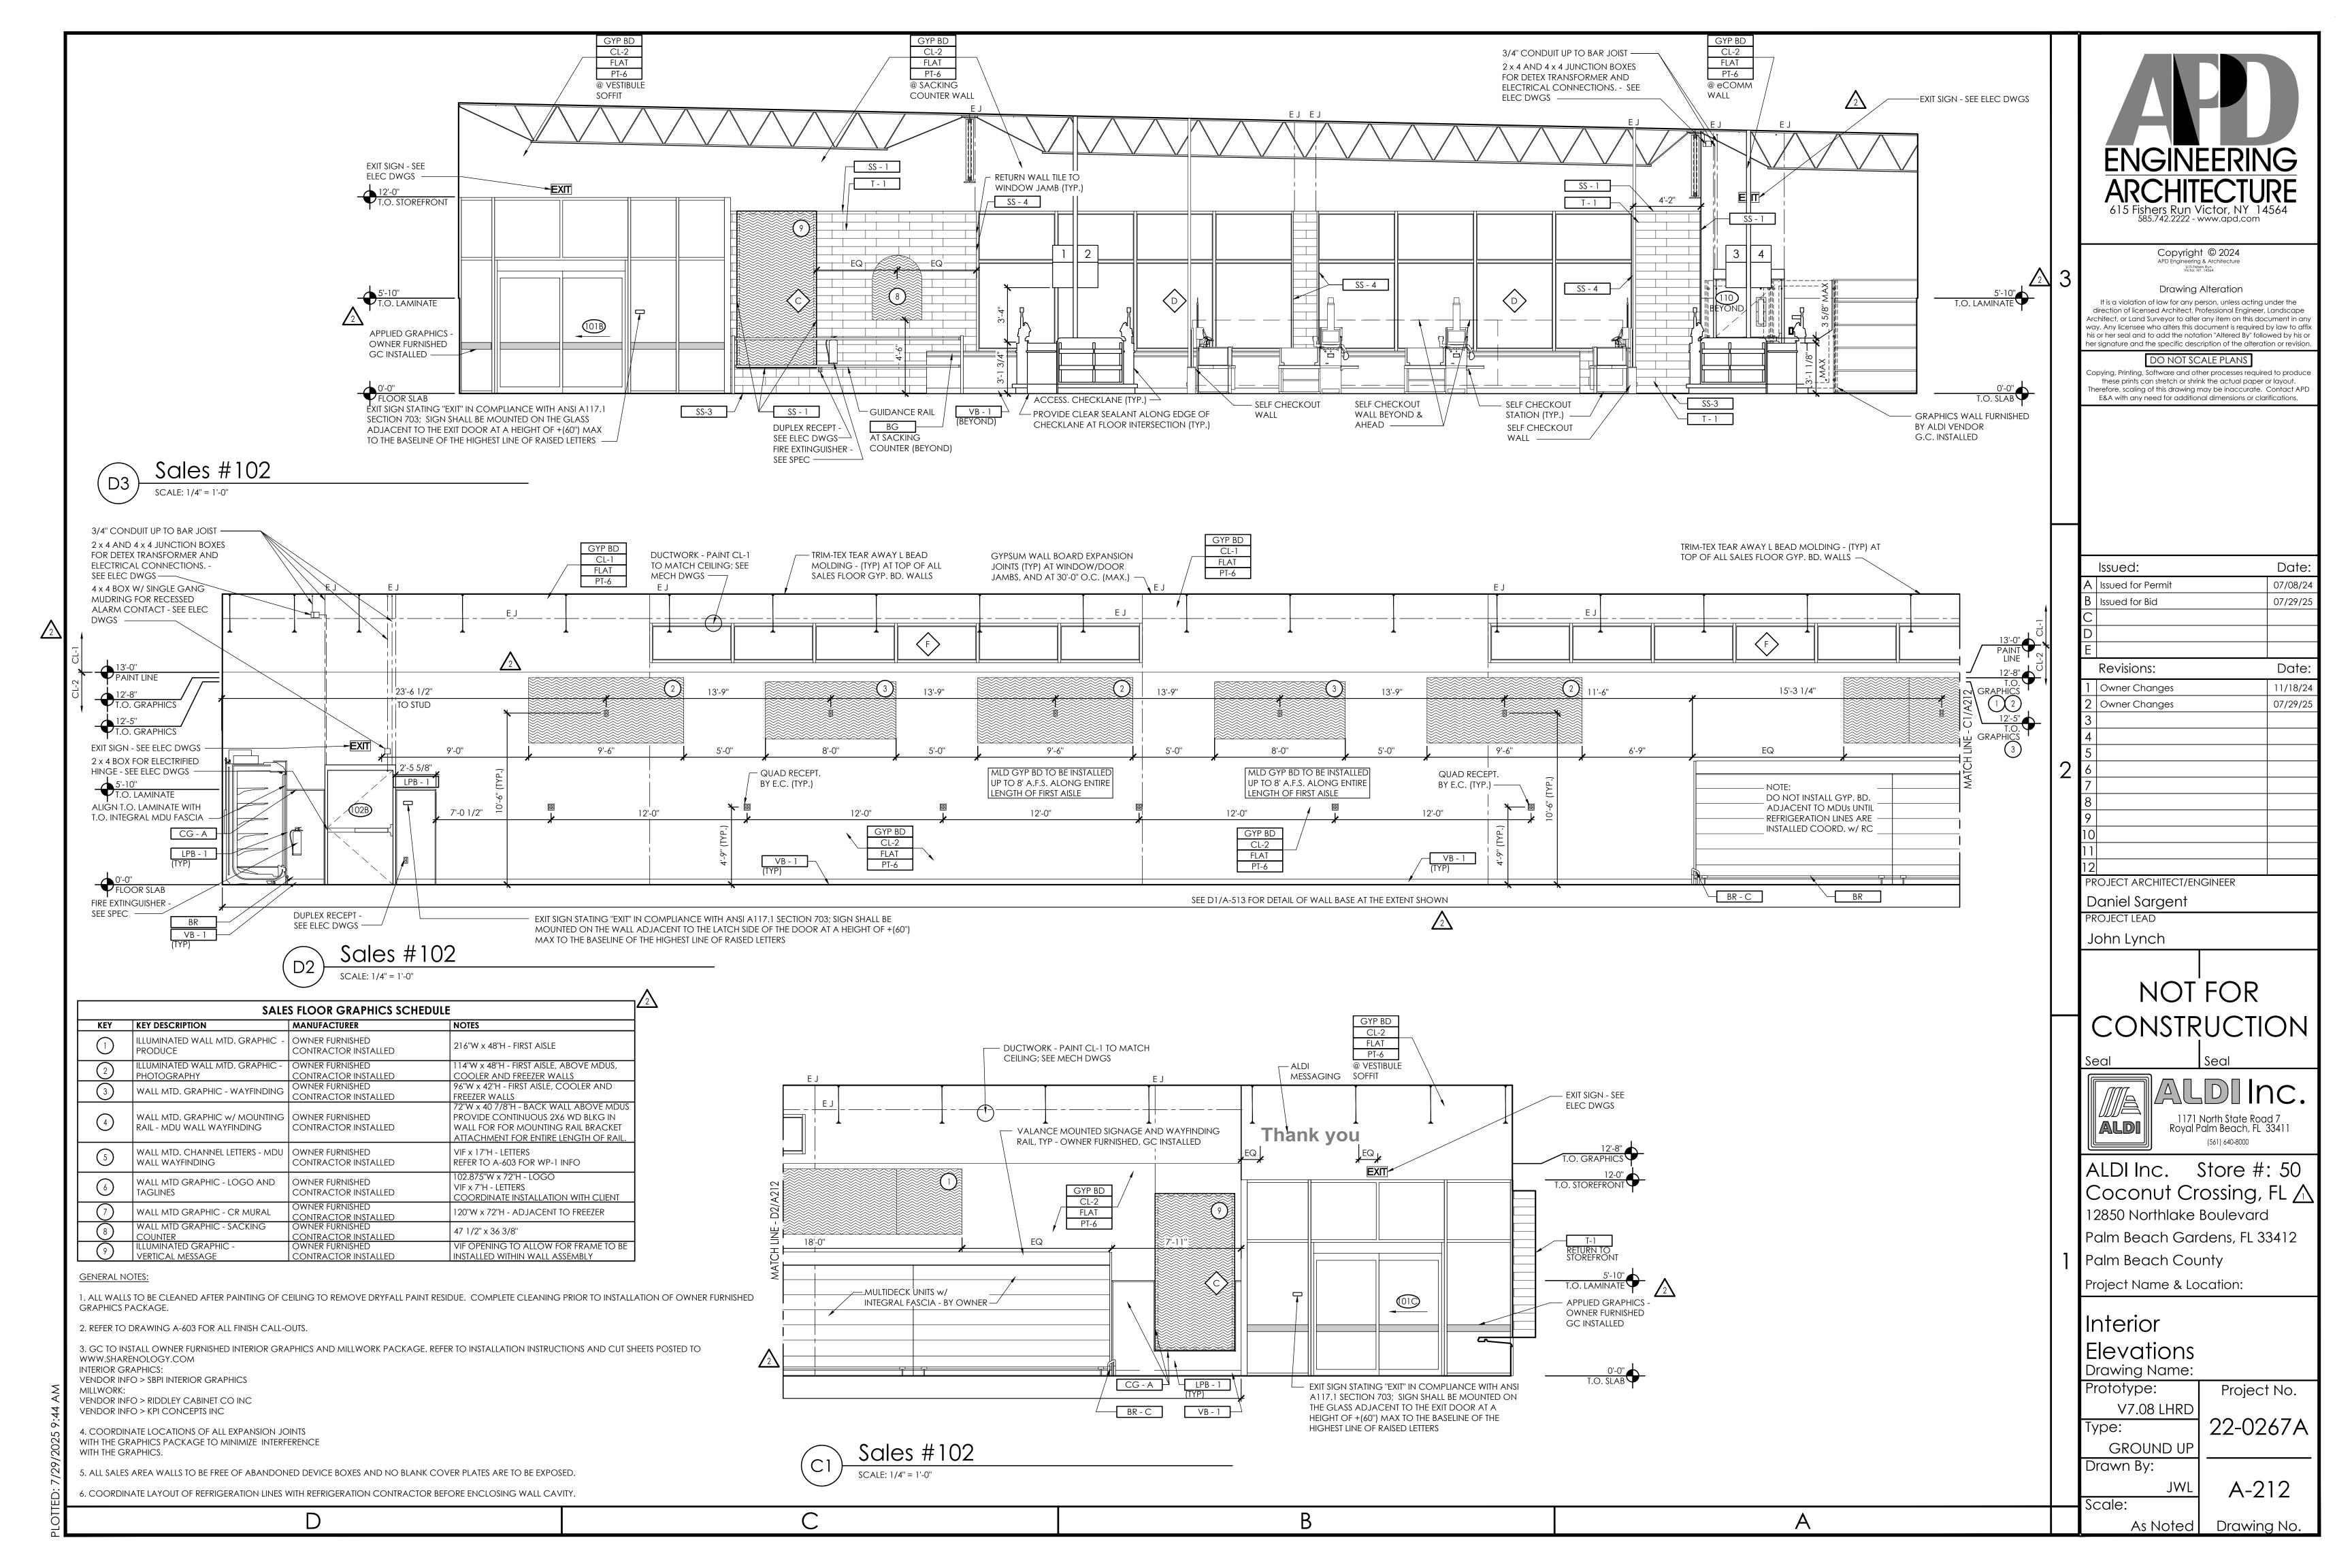
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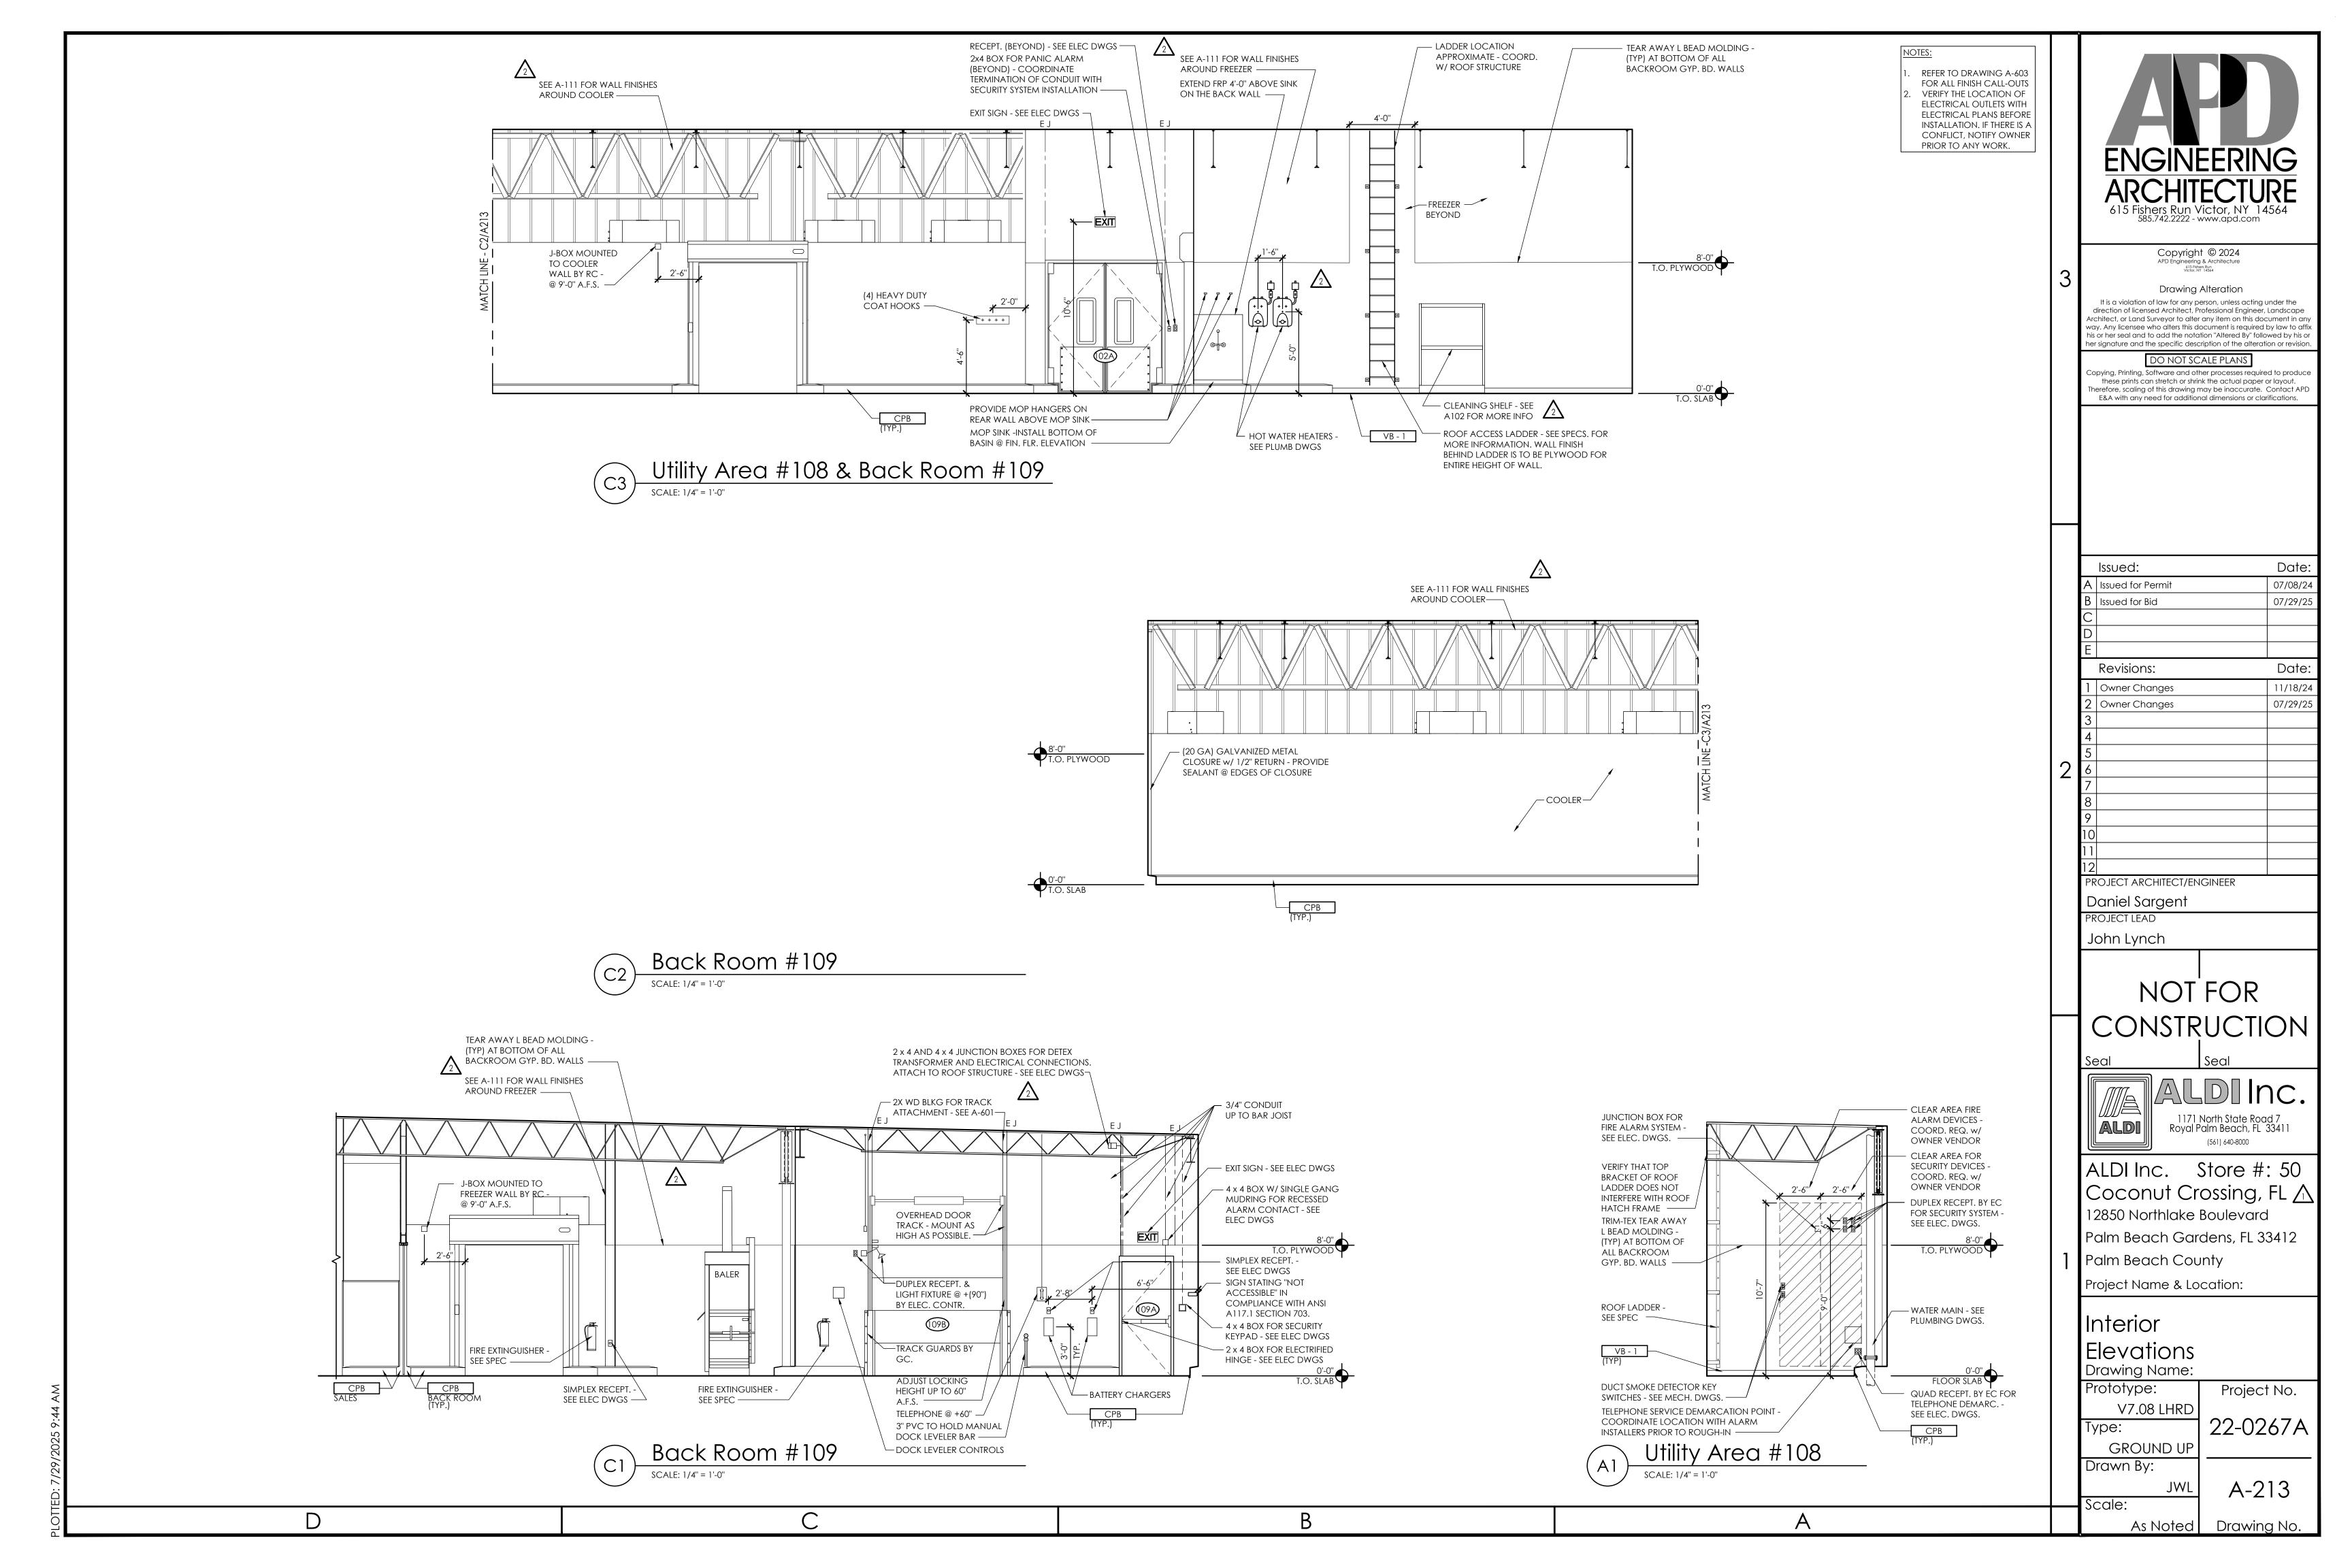
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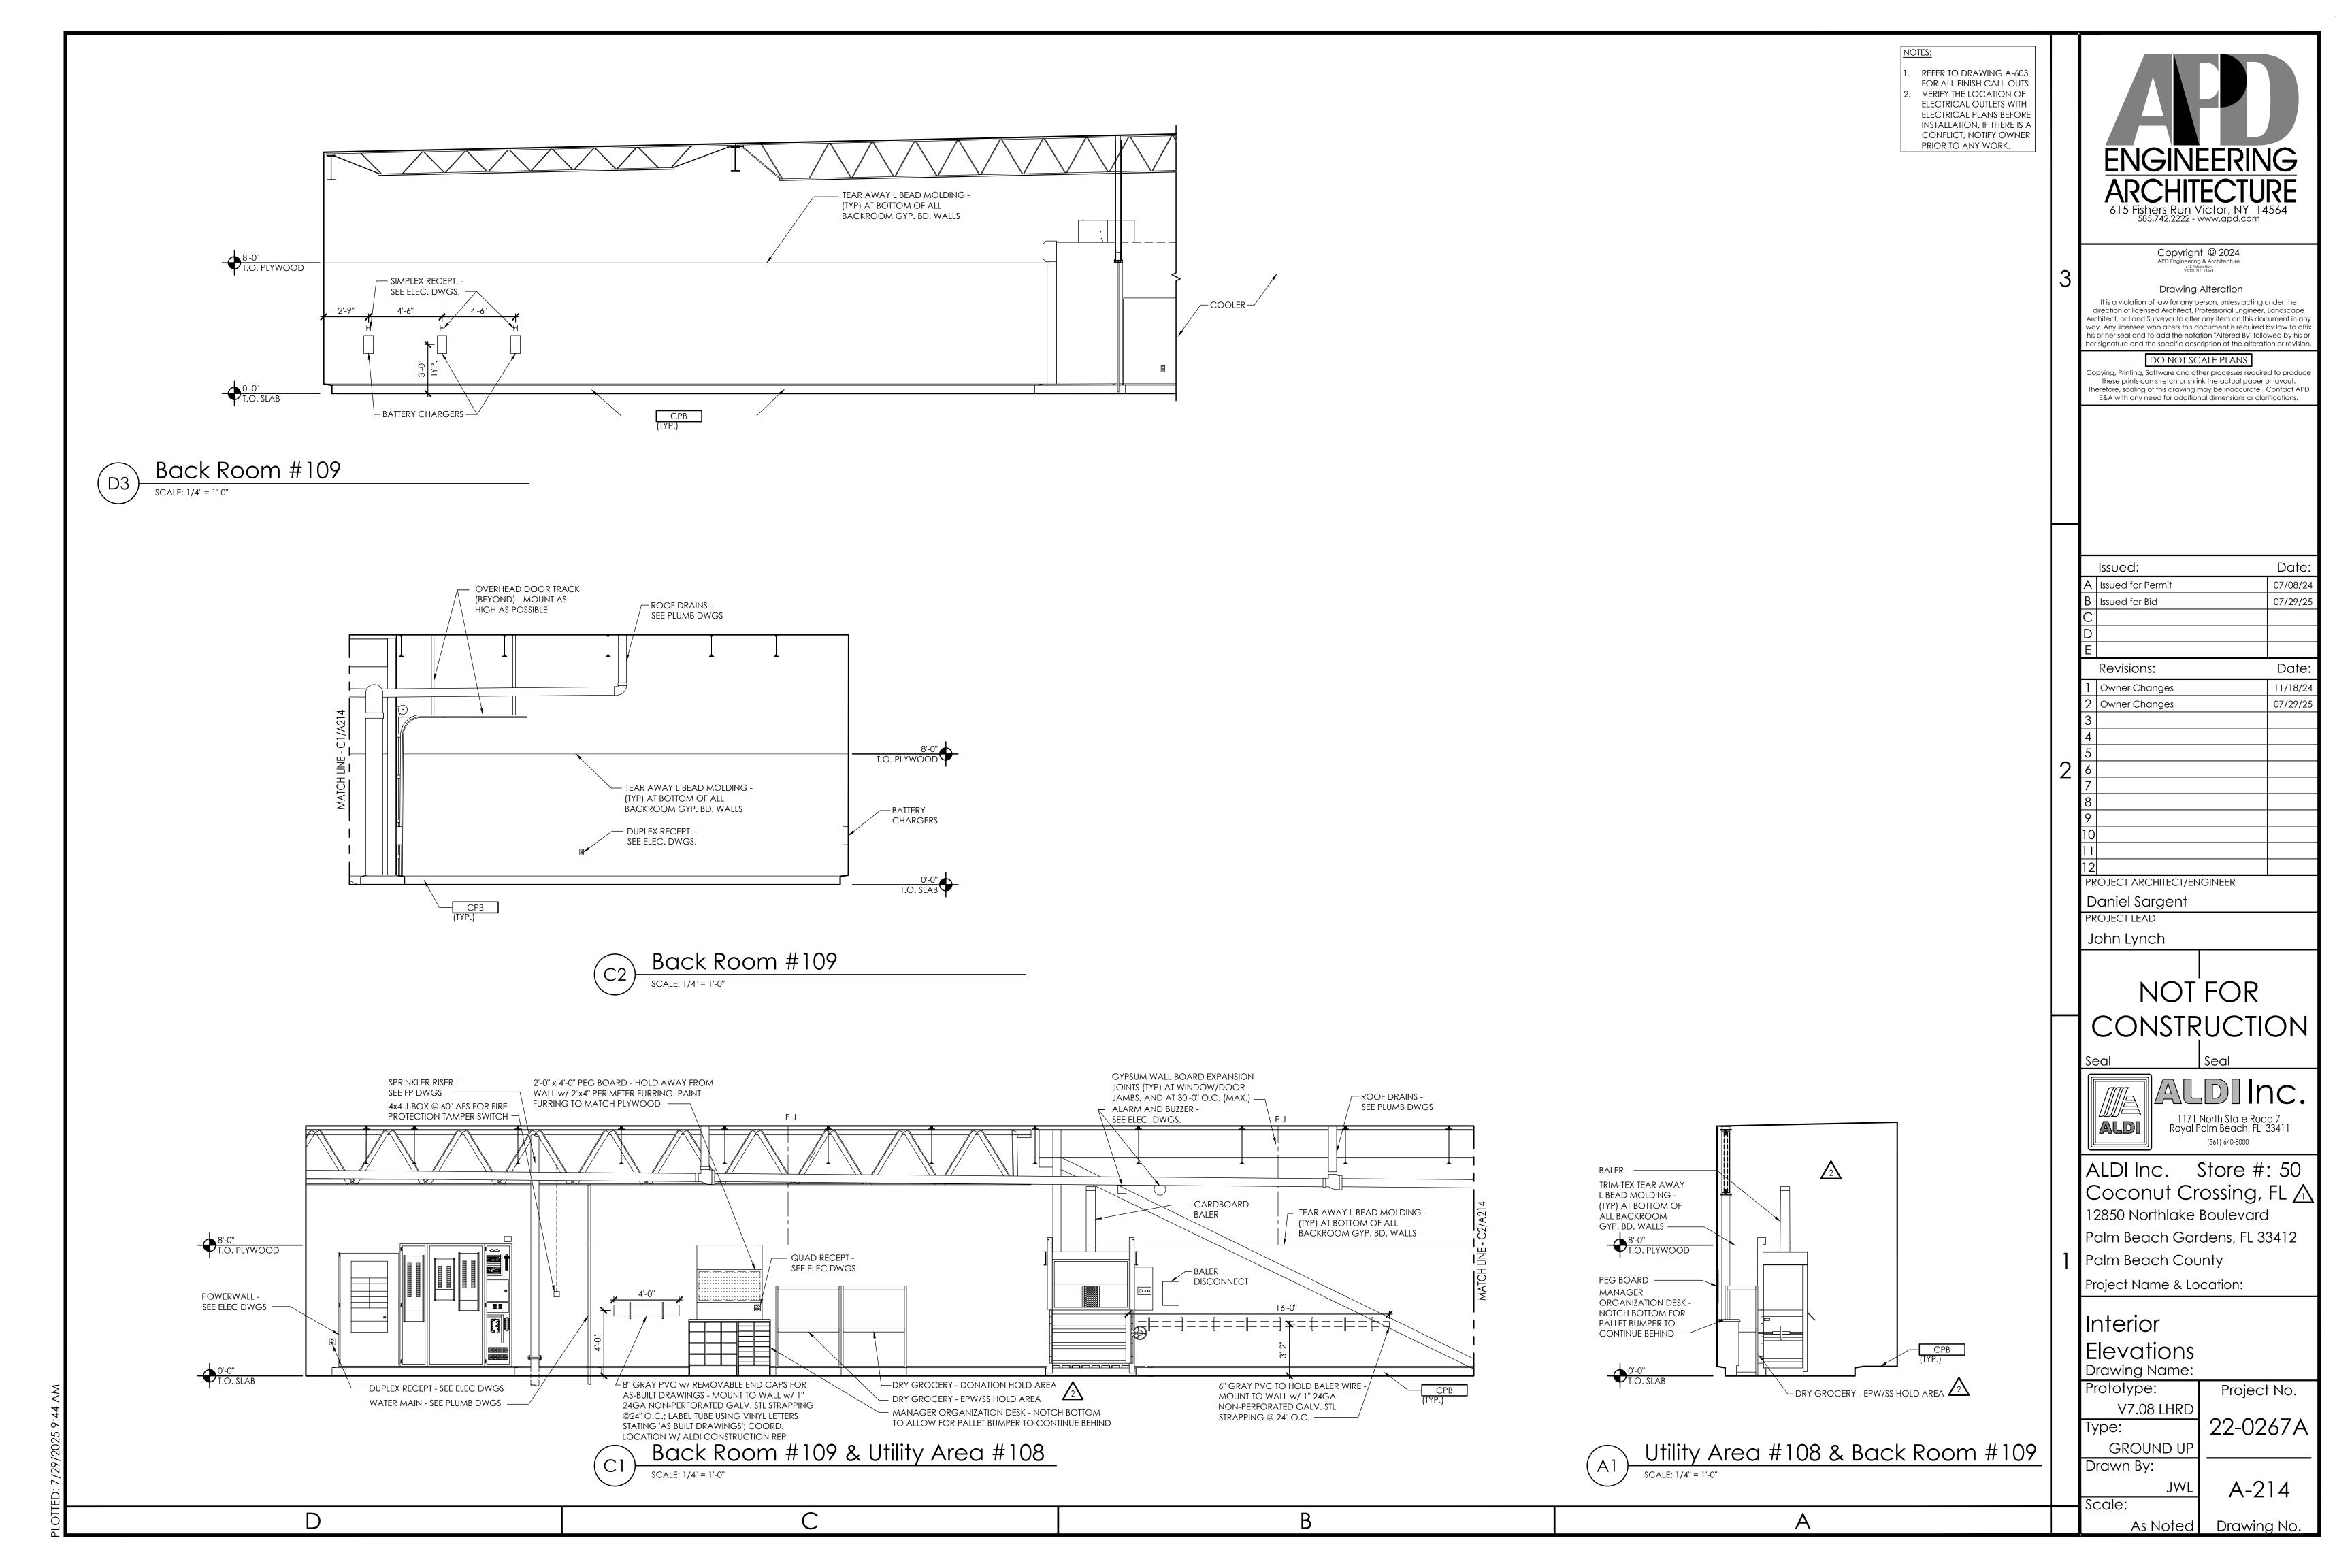
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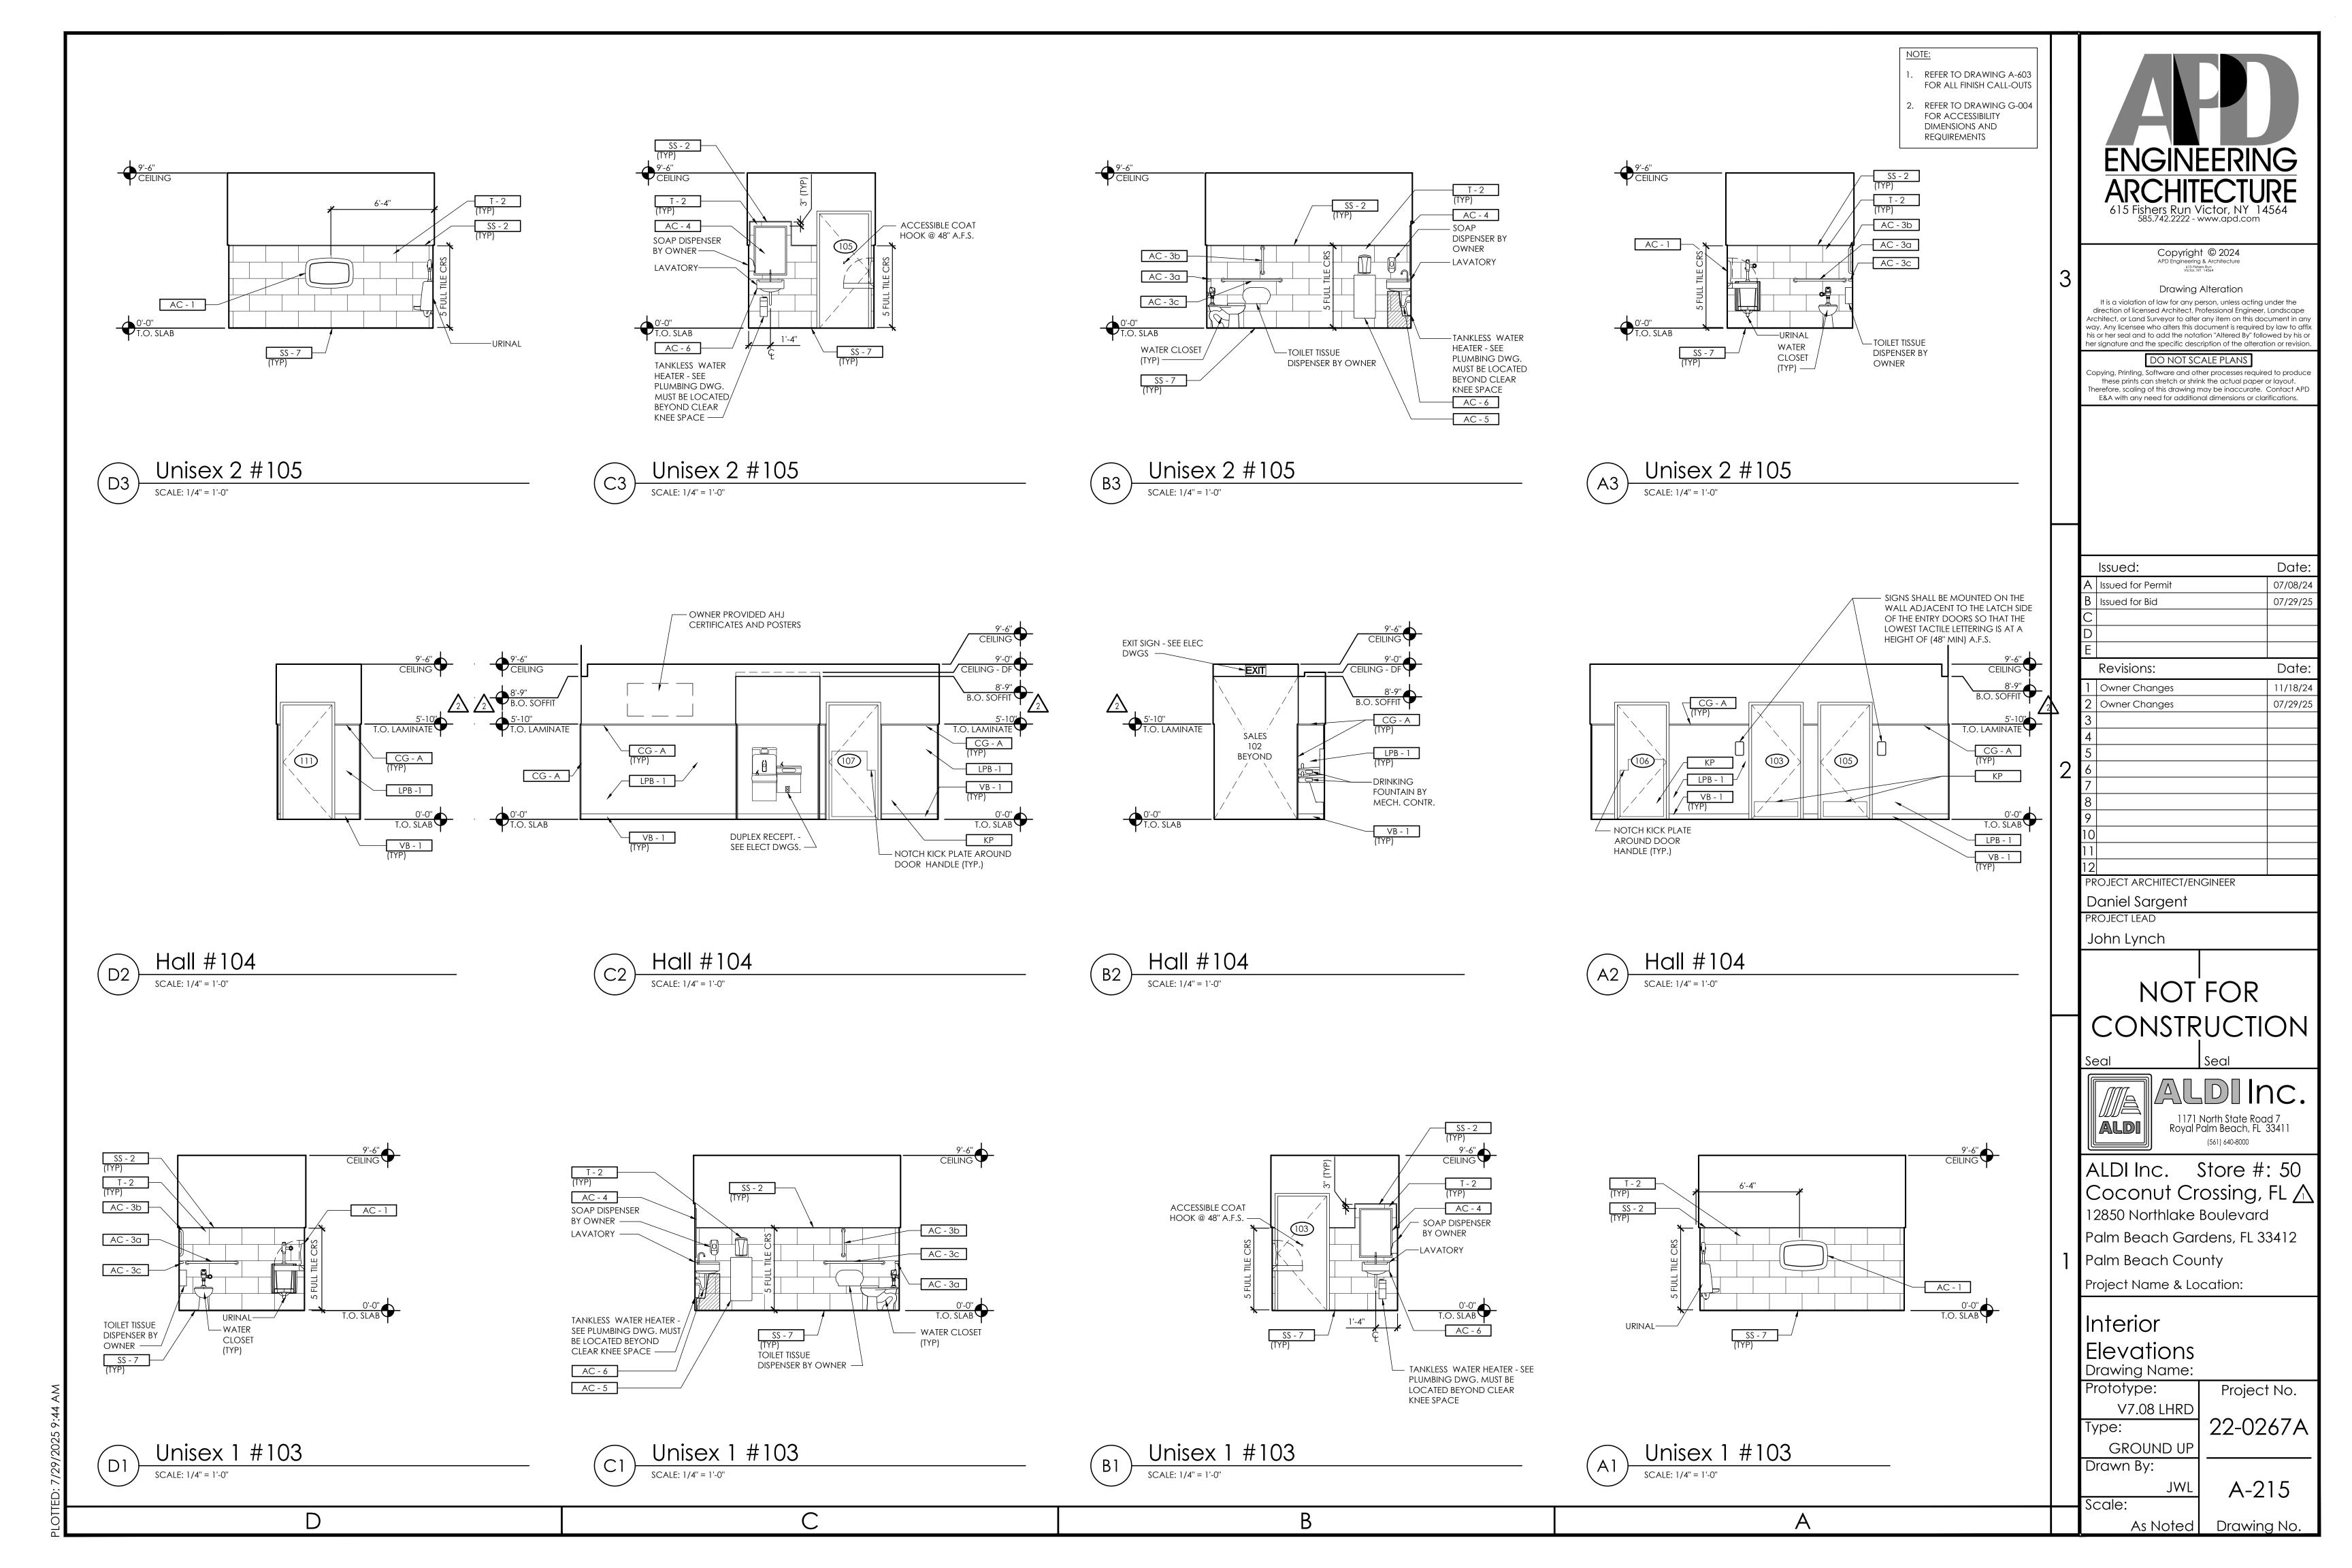
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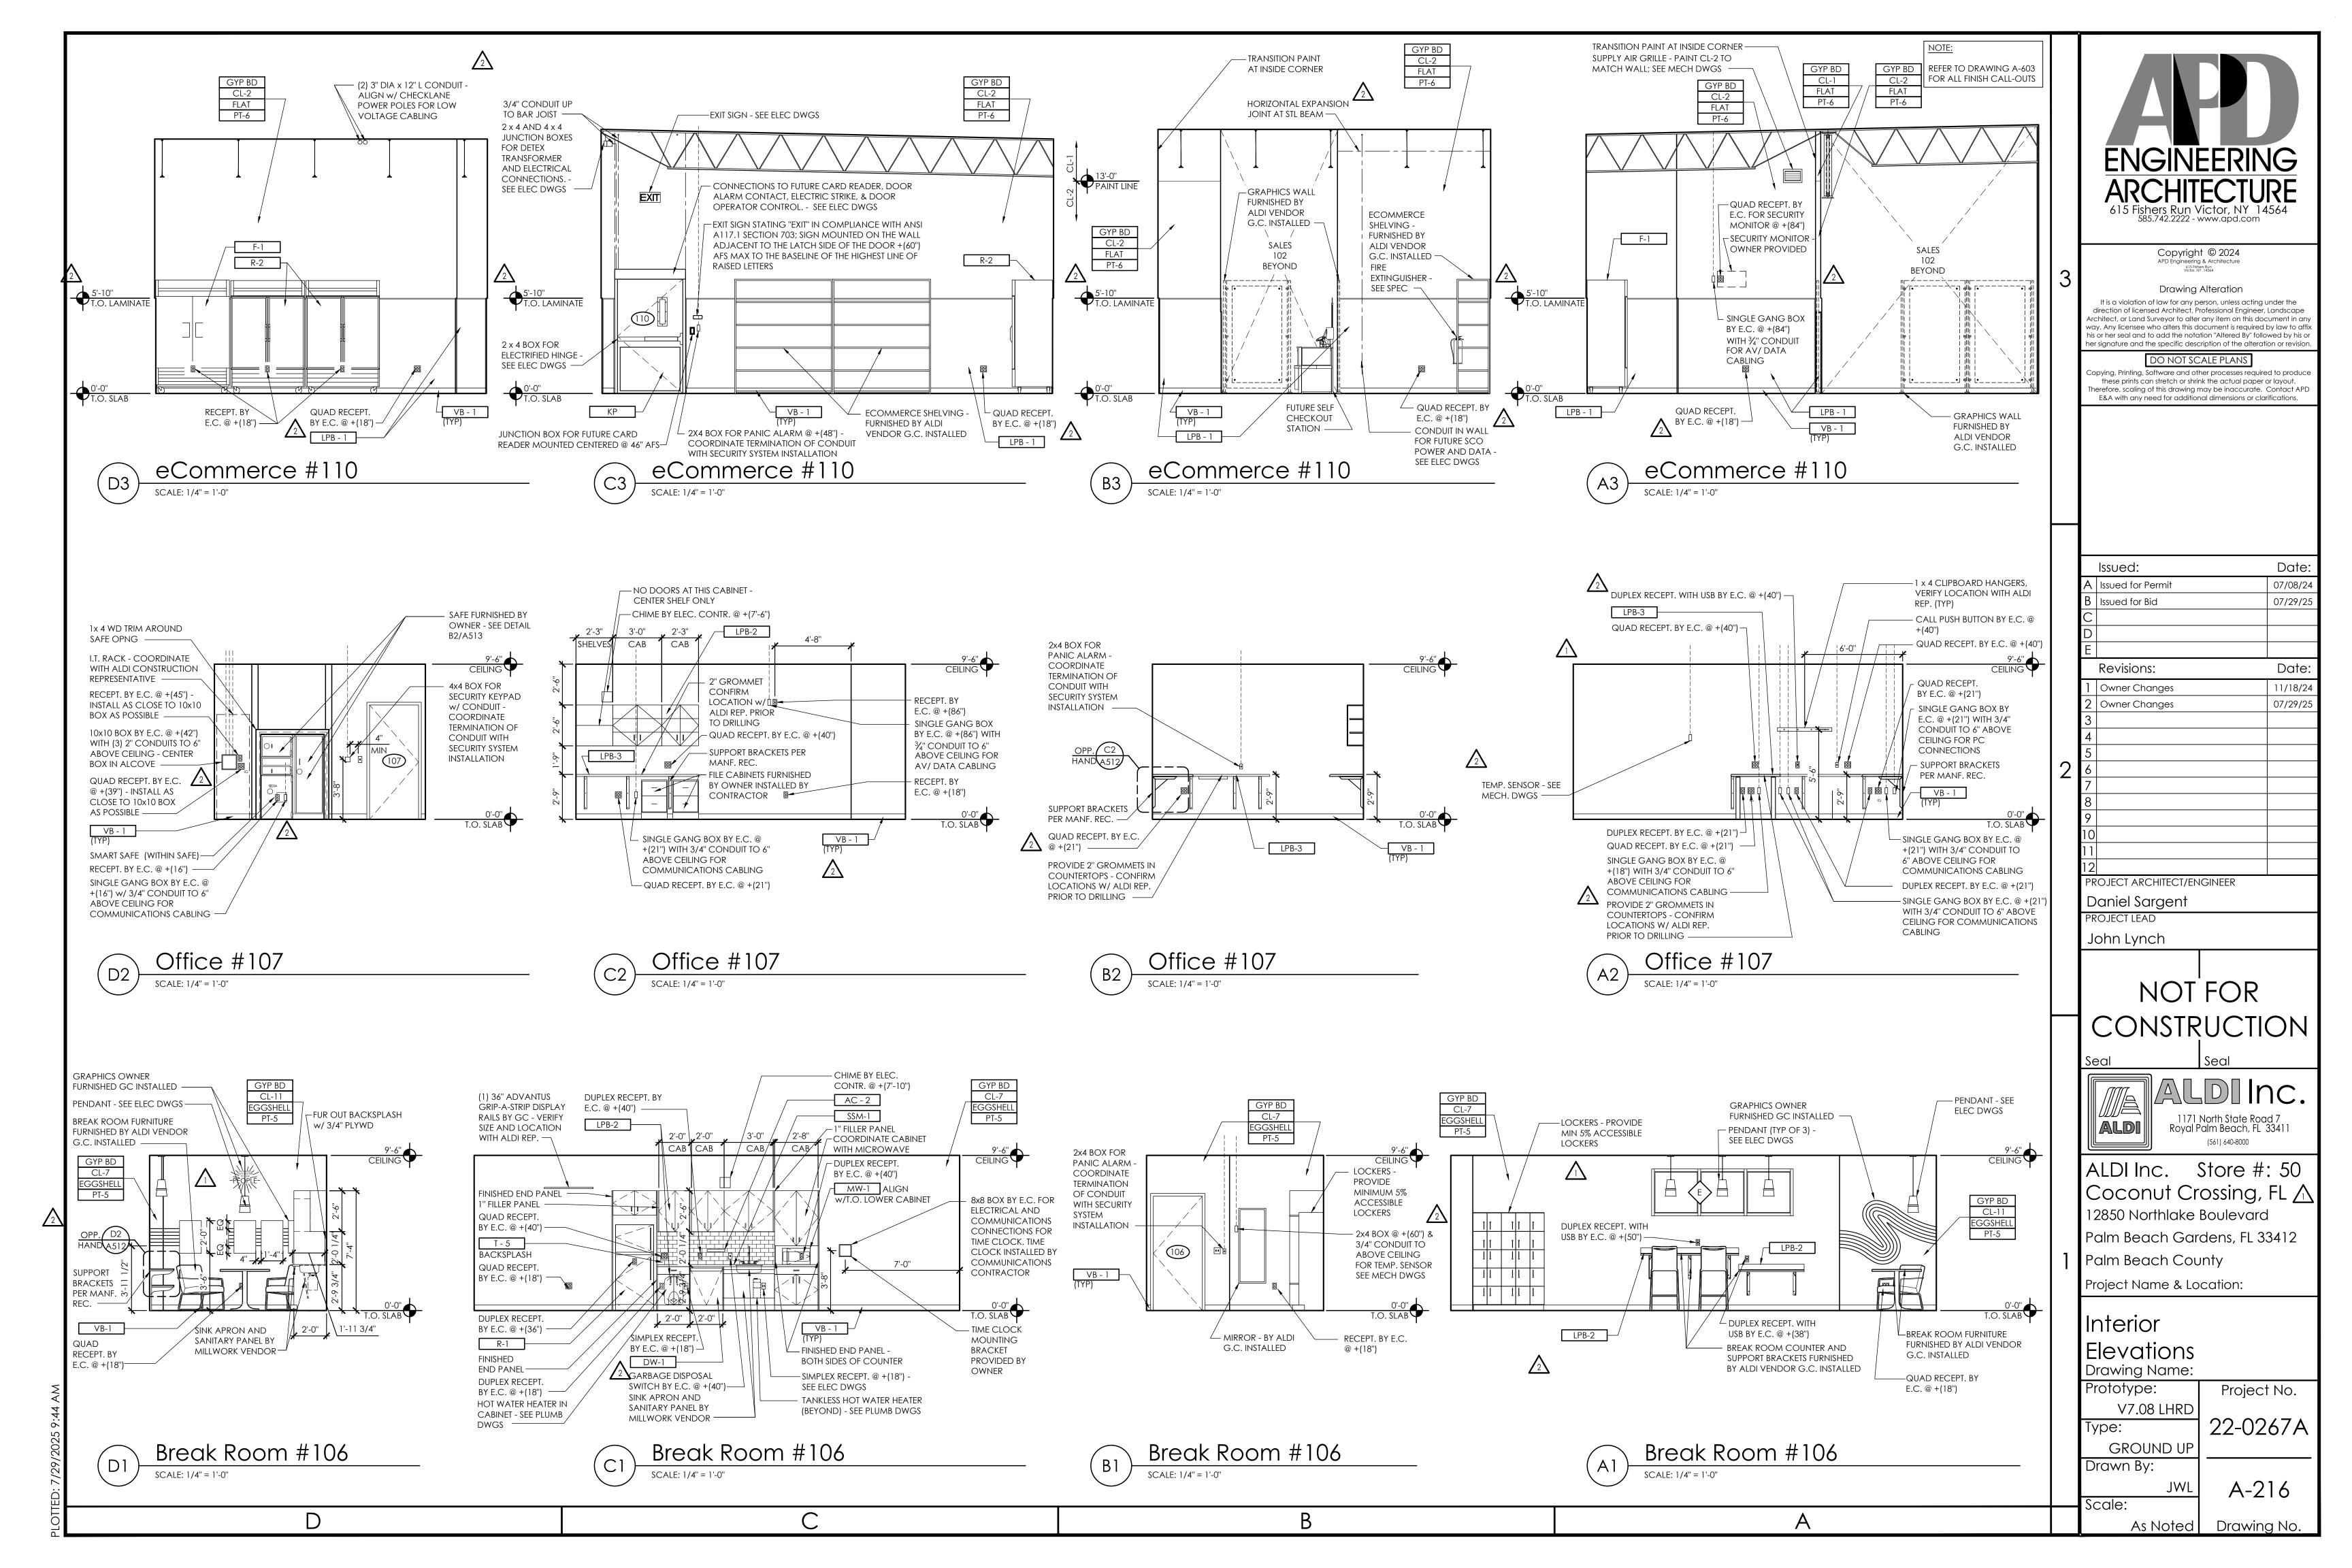














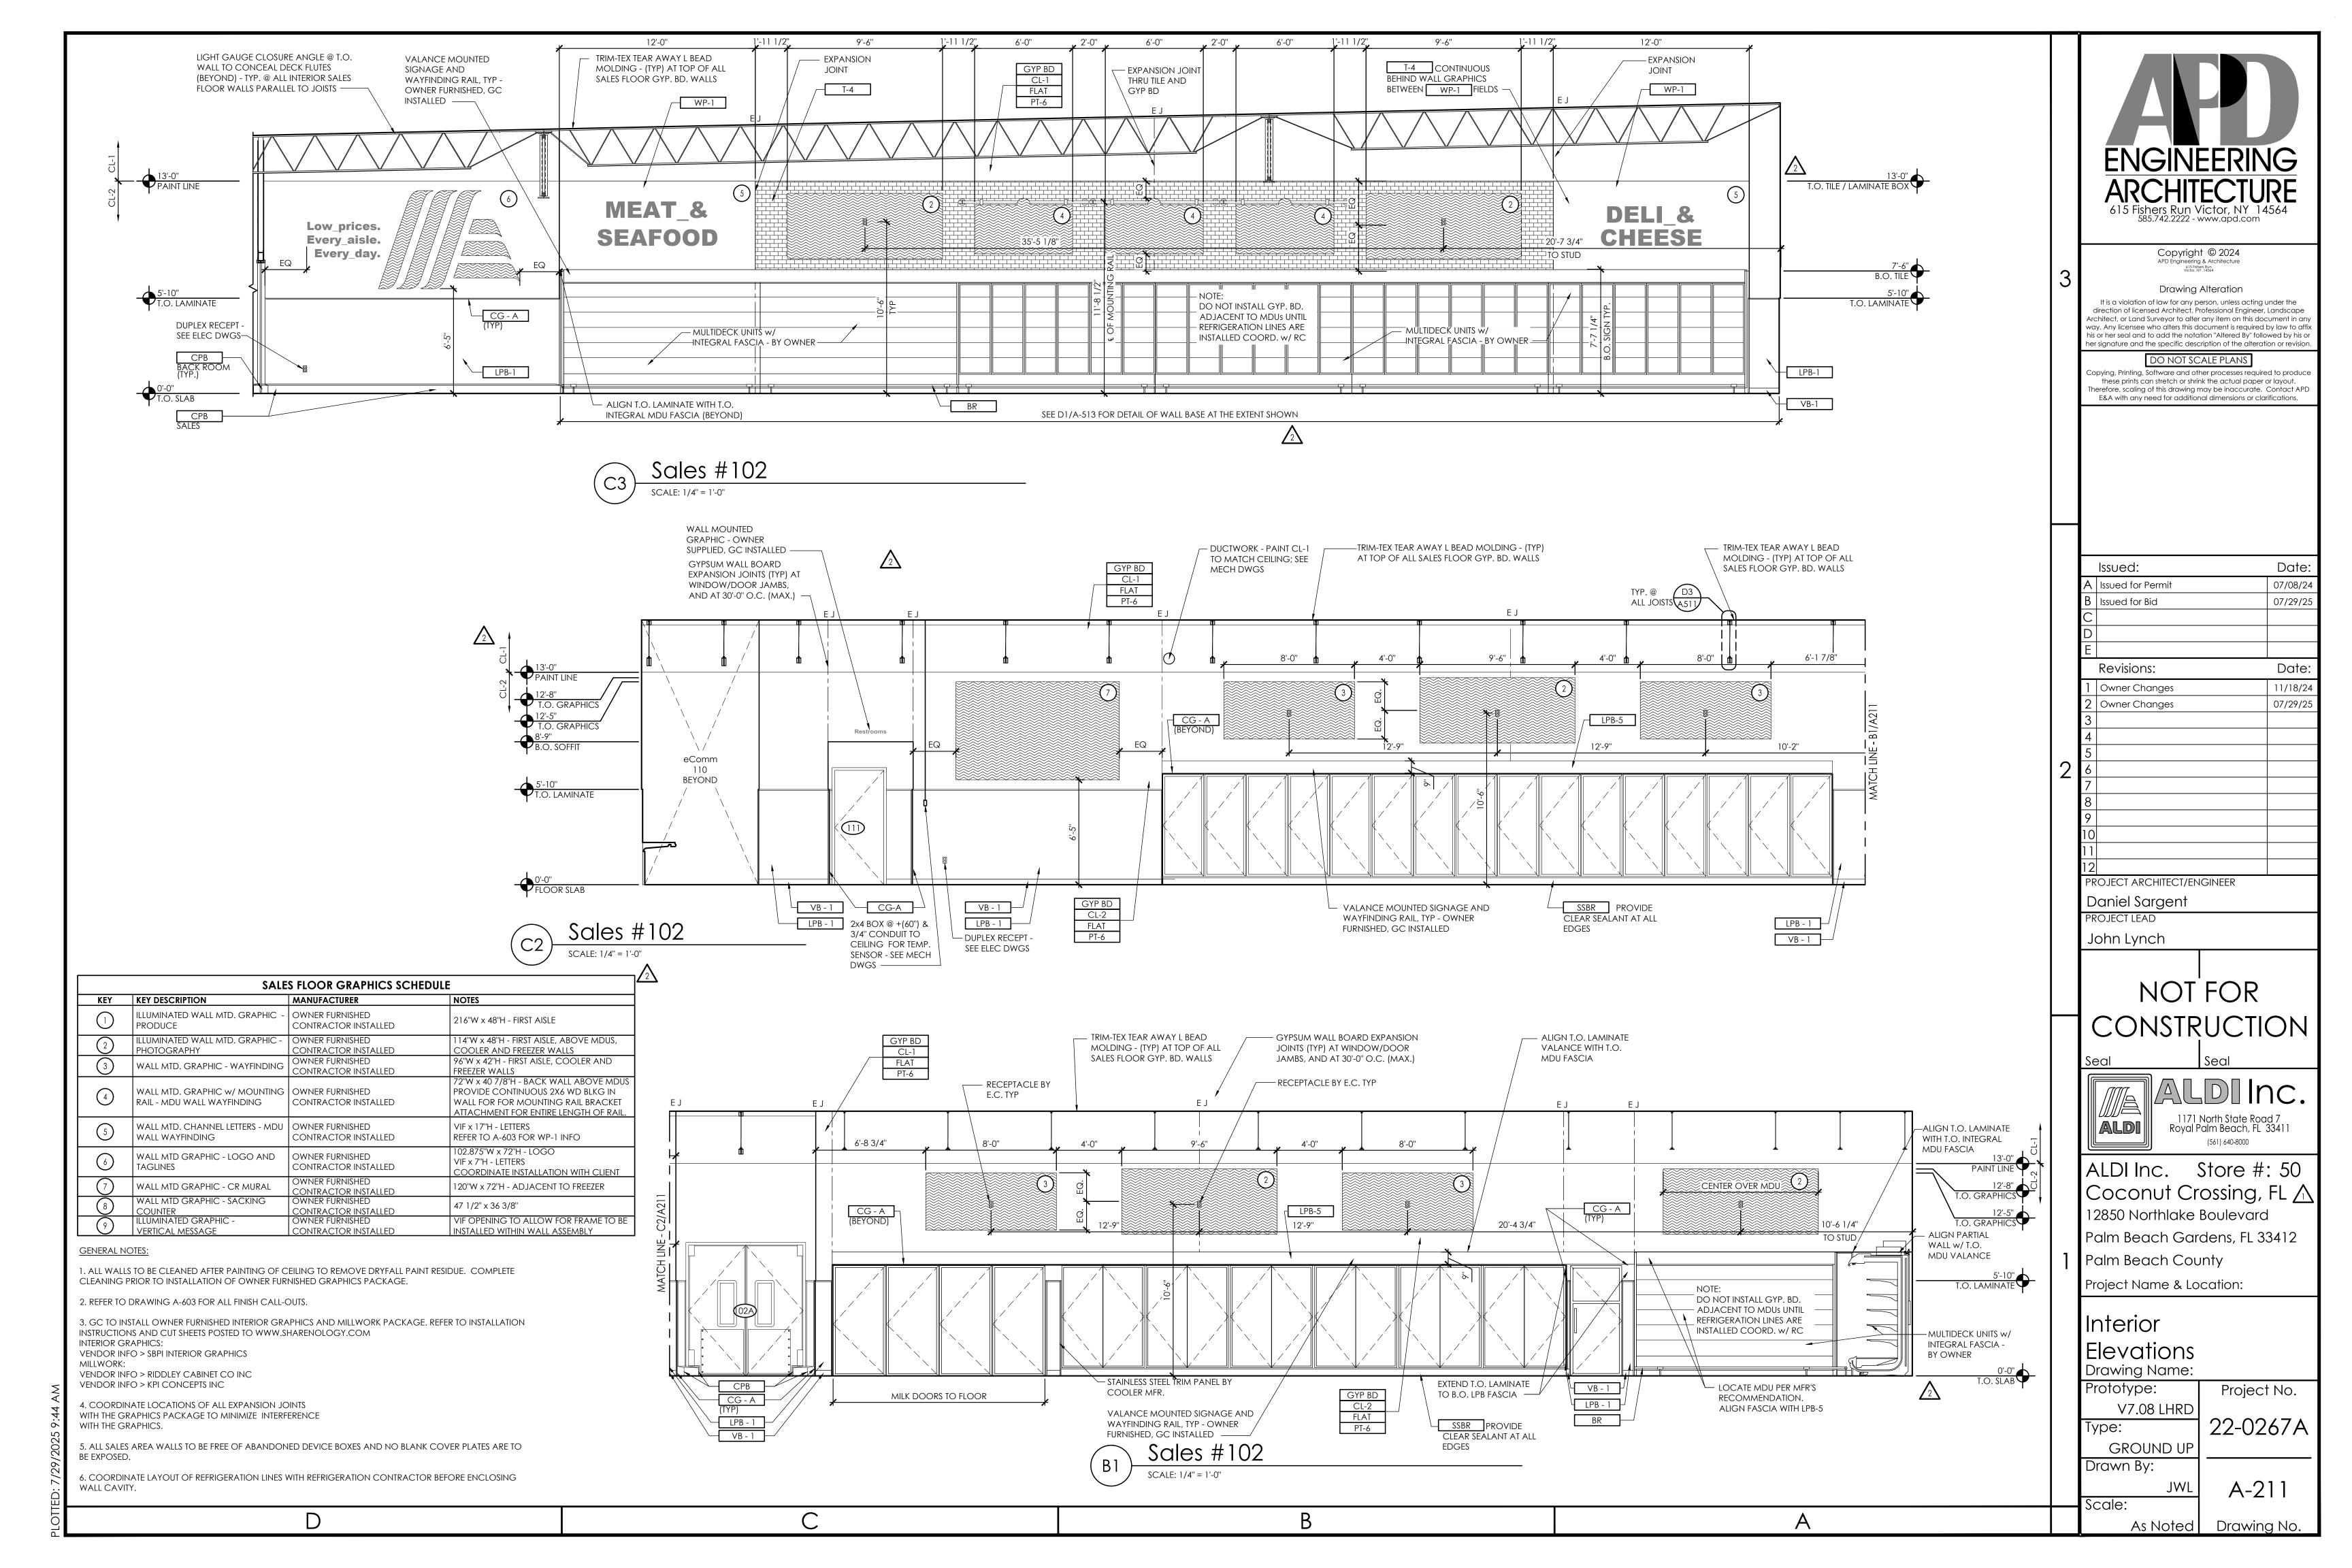


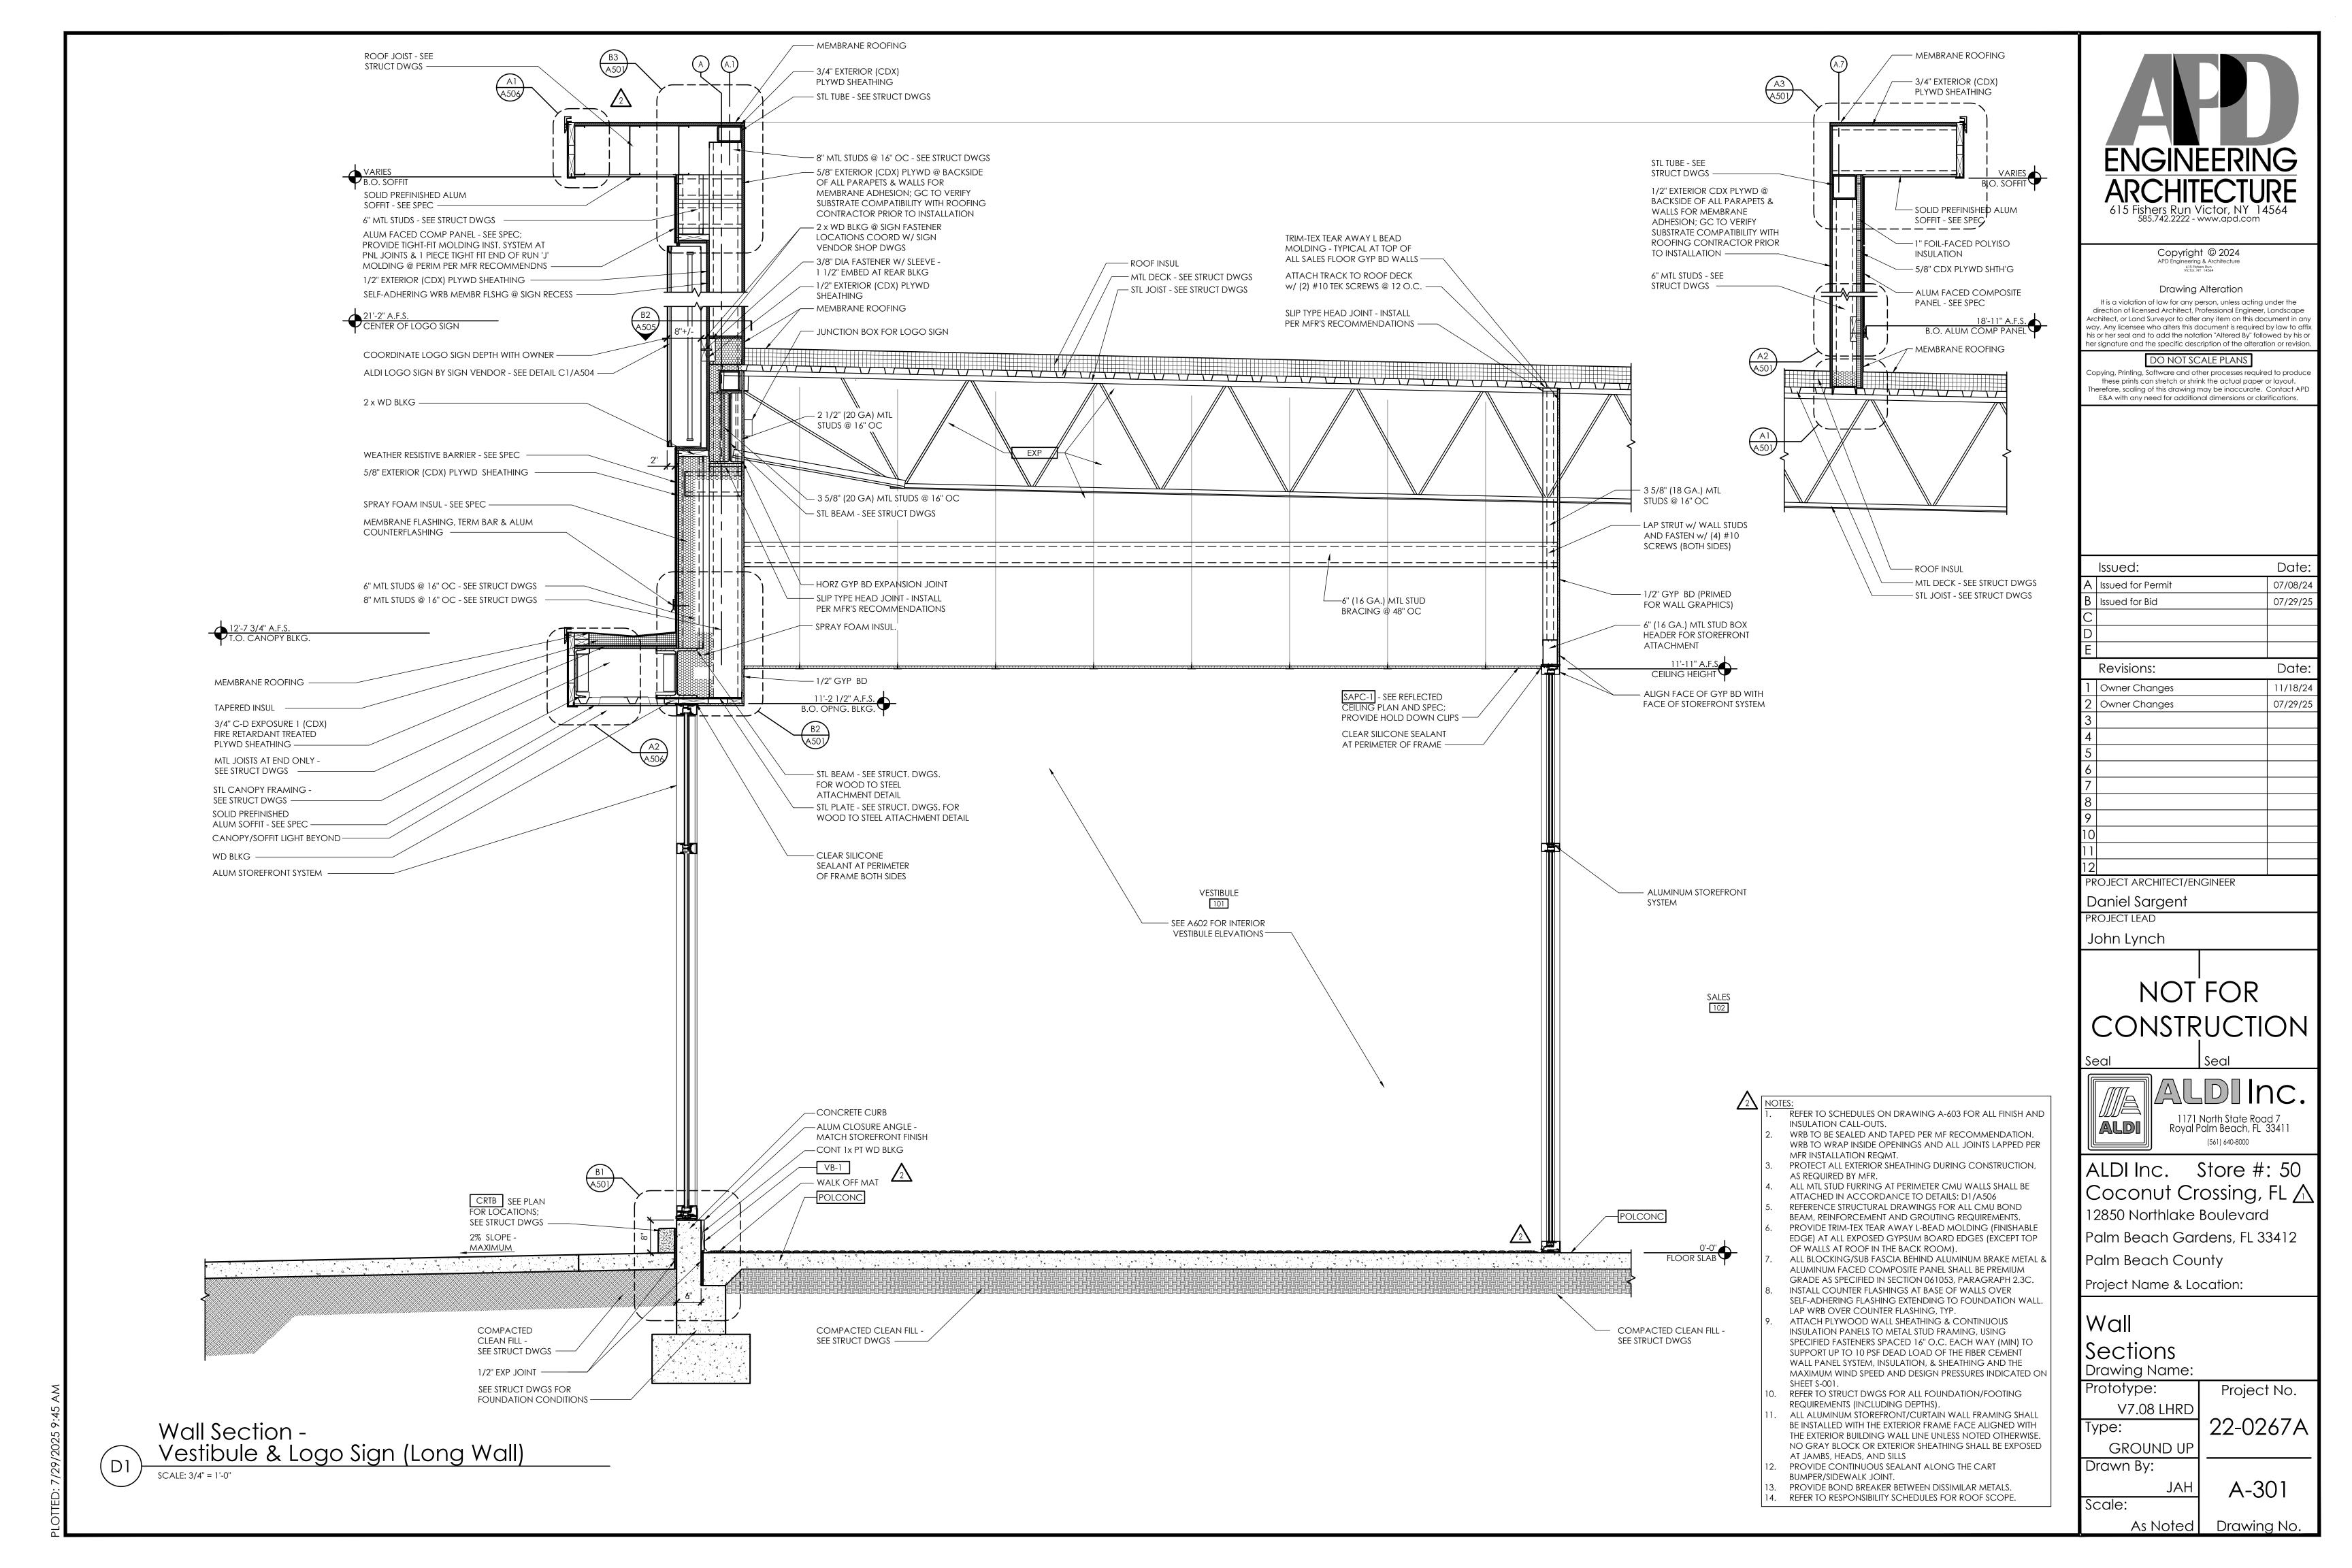


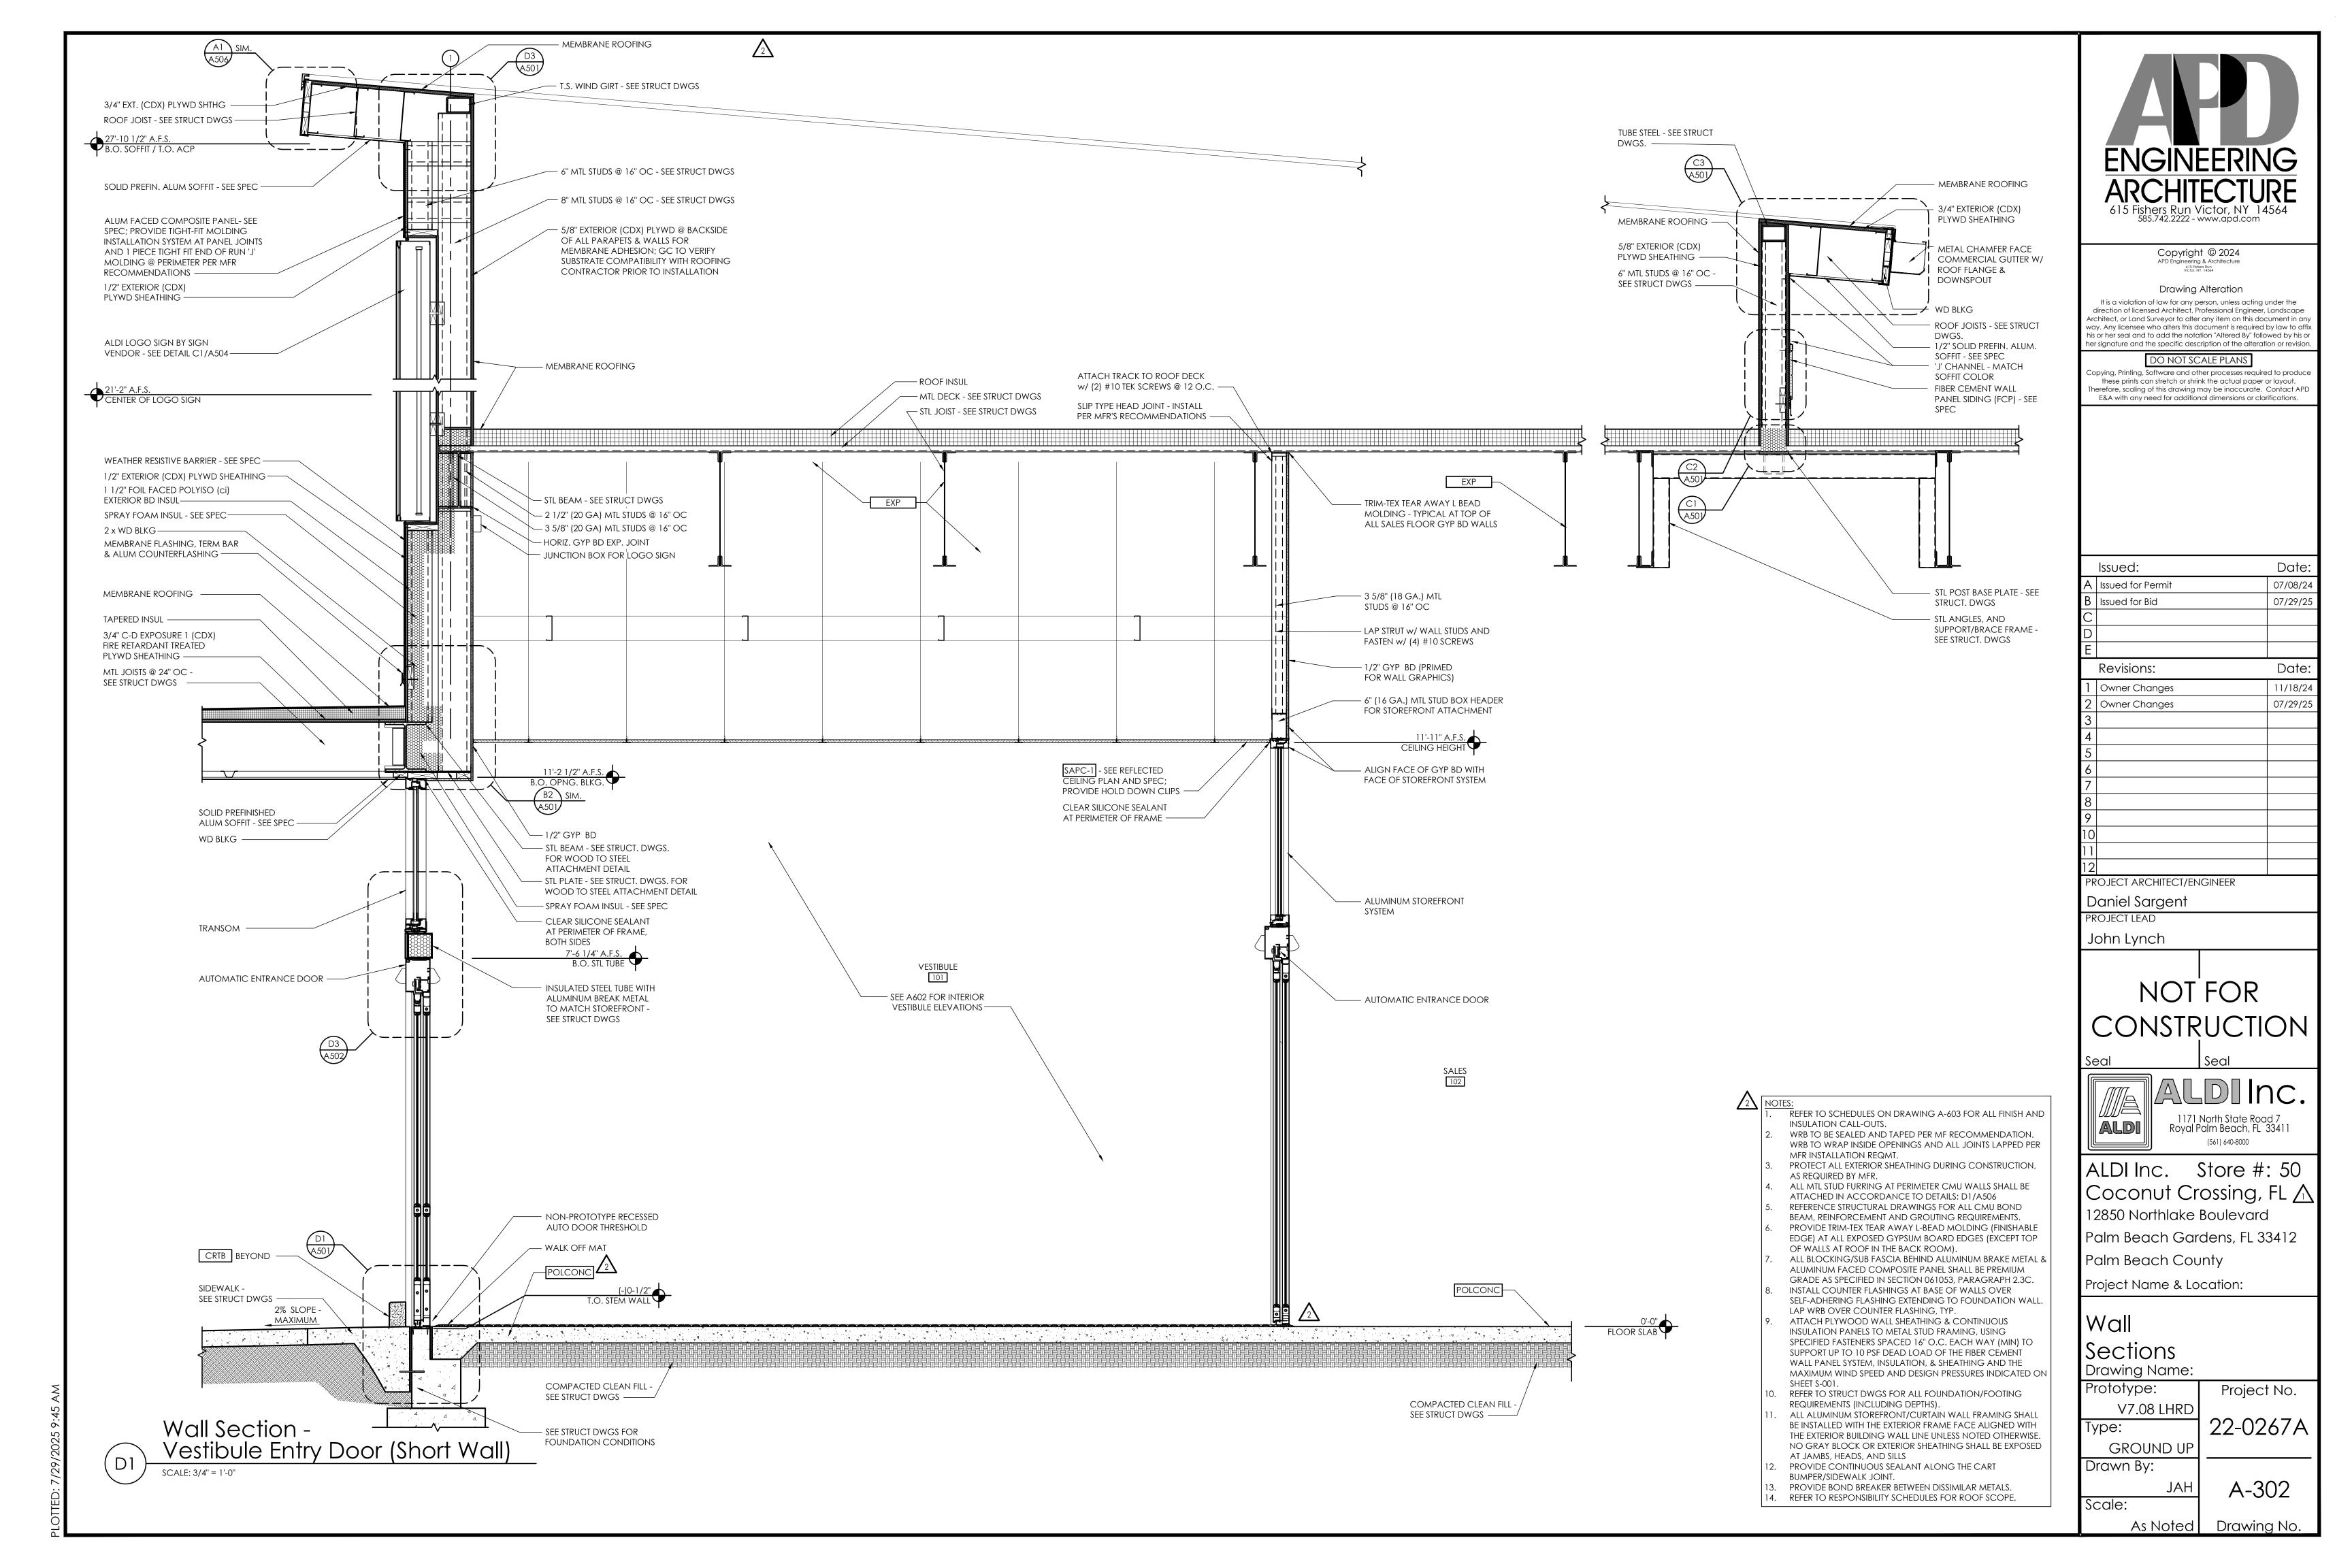


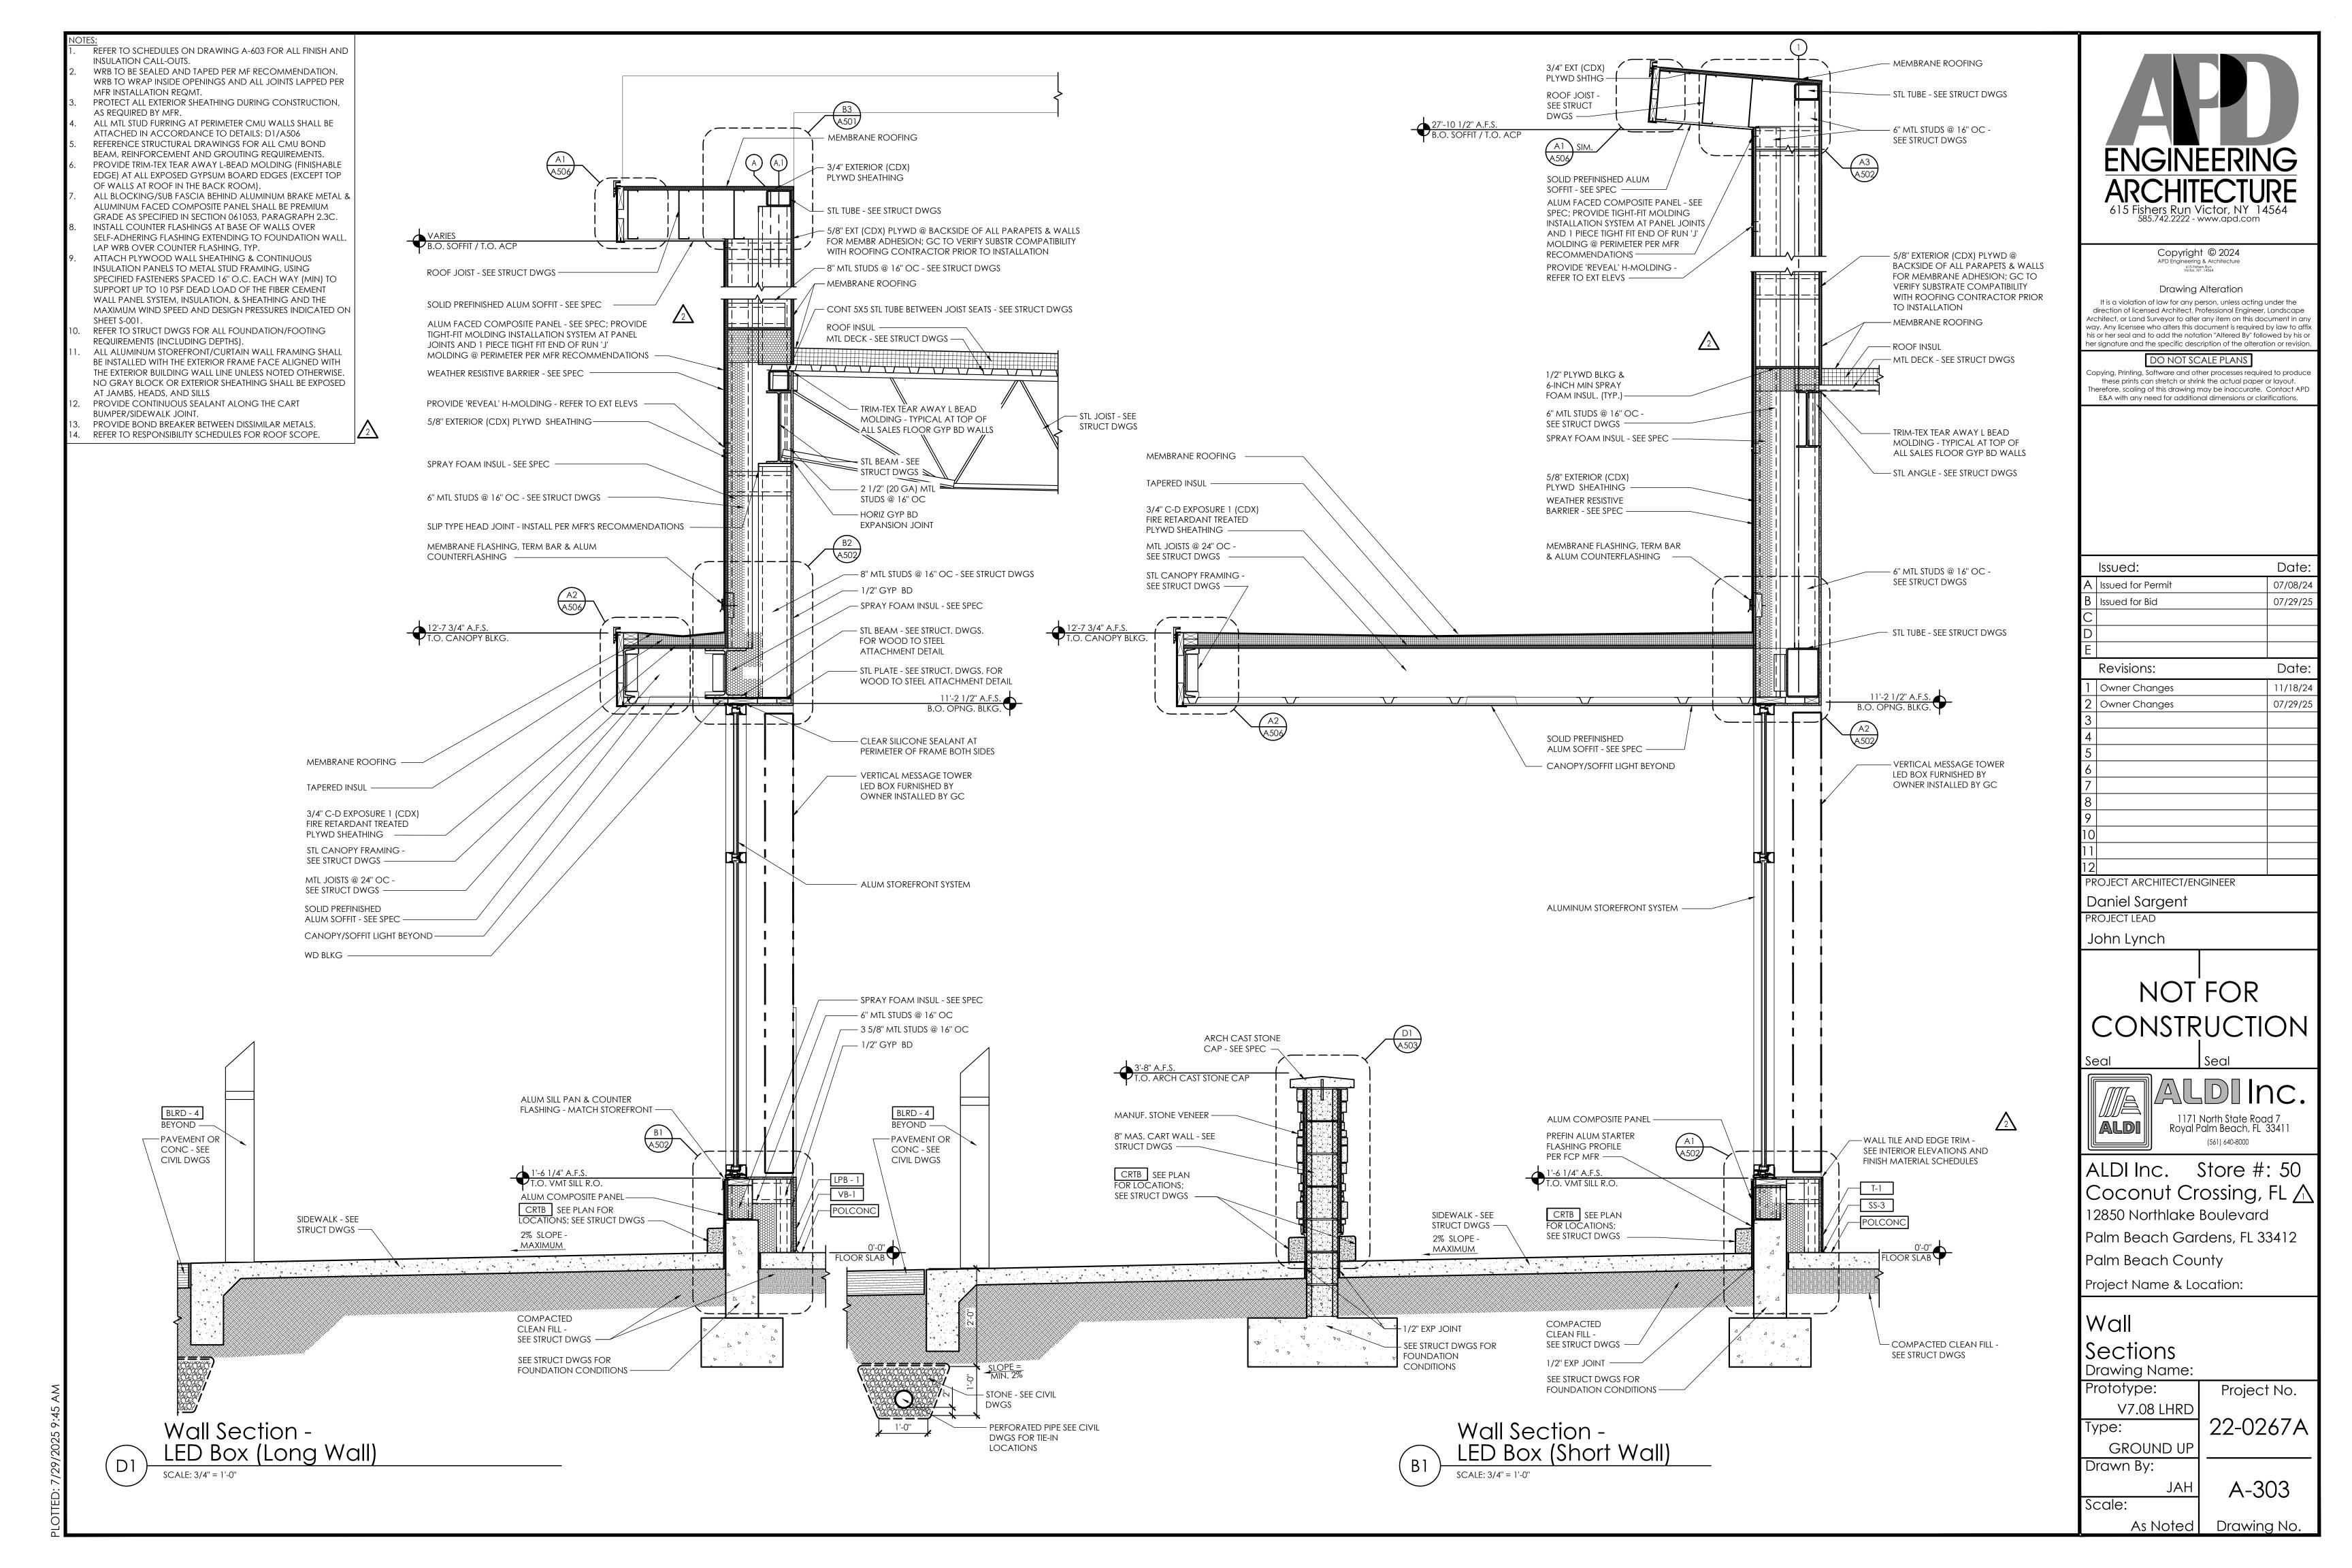


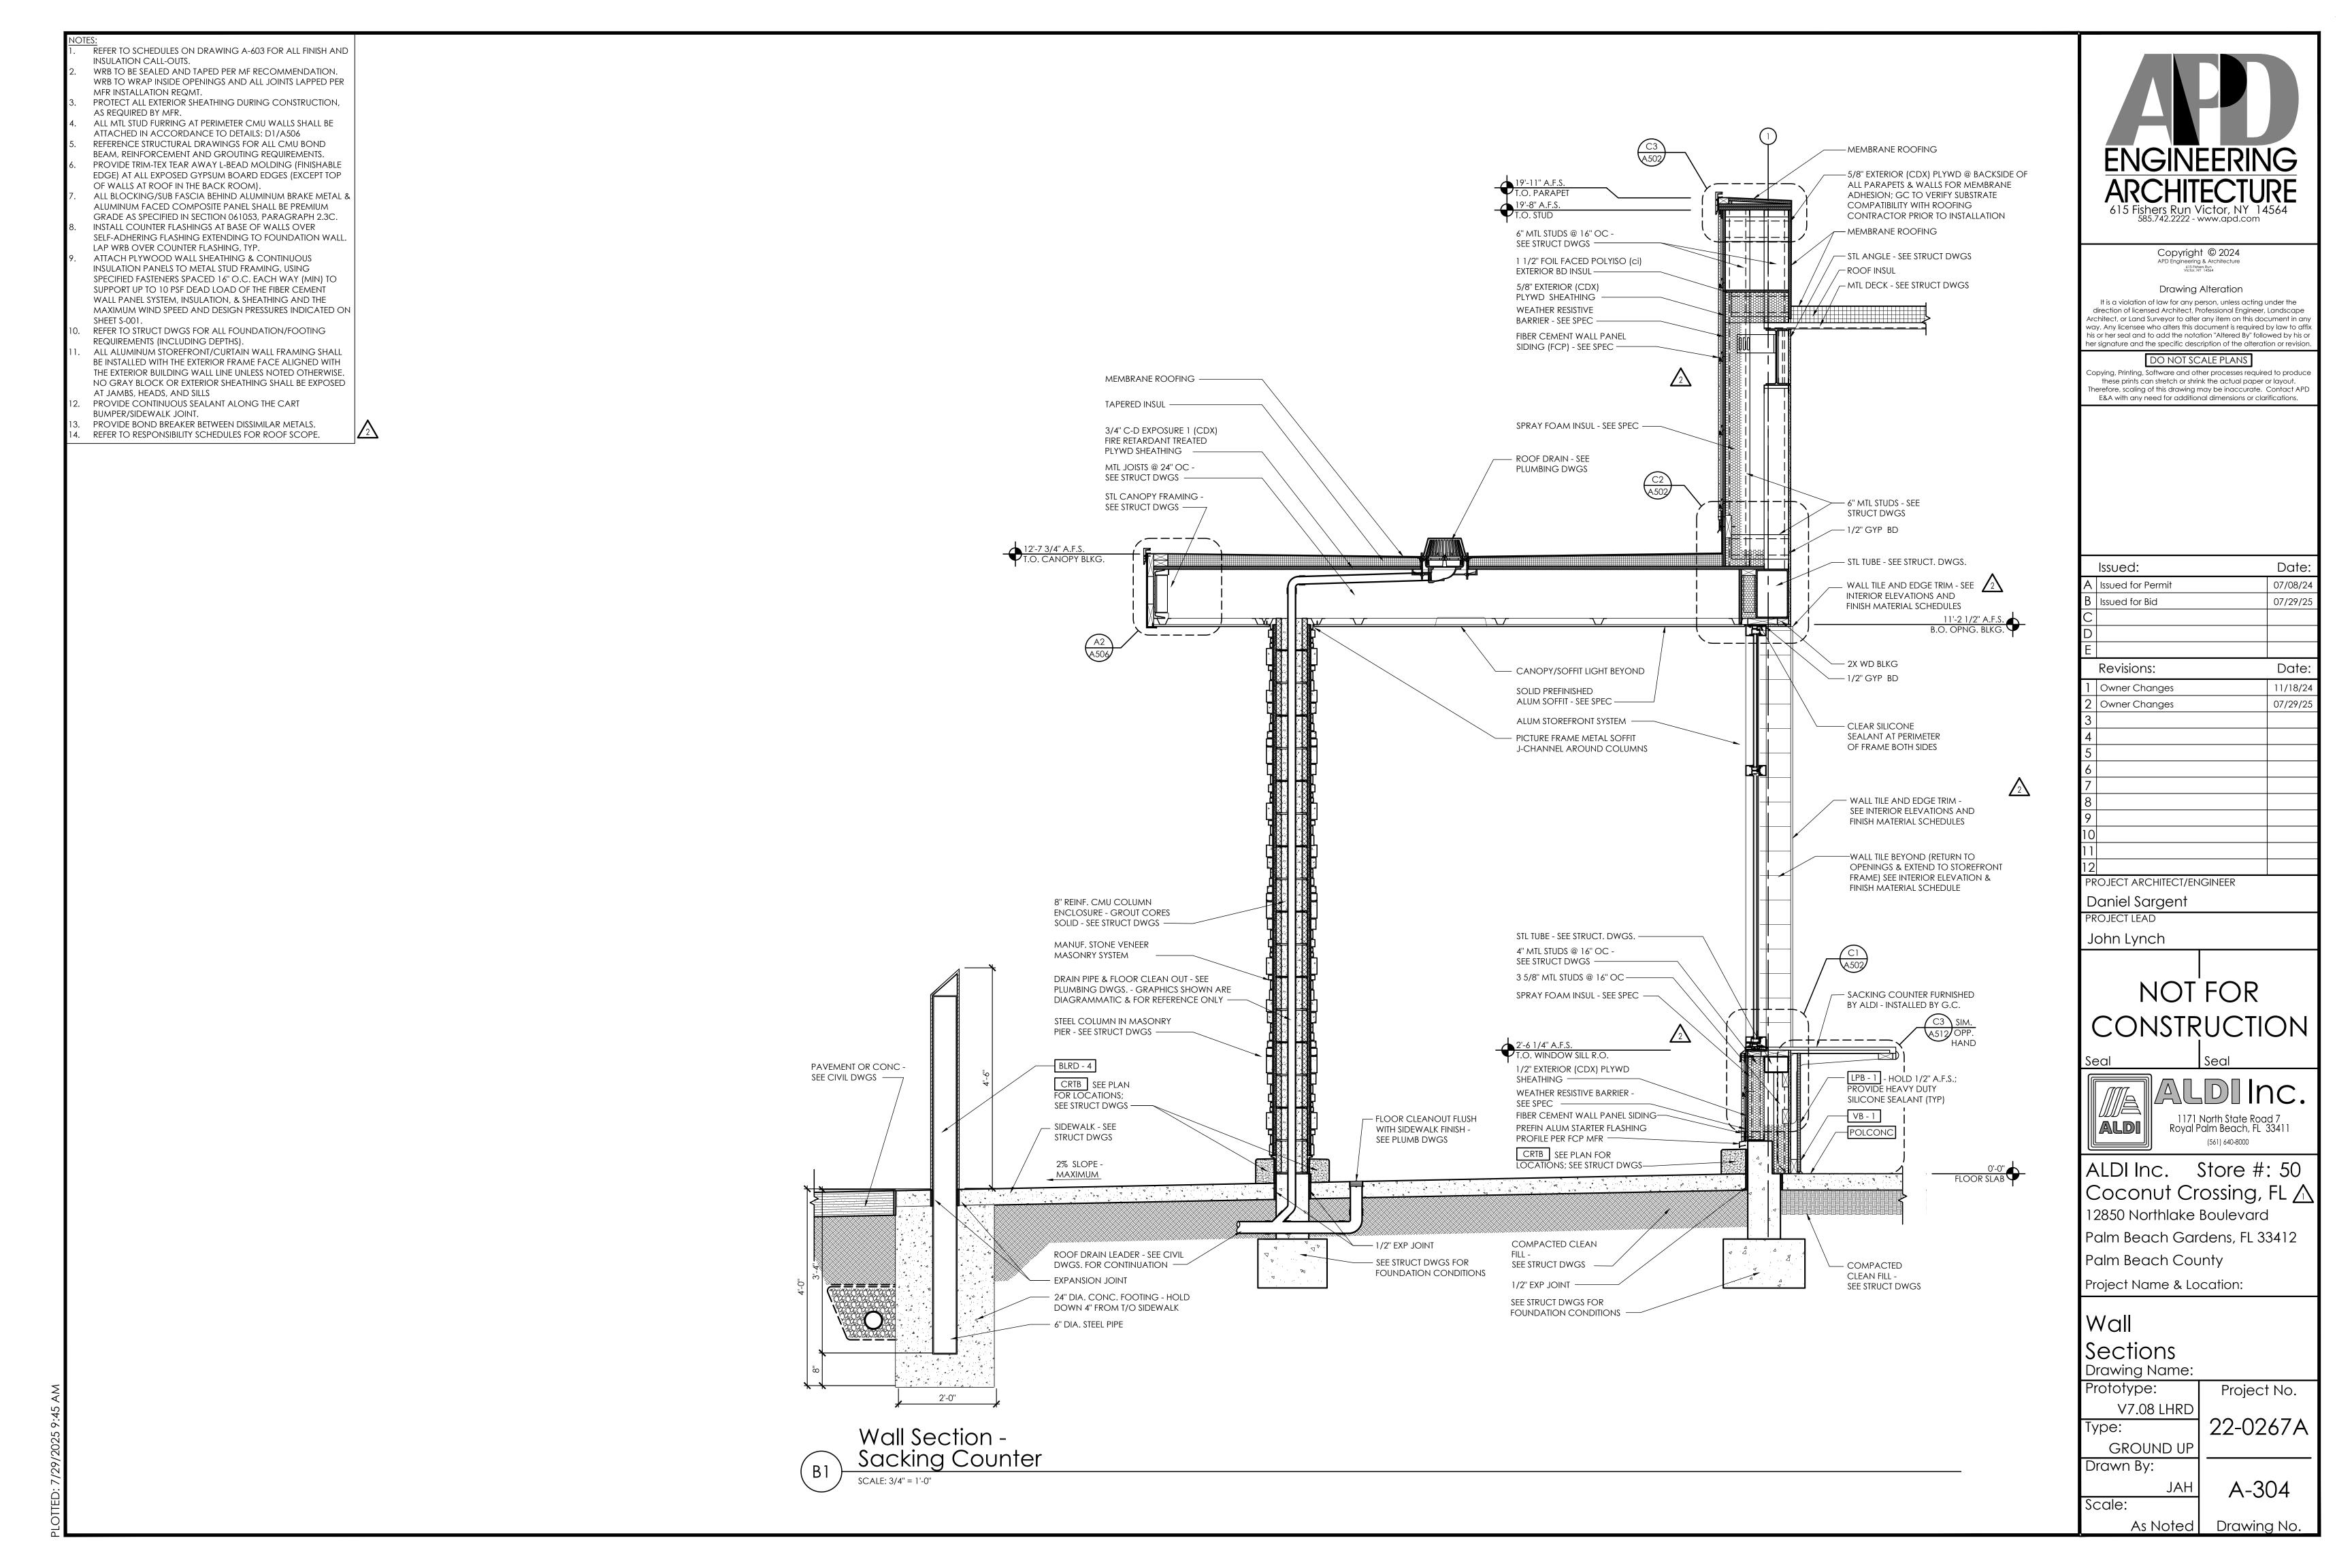

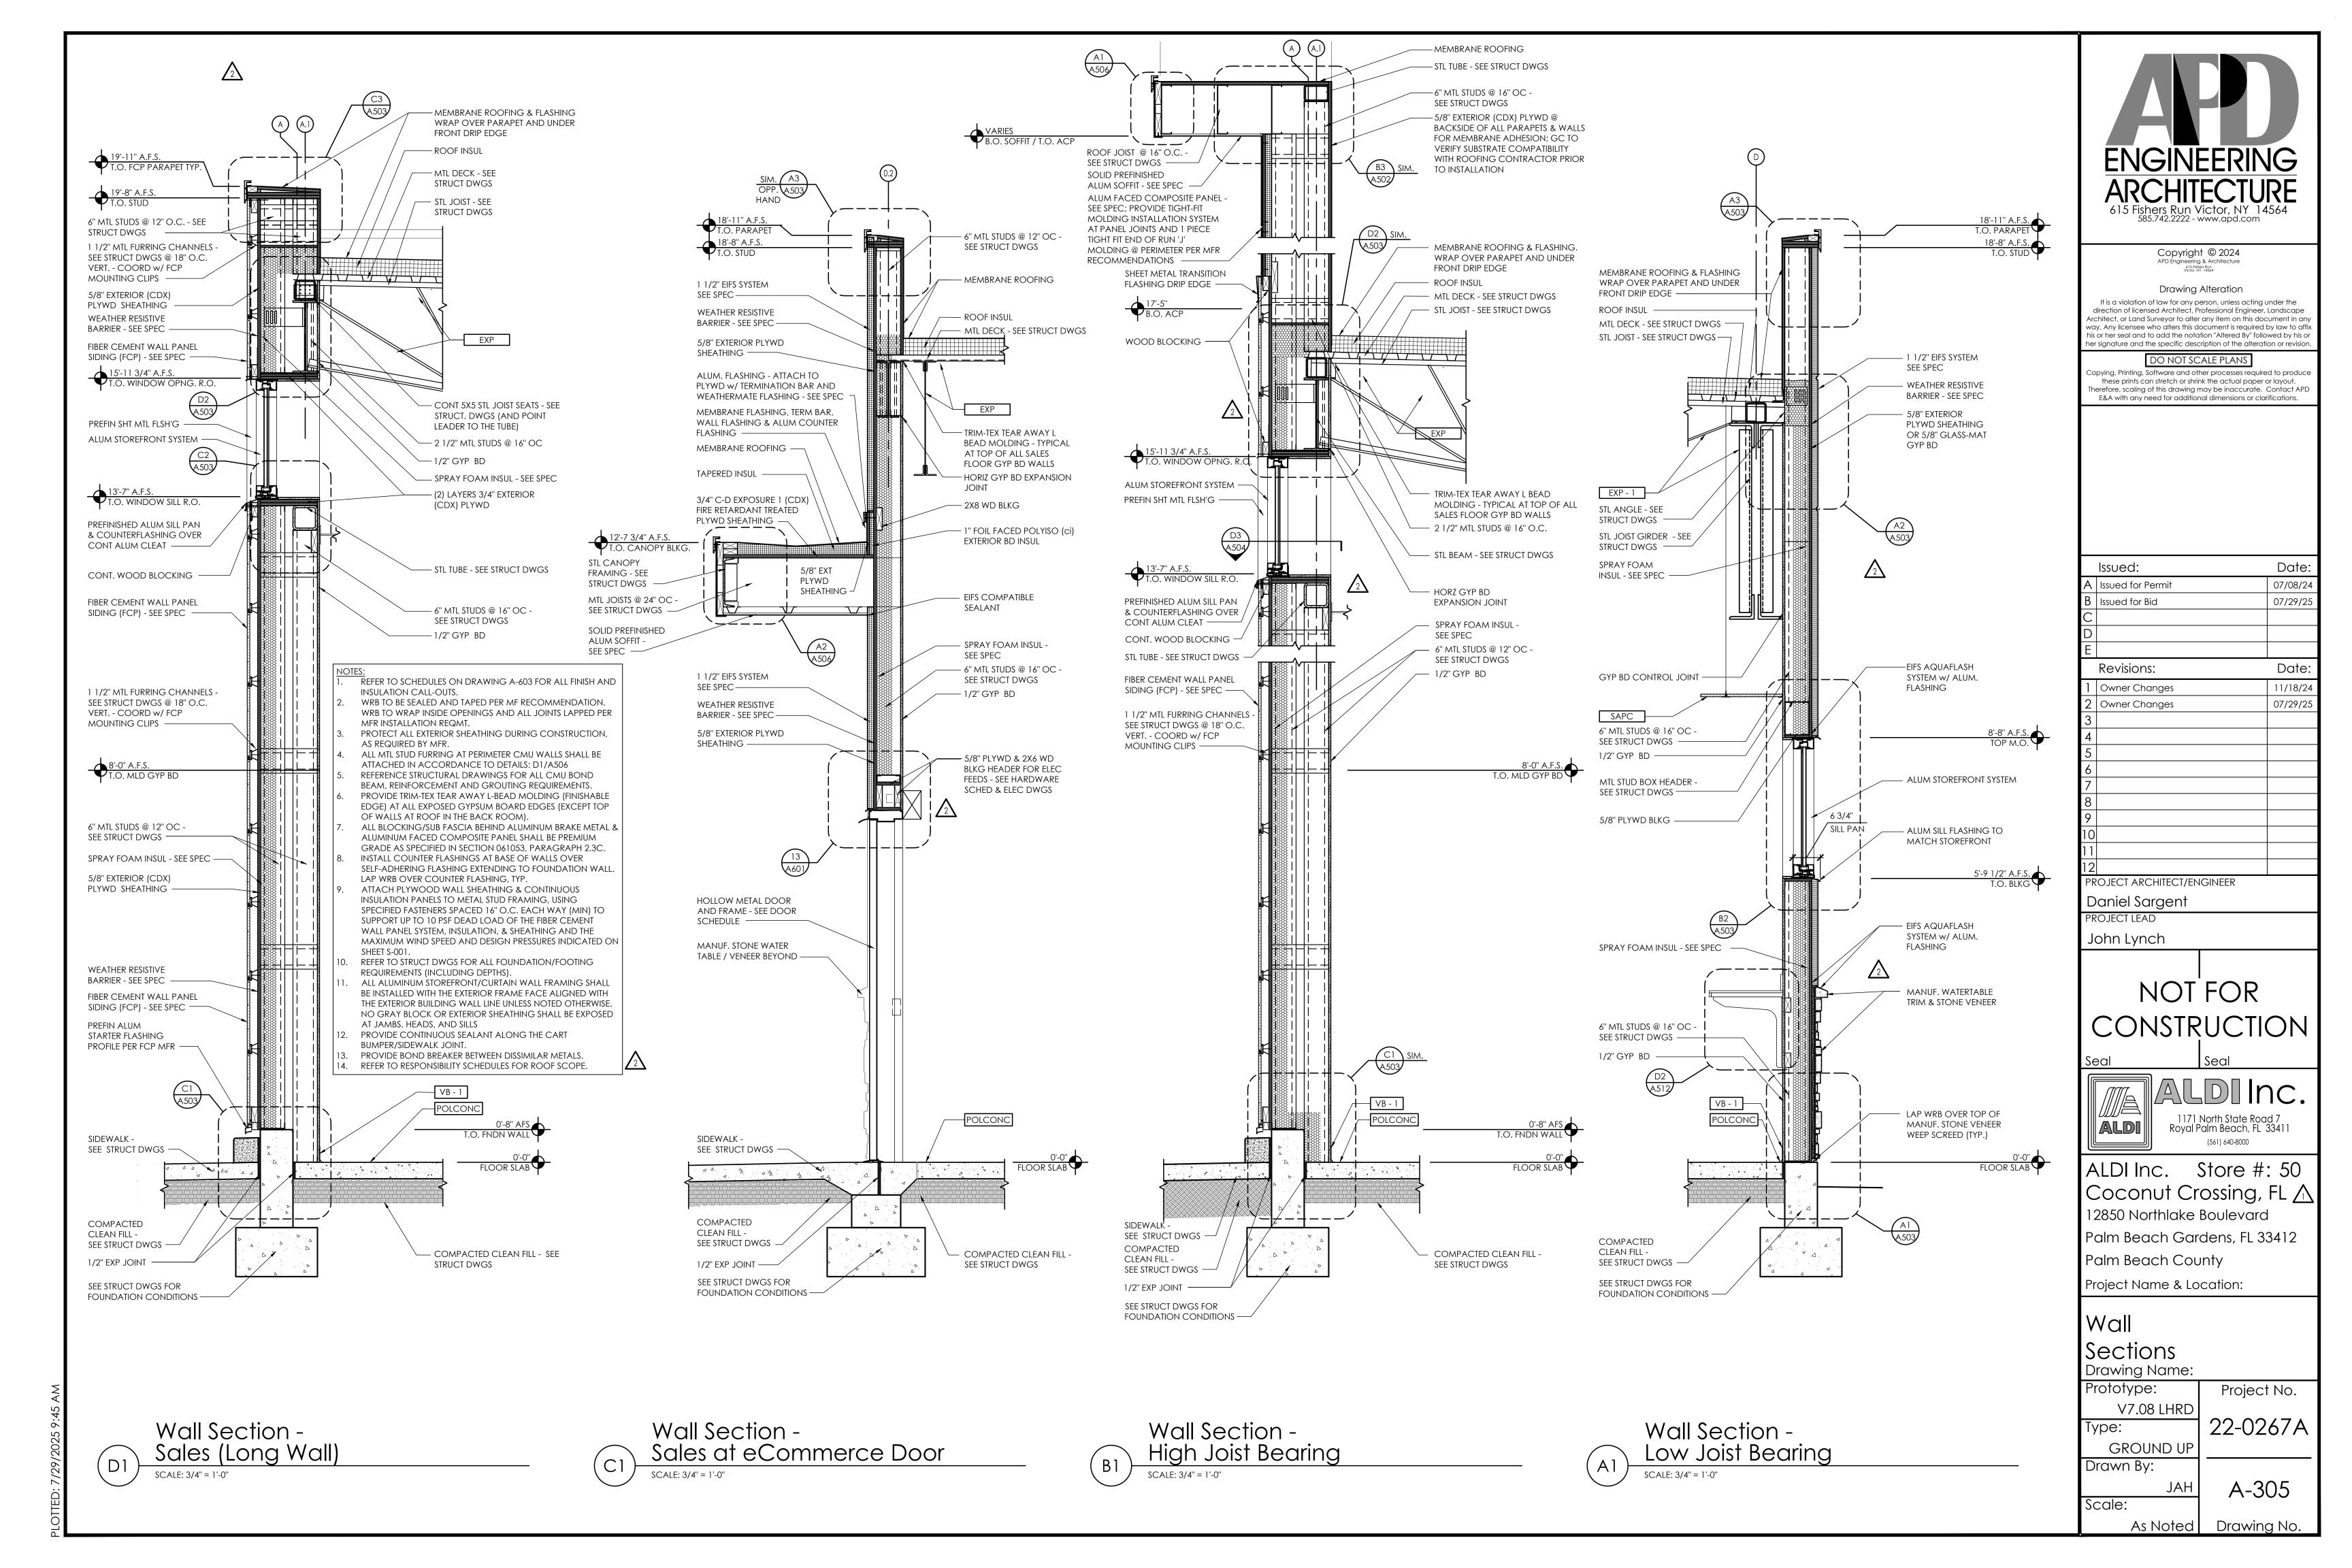


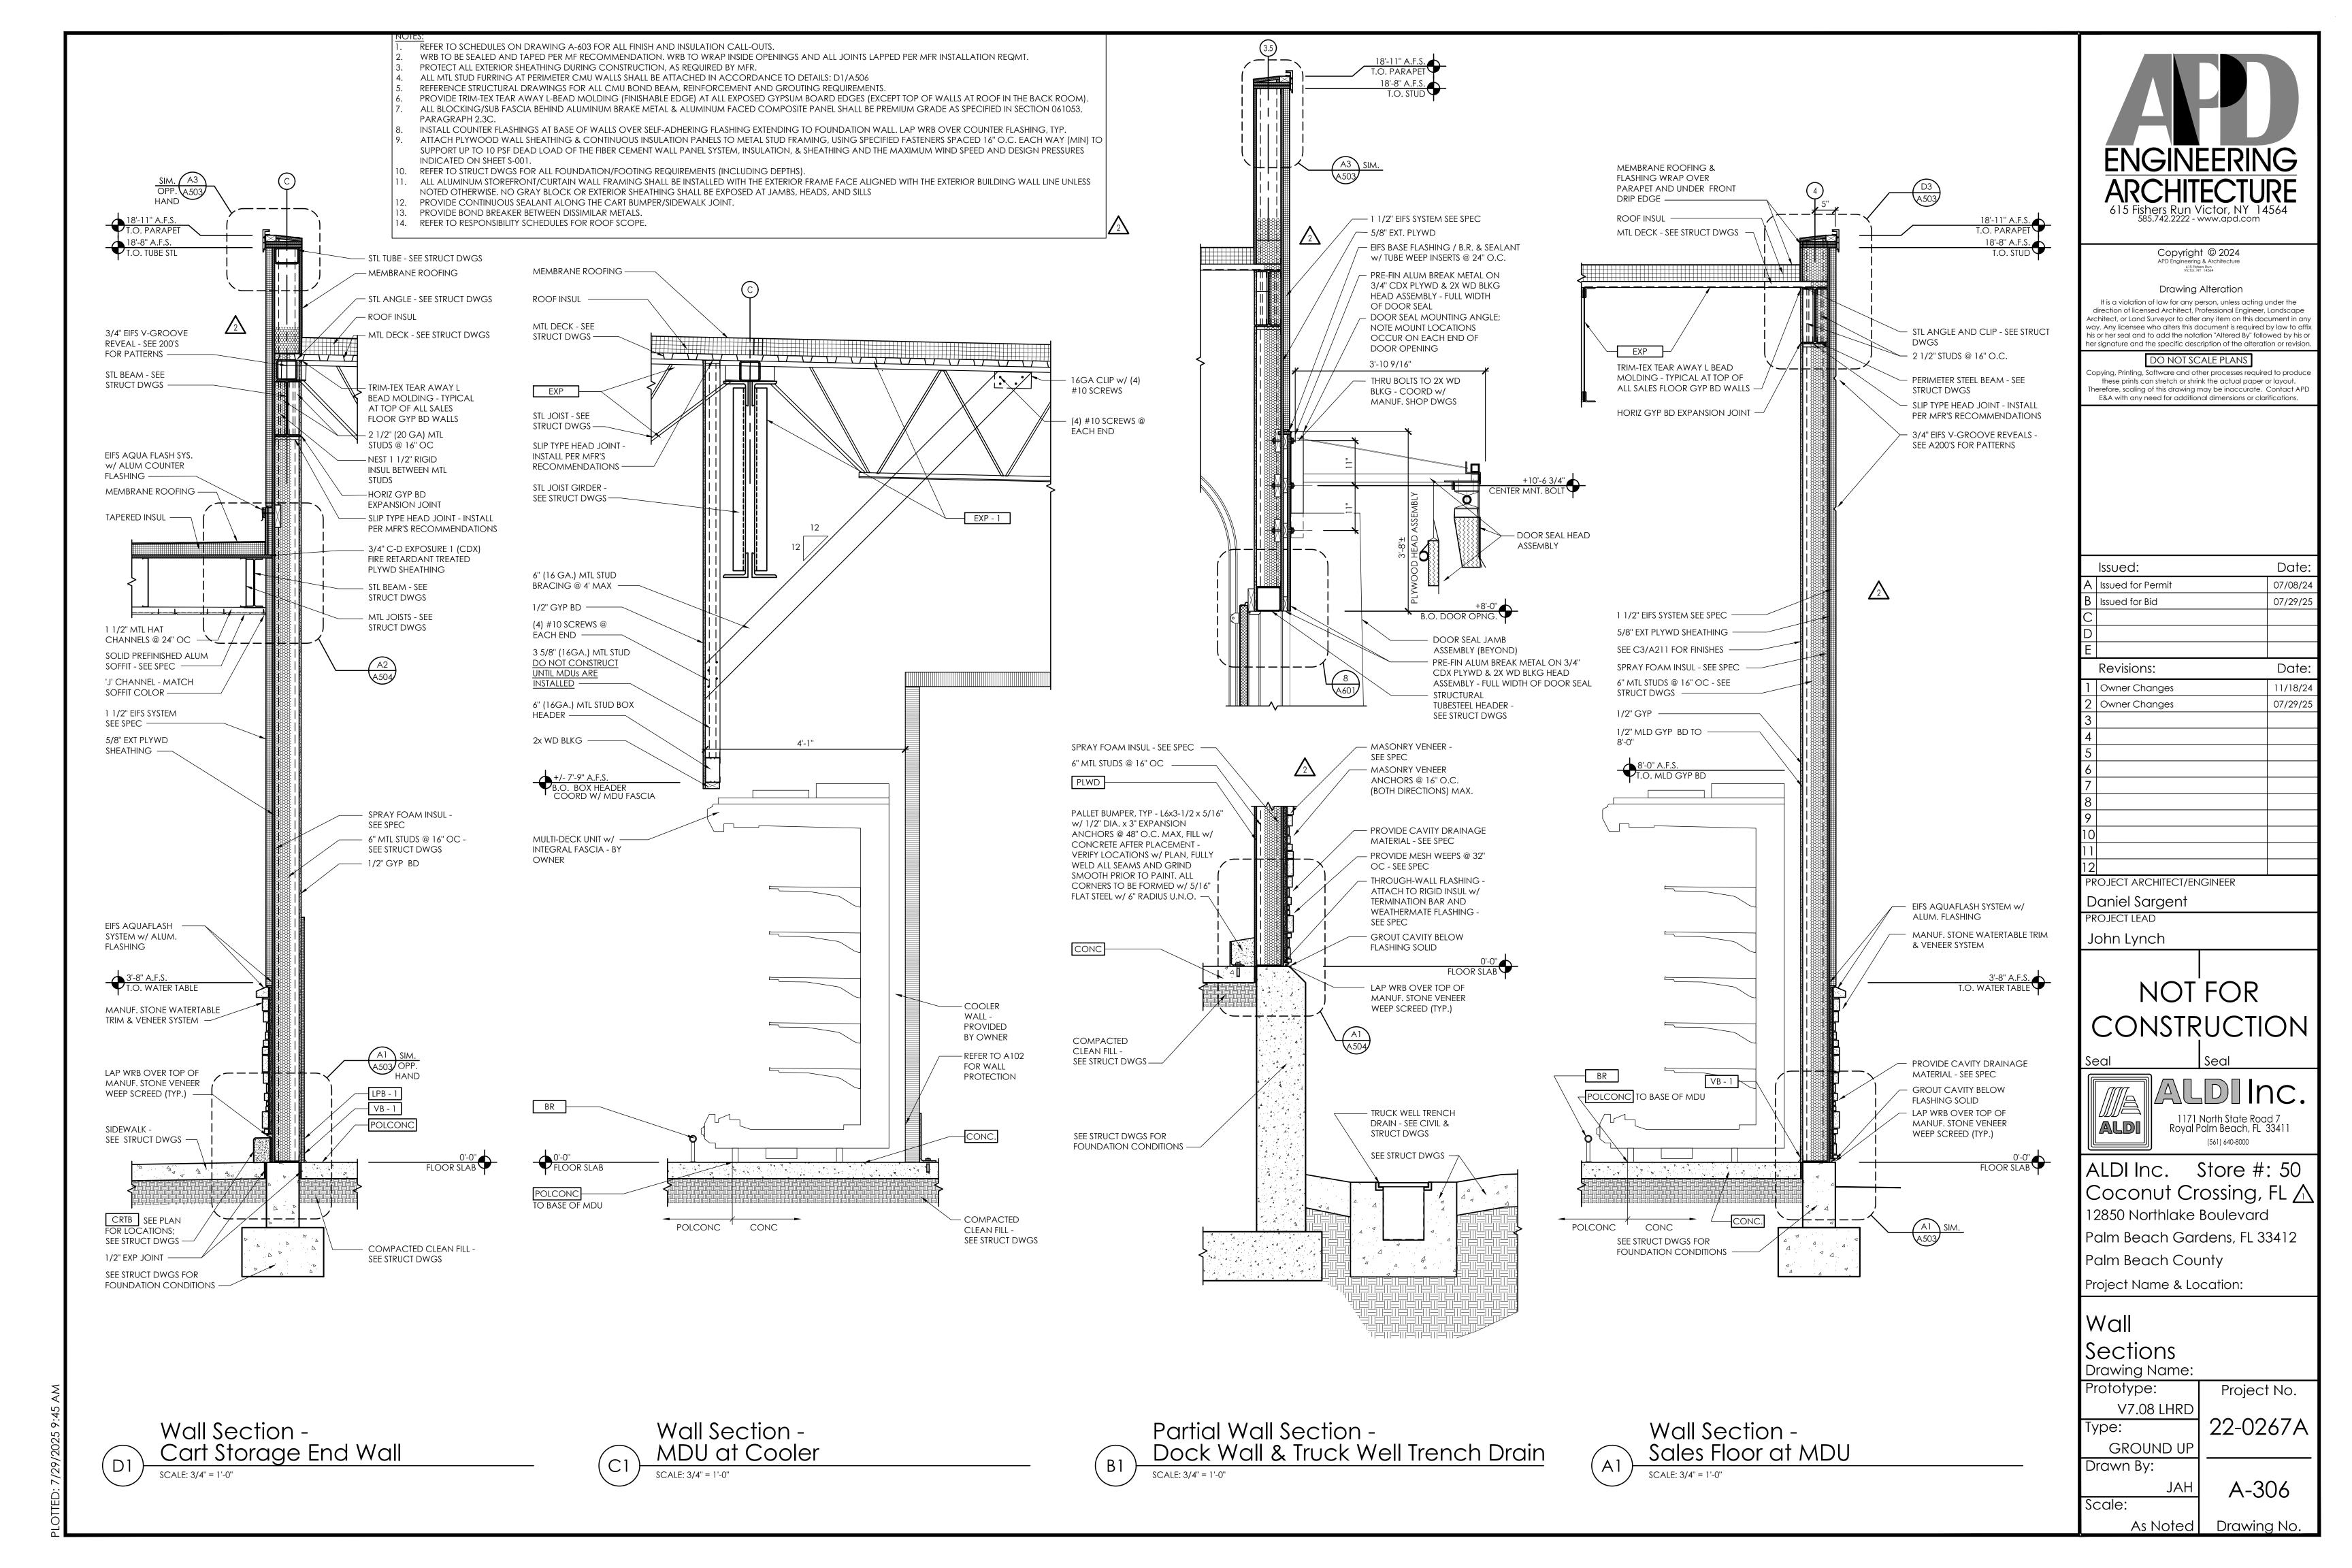

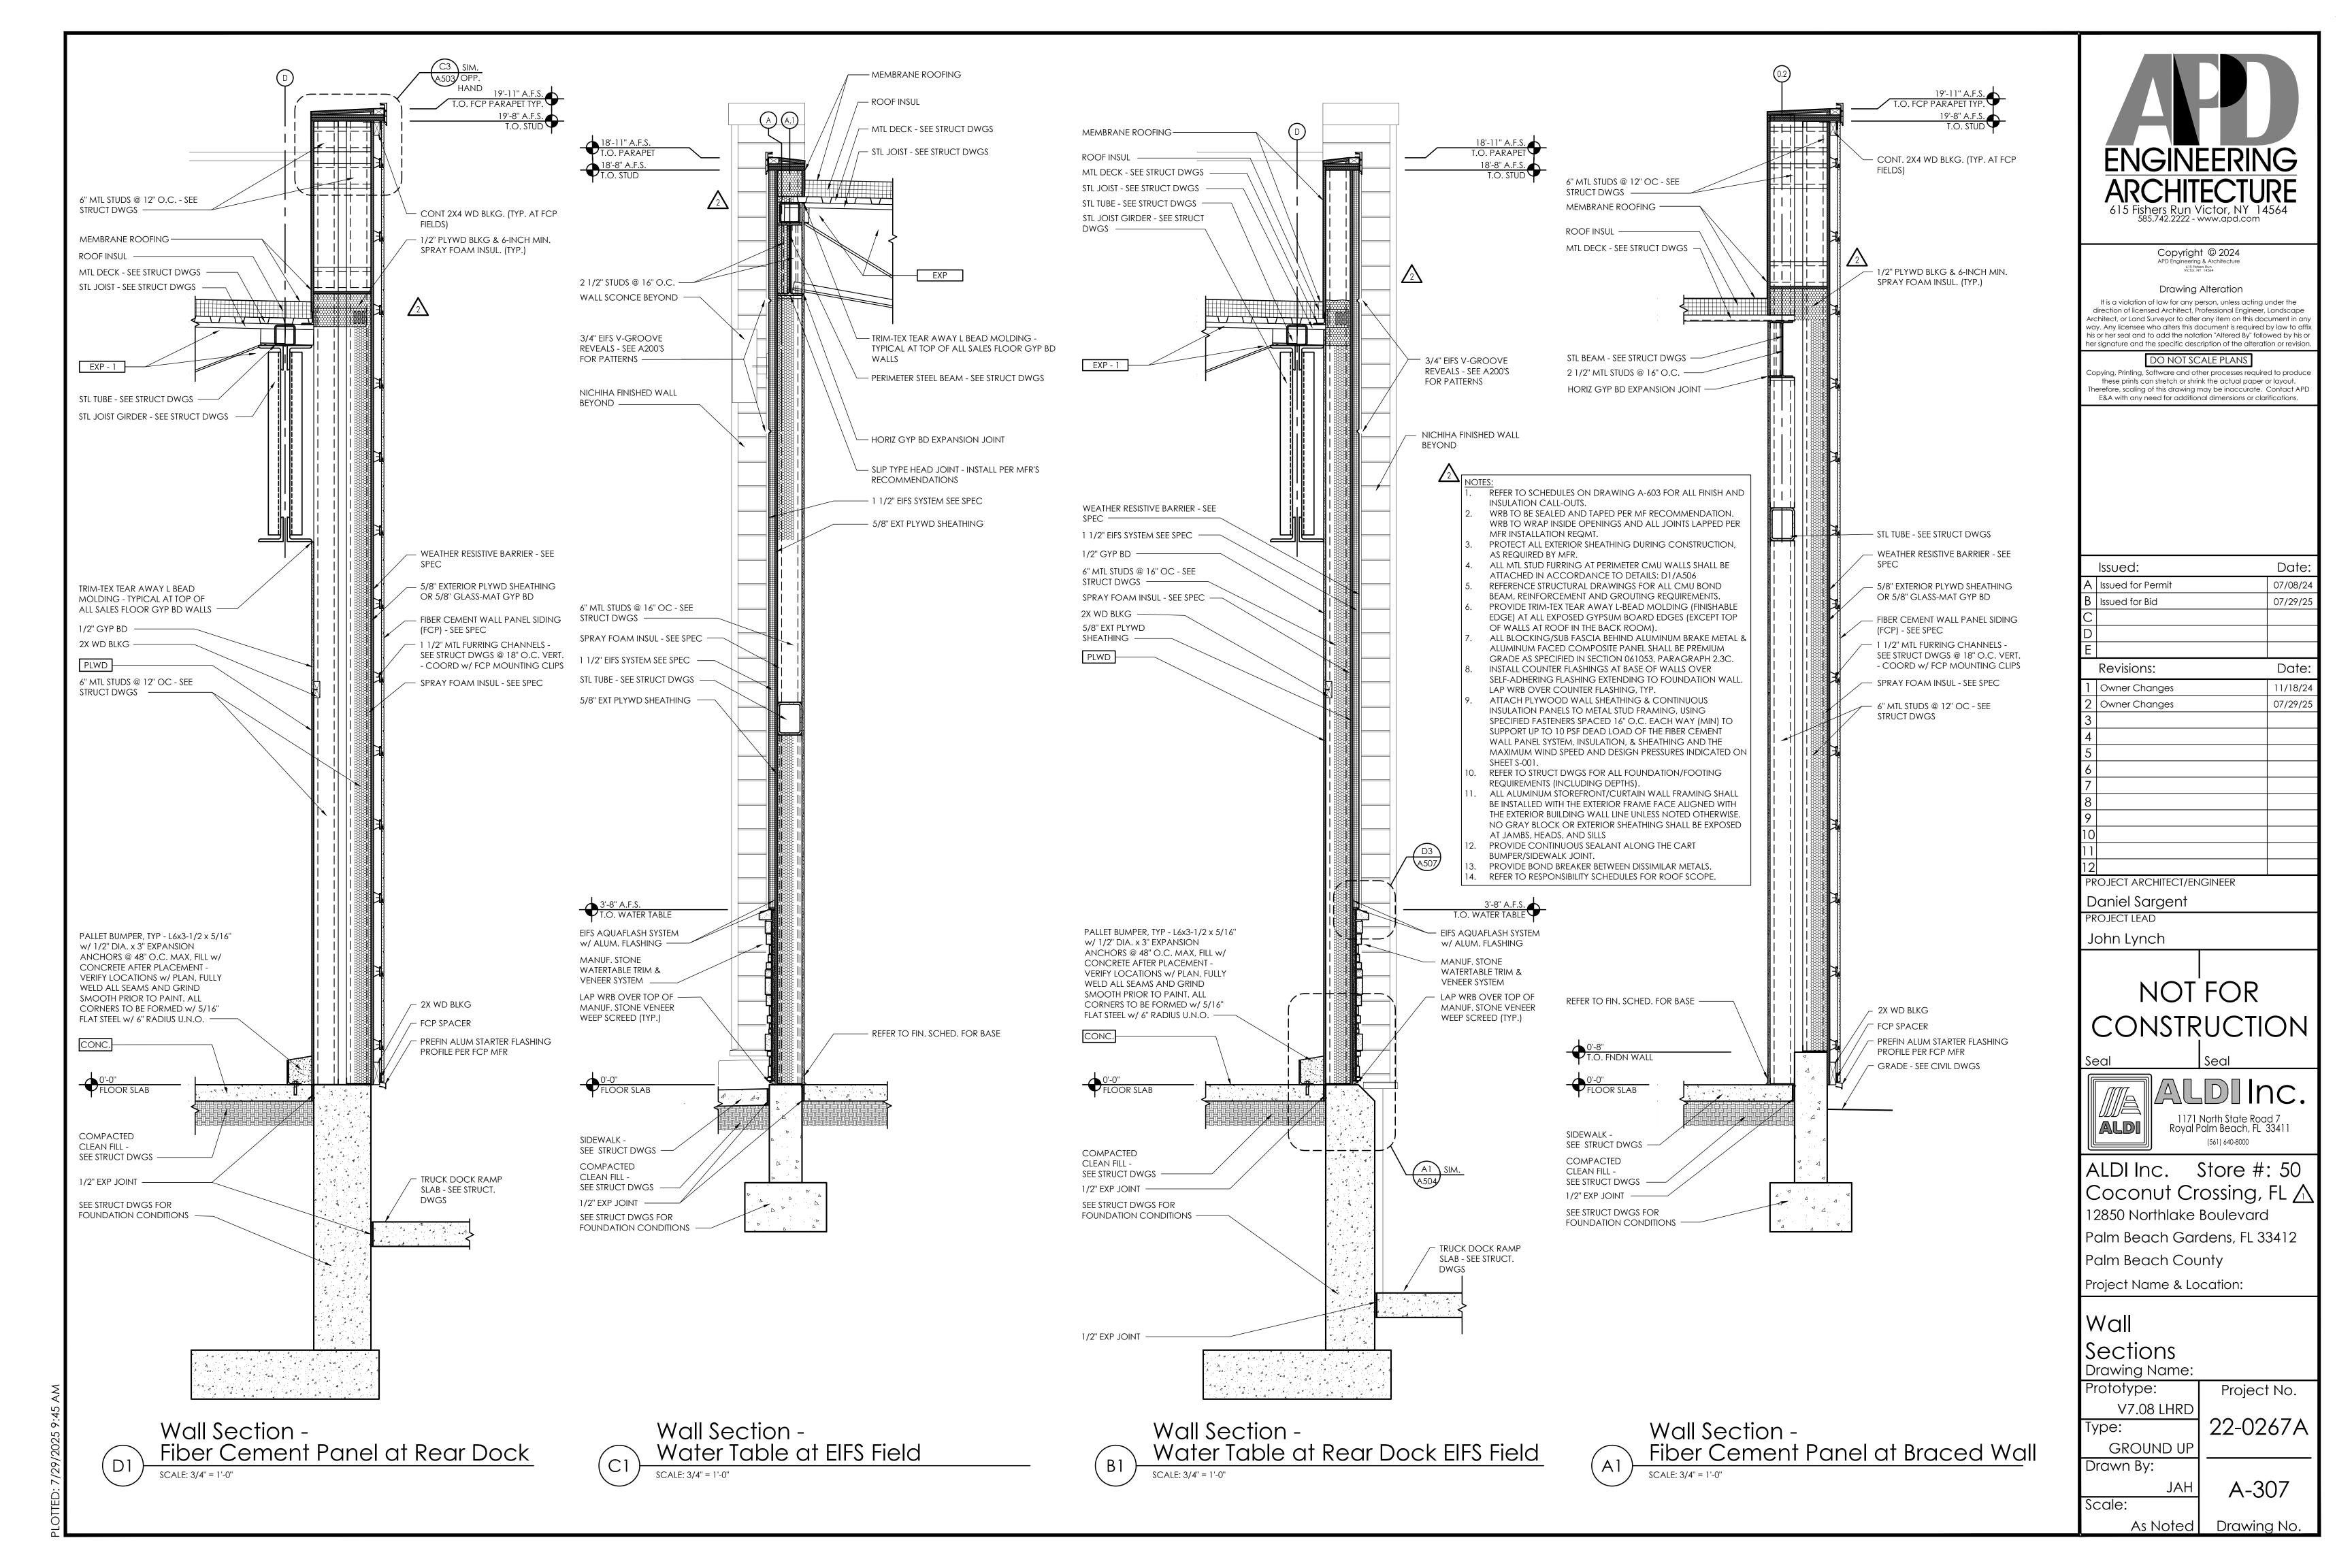

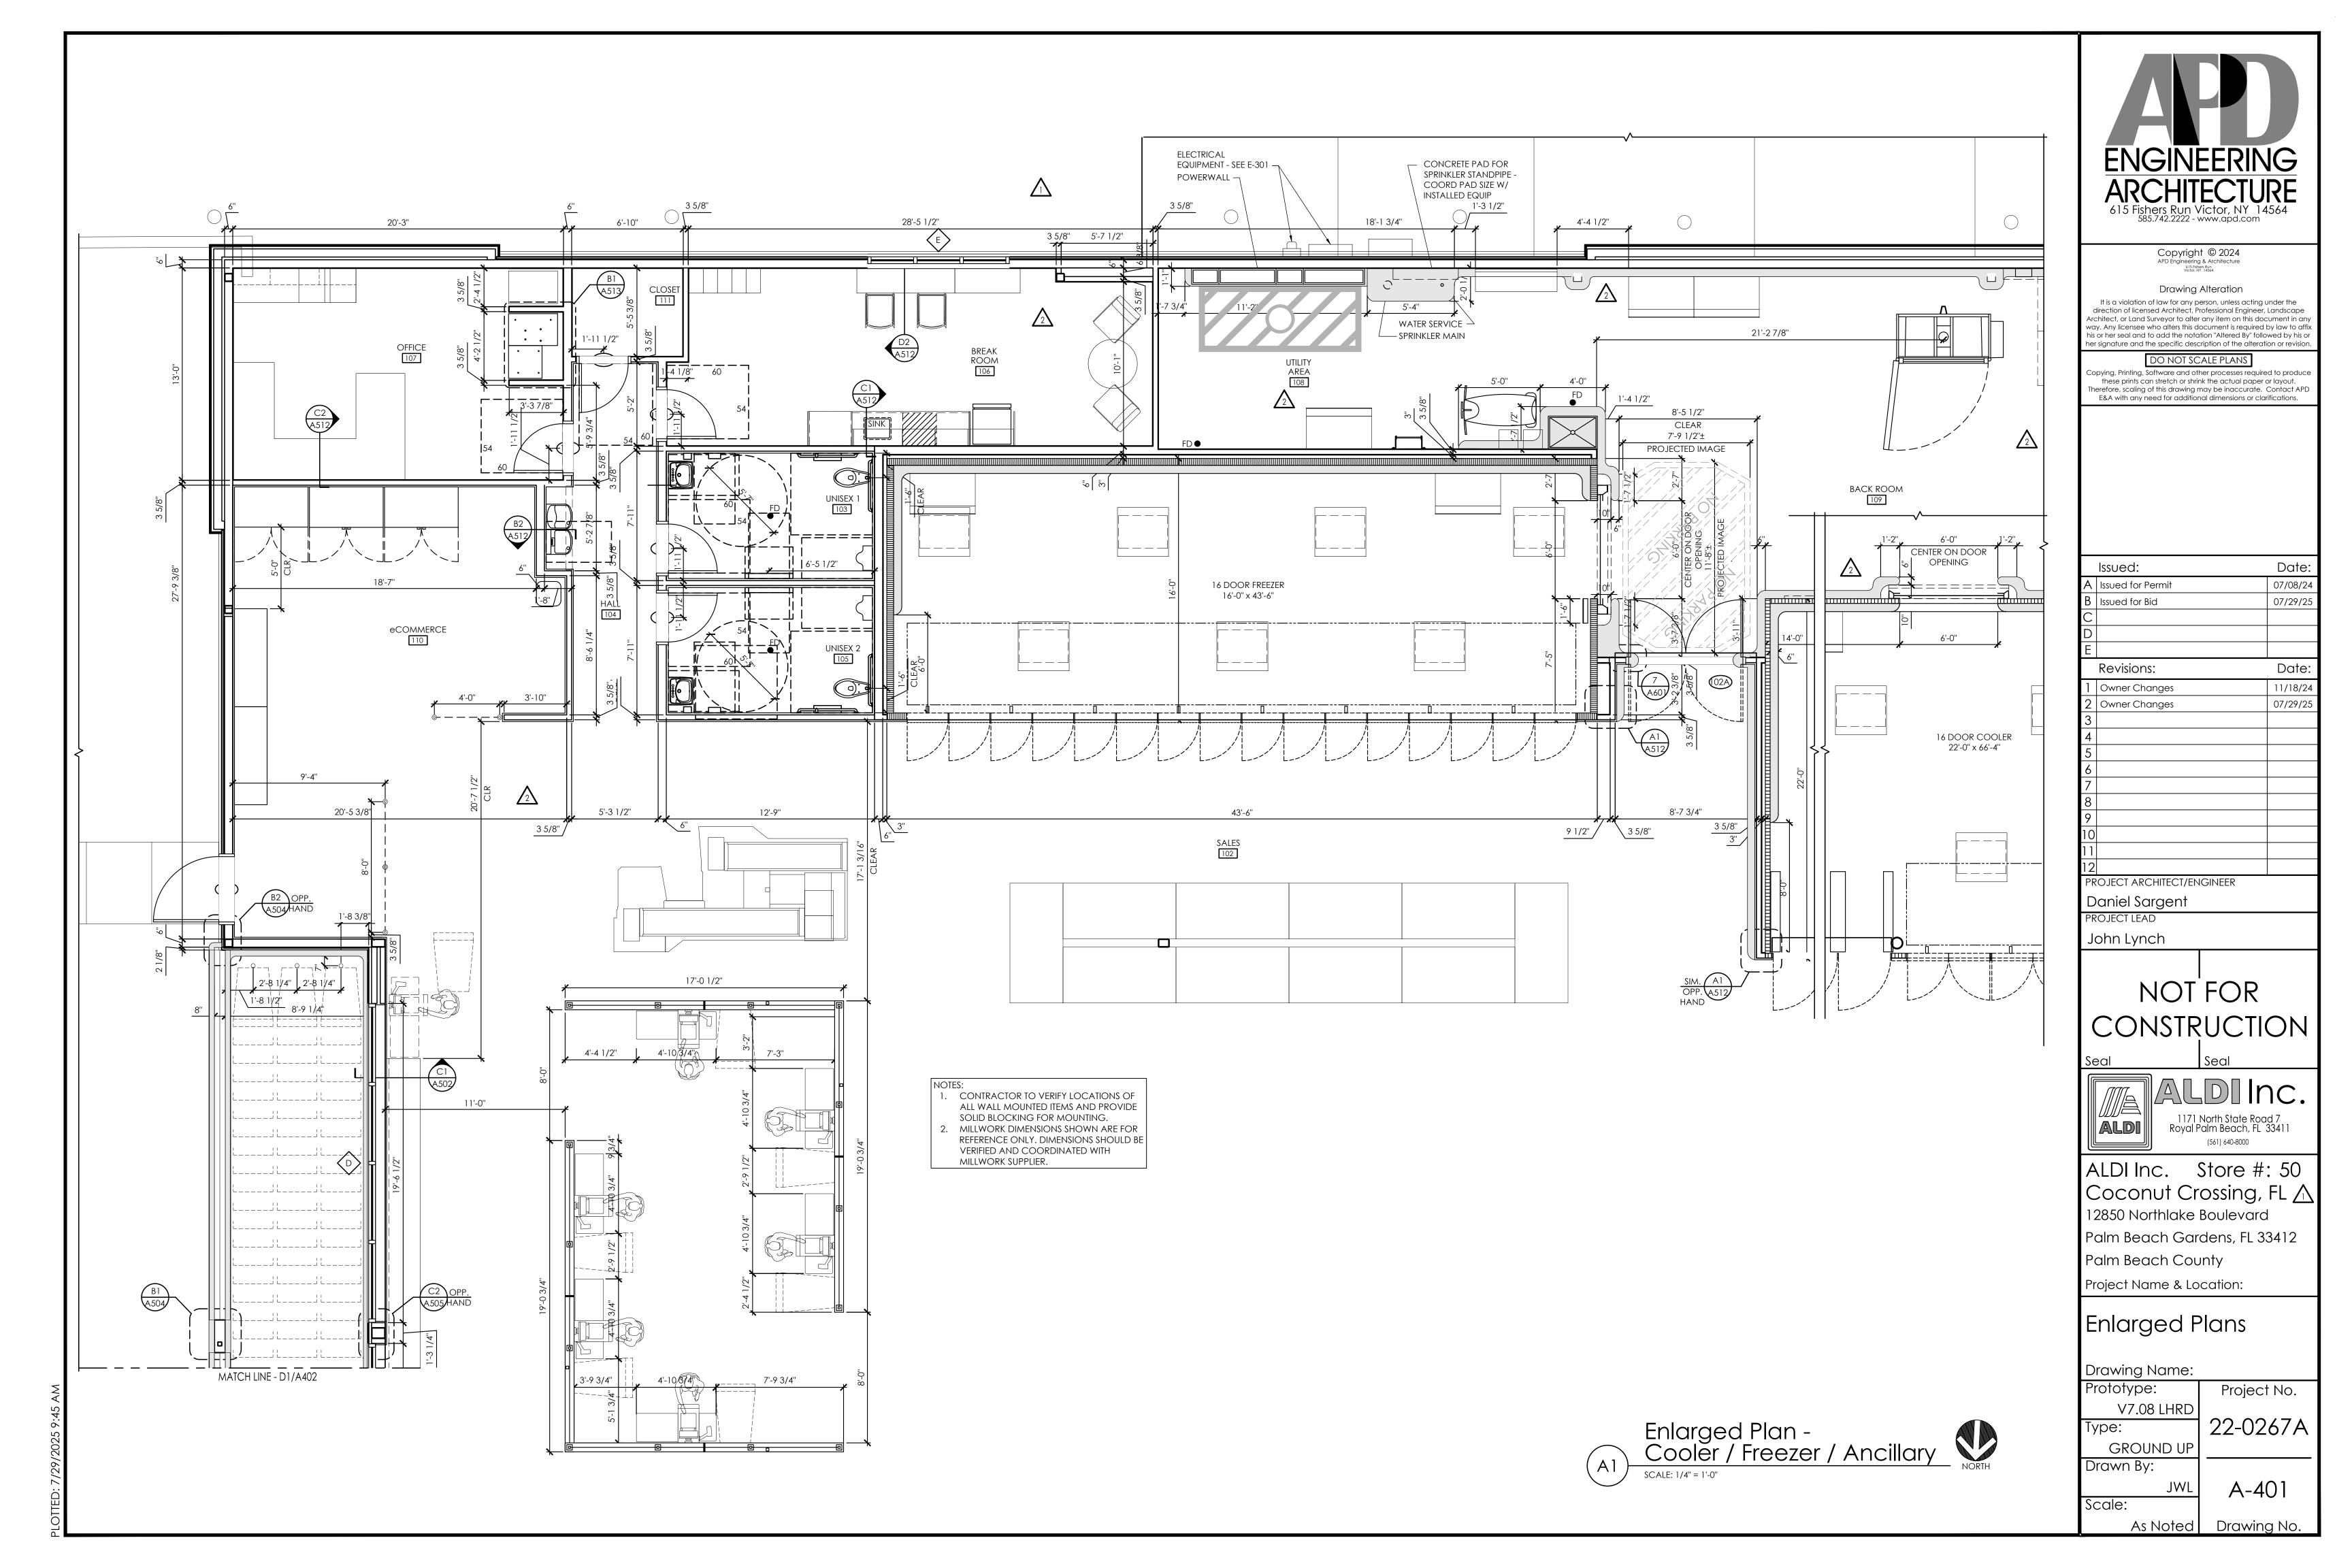

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PR	OJECT ARCHITECT/ENGINEER	
D	aniel Sargent	
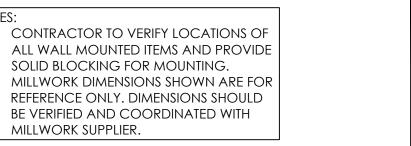
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PROJECT LEAD

John Lynch



Store #: 50 Coconut Crossing, FL 🛆 12850 Northlake Boulevard

Palm Beach Gardens, FL 33412

Palm Beach County Project Name & Location:

Enlarged Plans

Drawing Name: Prototype:


Project No.

V7.08 LHRD 22-0267A GROUND UP

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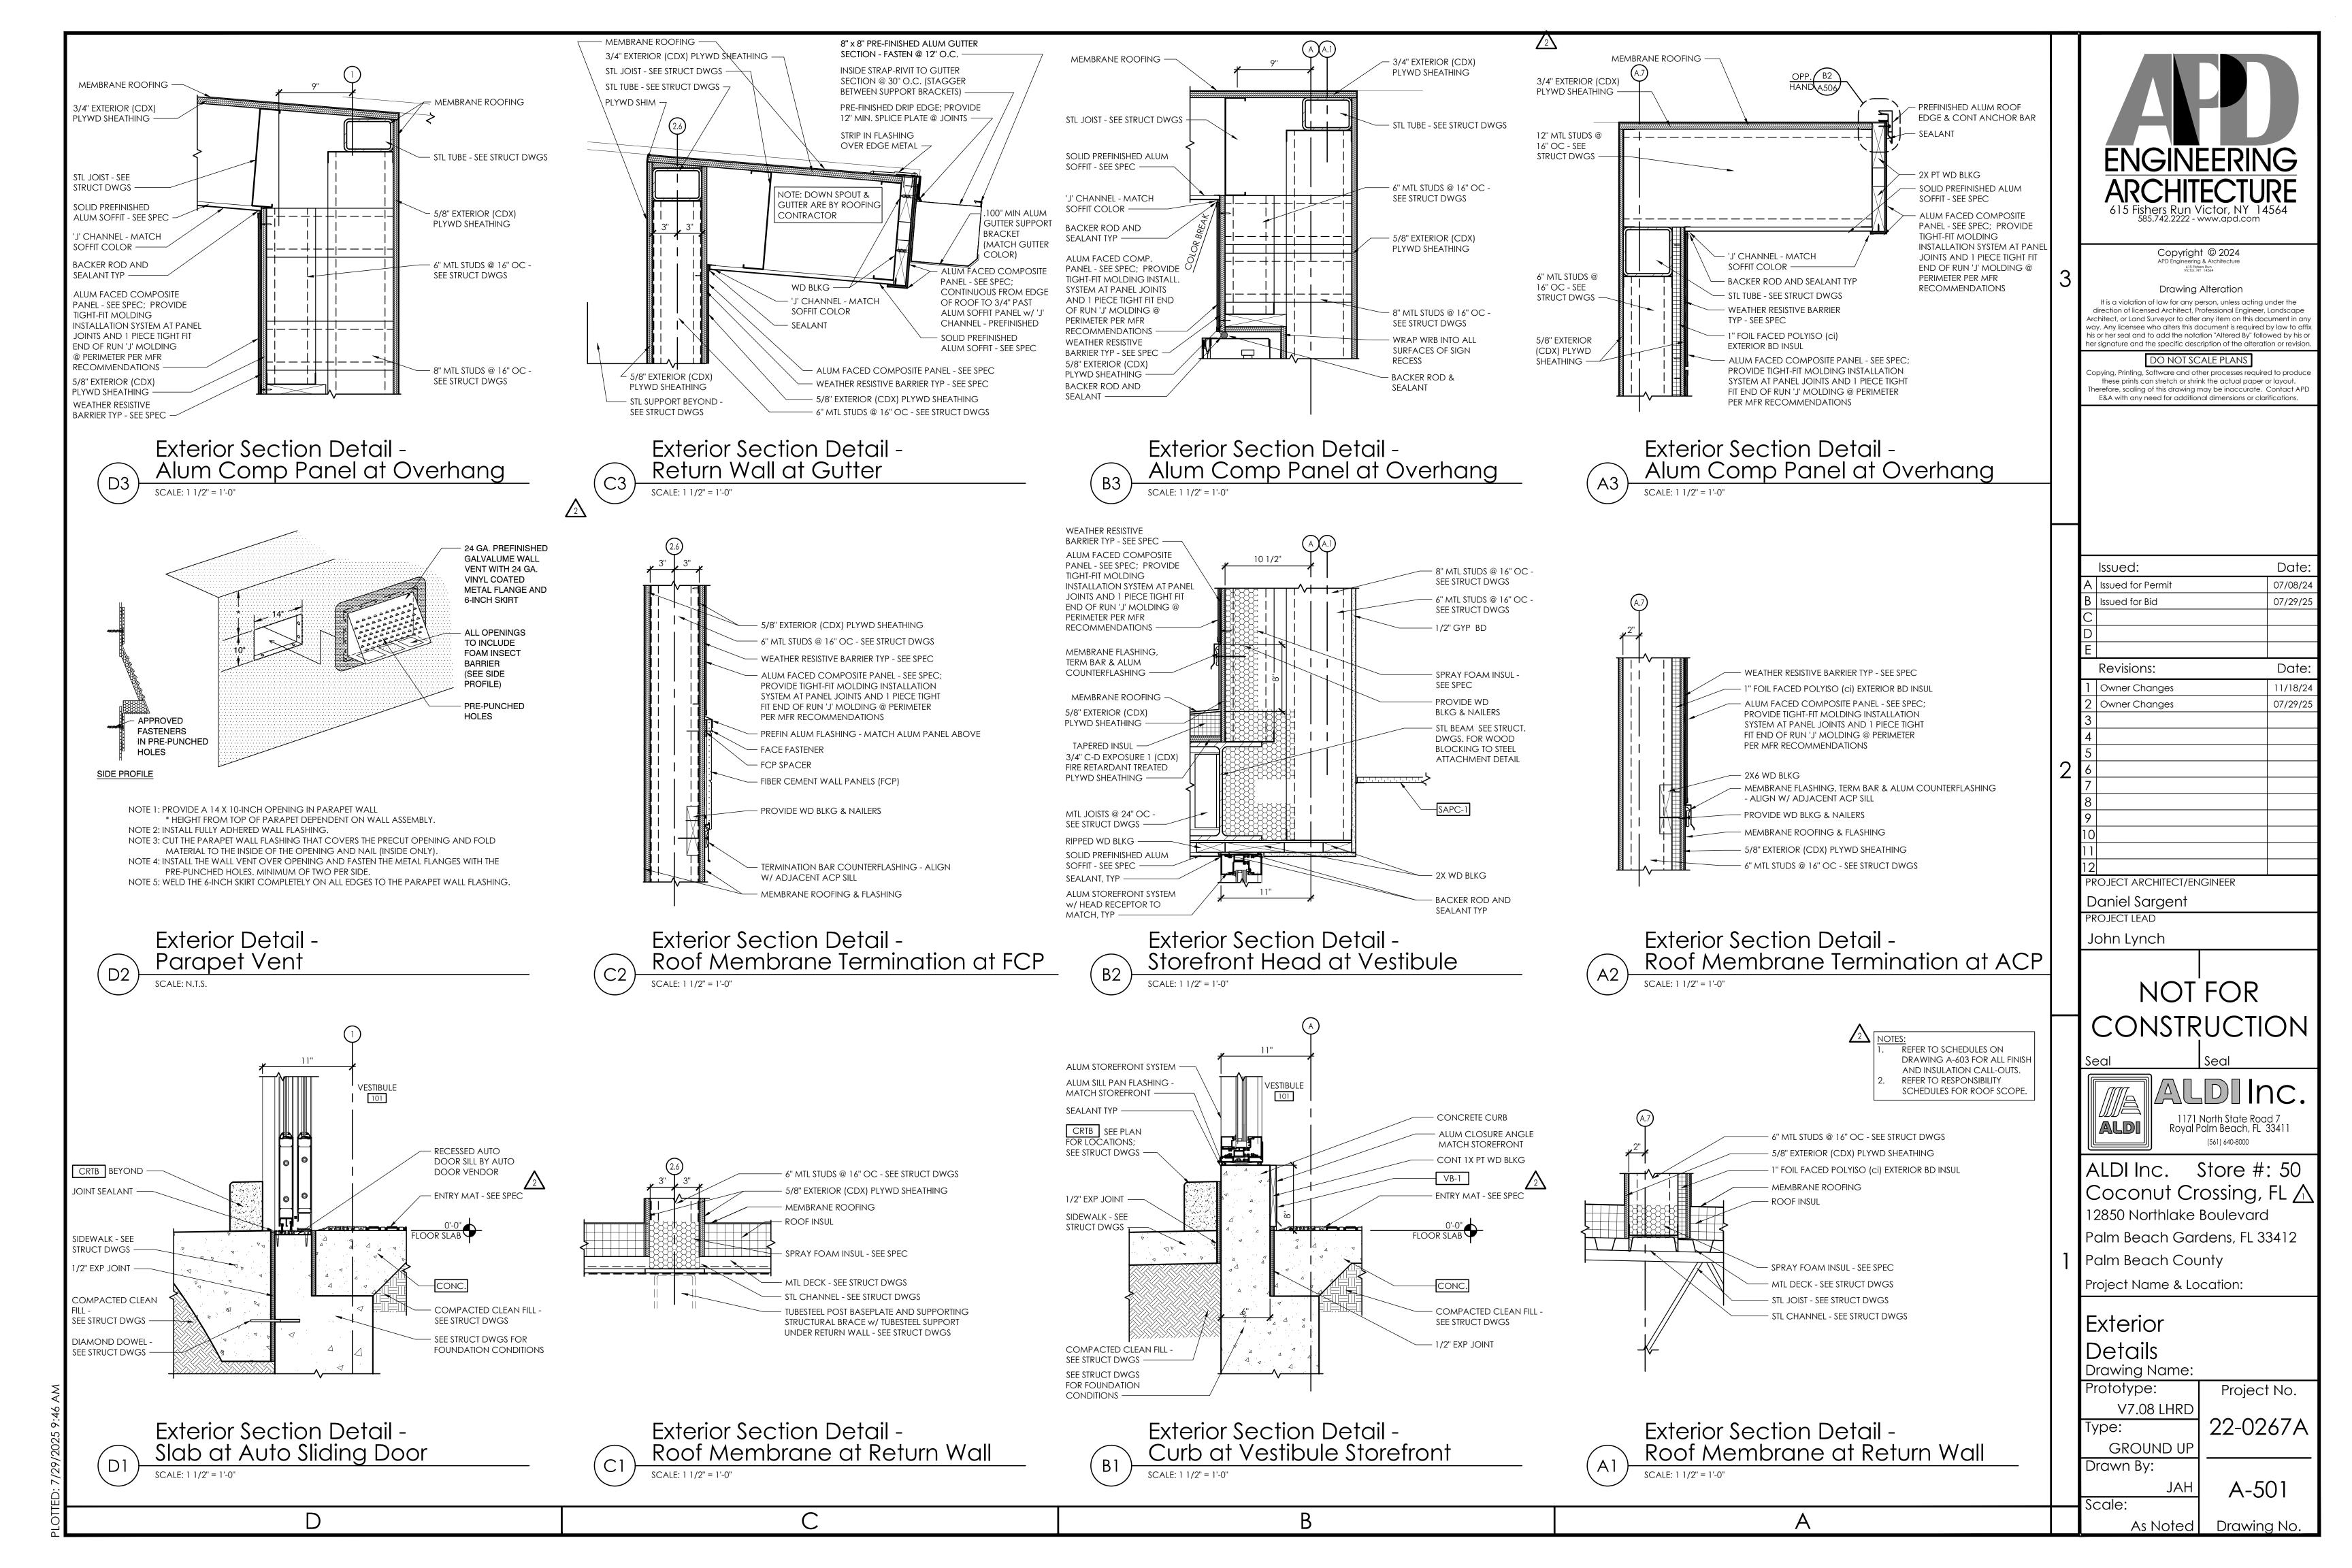
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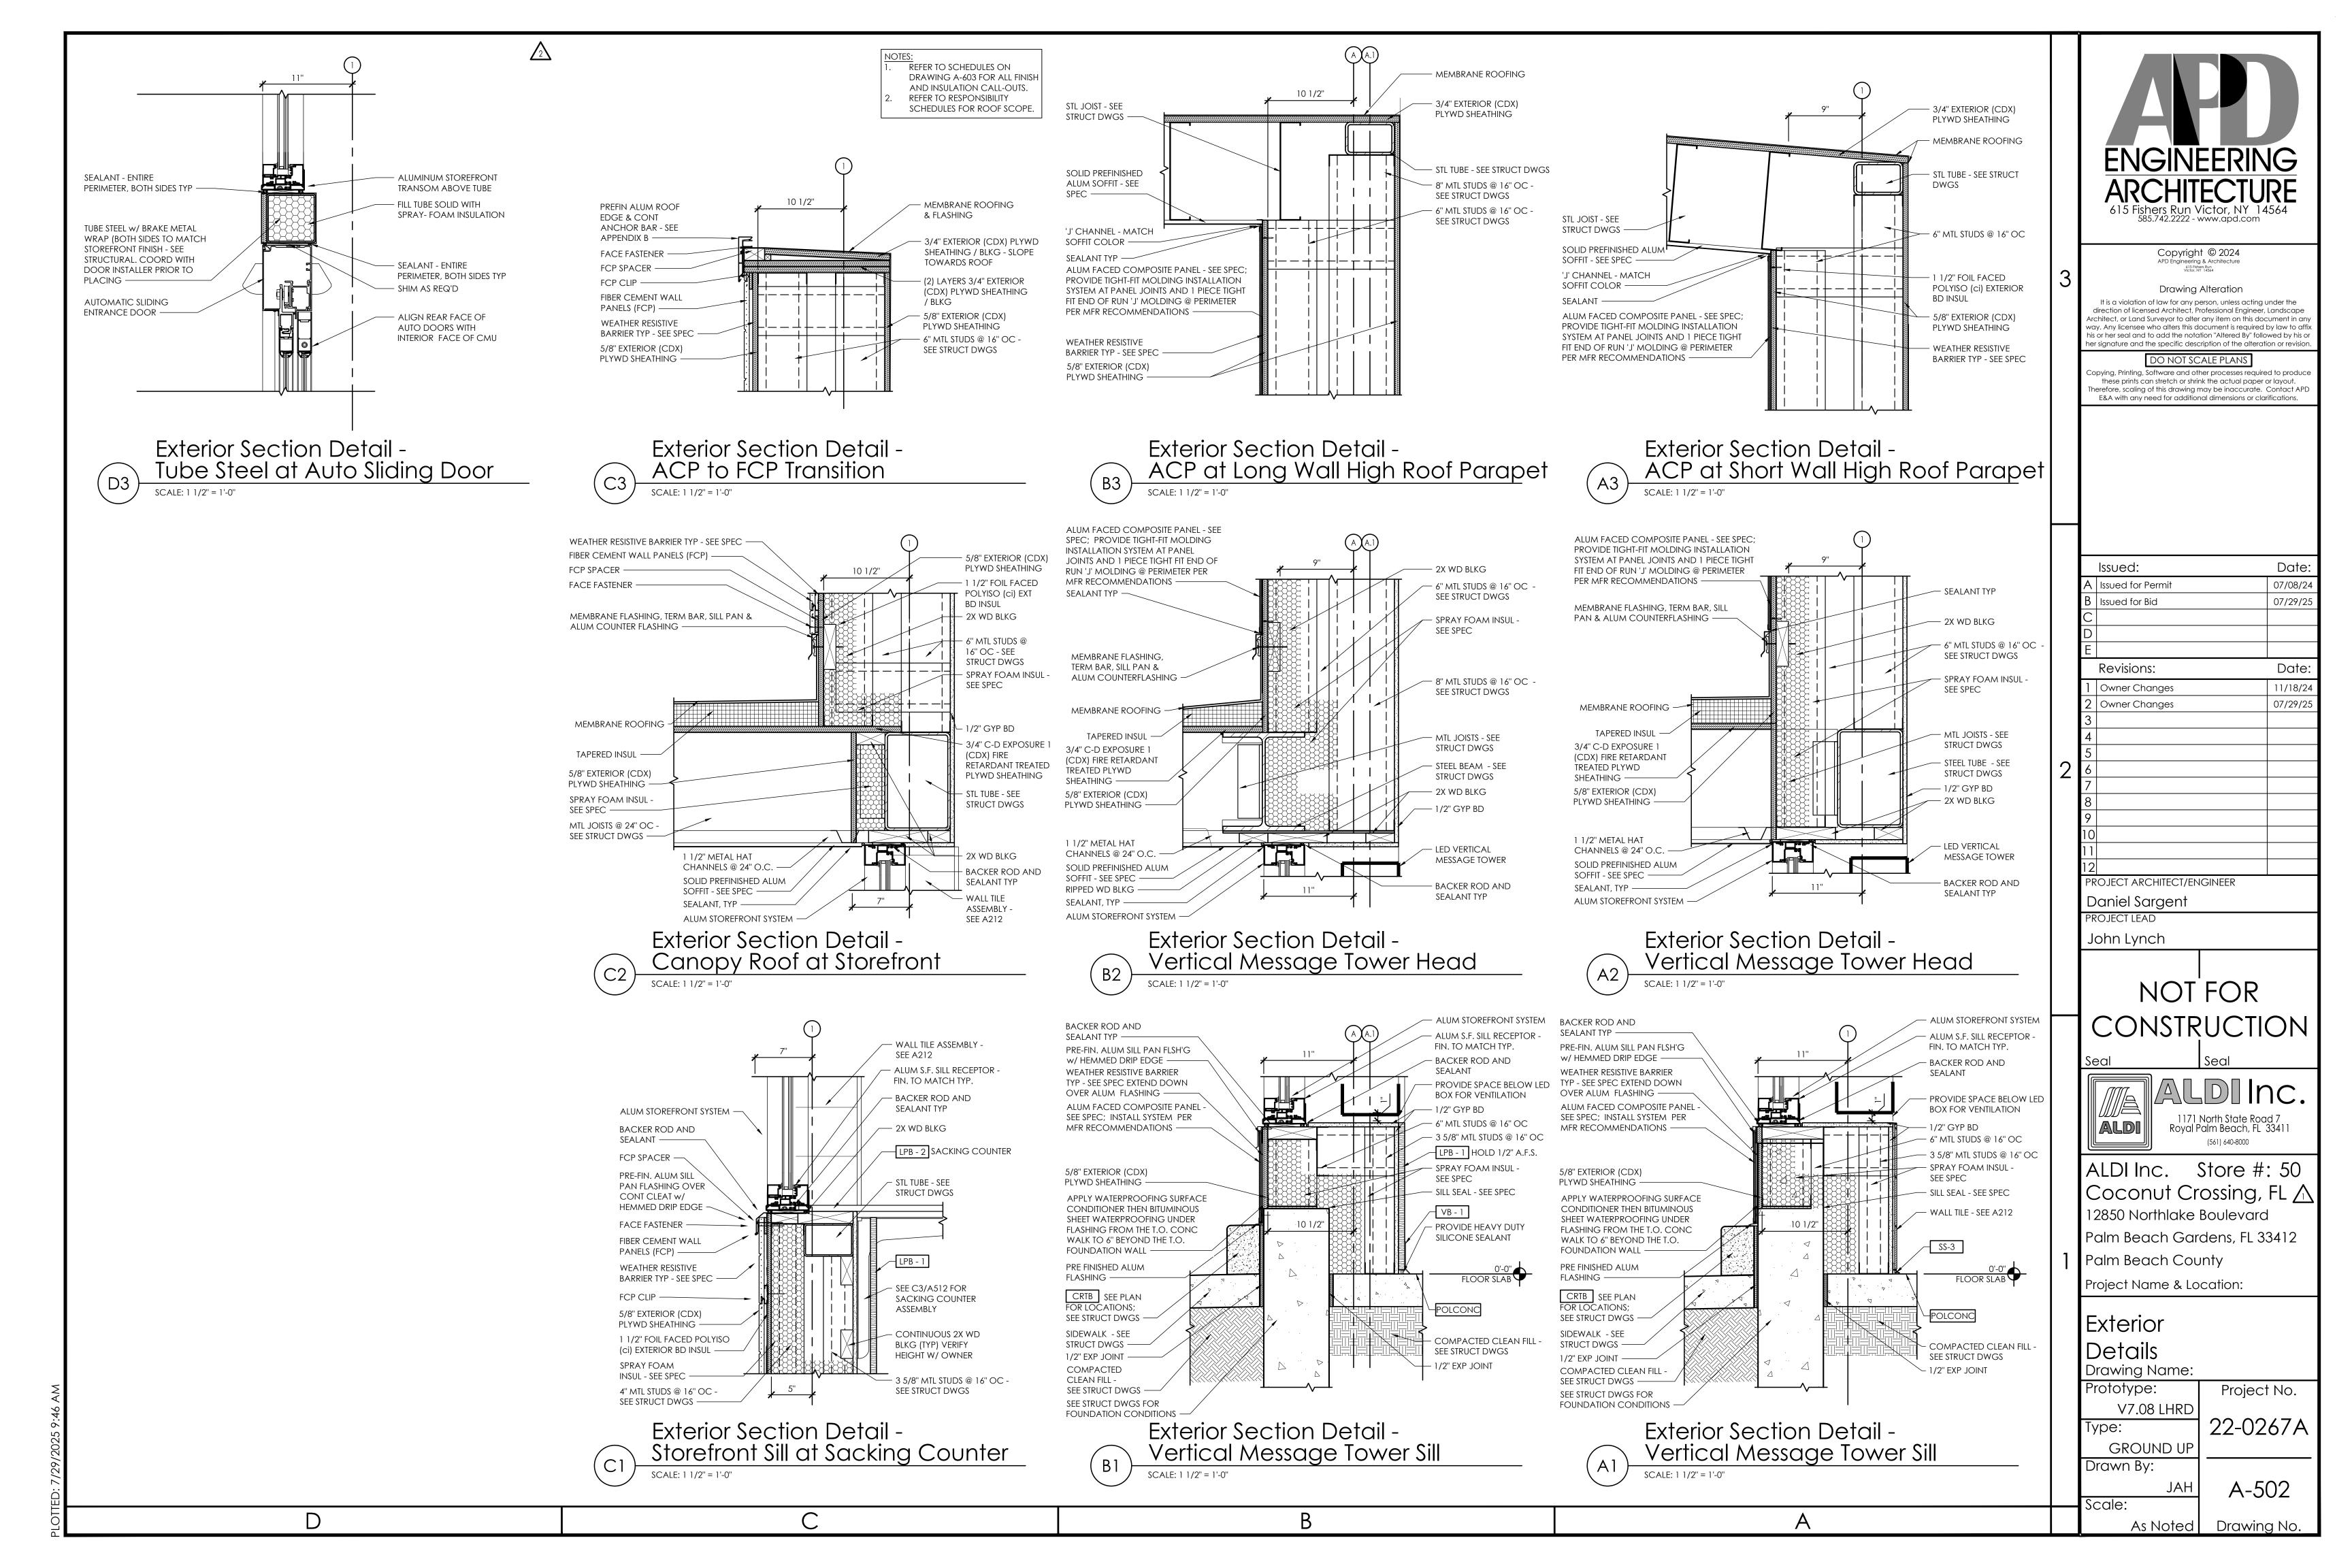
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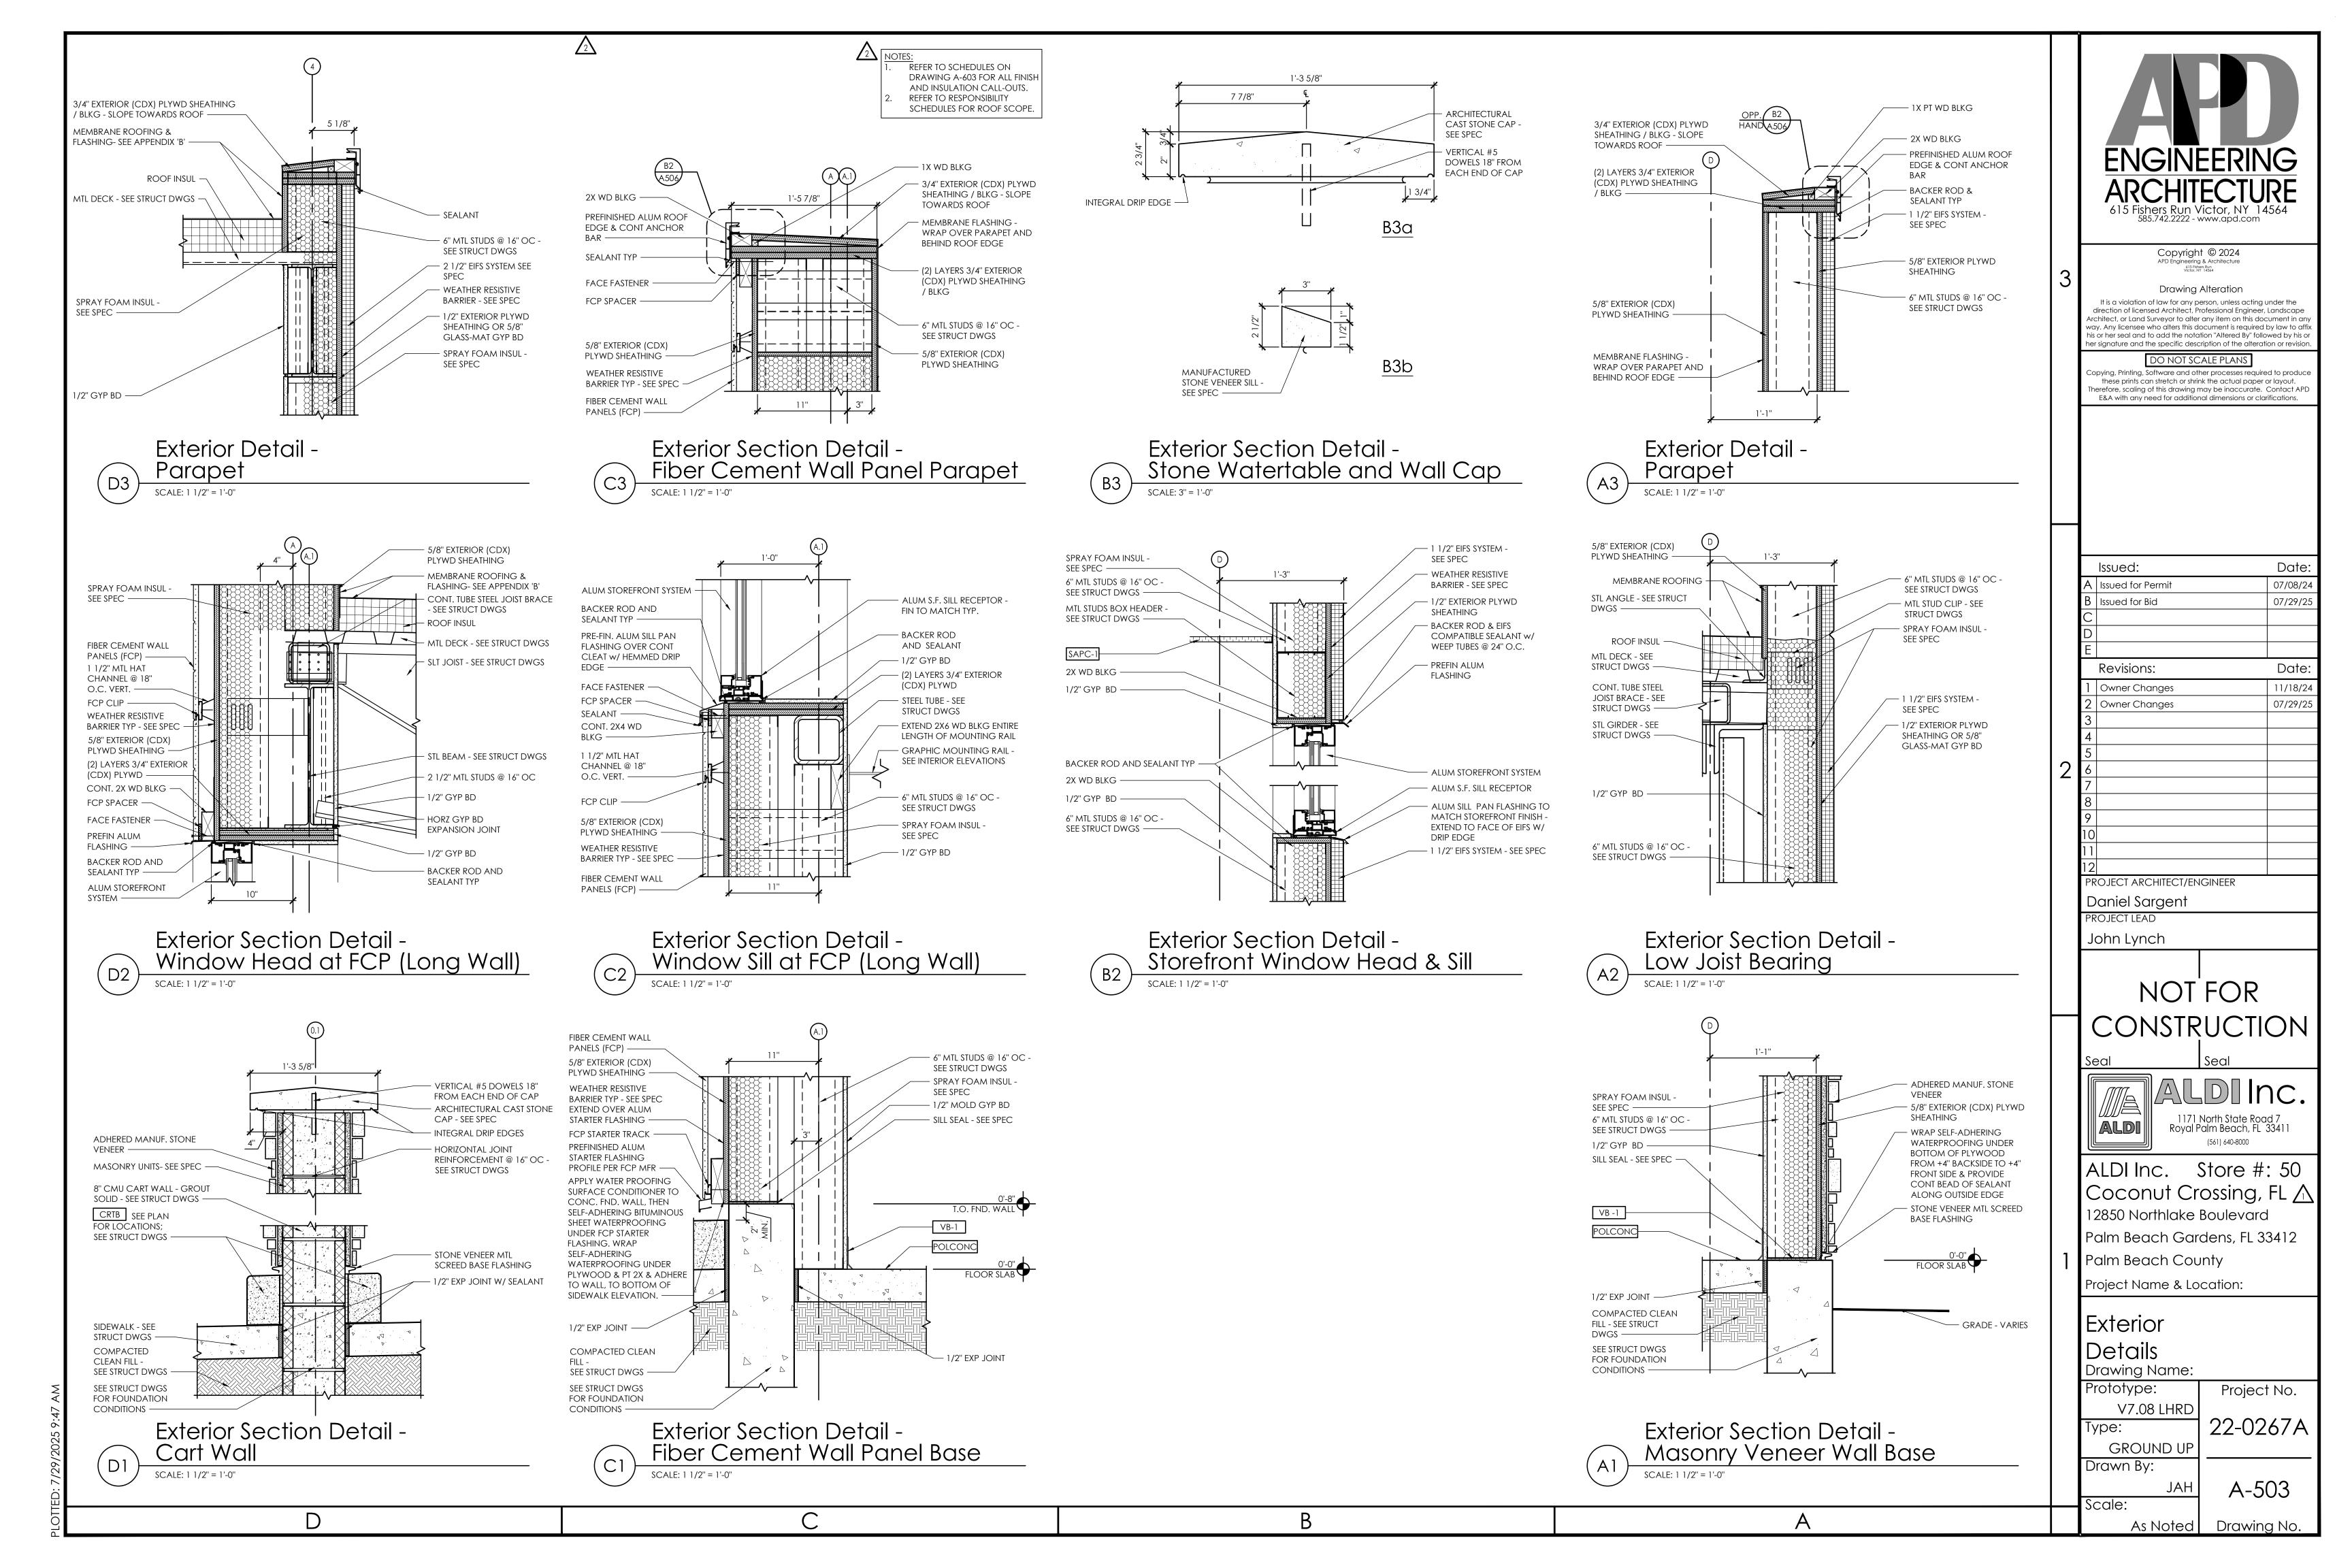



Enlarged Plan -Entry (D1


SCALE: 1/4" = 1'-0"

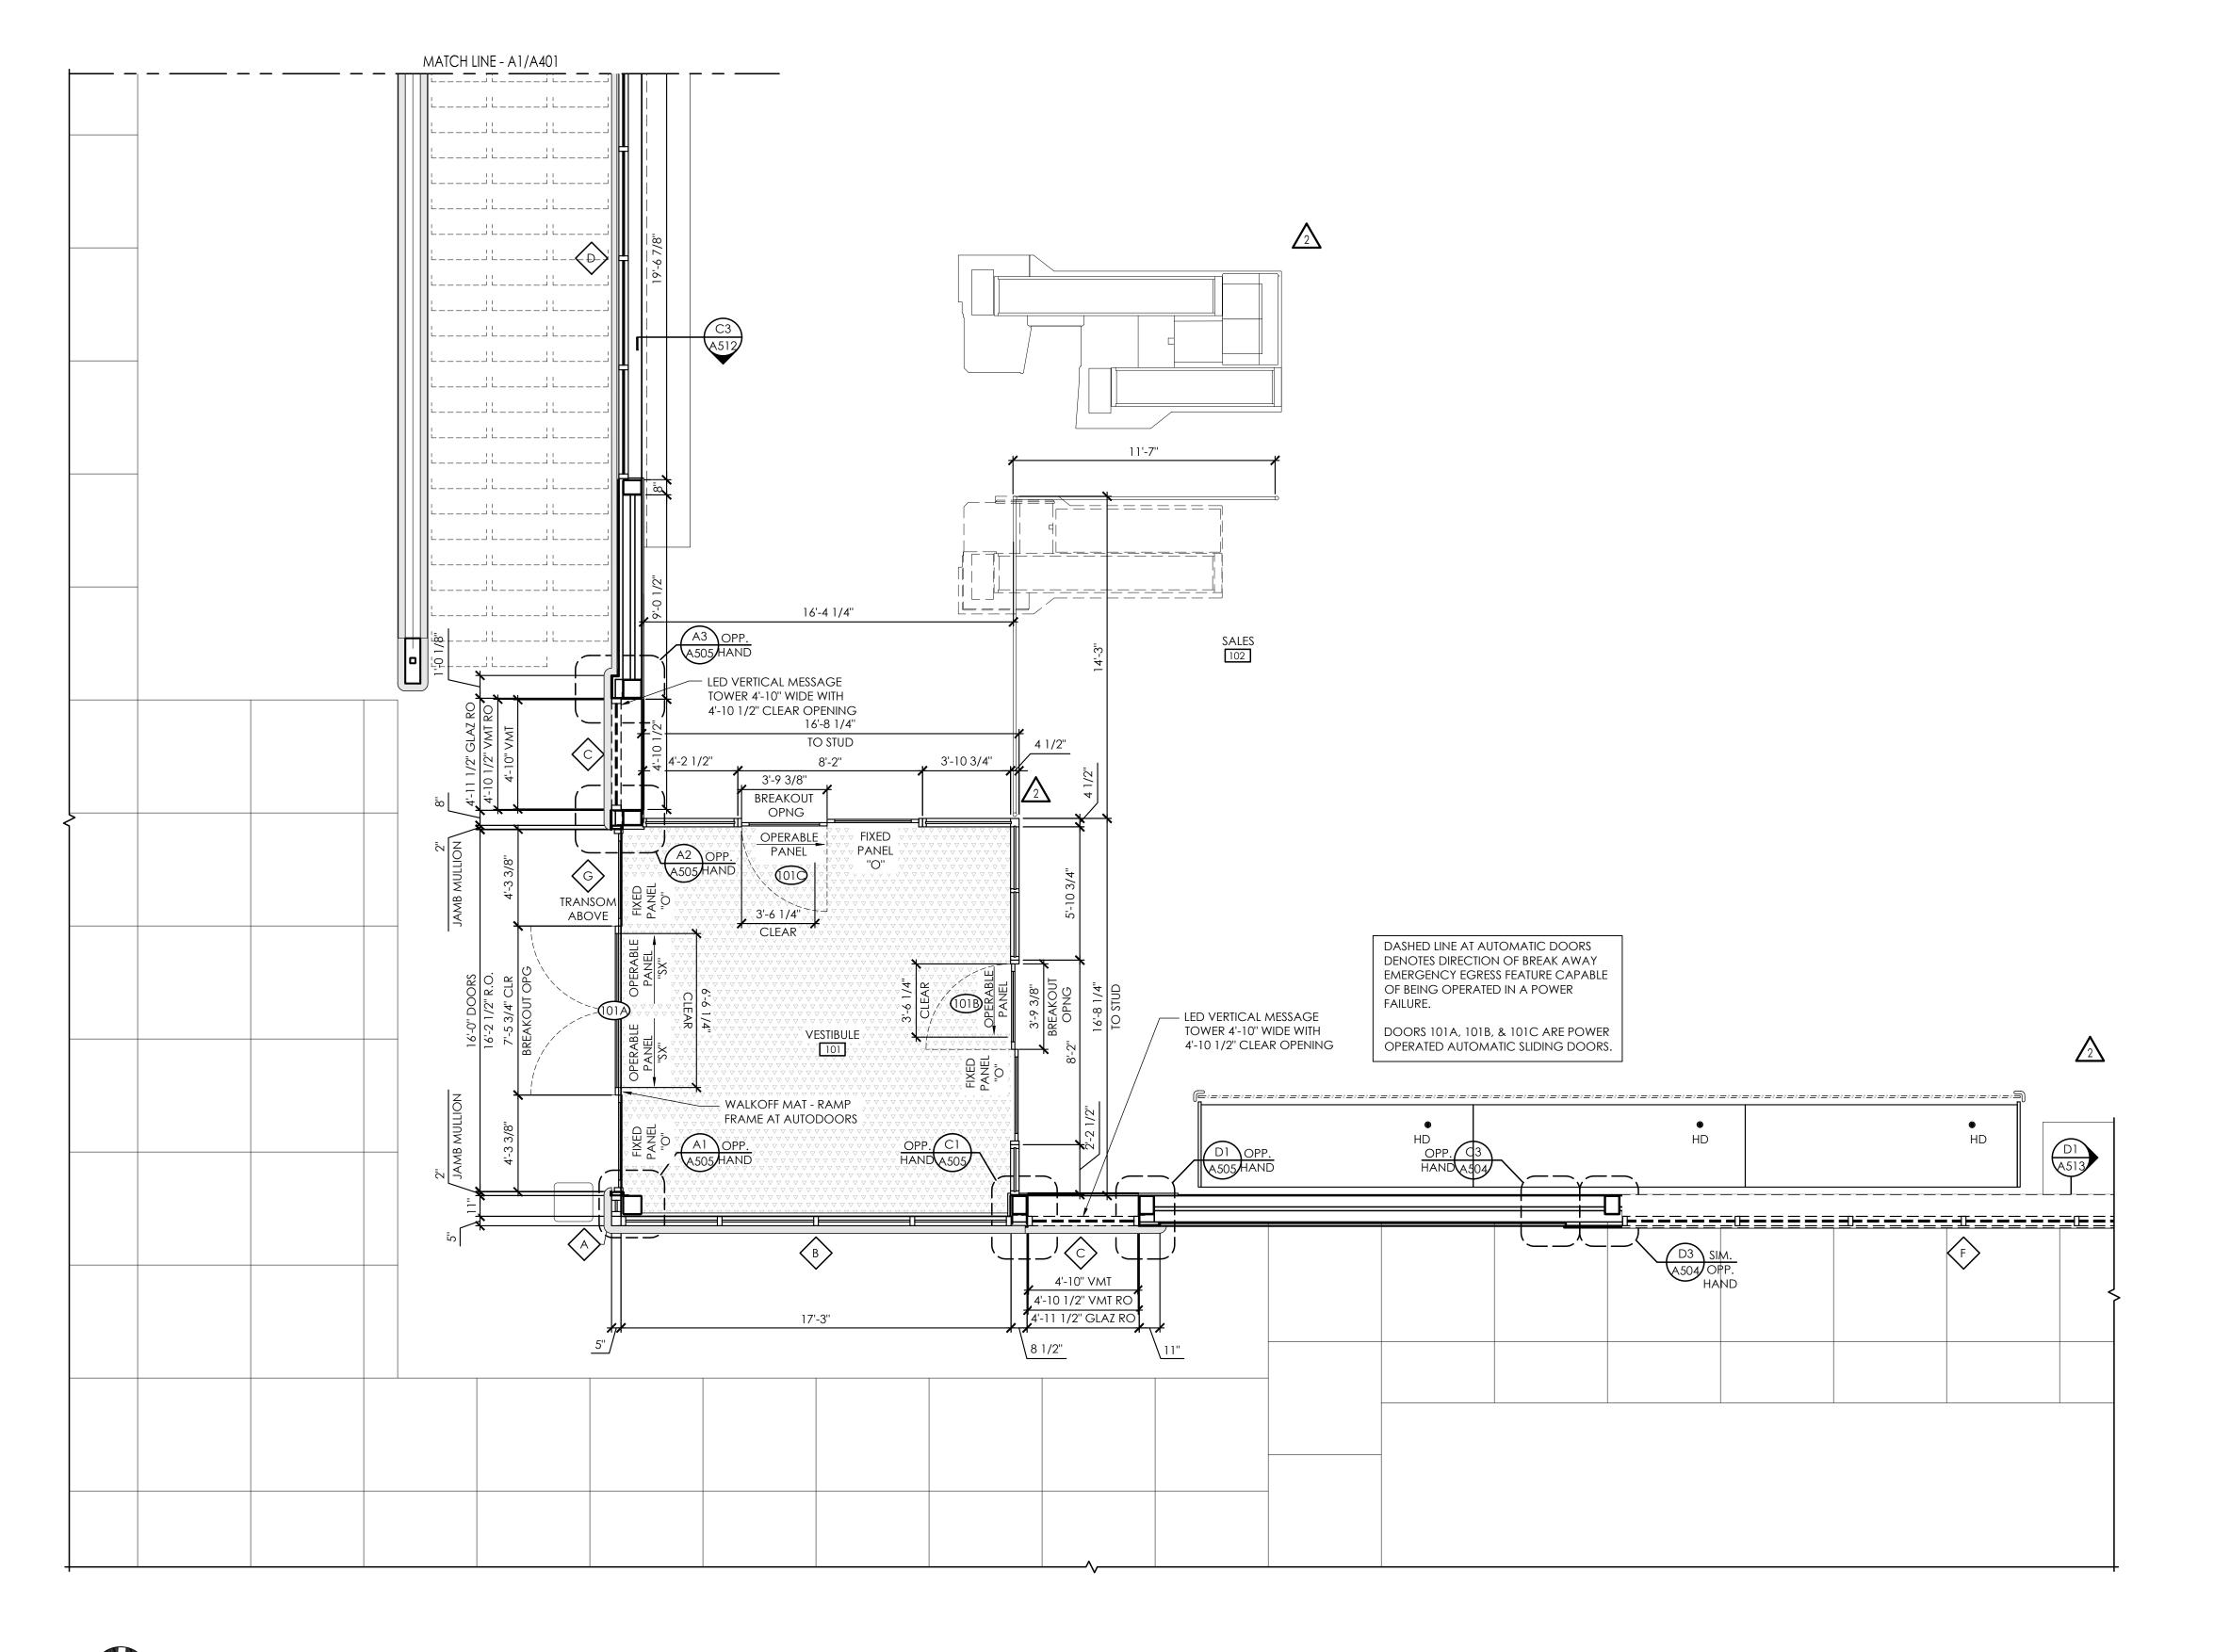








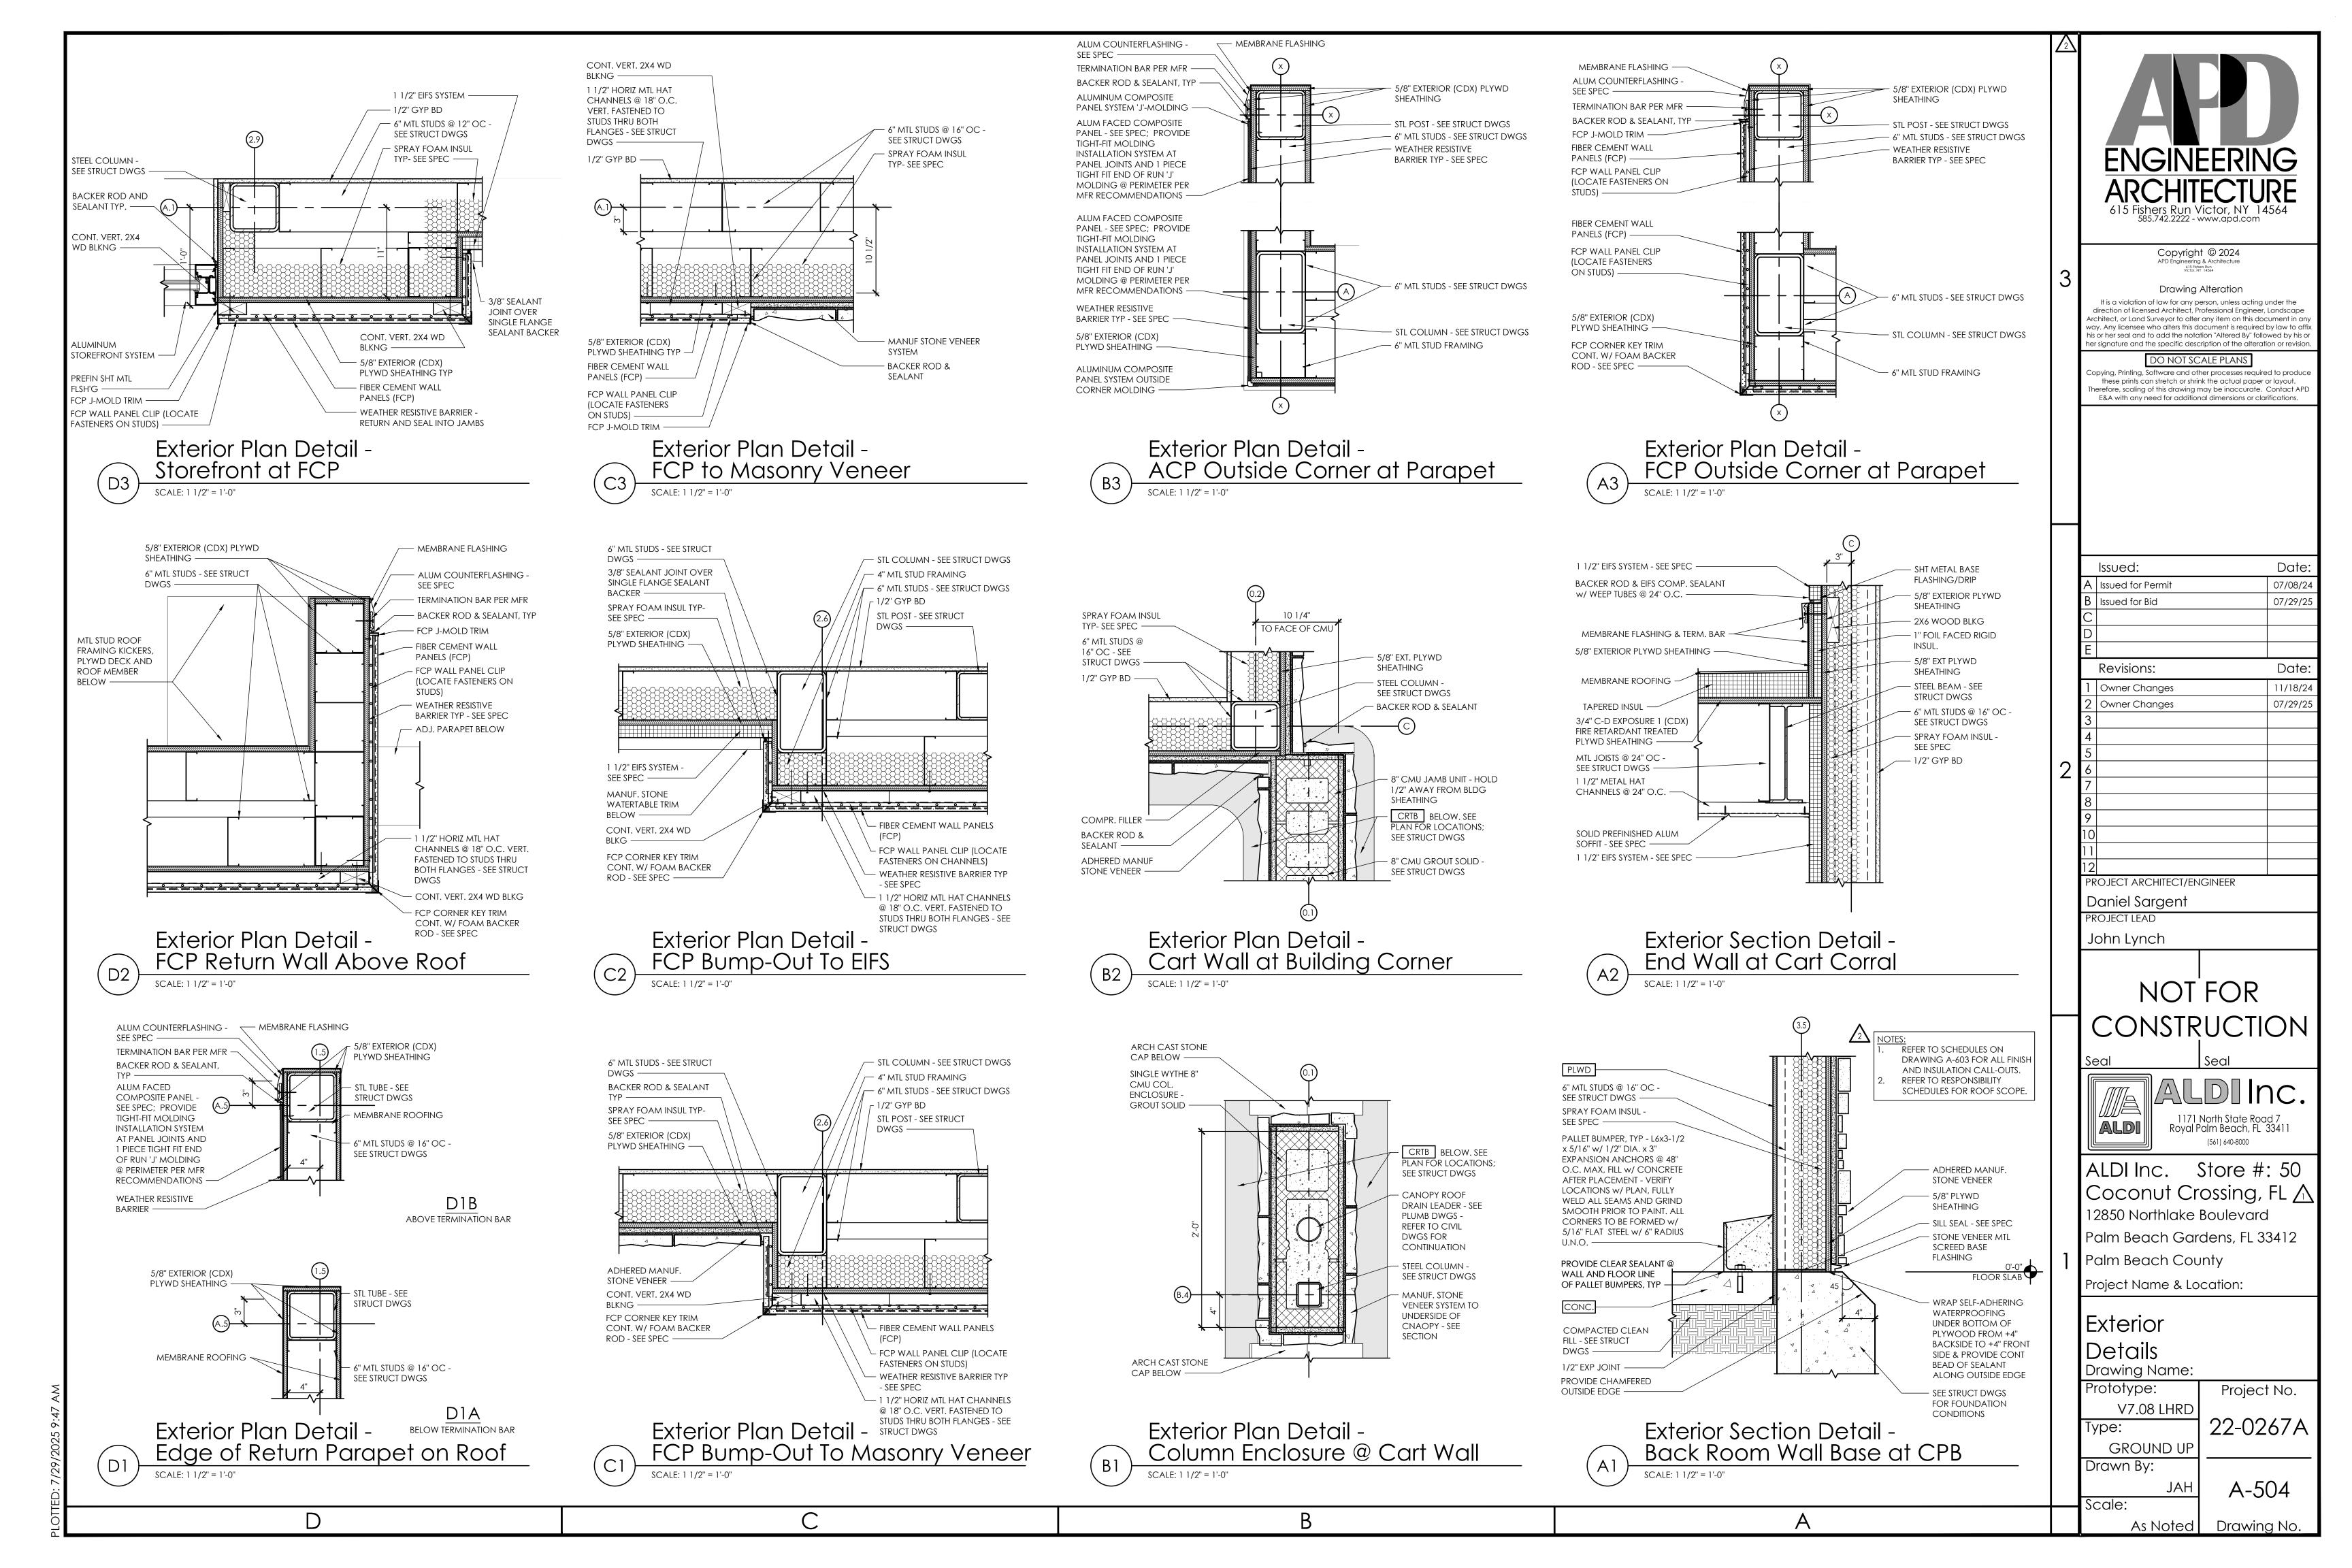


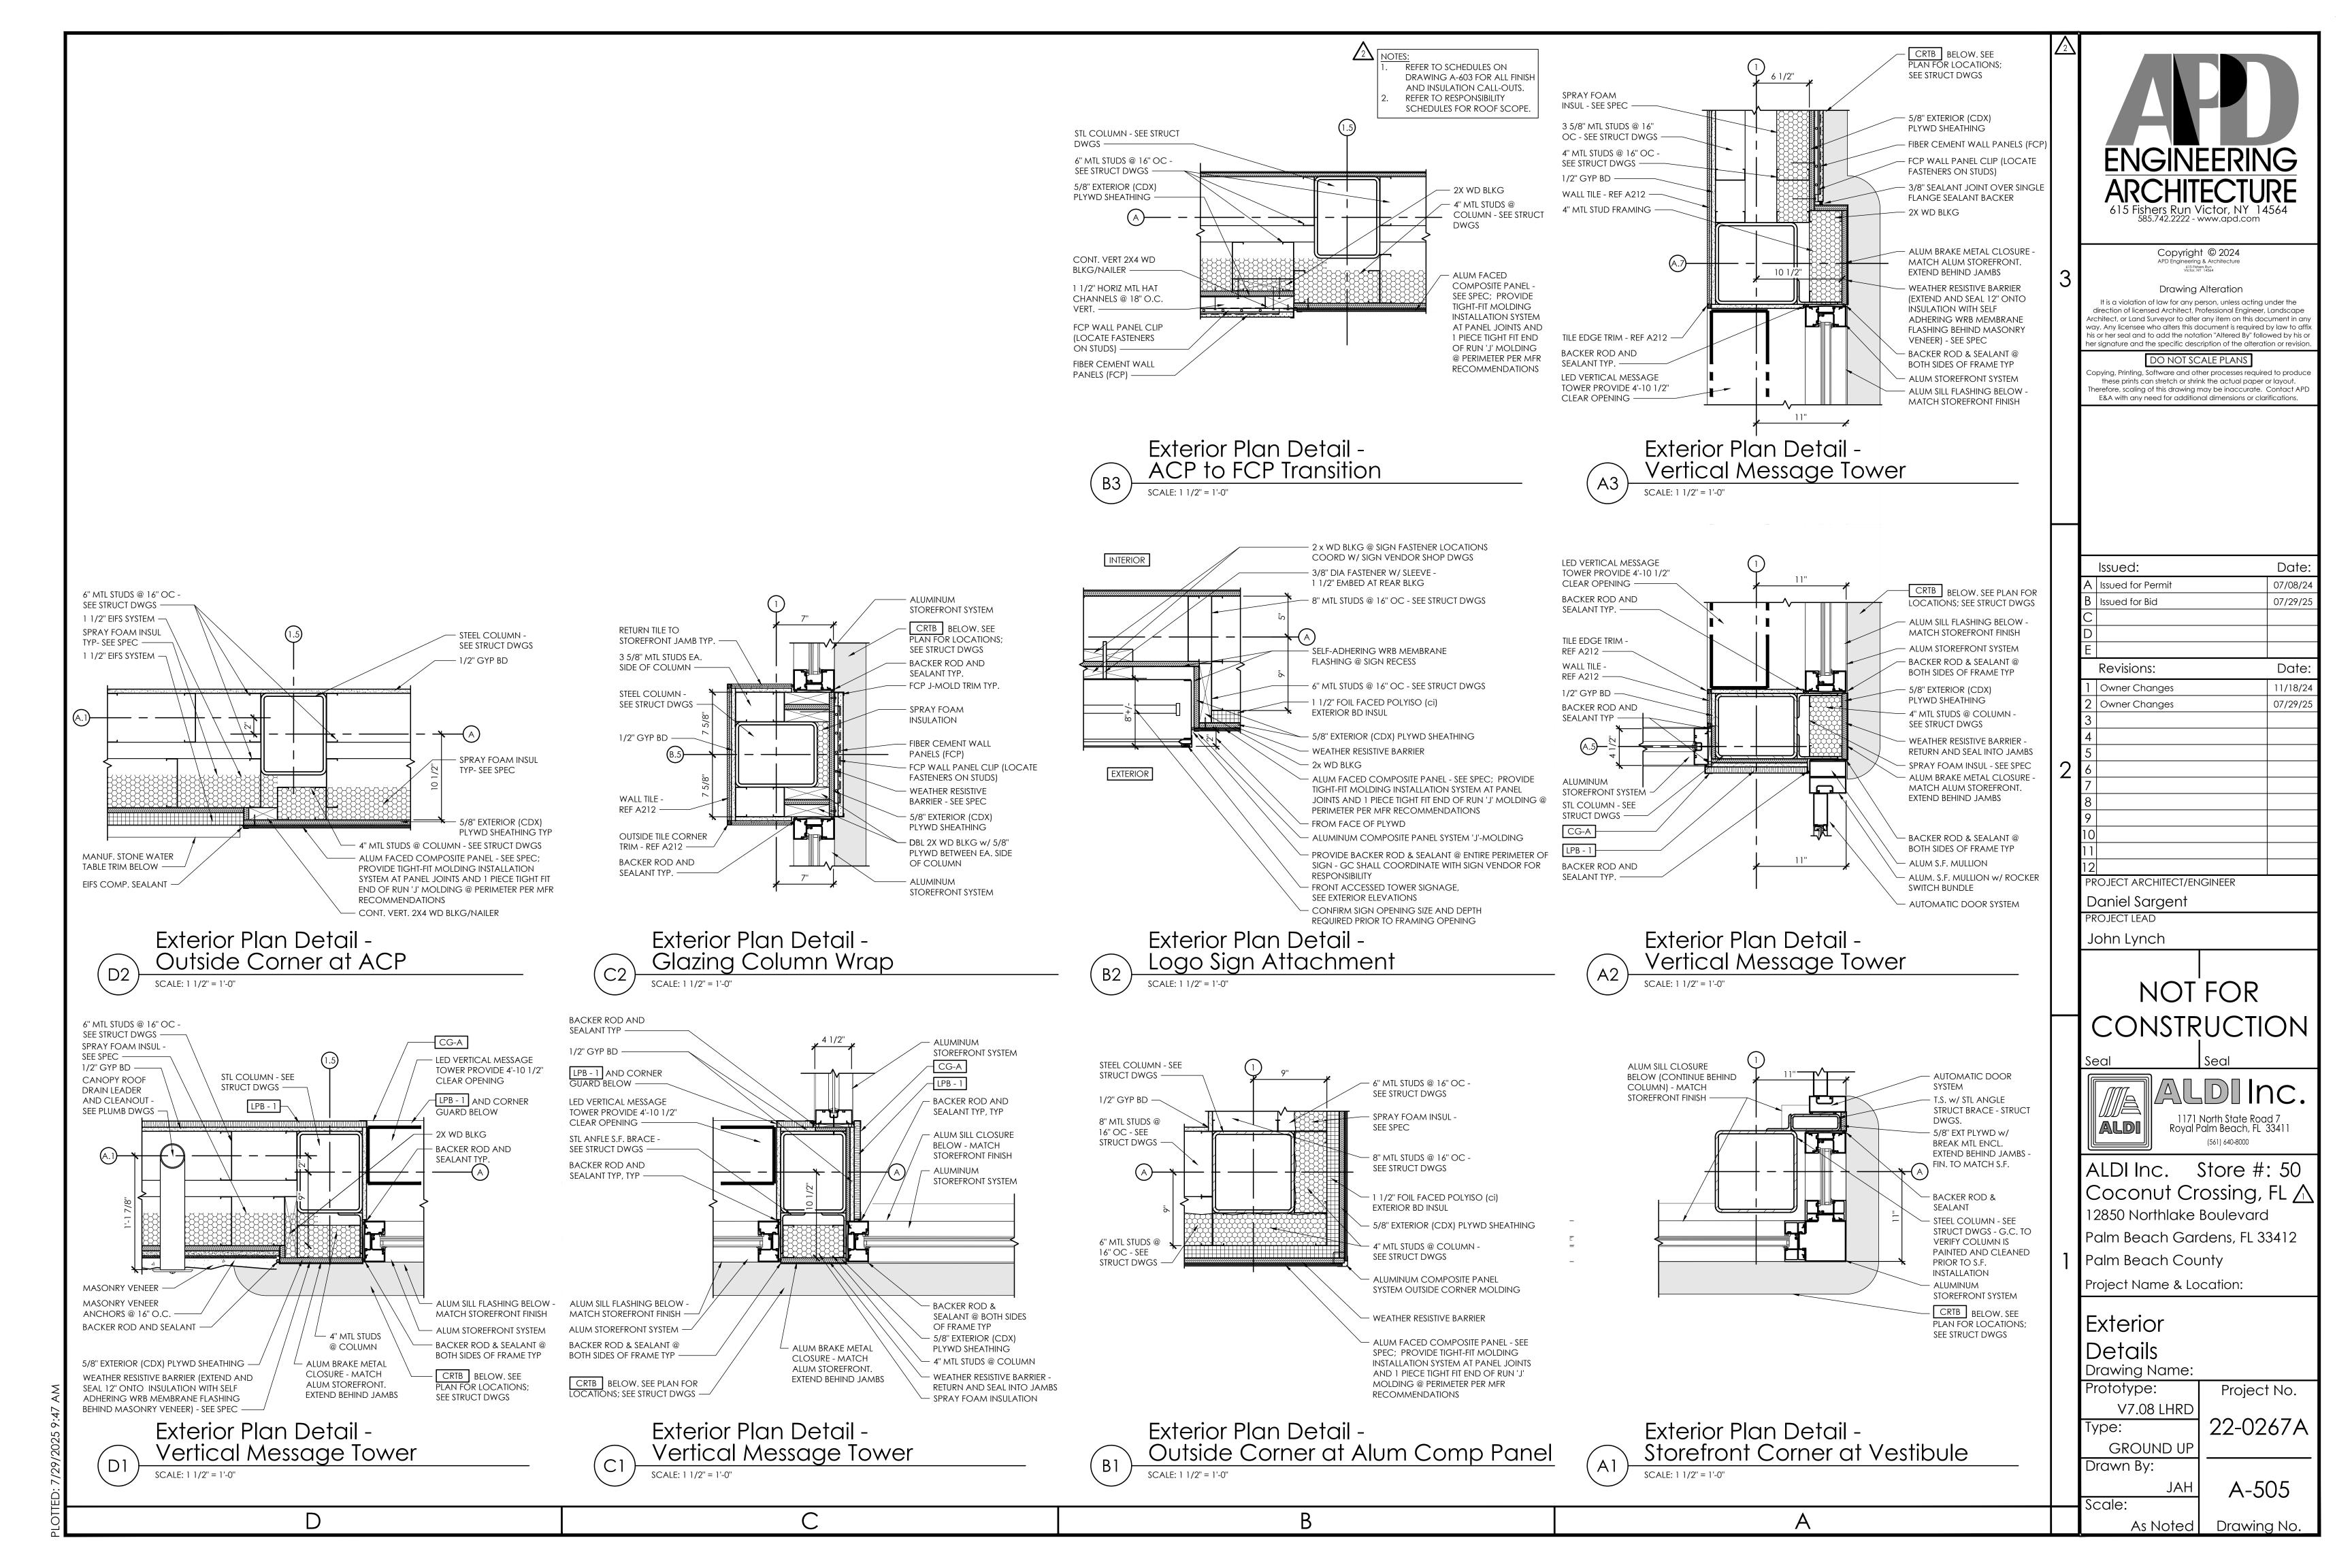


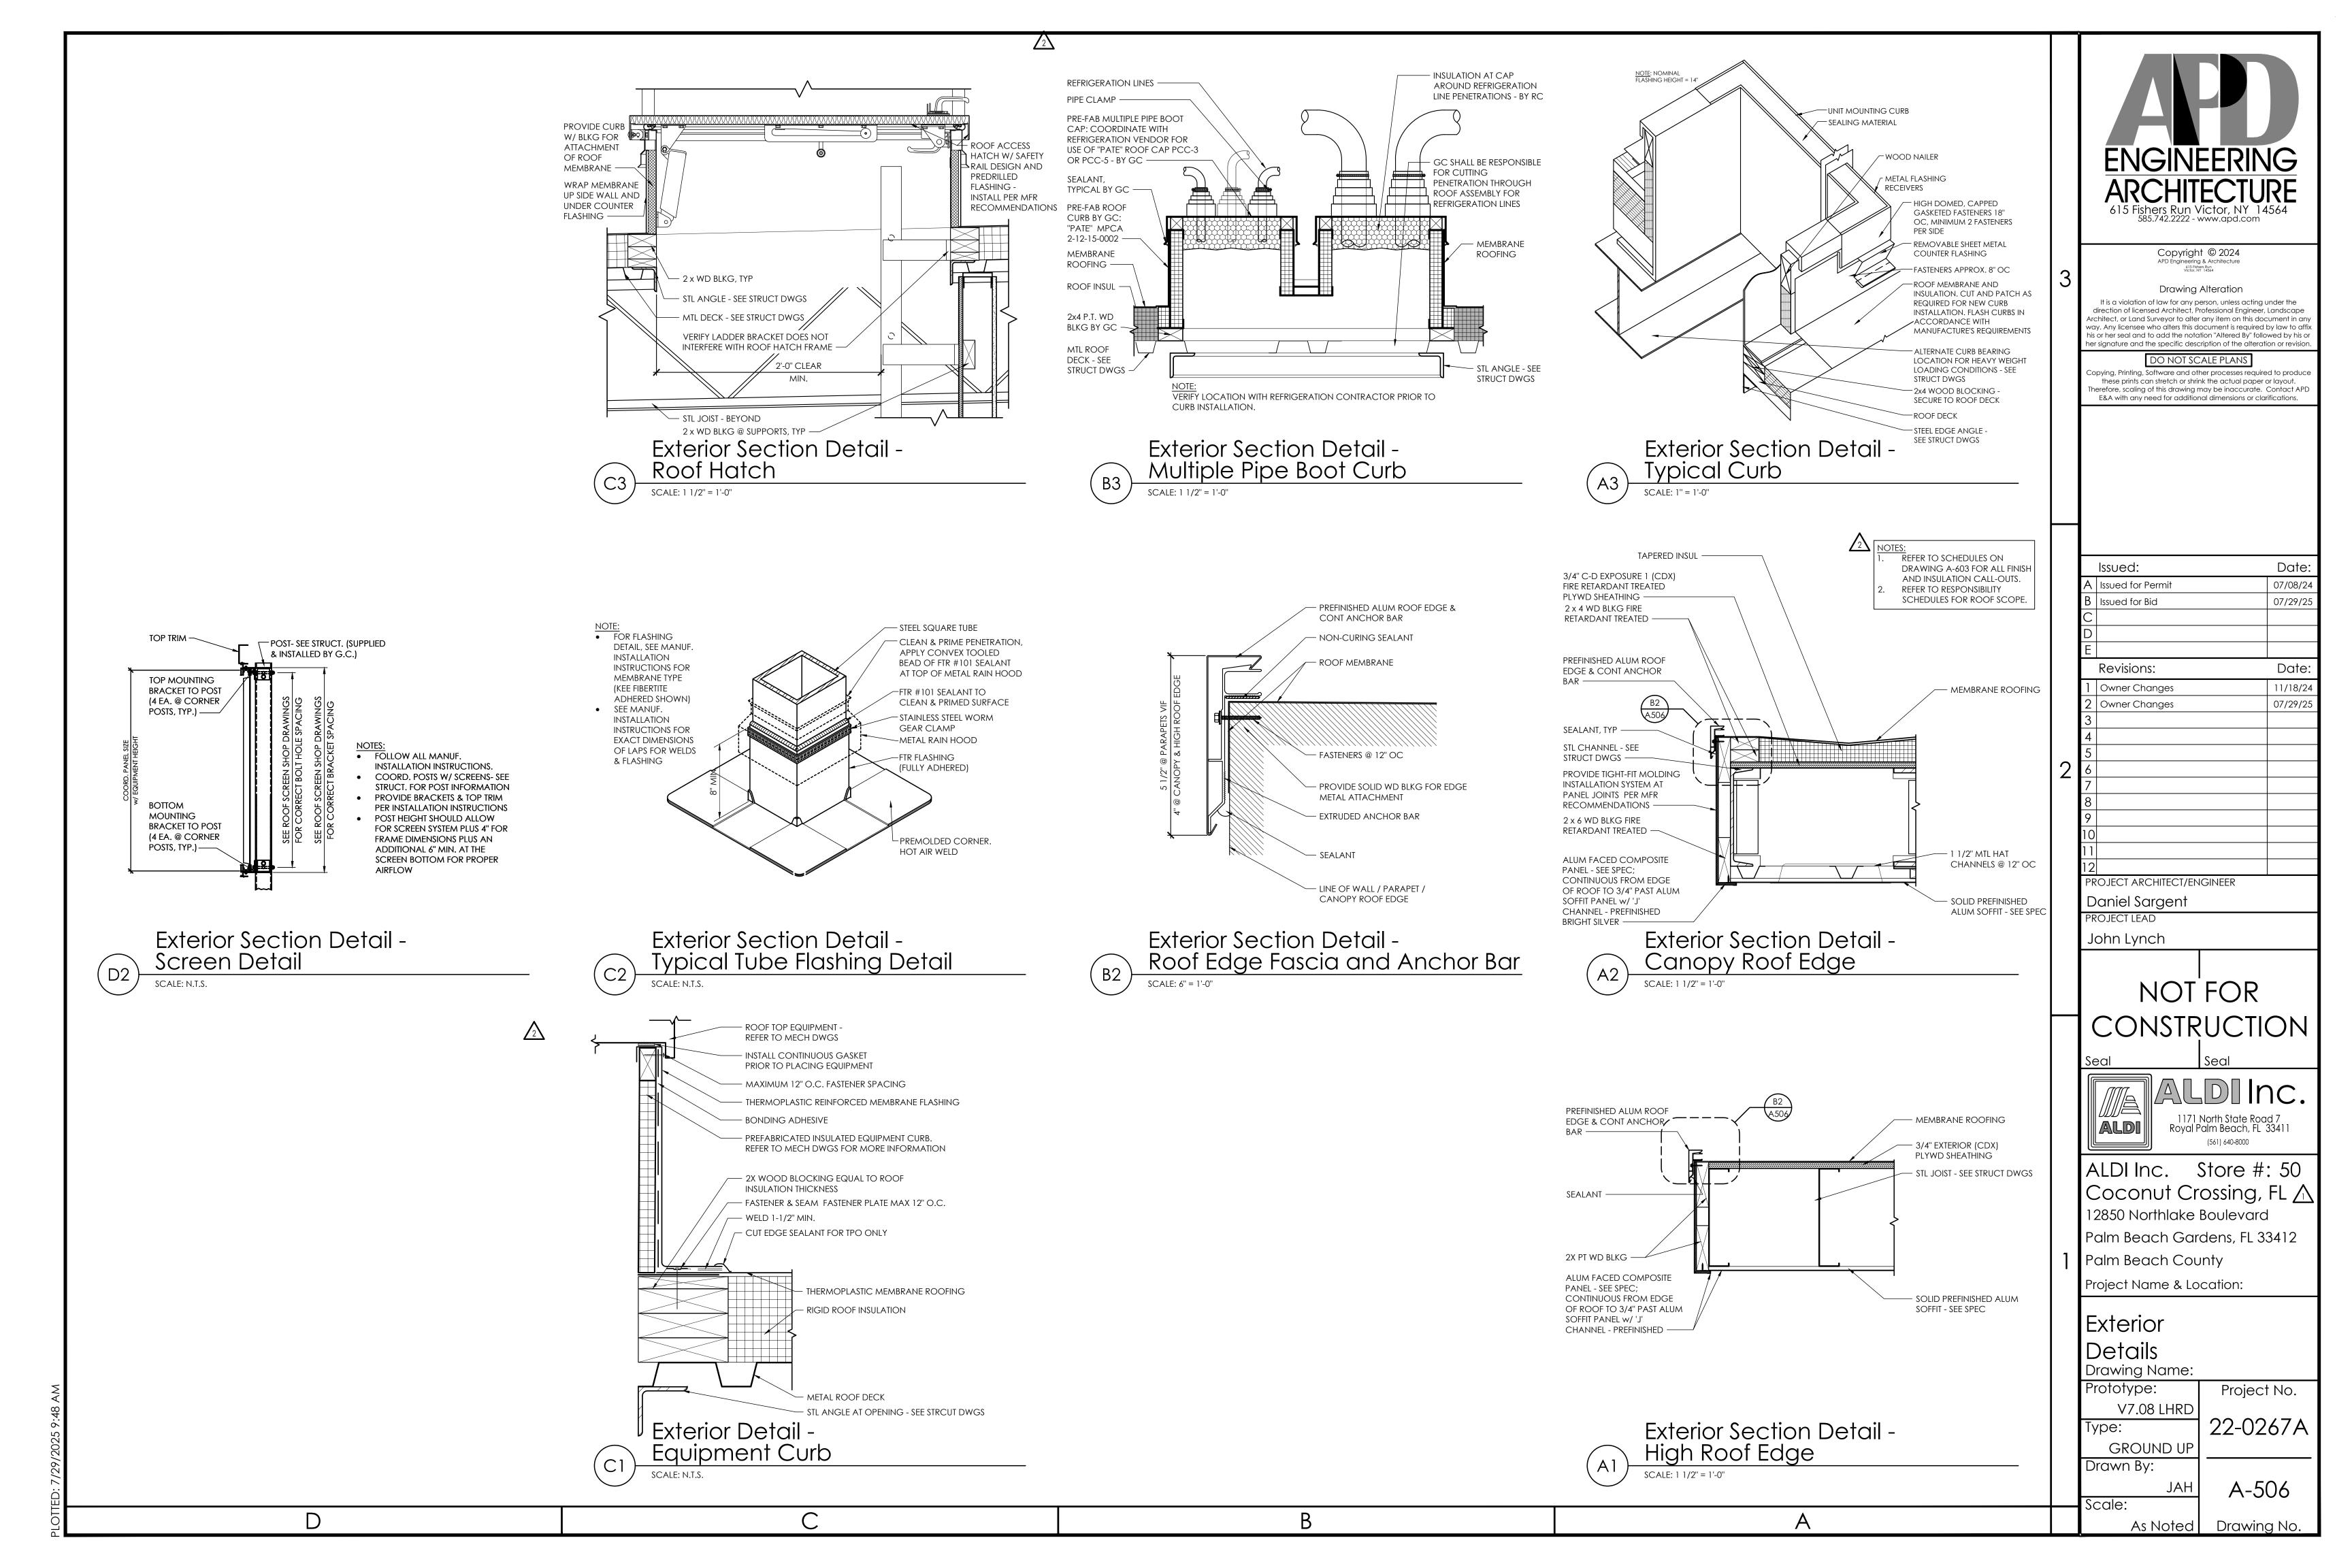


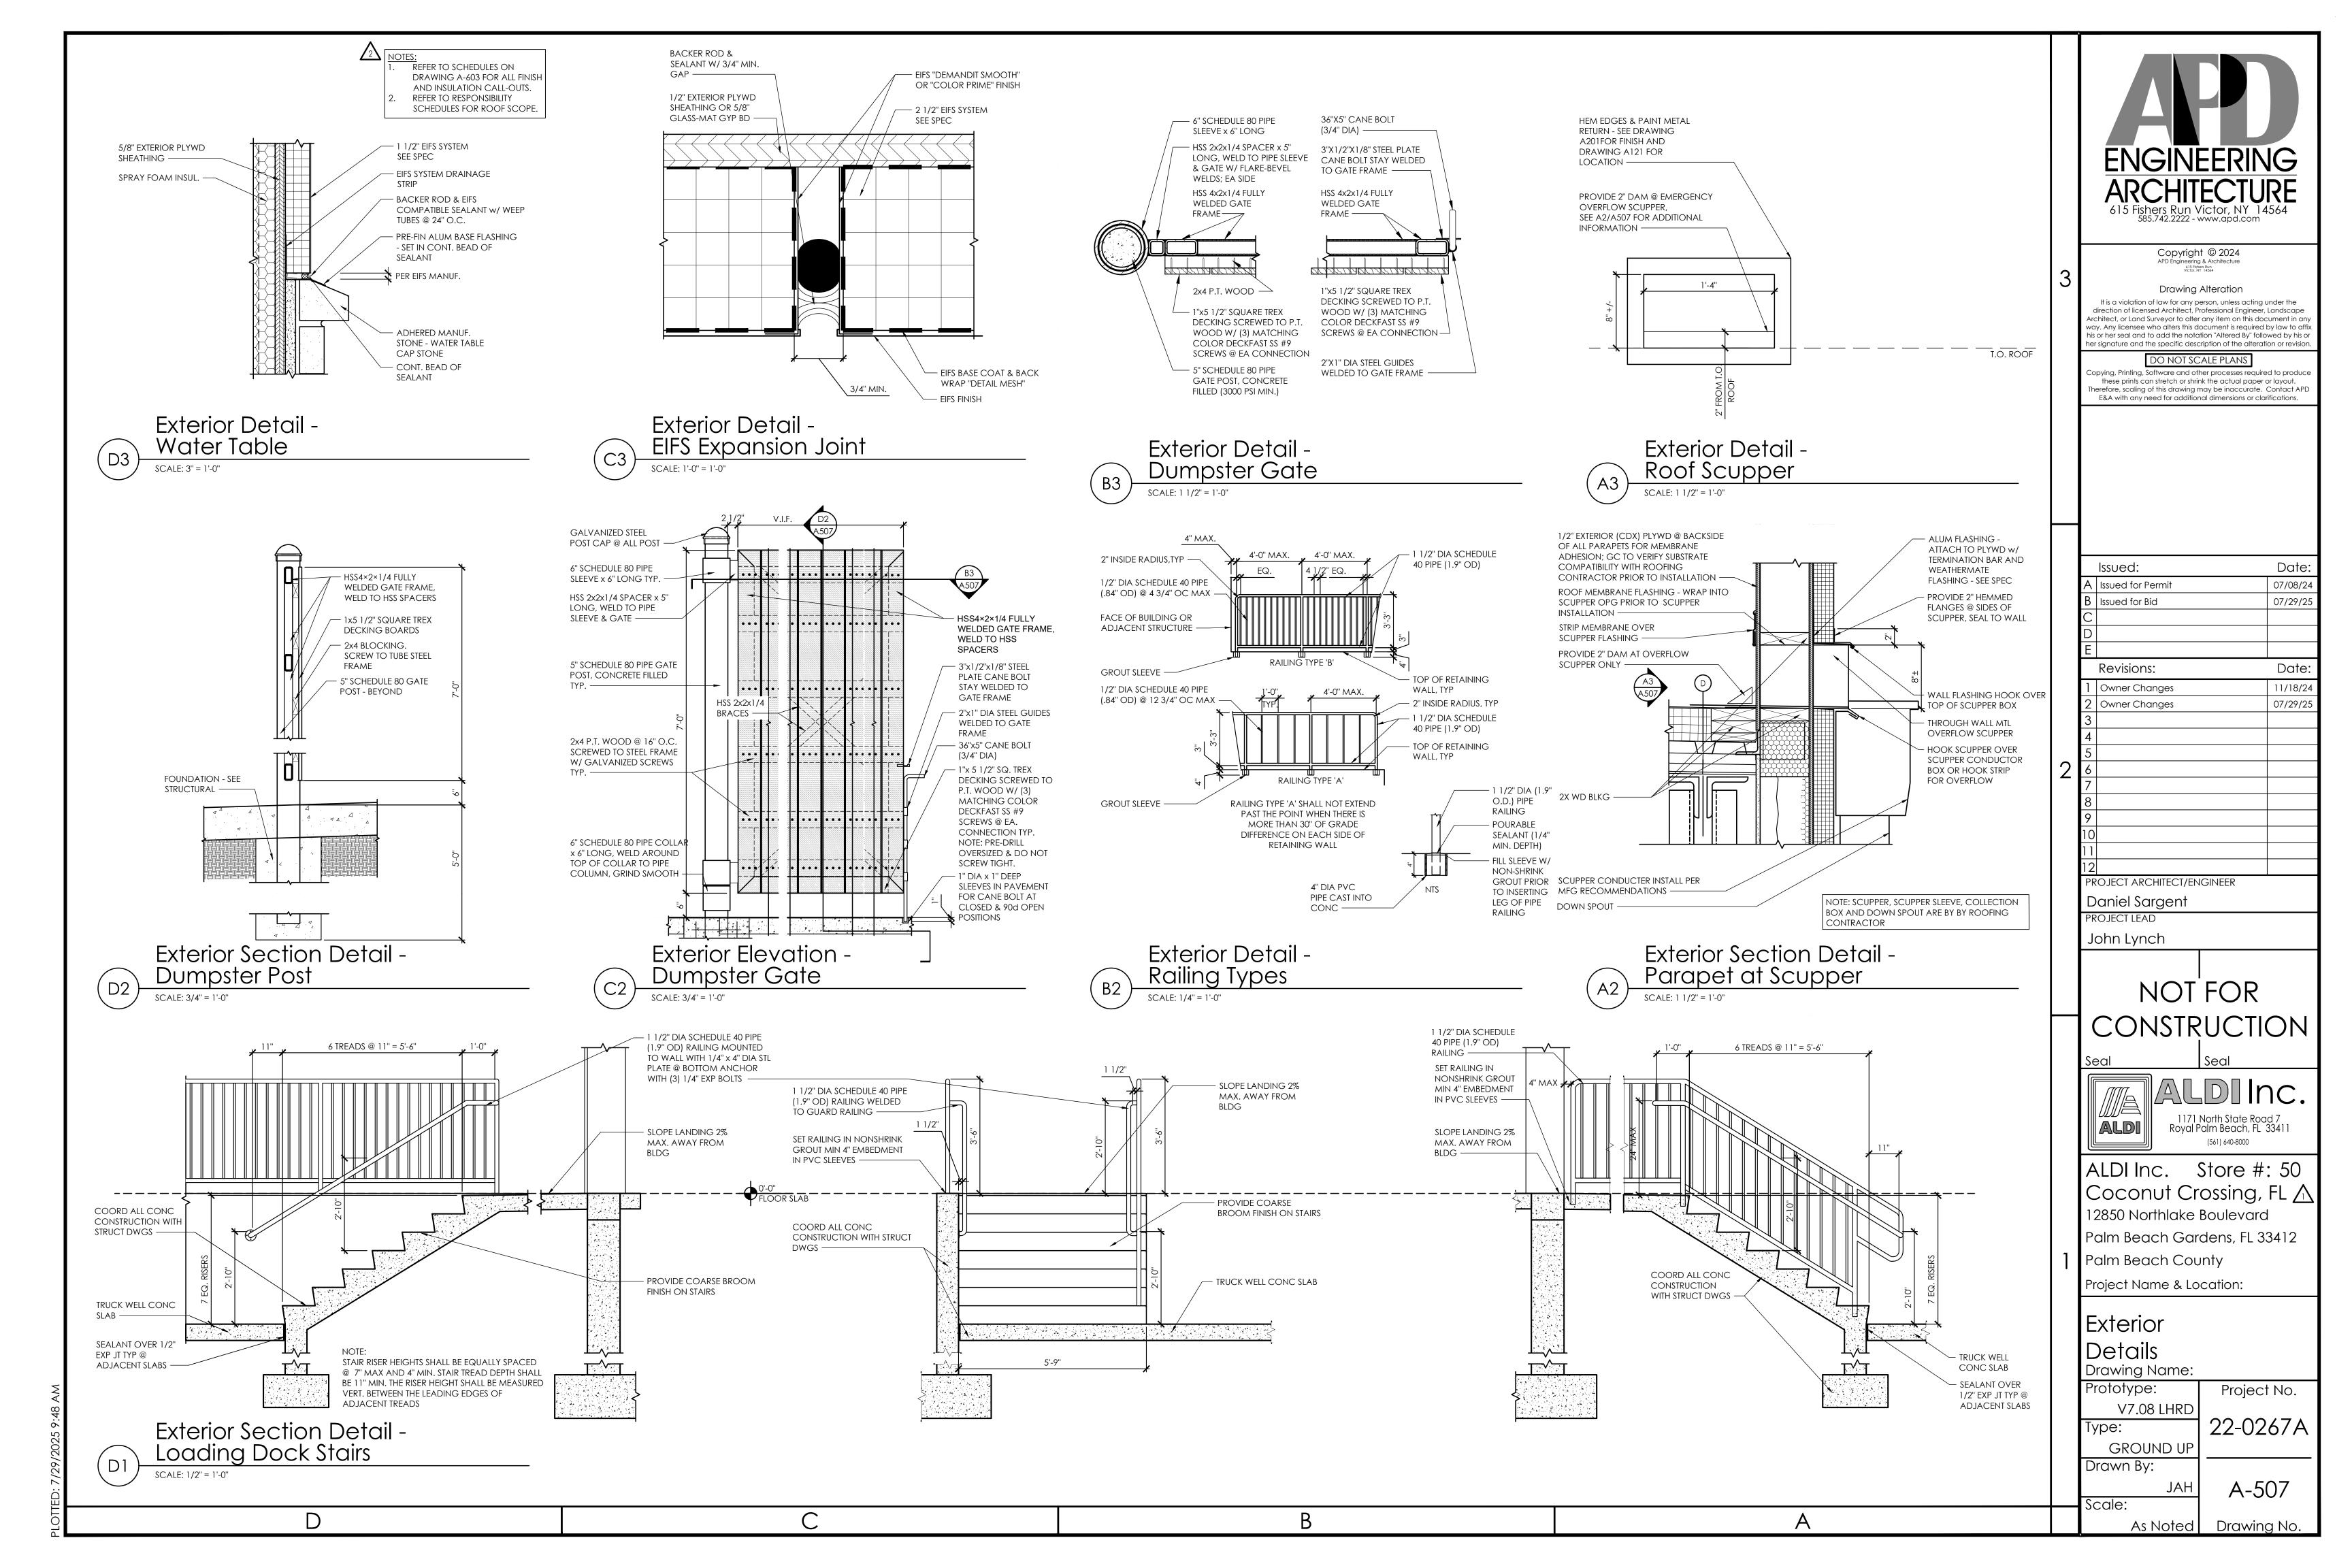


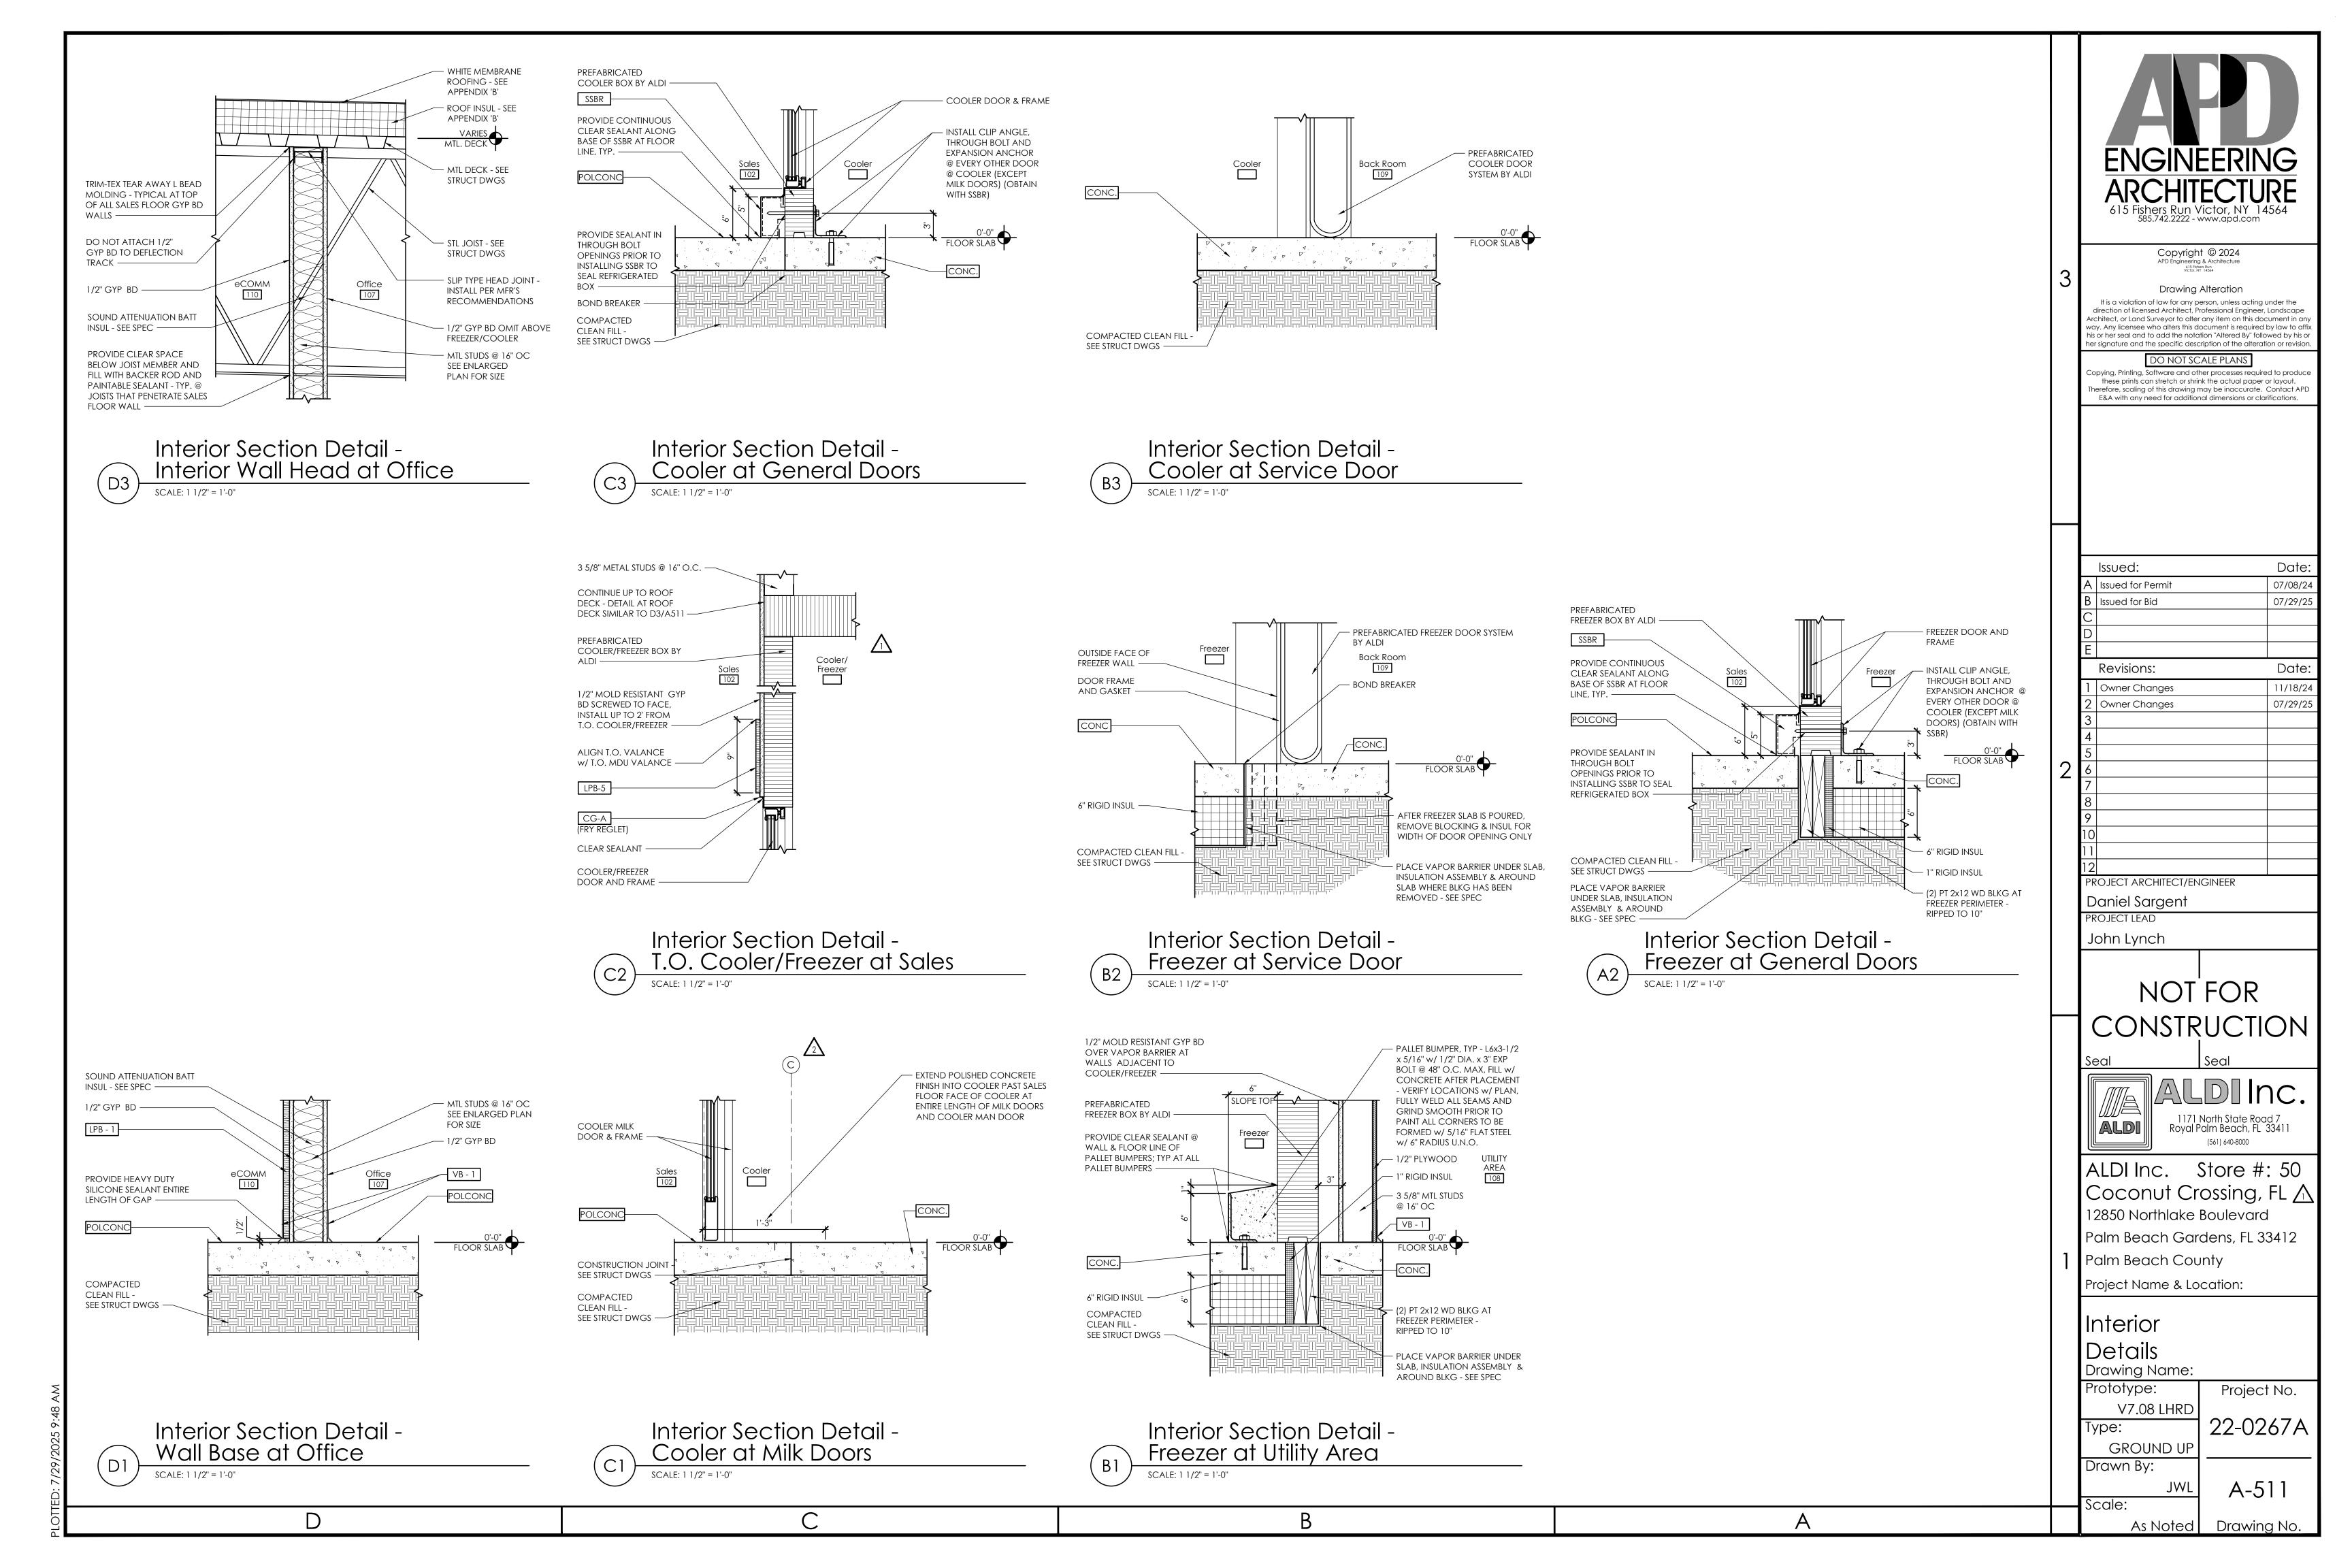

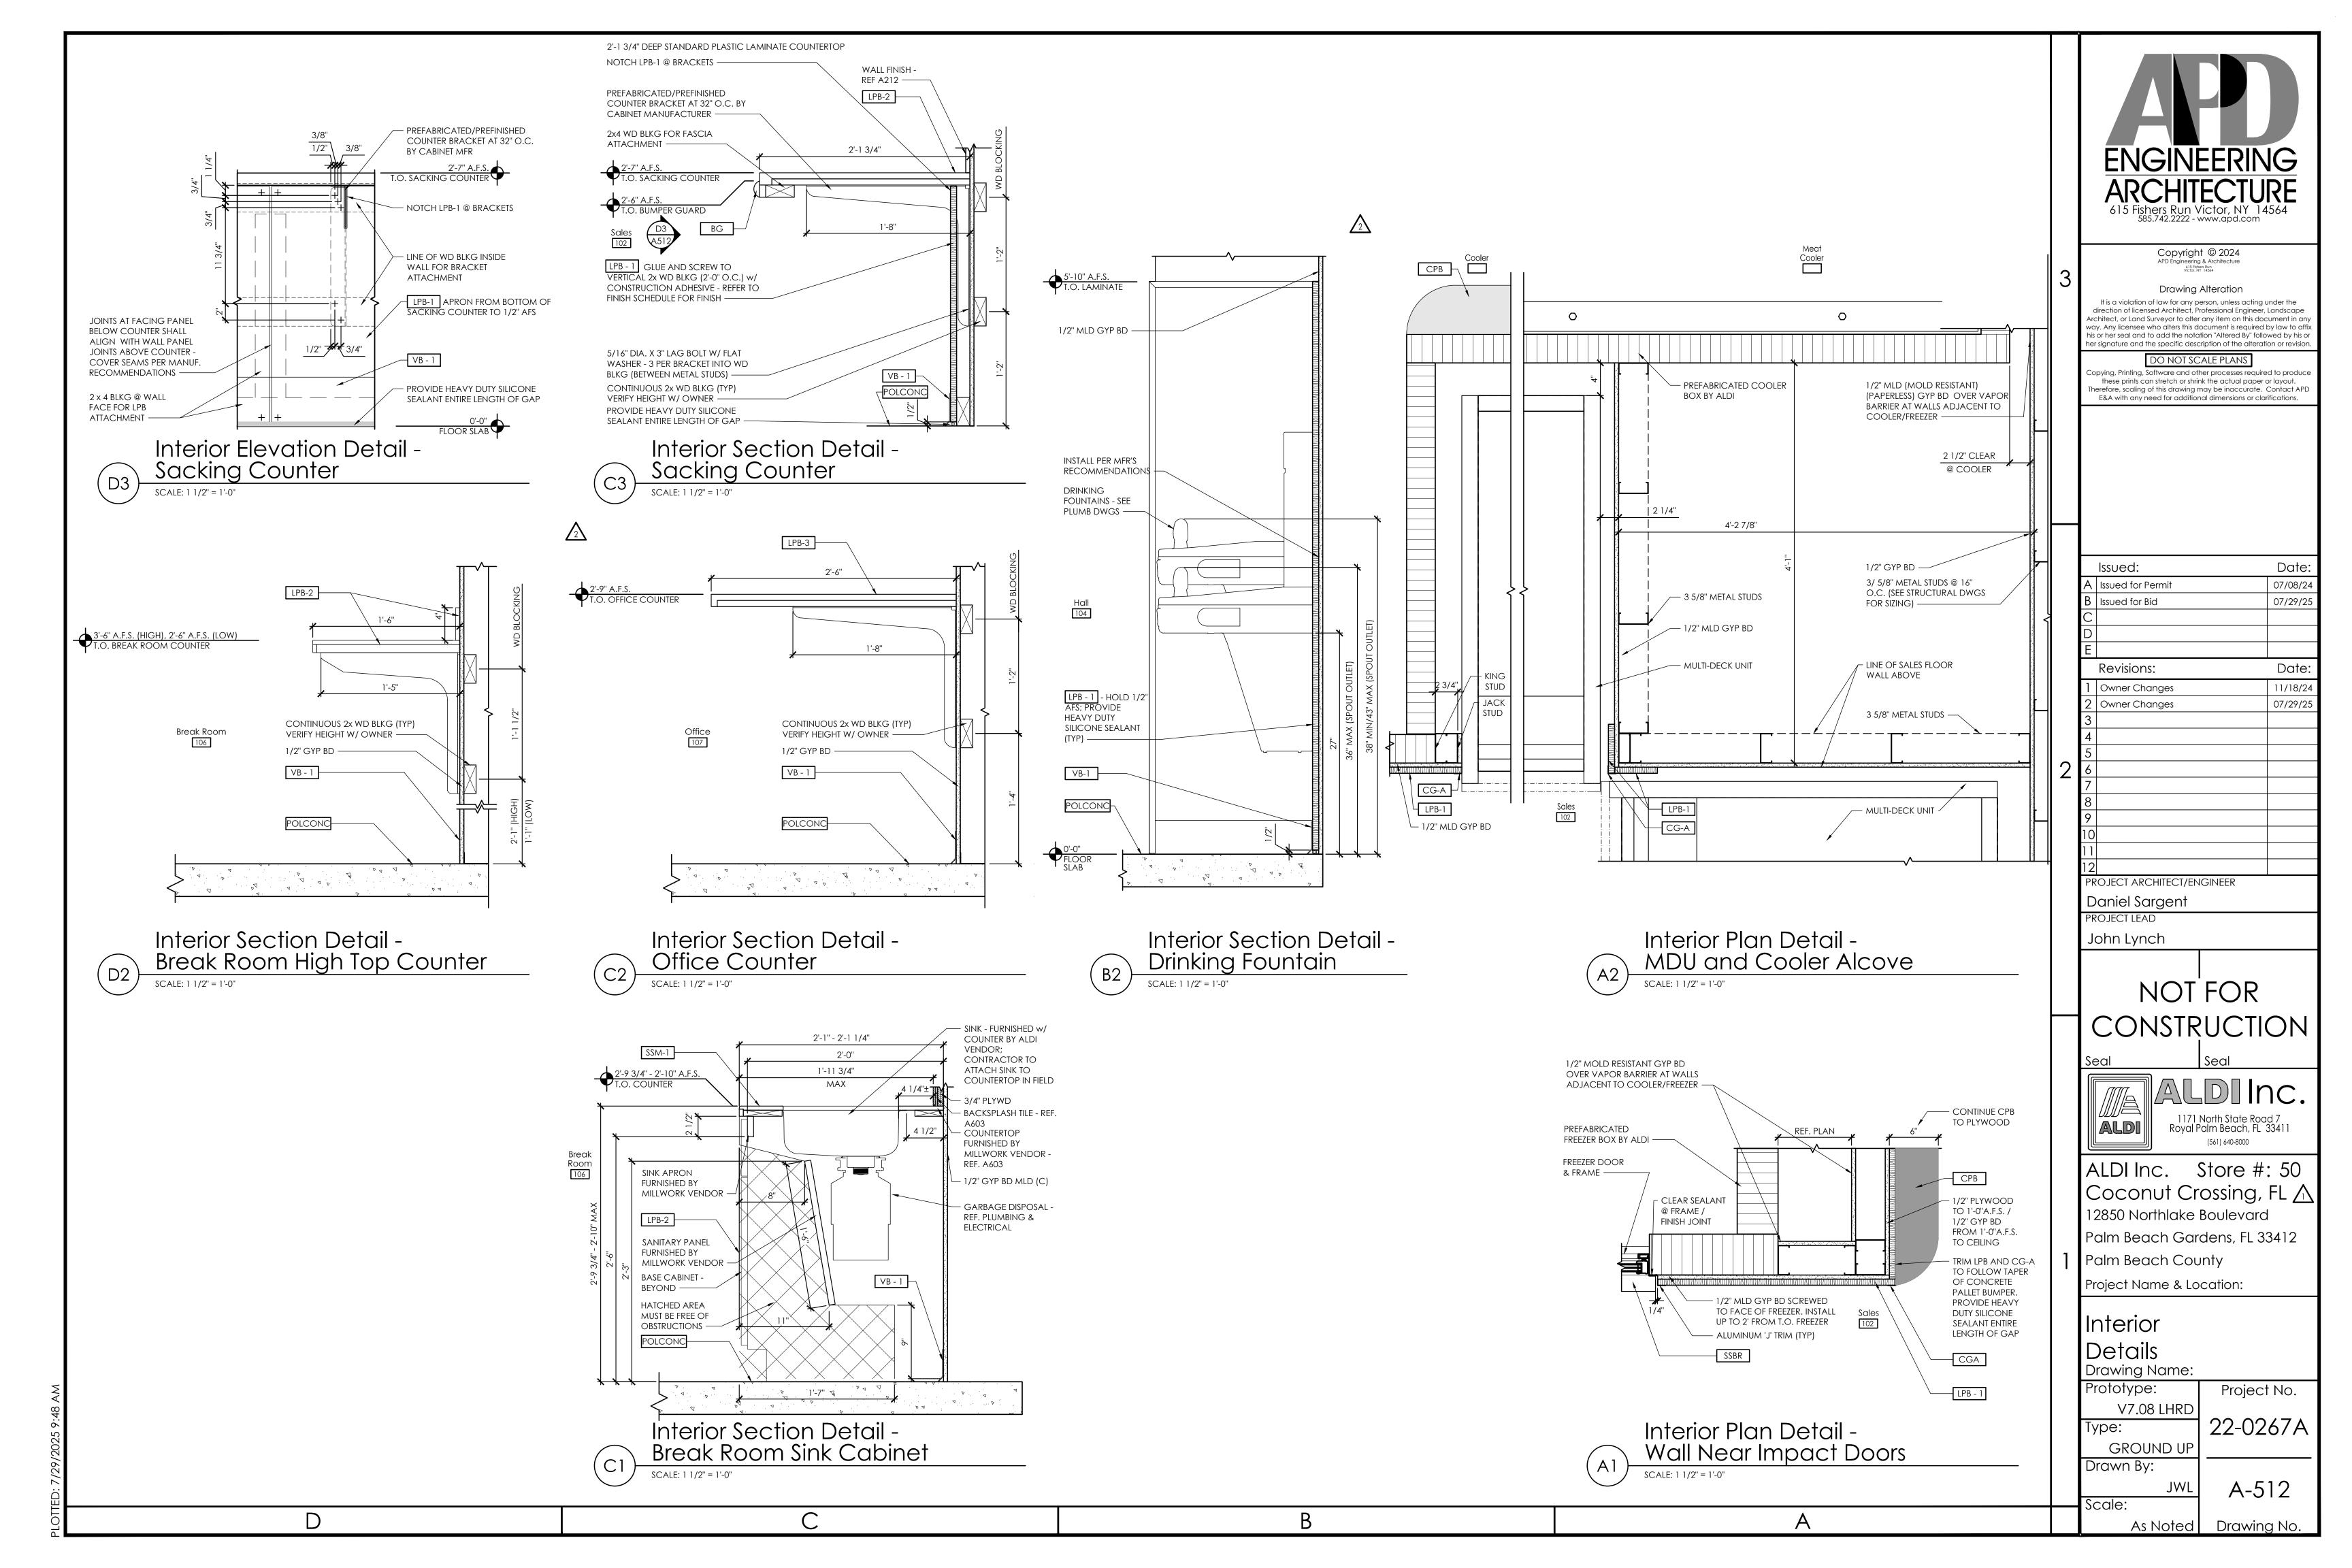

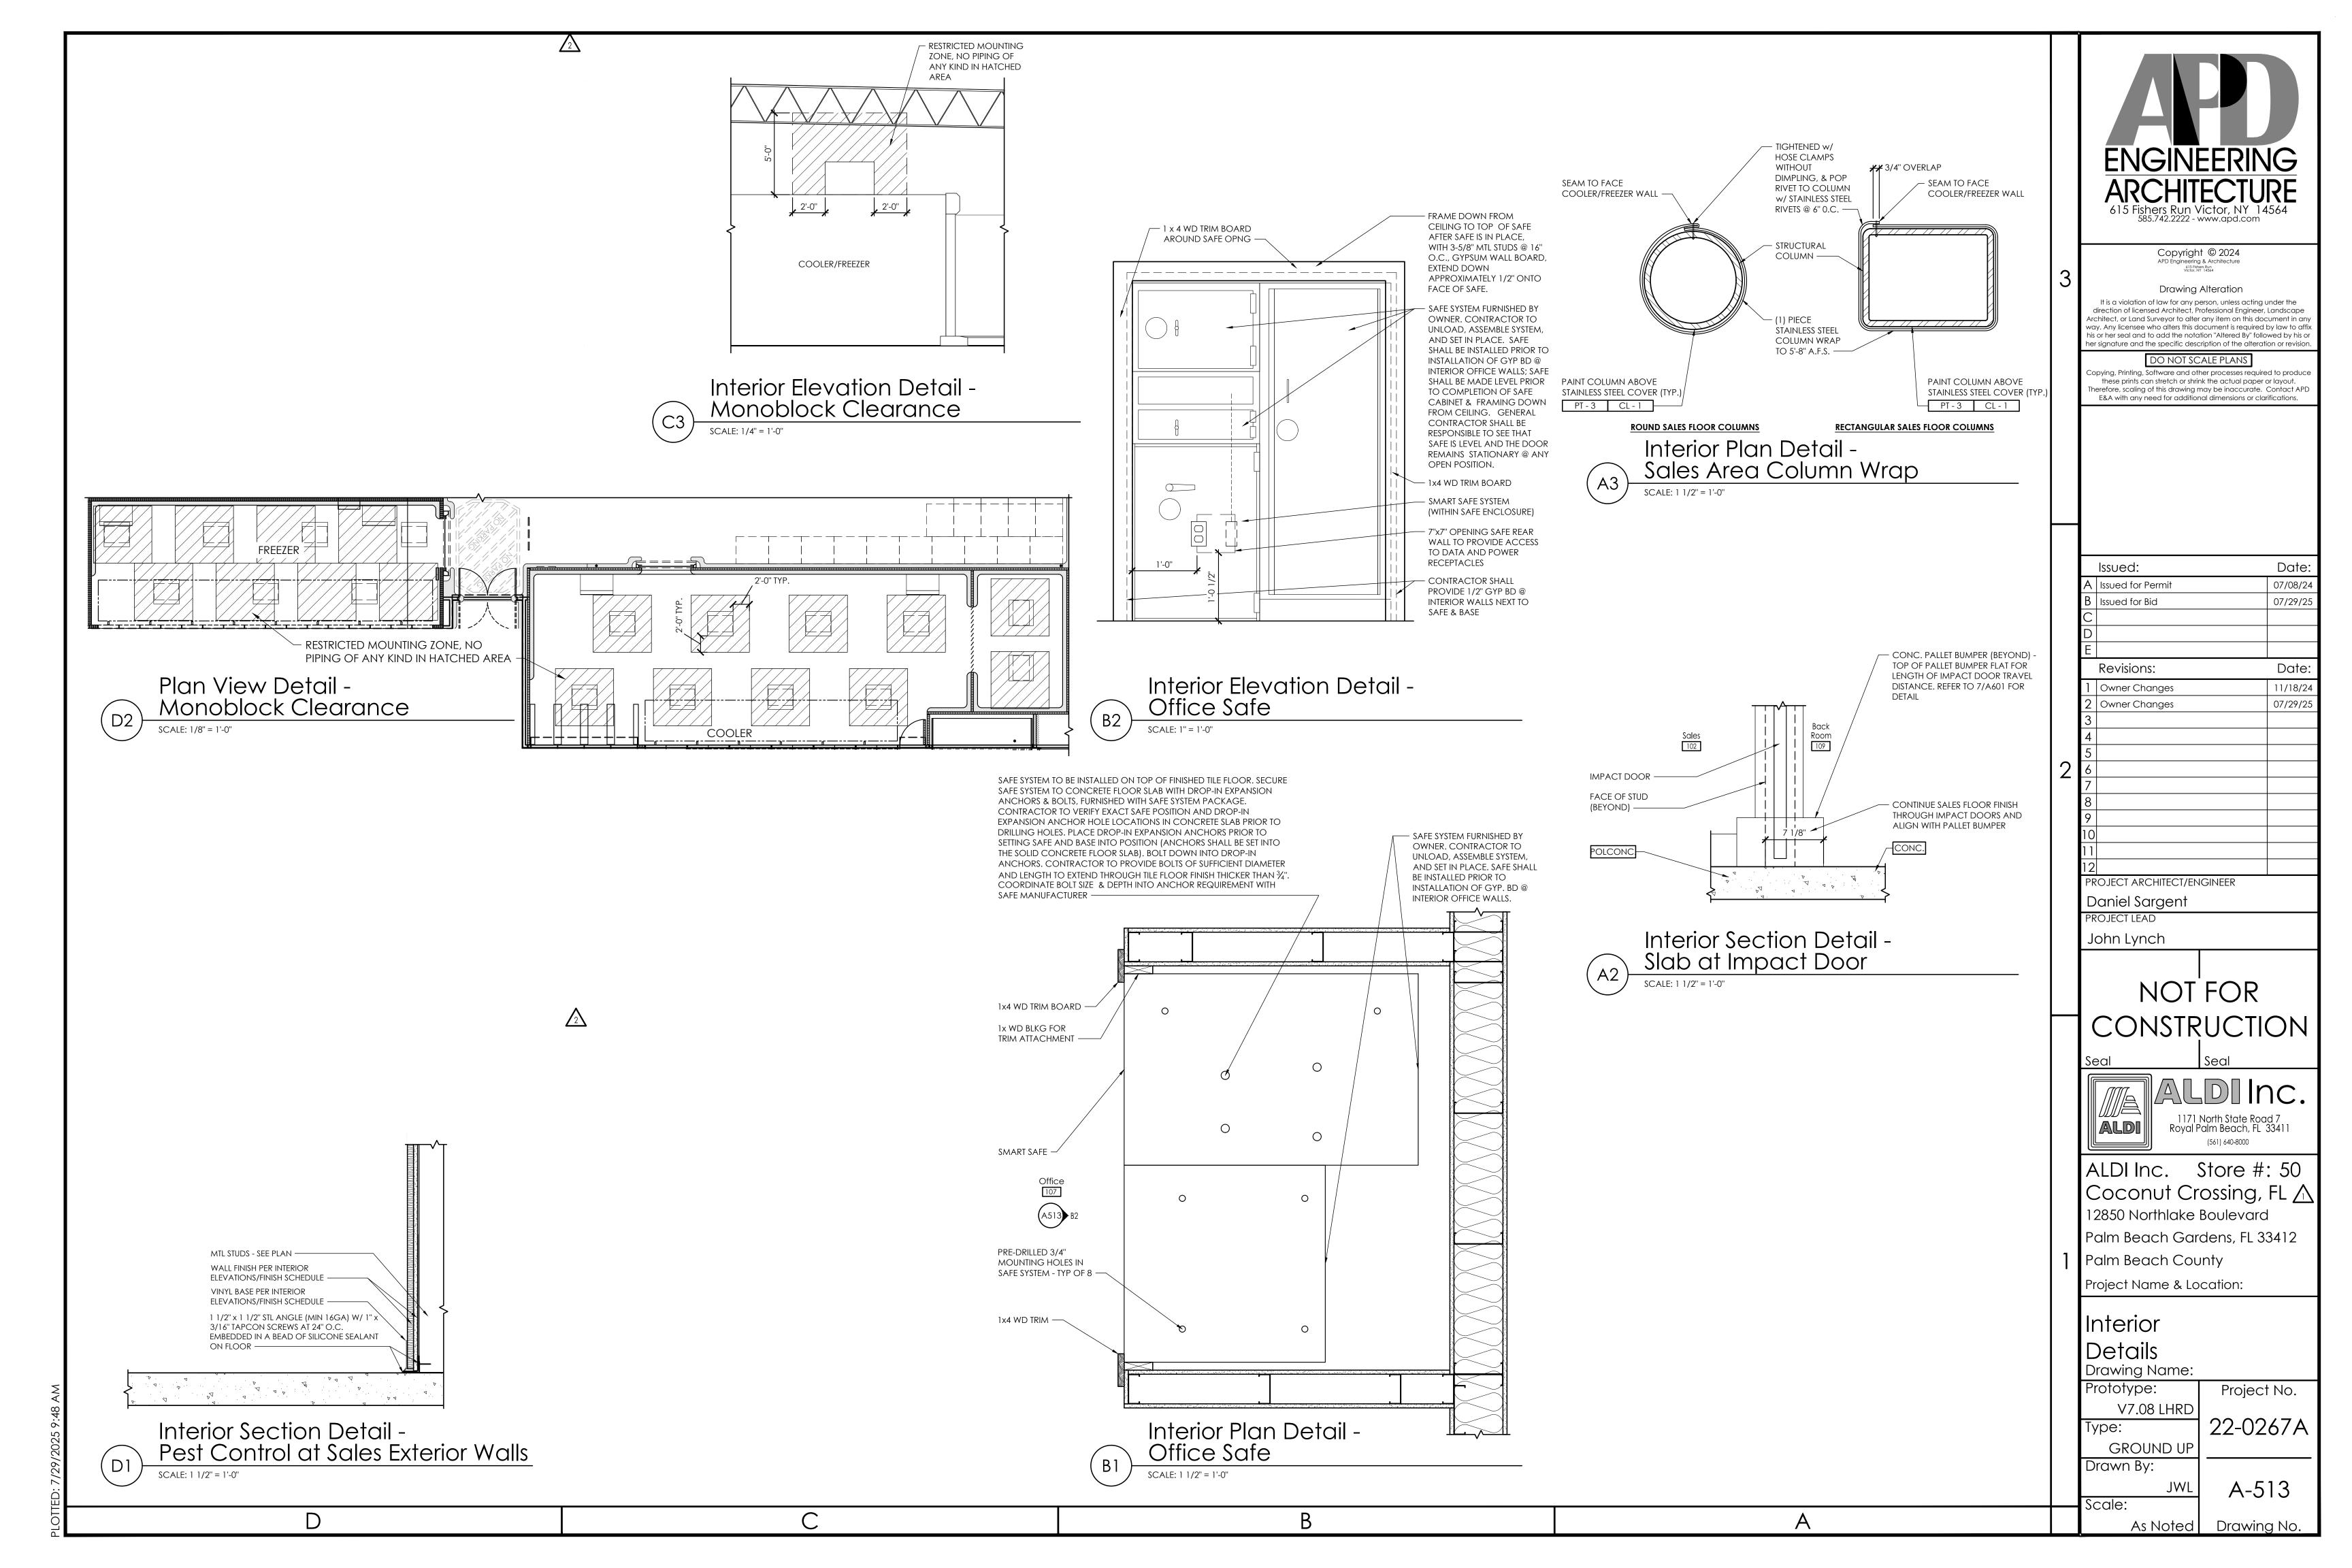

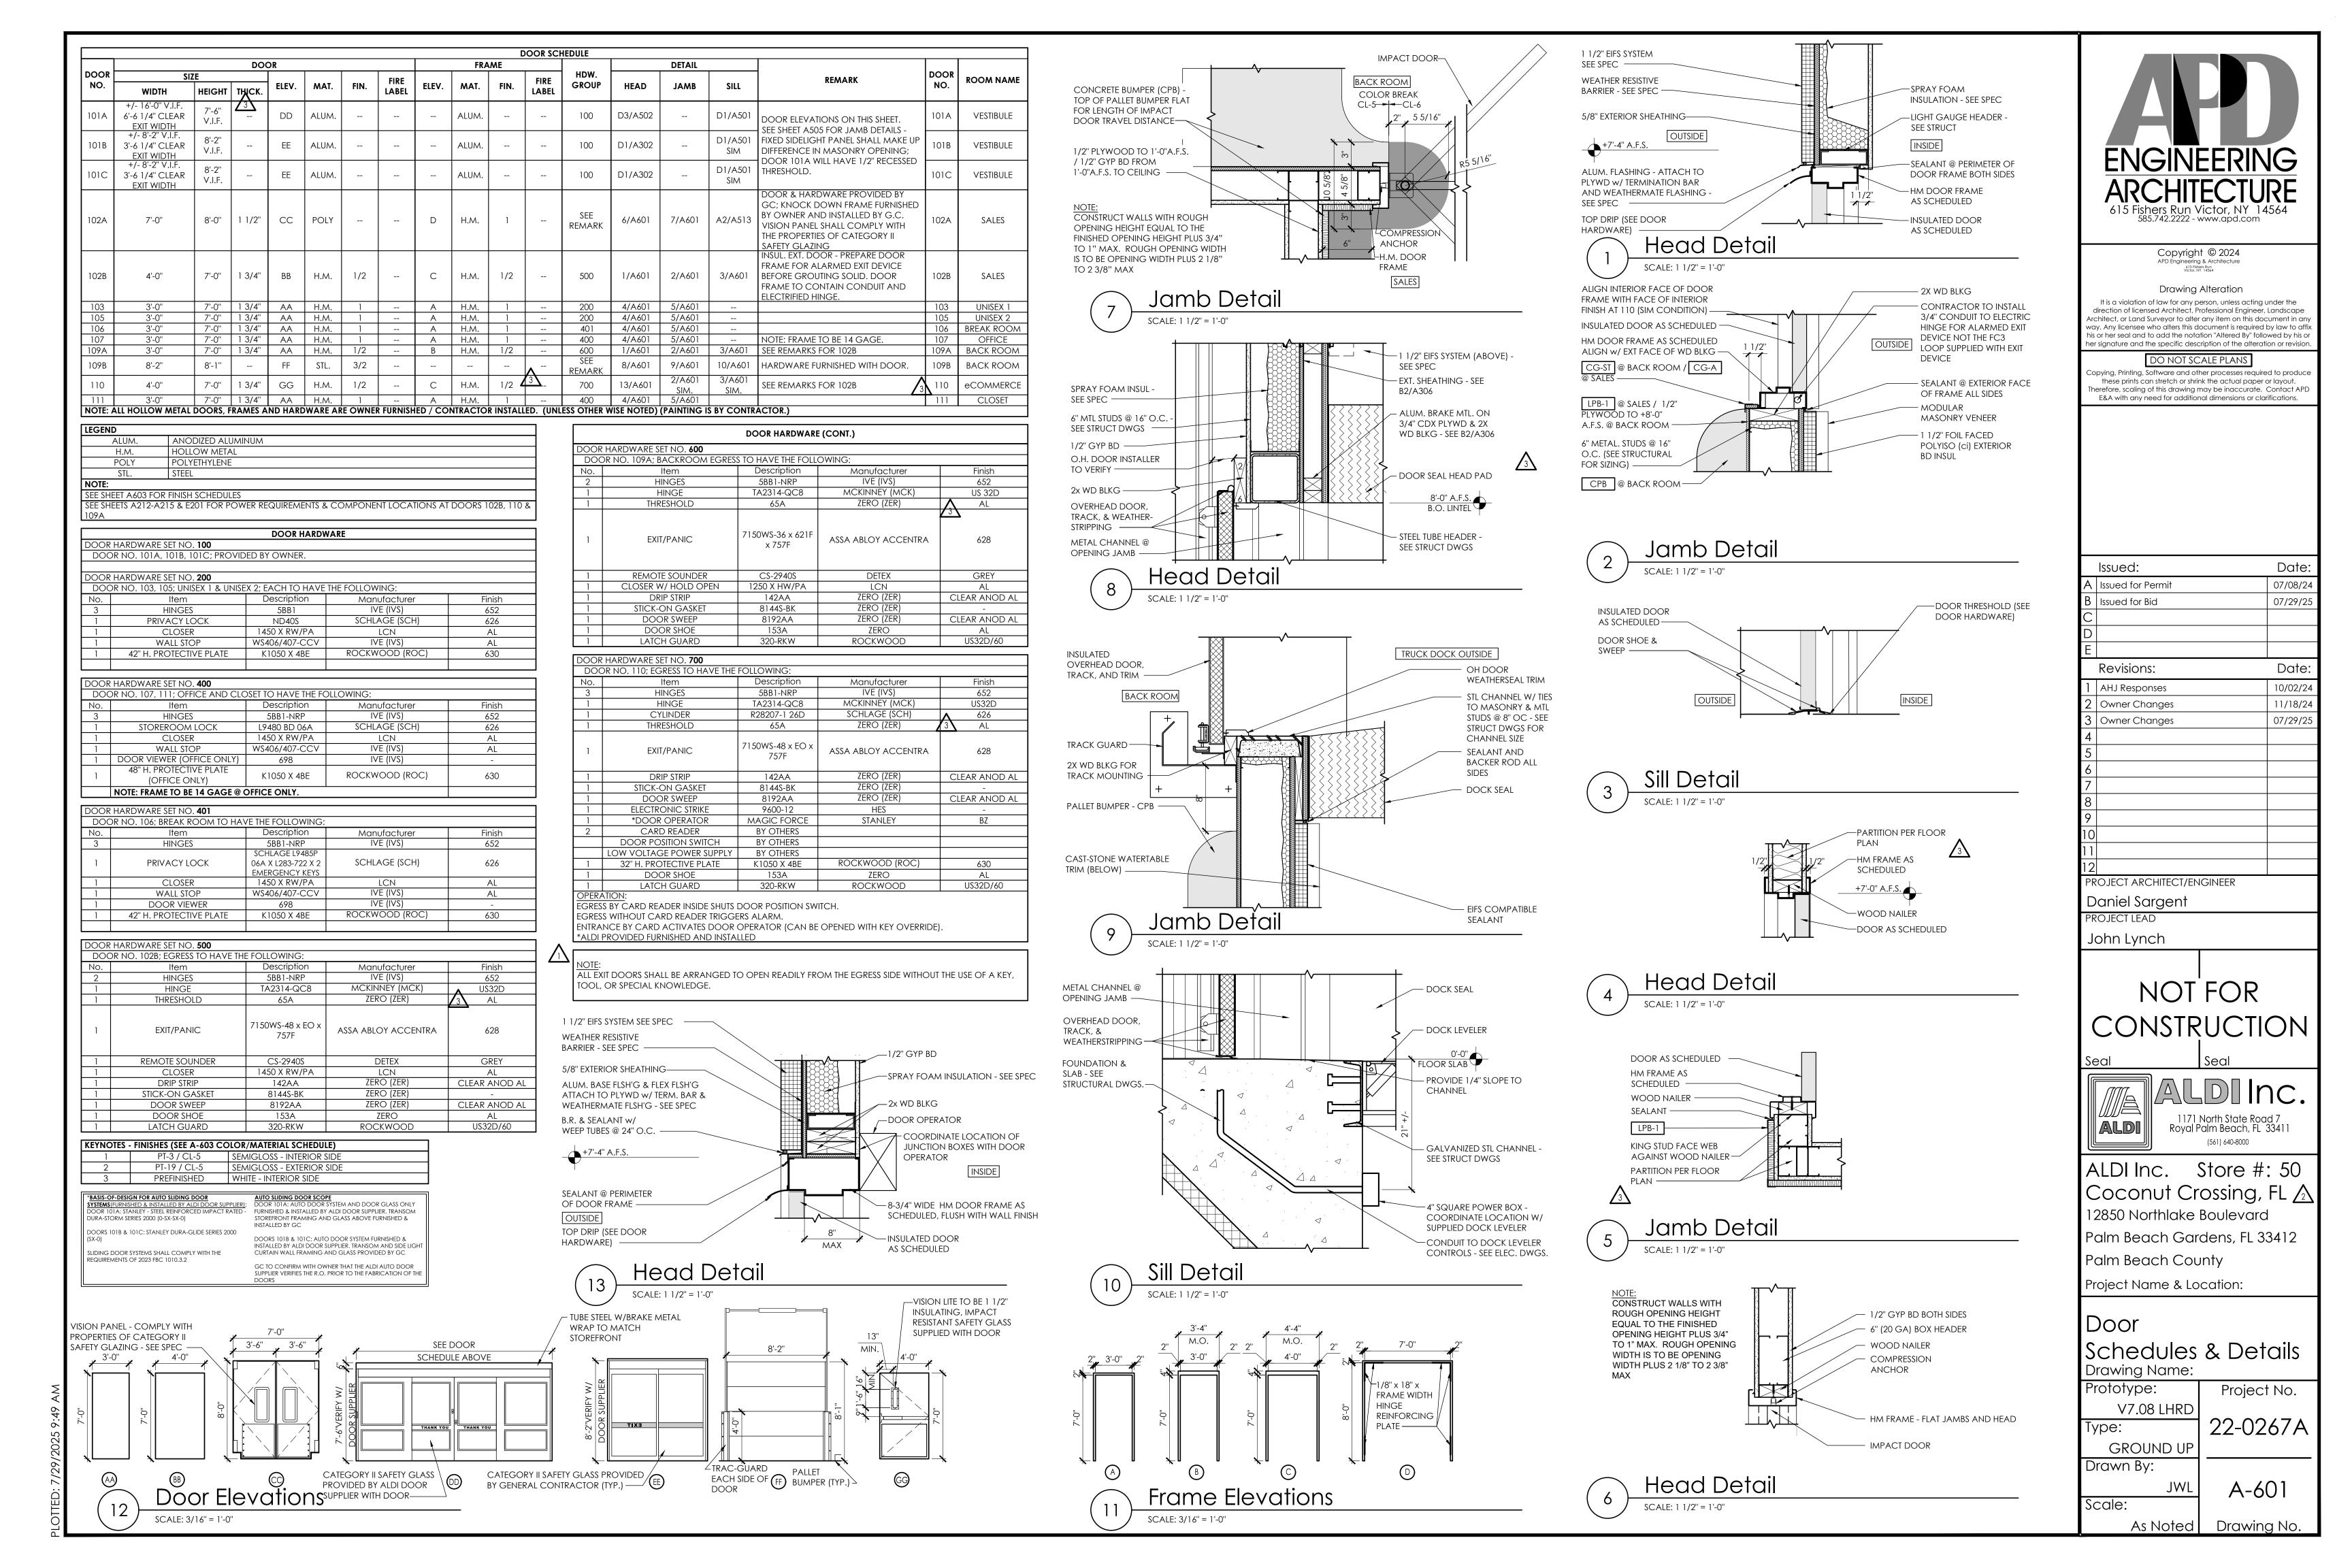

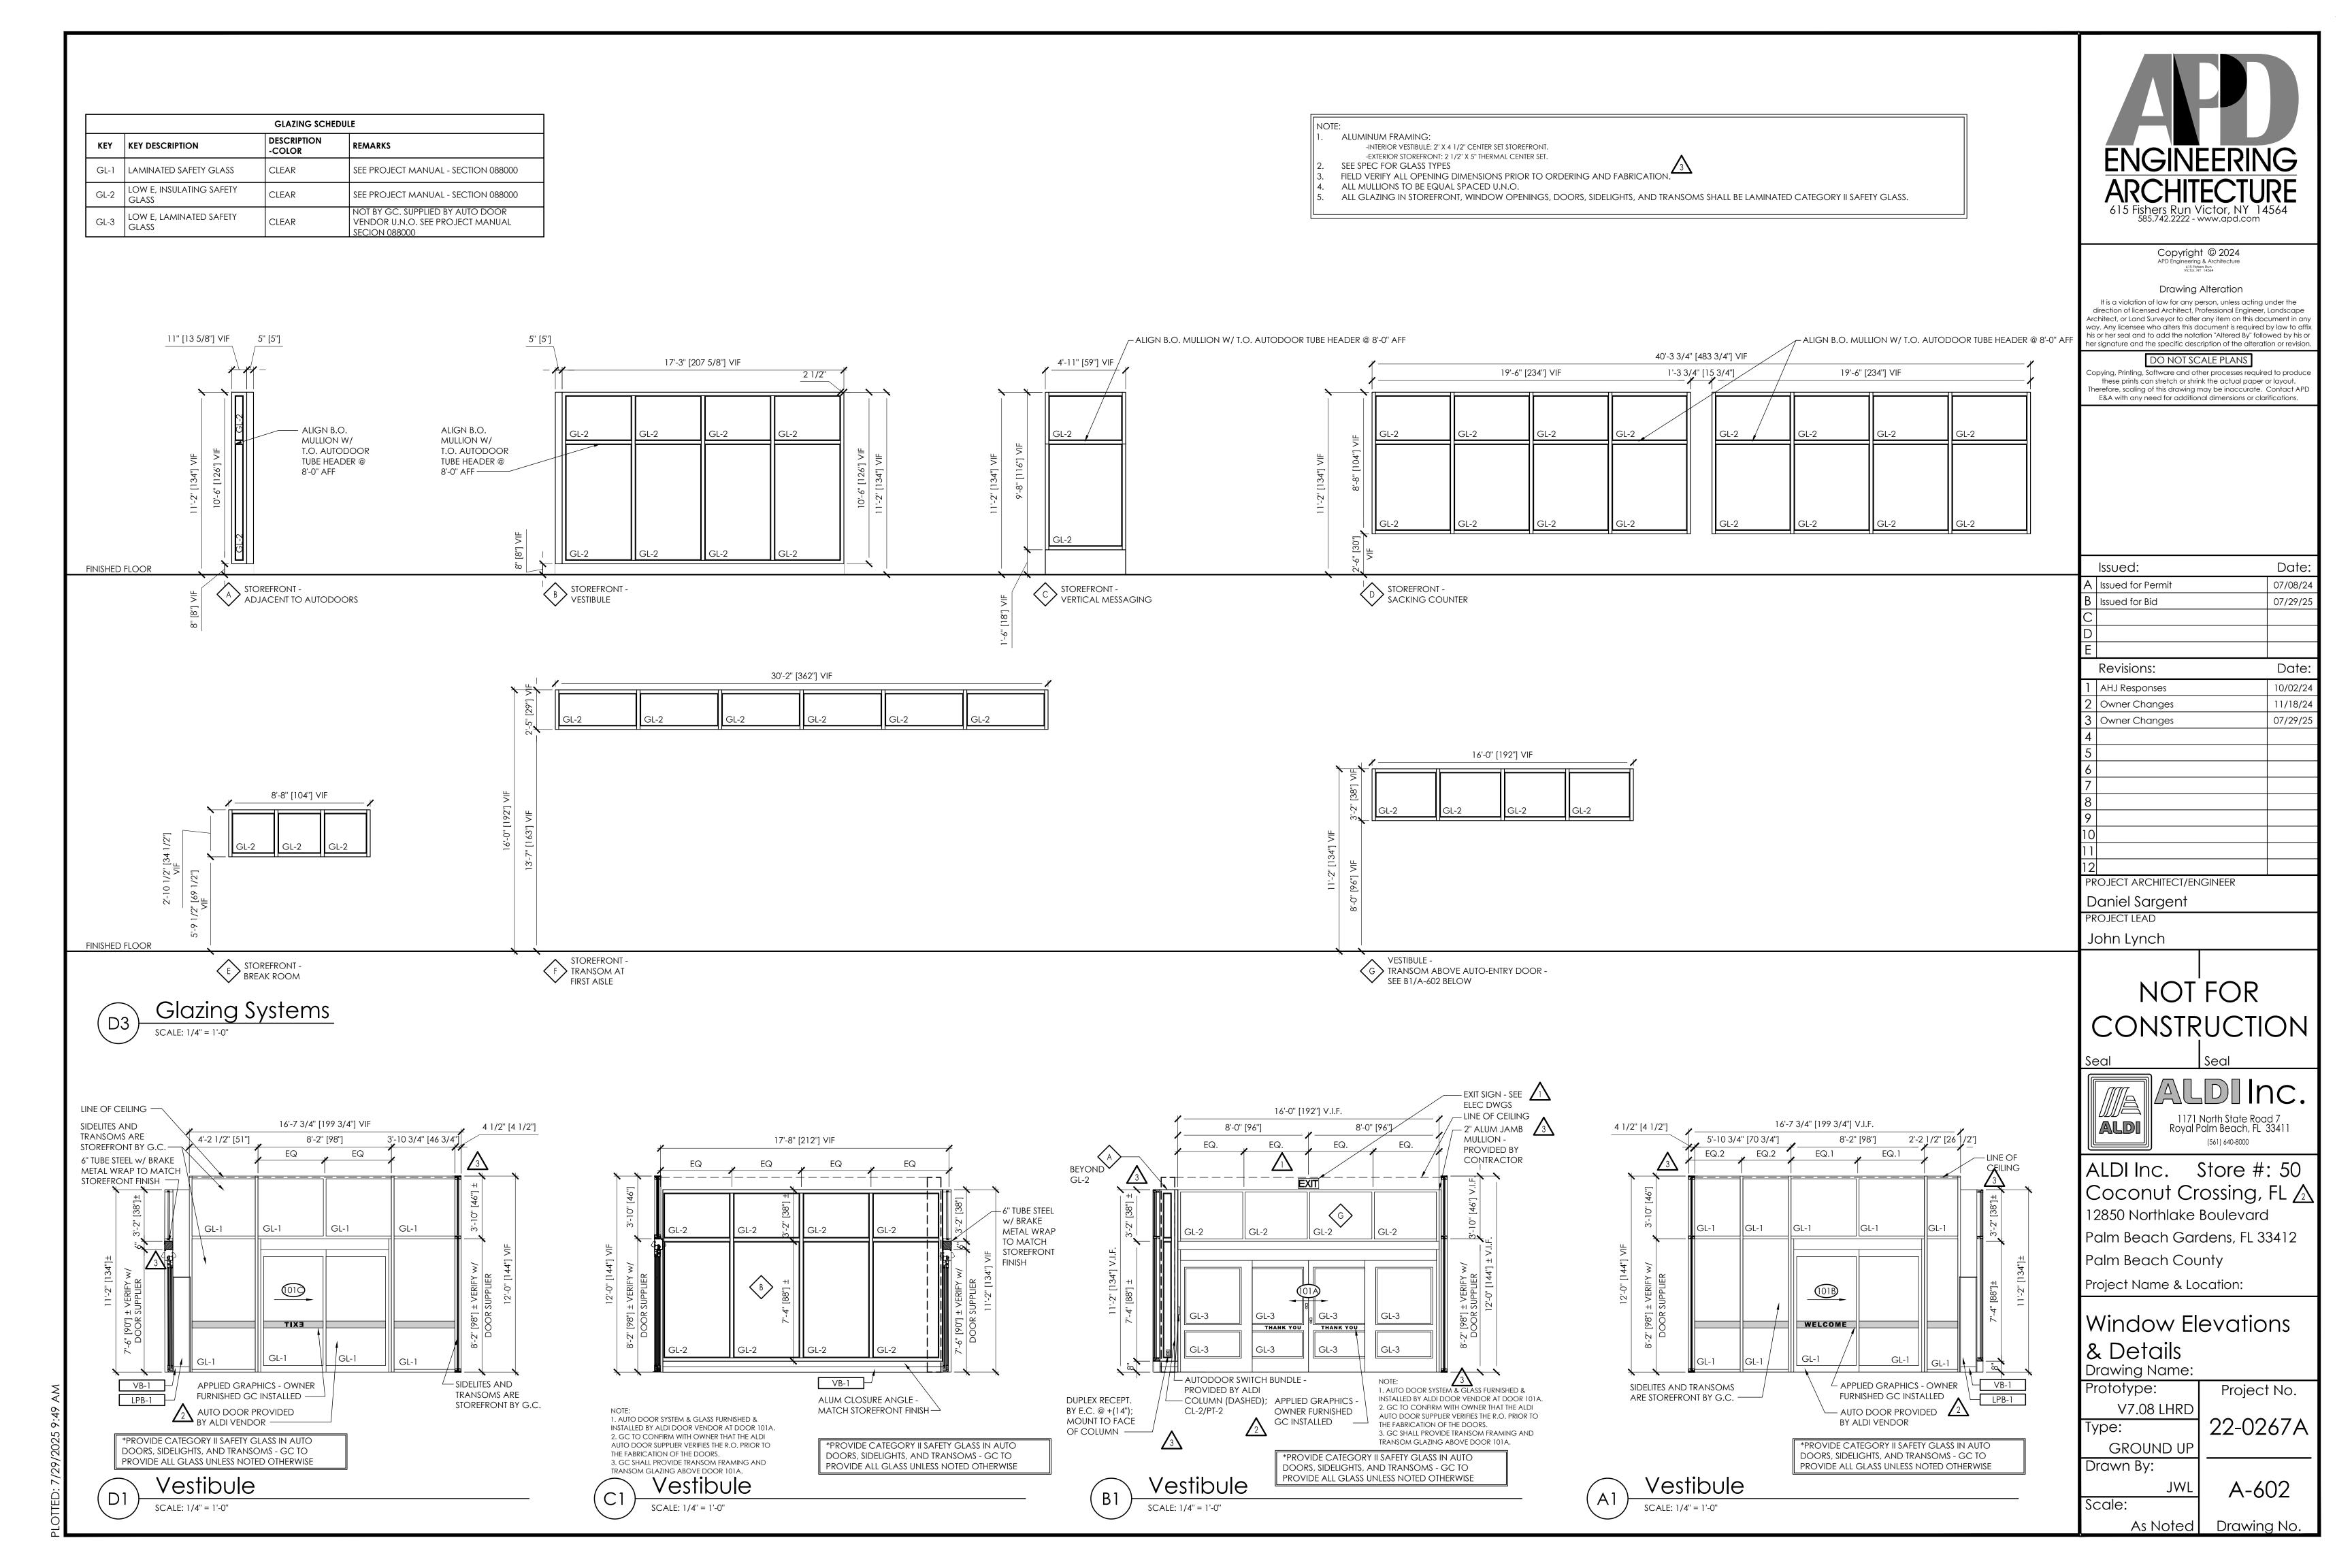

												ROOM F	INISH SCHE	DULE:								
OOM				GYP BD	SOUND	LPB	TOP	WALL	LEFT	WALL	ВОТТО	M WALL	RIGH	T WALL		CEILIN	G	GYP BD				ROO
NO.	ROOM NAME	FLOOR	BASE	THICKNESS	ATTENUATION BATTS	THICKNESS	LOWER	UPPER	LOWER	UPPER	LOWER	UPPER	LOWER	UPPER	MAT.	FIN.	HGT.	PAINT SYSTEM	CL#	SURFACE	REMARKS	M NO.
01	VESTIBULE	CONC	VB-1	1/2"		3/4"	AL/GL / LPB-1	AL/GL / GYP BD	AL/GL	AL/GL / GYP BD	AL/GL	AL/GL / GYP BD	AL/GL / LPB-1	AL/GL / GYP BD	SAPC-1		11'-11"	PT-6	CL-2	BELOW CEILING: GYP BD WALLS, SOFFITS, COLUMI	S	10
2	SALES	POLCONC	VB-1/ SS-3/ CPB/ SSBR	1/2" & 1/2 MLD. (A)(C)		3/4"	LPB-1	GYP BD	AL/GL / T1 / LPB-1	GYP BD	AL/GL / LPB-1 / GYP BD	AL/GL / GYP BD	LPB-1 / GYP BD	T-4 / WP-1 / GYP BD	EXP		VARIES	PT-6	CL-1	COLUMNS ON THE SALES FLOOR, DECK, BAR JOIST GIRDER TRUSSES, CONDUIT, SPRINKLER LINES, UNIS HARD DUCT WORK (U.N.O.), METAL GRILLES, GYP ABOVE PAINT LINE & VMT - SEE DWGS (PT-2) METAL GRILLES, SACKING COUNTER WALL ABOVE GYP BD WALLS BELOW PAINT LINE, SOFFITS, HARD DUCT WORK, AND VMT - SEE DWGS	RUT,	10
																				CONCRETE PALLET BUMPER		
3	UNISEX 1	POLCONC	SS-7	1/2" MLD (B)	X		T-2	GYP BD	T-2	GYP BD	T-2	GYP BD	T-2	GYP BD	SAPC-1		9'-6"	PT-5		GYP BD WALLS		1
4	HALL	POLCONC	VB-1	1/2"	X	3/4"	LPB-1	GYP BD	LPB-1	GYP BD	LPB-1	GYP BD	LPB-1	GYP BD	SAPC-1		9'-6"	PT-6		GYP BD WALLS, SOFFITS		
	11) 110 57 / 0				,,	·	T 0								GYP BD		9'-0''	57.5		CEILING AT DRINKING FOUNTAINS		+
5	UNISEX 2	POLCONC	SS-7	1/2" MLD (B)	X		T-2	GYP BD AL/GL /	T-2	GYP BD	T-2	GYP BD /	T-2	GYP BD	SAPC-1		9'-6"	PT-5		GYP BD WALLS		-
6	BREAKROOM	POLCONC	VB-1	1/2" MLD (c)	X		GYP BD	GYP BD	GYI	P BD	GYP BD	T-5	GY	P BD	SAPC-1		9'-6"	PT-5	CL-7 & 11	GYP BD WALLS		
)7	OFFICE	POLCONC	VB-1	1/2" MLD (c)	Х		GY	P BD	GYI	P BD	GYI	P BD	GY	P BD	SAPC-1		9'-6"	PT-5	CL-7	GYP BD WALLS		T
8	UTILITY AREA	CONC	-	1/2"			PLWD	GYP BD	PLWD	GYP BD	PLWD / FRP	PLWD / GYP BD	PLWD	GYP BD	EXP-1		VARIES	PT-5	CL-X	MATCH BACK ROOM	EXTEND FRP 4'-0" ABOVE MOP SINK ON BACK WALL. PLWD FULL HEIGHT BEHIND ROOF ACCESS LADDER - SEE C3/A213	
																			CL-4	EDGE OF OVERHEAD DOOR OPENING, TRACK GUARDS, WARNING STRIPES ON FLOOR (STRIPING BE 4" WIDE W/ 12" SPACING IN-BETWEEN)	0	
)9	BACK ROOM	CONC	СРВ	1/2"			PLWD	GYP BD	PLWD	GYP BD	PLWD	GYP BD	PLWD	GYP BD	EXP-1		VARIES	PT-5	CL-6	LOWER PLYWOOD WALLS, TRIM, CONCRETE PALLE BUMPER, COLUMNS, BRACED BAY STEEL, METAL GR CMU (WHEN APPLICABLE)		
																			CL-8	UPPER GYP BD WALLS		┸
																			CL-1	DECK, BAR JOISTS, GIRDER TRUSSES, CONDUIT, SPRINKLER LINES, UNISTRUT, HARD DUCT WORK		
10	ECOMMERCE	POLCONC	VB-1	1/2" MLD.	X	3/4"	LPB-1	GYP BD	LPB-1	GYP BD	LPB-1	GYP BD	LPB-1	GYP BD	EXP-1		VARIES	PT-6		(U.N.O.), METAL GRILLES, GYP BD ABOVE PAINT LIN		
																			CL-2	WALLS ABOVE LPB, SOFFITS & HARD DUCT WORK		
11	CLOSET	POLCONC	VB-1	1/2"			GY	P BD	GYI	P BD	GYI	P BD	GY	P BD	SAPC-1		9'-6"	PT-5	CL-7	GYP BD WALLS		
				INISH NOTES:	•	•	•							YP BD KEYNO	TEC.				•	5011	D ATTENUATION BATTS:	<u> </u>
1	SEE REELECTER) CEILING PLA		L CEILINGS AN	ID SOFFITS				. MOID	(MLD) RESIS	TANT GYP BD) TO EXTEND				EZER. MI ſ	O GYP BD TO	BE INSTAI	LED UP T		FOR FULL HEIGHT OF WALL ON ALL INTER	ĪOR
2					VNER AND INSTA	LLED BY CON	NTRACTOR		A WALLS	SURROUND	ING MULTI-DI	ECK UNITS AN	ND ALONG E	ENTIRE LENGT					<u> </u>		NG ROOMS WITH "X" IN SCHEDULE ABOV	
_	1.12. 2.1 10 7 11 1	=: .2		OVIDED BY OW				——————————————————————————————————————	B MOLD	(MLD) RESIS	TANT GYP BE	TO EXTEND	TO CEILING	ALL WALLS		· <u></u>		· <u></u>			VAPOR BARRIER [.]	

C MOLD (MLD) RESISTANT GYP BD ON WALLS ADJACENT TO FREEZER. APPLY VAPOR BARRIER BETWEEN GYP BD AND STUDS.

	E SPECIFICATION SECTION (4						
8 RE	FER TO PAINT FINISH SCHED	OULES FOR TREATMENT	AND COLOR OF WALL FINISHES.							
	_		FINISH MATERIAL SCHEDULE:			_			WALL AND SUR	RFACE PROTE
MAT. KEY	KEY DESCRIPTION	MANUFACTURER	DESCRIPTION - COLOR	REMARKS	MAT. KEY	KEY DESCRIPTION	ON	MANUFACTU	JRER	DESCRIPT
AL/GL	ALUMINUM & GLASS STOREFRONT		CLEAR ANODIZED	SEE A602 FOR GLAZING TYPES	BG	BUMPER GUAR	RD	McCUE		STAINLESS
CONC.	CONCRETE SLAB			SEE PROJECT MANUAL - SECTION 033000	BR	BUMPER RAIL		McCUE		CART STC
EXP	EXPOSED STRUCTURE		SEE ROOM FINISH SCHEDULE	SALES FLOOR - GC TO ENSURE ALL JOIST AND JOIST GIRDER TAGS ARE PROPERLY SECURED TO JOIST WEBBING AND CONCEALED FROM VIEW PRIOR TO PAINTING.	BR-C	BUMPER RAIL		McCUE		CART STC
EXP-1	EXPOSED STRUCTURE		NO PAINT	BACK ROOM/ABOVE CEILINGS	CG-A	CORNER GUAI	.RD	•		CLEAR AN
FRP	FIBER REINF PLASTIC		P-151 LIGHT GRAY	SEE PROJECT MANUAL - SECTION 066400	1			$\sqrt{2}$		
GR-1	GROUT	MAPEI	#5047 CHARCOAL	GROUT FOR T-2 AND T-3	CG-ST	CORNER GUAI	.RD			STEEL - PT
GR-2	NOT USED				1 2\					PT-3 / CL-
GR-3	GROUT	MAPEI	#5220 EGGSHELL	GROUT FOR T-4, T-5	СРВ	CONC. PALLET	T BUMPER	₹		ROOM, C
GR-4	NOT USED					O A DT DUI A DED				PT-3 / CL-
GR-5	GROUT	MAPEI	#5004 BAHAMA BEIGE	GROUT FOR T-1	CRTB	CART BUMPER				CONC N
GYP BD	GYPSUM WALL BOARD			SEE PROJECT MANUAL - SECTION 092900	_ KP	KICK PLATE				STAINLESS
LPB-1	LAMINATED PARTICLE BOARD - WAINSCOT	FORMICA	#5883-58 PECAN WOODLINE	COORDINATE W/ MILLWORK VENDOR TO BE INSTALLED 1/2" AFS - REFER TO APPENDIX A.	SSBR	STAINLESS STEE	EL BUMPE	R RAIL TARPENING	- LAFOLLETTE CO	STAINLESS
	LAMINATED PARTICLE BOARD - SACKING				MAT. KEY	KEY DESCRIPTION	ON	MANUFACTURER	BO DESCRIPTION - O	OLLARD SCHE
LPB-2	COUNTER, WINDOW SILLS AND CABINETRY,	FORMICA	#5884-58 CHESTNUT WOODLINE	COORDINATE W/ MILLWORK VENDOR. REFER TO APPENDIX A.	BLRD-1	NOT USED	\wedge			
	BREAK ROOM HIGH TOP COUNTER				BLRD-2	10" Ø BOLLARI	D		STEEL PIPE FILLED	
LPB-3	LAMINATED PARTICLE BOARD - COUNTERTOPS OFFICE	FORMICA	#961-58 FOG	COORDINATE W/ MILLWORK VENDOR. REFER TO APPENDIX A.	BLRD-3	3" Ø BOLLARD			GALV STEEL PIPE	
LPB-4	NOT USED				_					
LPB-5	LAMINATED PARTICLE BOARD - COOLER AND FREEZER VALANCES	FORMICA	#2297-58 TERRILL	COORDINATE W/ MILLWORK VENDOR. REFER TO APPENDIX A.	BLRD-4	6" Ø STEEL PIPE BOLLARD W/ C		McCUE CORPORATION	SLOPED PLASTIC CSPC-6S-54-155	
POLCONC	CONCRETE SLAB		GROUND AND POLISHED	COORDINATE W/ POLISHING VENDOR. REFER TO APPENDIX B.					EQUIPMENT A	
PLWD	PLYWOOD - PAINTED		PT-7 / CL-6: SEMIGLOSS	BACK ROOM; SEE PROJECT MANUAL - SECTION 061053 (RUN PLWD VERTICAL)		KEY DESCRIPTION		MANUFACTURER BY CONTRACTOR	DESCRIPTION - 0	COLOR
SAPC-1	SUSPENDED ACOUSTIC PANEL CEILING		WHITE	SEE PROJECT MANUAL - SECTION 095113	AC-X	TOILET ROOM A				
SS-1	SCHLUTER STRIP - SACKING COUNTER TILE	SCHLUTER	SCHIENE; AE 100; SATIN ANODIZED ALUMINUM FINISH	THIN SET PORCELAIN WALL TILE EDGE - SIZE TO FIT TILE; INCLUDE ALL SPECIAL CORNER AND TRIM SHAPES (GC FURNISH AND INSTALL)	MDU TR-1	W/INTEGRAL FA		HUSSMAN DAWN ENTERPRISES	MODEL # RP409	S-ALDI - FAC
	SCHLUTER STRIP -	COULITED	RONDEC; DB 14 AE; SATIN ANODIZED	WALL TILE EDGE - SIZE TO FIT TILE; INCLUDE ALL SPECIAL CORNER AND TRIM SHAPES	R-1	REFRIGERATOR	?	FRIGIDAIRE	FINISH	
SS-2	RESTROOM WALL	SCHLUTER	ALUMINUM FINISH	(GC FURNISH AND INSTALL)	MW-1	MICROWAVE (WHIRLPOOL		
SS-3	SCHLUTER STRIP - SACKING COUNTER BASE	SCHLUTER	DILEX-AHKA; AHKA 100 AE; SATIN ANODIZED ALUMINUM FINISH	WALL TILE BASE - SIZE TO FIT TILE; INCLUDE ALL SPECIAL CORNER AND TRIM SHAPES; INSTALL FLANGE ON VERTICAL SURFACE (GC FURNISH AND INSTALL)	DW-1	DISHWASHER		FRIGIDAIRE		
SS-4	SCHLUTER STRIP - SACKING COUNTER TILE	SCHLUTER	QUADEC; Q100 AE; SATIN ANODIZED ALUMINUM FINISH	THIN SET PORCELAIN TILE CORNERS - SIZE TO FIT TILE; INCLUDE ALL SPECIAL CORNER AND TRIM SHAPES	R-2	REFRIGERATOR	?	TRUE		
\$S-5	NOT USED			(GC FURNISH AND INSTALL)	F-1	FREEZER		TRUE		
SS-6	NOT USED				┨┌───				CG-4	A SCHEDULE
33-0				WALL TILE BASE - SIZE TO FIT TILE; INCLUDE ALL SPECIAL CORNER	TYPE		SIZE		REMARKS	(CONEDULE
SS-7	SCHLUTER STRIP - RESTROOM WALL BASE	SCHLUTER	DILEX-AHKA; AHKA 80 AE; SATIN ANODIZED ALUMINUM FINISH	AND TRIM SHAPES; INSTALL FLANGE ON VERTICAL SURFACE (GC FURNISH AND INSTALL)	INSIDE CC	ORNERS	1" x 1" x 1	1/16" x 80" LENGTHS	INSTALL AT LP	
SSM-1	SOLID SURFACE MATERIAL - COUNTER BREAKROOM	WILSONART	#9175 ML(3) AVALANCHE MELANGE	COORDINATE W/ MILLWORK VENDOR. REFER TO APPENDIX A.	J CHANNE			1/16" x 80" LENGTHS " LENGTHS	INSTALL AT LP INSTALLED AT OWNER FURN	T ALL LPB ED VISHED CON
T-1	GLAZED TILE	DALTILE	WILLOW BEND - DARK BROWN WB03, 6"X24" (//3 BOND)	SACKING COUNTER ACCENT TILE; (GC FURNISH AND INSTALL) GROUT: GR-5	ANGLE		FRY REG	LET JDM-50	INSTALLED AT PROVIDED	
T-2	PORCELAIN TILE	DALTILE	DB PORTFOLIO PORC - 12"X24" PF05 ASH	RESTROOM WALL TILE;					INTERIOR MT	TL. STUD SCH
I-Z	I ONCLUMIN THE	DALIILL	GRAY STD (RUNNING BOND)	(GC FURNISH AND INSTALL); GROUT: GR-1		3 5/8" STUD DESIG			XIMUM HEIGHT	
T-3	PORCELAIN TILE	DALTILE	DB PORTFOLIO PORC - 12"X24" PF05 ASH GRAY STD (1/3 RUNNING BOND)	ANCILLARY FLOOR TILE; (GC FURNISH AND INSTALL); GROUT: GR-1	362\$1	125-30 @ 16" O.C 125-43 @ 16" O.C	C. (18 GA	UGE)	16'-1" 17'-5"	600
			RITTENHOUSE SQUARE - WHITE 0100	I SALES FLOOR REAR WALL ACCENTITIE:	12075	125-54@16"00) (14 <u>C A</u>	LIGE) I	18'_8"	400

(GC FURNISH AND INSTALL); GROUT: GR-3

(GC FURNISH AND INSTALL) GROUT: GR-5

RCOOPER@ARCHSYSTEMS.COM AND CC

FOR NATIONAL ACCOUNT ORDERING, CONTACT RACHEL

COOPER OF ARCH SYSTEMS VIA PHONE: 646-460-8222 OR EMAIL:

FOR NATIONAL ACCOUNT ORDERING, CONTACT BLAKE CHAFFEE OF SKYLINE FLOORSCAPES VIA PHONE 512-782-8484 OR EMAIL

SEE PROJECT MANUAL - SECTION 096513

SALES FLOOR REAR WALL ACCENT TILE;

BREAKROOM BACKSPLASH TILE;

MRAMPELLI@ARCHSYSTEMS.COM

BLAKEC@SKYLINEFLOORSCAPES.COM

				WALL AND SURF	ACE PROTECTION	SCHEDULE :	
MAT. KEY	KEY DESCRIPTION	M	ANUFACTUE	RER	DESCRIPTION - C	OLOR	REMARKS
BG	BUMPER GUARD	Mo	CCUE		STAINLESS STEEL		SEE PROJECT MANUAL - SECTION 102600
BR	BUMPER RAIL	Mo	CCUE		CART STOP SSR		SEE PROJECT MANUAL - SECTION 102600
BR-C	BUMPER RAIL	Mo	CCUE		CART STOP UG15	50 12"H 101 (GREY)	SEE PROJECT MANUAL - SECTION 102600
CG-A	CORNER GUARD	2			CLEAR ANODIZE	O ALUMINUM	SEE PROJECT MANUAL - VOL. 3, APPENDIX A SECTION 064023 REFER TO CG-A SCHEDULE FOR SIZE AND LOCATION
CG-ST	CORNER GUARD				STEEL - PT-3 / CL-	6: SEMIGLOSS	SEE PROJECT MANUAL - SECTION 055000
2 СРВ	CONC. PALLET BUMPE	R			PT-3 / CL-6: SEMI ROOM, COOLER PT-3 / CL-5: SEMI	, FREEZER)	SEE DETAIL B1/A511 FOR ASSEMBLY SEE DETAIL 7/A601 FOR COLOR BREAK
CRTB	CART BUMPER				CONC NATURAL	- RUBBED FINISH	SEE DETAIL D1/S301
KP	KICK PLATE				STAINLESS STEEL		SEE PROJECT MANUAL - VOL. 3, APPENDIX A SECTION 087100
SSBR	STAINLESS STEEL BUMP	er rail ta	RPENING -	LAFOLLETTE CO	STAINLESS STEEL		
				BOL	LARD SCHEDULE :		
MAT. KEY	KEY DESCRIPTION	MANUFAC	CTURER	DESCRIPTION - C	OLOR	REMARK	
BLRD-1	NOT USED						
BLRD-2	10" Ø BOLLARD	3		STEEL PIPE FILLED PT-19 / CL-4: SEM		@ LOADING DOCK -	SEE STRUCTURAL DWG.
						@ CART CORRAL - C	CENTER WITHIN ROWS. ATTACH OWNER

VAPOR BARRIER:

STUD AND GYP ON FREEZER SIDE OF WALL

PROVIDE VAPOR BARRIER ON WALLS ADJACENT TO FREEZER BETWEEN

PROVIDED STARTER CHAINS FOR CART SYSTEM - COORD LAYOUT

WITH ALDI CONSTRUCTION REPRESENTATIVE;

					SEE PROJECT MANUAL - SECTION 055000
	BLRD-4	6" Ø STEEL PIPE BOLLARD W/ COVER	McCUE CORPORATION	SLOPED PLASTIC COVER CSPC-6S-54-155	SLOPED SIDE OF COVER TO FACE AWAY FROM BUILDING. FOR ORDERING, CONTACT JOHN ROMANO, 574-532-0221, ROMKTG@AOL.COM
				EQUIPMENT AND ACCESSORY SO	CHEDULE :
	MAT. KEY	KEY DESCRIPTION	MANUFACTURER	DESCRIPTION - COLOR	REMARK
	AC-X	TOILET ROOM ACC.	BY CONTRACTOR		SEE PROJECT MANUAL - SECTION 102800
\dashv	MDU	MULTIDECK UNITS W/INTEGRAL FASCIA	HUSSMAN	\triangle	BY OWNER
	TR-1	TRASH RECEPTACLE	DAWN ENTERPRISES	MODEL # RP40S-ALDI - FACTORY FINISH	FOR ORDERING, CONTACT DAWN ENTERPRISES VIA PHONE: 800-262-3296 OR EMAIL: brenda@godawn.com
	R-1	REFRIGERATOR	FRIGIDAIRE		OWNER SUPPLIED CONTRACTOR INSTALLED
	MW-1	MICROWAVE OVEN	WHIRLPOOL	<u></u>	OWNER SUPPLIED CONTRACTOR INSTALLED
	DW-1	DISHWASHER	FRIGIDAIRE		OWNER SUPPLIED CONTRACTOR INSTALLED
L	R-2	REFRIGERATOR	TRUE		OWNER SUPPLIED CONTRACTOR INSTALLED
	F-1	FREEZER	TRUE		OWNER SUPPLIED CONTRACTOR INSTALLED
\exists				CG-A SCHEDULE (U.N.O.):

TYPE	SIZE	REMARKS
INSIDE CORNERS	1" x 1" x 1/16" x 80" LENGTHS	INSTALL AT LPB ONLY. OWNER FURNISHED CONTRACTOR INSTALLED
OUTSIDE CORNERS	2" x 2" x 1/16" x 80" LENGTHS	INSTALL AT LPB ONLY. OWNER FURNISHED CONTRACTOR INSTALLED
J CHANNEL	3/4" x 96" LENGTHS	INSTALLED AT ALL LPB EDGES. LONG LEG ON THE BACK SIDE OF LPB AND SHORT LEG LEFT EXPOSED. OWNER FURNISHED CONTRACTOR INSTALLED
ANGLE	FRY REGLET JDM-50	INSTALLED AT BOTTOM OF GYP. BD. ABOVE COOLER AND FREEZER DOORS. CONTRACTOR PROVIDED

	INTERIOR MTL.	STUD SCHEDULE (U.N.O.):	
3 5/8" STUD DESIGNATION	MAXIMUM HEIGHT	6" STUD DESIGNATION	MAXIMUM HEIGHT
362\$125-30 @ 16" O.C. (20 GAUGE)	16'-1"	600\$125-30 @ 16" O.C. (20 GAUGE)	23'-0"
362\$125-43 @ 16" O.C. (18 GAUGE)	17'-5"	600\$125-43 @ 16" O.C. (18 GAUGE)	26'-2"
362\$125-54 @ 16" O.C. (16 GAUGE)	18'-8"	600\$125-54 @ 16" O.C. (16 GAUGE)	28'-0"
		NOTES	

STUD DEPTH INDICATED ON DRAWINGS
Studs per this table require sheathing both sides of stud and/or bridging at 4'-(
STRUCTURAL DRAWINGS & PROJECT SPECIFIC LIGHT GAUGE SHOP DRAWINGS SUPERSEDE
DROVIDE DOUBLE KING STUDS ON BOTH SIDES OF OBENING

OVIDE DOUBLE KING STUDS ON BOTH SIDES OF OPENING.	
TABLE IS FOR GENERAL REFERENCE ONLY, STUD MANUFACTURER'S SPAN TABLES SHOULD SUPERSEDE THIS TABLE BASED ON STUD DESIGNATION SELECTED	
D SPAN REQUIREMENTS.	

			PAINT COLOR SCHEDUL	E:
MAT. KEY	KEY DESCRIPTION	MANUFACTURER	DESCRIPTION - COLOR	REMARKS
CL-1	PAINT COLOR	SHERWIN WILLIAMS	#7510 CHATEAU BROWN	
CL-2	PAINT COLOR	SHERWIN WILLIAMS	#6071 POPULAR GRAY	
CL-3	PAINT COLOR	SHERWIN WILLIAMS	#6073 PERFECT GREIGE	USED ABOVE PAINT BREAK LINE ONLY WITH SUSPENDED CEILING
CL-4	PAINT COLOR	SHERWIN WILLIAMS	SAFETY YELLOW	
CL-5	PAINT COLOR	SHERWIN WILLIAMS	#7504 KEYSTONE GRAY	
CL-6	PAINT COLOR	SHERWIN WILLIAMS	#7073 NETWORK GRAY	
CL-7	PAINT COLOR	SHERWIN WILLIAMS	#7015 REPOSE GRAY	
CL-8	PAINT COLOR	SHERWIN WILLIAMS	#7757 HIGH REFLECTIVE WHITE	
CL-9	PAINT COLOR	SHERWIN WILLIAMS	#6089 GROUNDED (197-C6)	
CL-10	NOT USED			
CL-11	PAINT COLOR	SHERWIN WILLIAMS	#6499 STREAM	
PT-X	PAINT SYSTEM	BY CONTRACTOR		SEE PAINT SYSTEM SCHEDULE ON THIS SHEET. REFER TO SPEC SECTION 099100 FOR PRODUCT REQUIREMENTS.

INTERIOR PAINT SYSTEM SCHEDULE				
PT#	SYSTEM	SUBSTRATE	SYSTEM	
PT-1	LATEX SEMI-GLOSS	CONCRETE BLOCK	1C. PRIMER B25W25 1C. B31-2600 1C. B31-2600	
PT-2	DRY-FALL (RETROFIT/ RENOVATION/ REFRESH STORES)	EXPOSED STEEL, WOOD, DUCTS, CONDUIT & SCRIM	1C. PRIMER B66-1560 1C. B66-1560	
PT-2	DRY-FALL (NEW CONSTRUCTION STORES)	EXPOSED STEEL, WOOD, DUCTS, CONDUIT & SCRIM	STEEL DECKS: 1C. PRIMER B66-310 1C. B42W181 GALVANIZED DECKS: 1C. PRIMER B42W181 1C. B42W181	
PT-3	LATEX SEMI-GLOSS	STEEL & CONC.	1C. PRIMER B66-310 1C. B66-650 1C. B66-650	
PT-4	LATEX SEMI-GLOSS	GALVANIZED METAL GRILLES	1C. PRIMER B66-310 1C. B66-650 1C. B66-650	
PT-5	LATEX EGGSHELL	GYPSUM BOARD	1C. PRIMER B28W2600 1C. B20-2600 1C. B20-2600	
PT-6	LATEX FLAT	GYPSUM BOARD	1C. PRIMER B28W2600 1C. B30-2600 1C. B30-2600	
PT-7	LATEX SEMI-GLOSS	PLYWOOD AND TRIM	1C. PRIMER B28W8111 1C. B31 1C. B31	
PT-8	WATER-BORNE URETHANE	STEEL	1C. PRIMER 646-100 1C. B65-720 1C. B65-720	
PT-9	WATER-BORNE EPOXY /URETHANE	CONCRETE	1C. PRIMER 3460 WBE 1C. 3460 WBE/5150-15 1C. 4408	
PT-10	WATER-BORNE EPOXY	CONCRETE	1C. PRIMER 8100 1C. 8100 1C. 8100	

X	PAINT SYSTEM	BY CONTRACTOR			SPEC SECTION 0	99100 FOR PROI	DUCT REQUIREMENT
INTERIOR PAINT SYSTEM SCHEDULE				EXTERIOR PAINT SYSTEM SCHEDULE			
	SYSTEM	SUBSTRATE	SYSTEM	PT #	SYSTEM	SUBSTRATE	SYSTEM
	LATEX SEMI-GLOSS	CONCRETE BLOCK	1C. PRIMER B25W25 1C. B31-2600 1C. B31-2600	PT-15	LATEX SATIN	CAST CONCRETE	1C. PRIMER A24W 1C. K62-650 1C. K62-650
	DRY-FALL (RETROFIT/ RENOVATION/	EXPOSED STEEL, WOOD, DUCTS,	1C. PRIMER B66-1560 1C. B66-1560	PT-16	URETHANE GLOSS	CONCRETE BLOCK	1C. PRIMER A2W: 1C. 646-100 1C. B65-720
REFRESH STORES)		CONDUIT & SCRIM		PT-17	LATEX SATIN	EXISTING EIFS /STUCCO	1C. PRIMER B28W2 1C. B20-2600 1C. B20-2600
	DRY-FALL (NEW CONSTRUCTION	STEEL, WOOD, DUCTS,	1C. PRIMER B66-310 1C. B42W181 GALVANIZED DECKS:	PT-18	LATEX SATIN	P.T. WOOD	1C. PRIMER B24W 1C. K43 1C. K43
STORES)	STORES)	CONDUIT & SCRIM	1C. PRIMER B42W181 1C. B42W181	PT-19	LATEX GLOSS	STEEL	1C. PRIMER 646- 1C. B65-720
	LATEX SEMI-GLOSS	STEEL & CONC.	1C. PRIMER B66-310 1C. B66-650 1C. B66-650	PT-20	LATEX OVER ALKALI-RESISTANT	CMU	1C. B65-720 1C. PRIMER A24W 1C. K43
	LATEX SEMI-GLOSS	GALVANIZED METAL GRILLES	1C. PRIMER B66-310 1C. B66-650 1C. B66-650	PRIMER SYSTEM 1C. K43 PAINT NOTES: PAINT COLORS MUST BE PROVIDED BY MANUFACTURER			
	LATEX EGGSHELL	GYPSUM BOARD	1C. PRIMER B28W2600 1C. B20-2600 1C. B20-2600	1 1	NDICATED; NO SUBS COLOR. ALL PAINTS ARE FRO	STITUTIONS WILL E	BE ACCEPTED FOR
	LATEX FLAT	GYPSUM BOARD	1C. PRIMER B28W2600 1C. B30-2600 1C. B30-2600	2 (CONTACT: TODD MOTODD.R.MCMARTING	CMARTIN 630-61	7-1714 /
	LATEX SEMI-GLOSS	PLYWOOD AND TRIM	1C. PRIMER B28W8111 1C. B31 1C. B31				
٦			1C. PRIMER 646-100				

THERMAL INSULATION SCHEDULE							
LOCATION	MIN. R VALUE	INSULATION TYPE	DESIGN STANDARD	REMARKS			
UNDER SLABS	5 PER INCH TOTAL: 30	TYPE IV EXTRUDED-POLYSTYRENE BOARD INSULATION		PROVIDE UNDER FREEZER SLAB			
CONCEALED BUILDING INSULATION	7.4 PER INCH TOTAL: 28	CLOSED-CELL SPRAY POLYURETHANE FOAM	ICYNENE HF0200	PROVIDE AT PERIMETER WALL STUDS AS SHOWN ON DRAWINGS - THERMAL BARRIER OF EITHER FULL HEIGHT 1/2" GYP. BD. OR INTUMESCENT COATING REQUIRED; SEE SPECIFICATIONS - 072100.2.8.A.2; GC TO PROVIDE BASED ON COST ANALYSIS			
METAL STUDS & GYP BD PARTITIONS	N/A	SOUND ATTENUATION BLANKETS		PROVIDE PER ROOM FINISH SCHEDULE			
CONCEALED SPACES	3.7 PER INCH	OPEN-CELL SPRAY POLYURETHANE FOAM	ICYNENE CLASSIC (LD-C-50)				
ROOF INSULATION	5.71 PER INCH TOTAL: 24	POLYISOCYANURATE BOARD INSULATION	CLOSE-CELL FOAM CORE FIBER-REINFORCED ORGANIC FELT FACERS	CONFIRM REQUIRED INSULATION THICKNESS TO OBTAIN DESIGN R-VALUE WITH MANUFACTURER			

INSULATION NOTES:

1 MINIMUM 'R' VALUE BASED ON (LTTR.) LONG TERM THERMAL RESISTANCE VALUE PER ASTM C1289.



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	Revisions:	Date:
1	Owner Changes	11/18/24
2	Owner Changes	07/29/25
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PR	OJECT ARCHITECT/ENGINEER	
	aniel Sargent	
PR	OJECT LEAD	
J	ohn Lynch	

NOT FOR CONSTRUCTION

1171 North State Road 7 Royal Palm Beach, FL 33411

Project No.

ALDI Inc. Store #: 50 Coconut Crossing, FL 🛆 12850 Northlake Boulevard

Palm Beach Gardens, FL 33412 Palm Beach County

Project Name & Location:

Finish Schedules & Notes

Drawing Name: Prototype: V7.08 LHRD

22-0267A GROUND UP Drawn By:

A-603 Scale: As Noted Drawing No.

PORCELAIN TILE

WOOD PANEL

GLAZED TILE

VINYL BASE

T-4

T-5

VB-1

WP-1

DALTILE

DALTILE

ROPPE

ARCH SYSTEMS

ALTERNATE: SKYLINE FLOORSCAPES

RITTENHOUSE SQUARE - WHITE 0100

MATTE, 3"X6" (RUNNING BOND)

193 BLACK /BROWN

ALTERNATE: SFS-W-0024

SEMI-GLOSS, 3"X6" (RUNNING BOND)

INTERPLAIT ECO-PANELS - WPVEP141

RITTENHOUSE SQUARE - ARCTIC WHITE

USE SOLVENT TO REMOVE ALL MANUFACTURER WORDING ON EXPOSED PVC PIPING.

PAINT ALL EXPOSED PIPING TO MATCH ADJACENT CEILING/WALL COVERING.

DO NOT PAINT GALVANIZED DOOR THRESHOLDS

7 SEE SPECIFICATION SECTION 099100 FOR PAINT SYSTEMS.