

# MIKE ERDMAN CADILLAC

4750 HIGHWAY 520 COCOA, FLORIDA

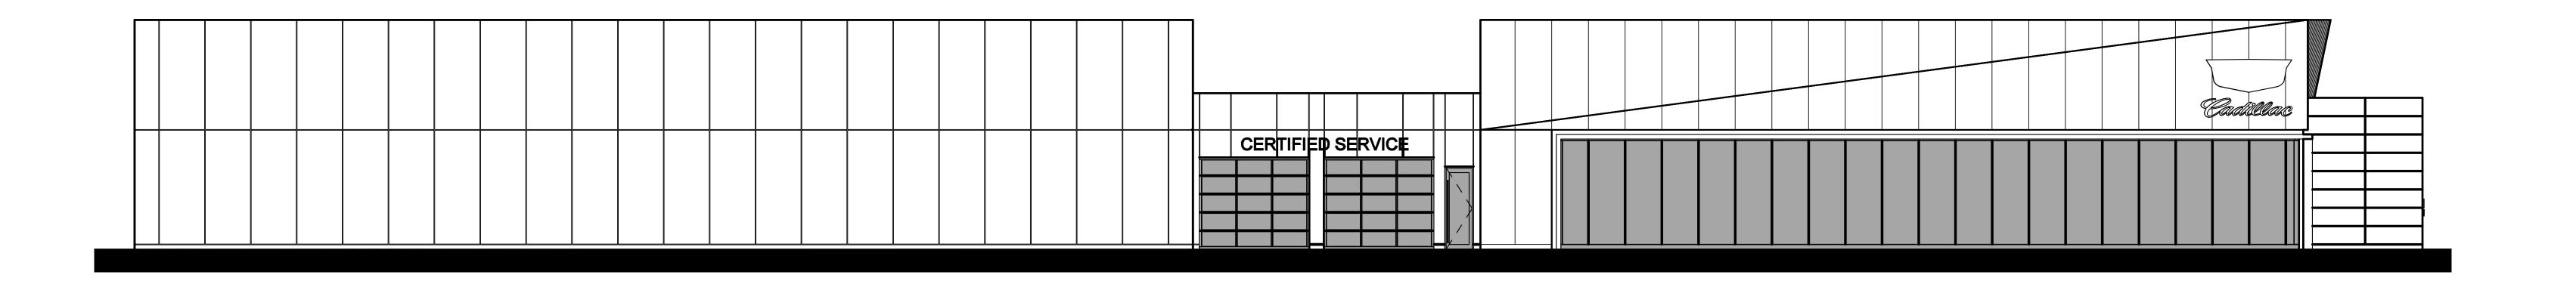



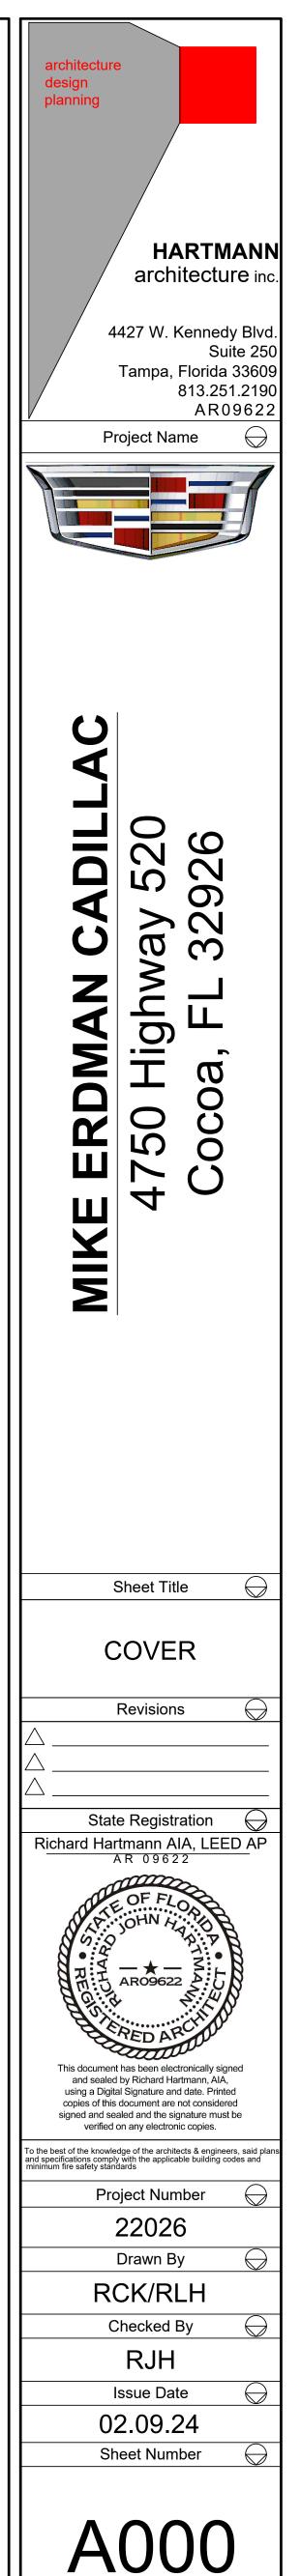

SHOULD INCONSISTENCIES OR DISCREPANCIES OCCUR WITHIN THESE DRAWINGS OR SPECIFICATIONS, THE BETTER QUALITY, GREATER QUALITY AND MOST EXPENSIVE PRODUCT OR TASK SHALL BE PERFORMED OR FURNISHED, UNLESS INSTRUCTED OTHERWISE BY THE ARCHITECT. DISCREPANCIES BETWEEN SPECIFIED ITEMS OR INSTALLATION METHODS SHALL NOT BE CAUSE FOR MODIFICATION TO THE CONTRACT SUM OR CONTRACT TIME.

## MIKE ERDMAN CADILLAC

## 4750 HIGHWAY 520 COCOA, FLORIDA

THIS PROJECT IS A SINGLE STORY, 20,121 S.F., AUTOMOBILE DEALERSHIP, WITH SERVICE DEPARTMENT AND ASSOCIATED SITE WORK. THE PROJECT WILL CONTAIN A SHOWROOM, CUSTOMER VEHICLE SERVICE AREAS. COVERED SERVICE DRIVE-THROUGH, SALES AND ADMINISTRATIVE OFFICES. THE FACILITY WILL ALSO CONTAIN, A SMALL PARTS STORAGE AREA W/ A MEZZANINE.

CONSTRUCTION WILL PRIMARILY BE CONCRETE TILT-UP PANELS. THE SHOWROOM WILL BE SURROUNDED BY A CURTAIN WALL SYSTEM. THE ROOF WILL BE A TPO TYPE ROOF AND ALL RAIN WATER ON THE ROOF WILL BE TIED INTO A STORM WATER SYSTEM. THE SERVICE DEPARTMENT WILL BE AIR CONDITIONED. THERE WILL ALSO BE AN OIL /WATER SEPARATOR (REFER TO SITE PLAN FOR LOCATION). THIS BUILDING WILL BE FULLY FIRE SPRINKLERED PER NFPA 13.

## PROJECT DESCRIPTION

<u>A</u>		K	
AB	ANCHOR BOLT	KIT	KITCHEN
ABV	ABOVE	KO	KNOCKOUT
ACT	ACOUSTICAL CEILING TILE	KPL	KICK PLATE
ADJ	ADJUSTABLE	1	
AFF	ABOVE FINISHED FLOOR	<u>-</u>	
AHU ALT	AIR HANDLING UNIT ALTERNATE	LAM	LAMINATED
ALI	ALUMINUM	LAV	LAVATORY
APPROX	APPROXIMATE	LB	POUND
ARCH	ARCHITECT(URE) (URAL)	LBL	LABEL
AUX	AUXILIARY	LF	LINEAR FOOT/FEET
AVG	AVERAGE	LH LHR	LEFT HAND LEFT HAND REVERSE
В		LL	LIVE LOAD
		LTWT	LIGHTWEIGHT
BFF	BELOW FINISHED FLOOR		2.0
BIT/BITUM	BITUMINOUS	M	
BLD	BOLLARD	MAS	MASONRY
BLDG BLK(G)	BUILDING BLOCKING	MAT	MATERIAL
BLW	BELOW	MAX	MAXIMUM
BM	BEAM / BENCHMARK	MCJ	MASONRY CONTROL JO
BR/BRK	BRICK	MECH	MECHANICAL
BRD	BOARD	MTL	METAL
BTM	BOTTOM	MFR	MANUFACTURER
BTW	BETWEEN BUILT-UP ROOF	MIN MISC	MINIMUM MISCELLANEOUS
BUR	BOILT-OF NOOI	MLDG	MOULDING
С		MO	MASONRY OPENING
CAB	 CABINET	MODF	MODIFIED
CB	CATCH BASIN/COVE BASE	MR	MOISTURE RESISTANT
CEM	CEMENT	MTD	MOUNT(ED)
CER	CERAMIC	MTG	MOUNTING
CG	CORNER GUARD	MULL	MULLION
CJ	CONTROL JOINT	MW	MILLWORK
CL	CENTER LINE	<u>N</u>	
CLG	CEILING	N	NORTH
CLR CM	CLEAR CROWN MOULDING	N NA	NORTH NOT APPLICABLE
CMU	CONCRETE MASONRY UNIT	NIC	NOT APPLICABLE
COL	COLUMN	NO	NUMBER
CONC	CONCRETE	NOM	NOMINAL
CONN	CONNECT(ION)	NRC	NOISE REDUCTION
CONT	CONTINUOUS		COEFFICIENT
CONTR	CONTRACTOR	NTS	NOT TO SCALE
CONST CPT	CONSTRUCTION CARPET	0	
CR	CHAIR RAIL	0.4	OVERALL
CT	CERAMIC TILE	OA OC	OVERALL ON CENTER
D	<u> </u>	OD	OUTSIDE DIAMETER
<u> </u>	<del></del>	OH	OVERHEAD
DEMO	DEMOLITION	OPP HAND	OPPOSITE HAND
DEPT	DEPARTMENT	OPNG	OPENING
DTL	DETAIL	OPP	OPPOSITE
DF	DRINKING FOUNTAIN	<u>P</u>	
DIA	DIAMETER		
DIM	DIMENSION	PL	PROPERTY LINE
DISP DISTR	DISPENSER DISTRIBUTION	PLAM	PLASTIC LAMINATE
DIV	DIVISION	PLAS PLYWD	PLASTIC PLYWOOD
DN	DOWN	PNL	PANEL
DS	DOWNSPOUT	PNT	PAINT
DIMO	DD444040		

PVC **EXPANSION JOINT** REF ELECTRIC WATER COOLER REFL ELECTRIC WATER HEATER EXPOSED/EXPANSION FIRE EXTINGUISHER FIRE EXTINGUISHER CABINET FINISHED FLOOR SECT FINISHED OPENING FIREPROOF(ING) STD STR GENERAL CONTRACTOR SYM GYPSUM WALLBOARD

DRAWING

**ELEVATION** 

**EMERGENCY** 

**ENCLOSURE** 

**EQUIPMENT** 

EXTERIOR

FIRE ALARM

FILE CABINET

FLOOR DRAIN

FOUNDATION

FINISH(ED)

**FLUORESCENT** 

FLOOR SINK

GAGE/GAUGE

GALVANIZED

HARDWARE

HOLLOW METAL

**HOT WATER** 

AIR CONDITIONING

INCLUDE(D) (ING)

INFORMATION

JUNCTION BOX

**INSULATION** 

INTERIOR

INVERT

JOIST

JOINT

FEET/FOOT

FOOTING

FUTURE

FIXTURE

**FLOOR** 

FQUAL

**EMER** 

**ENCL** 

EXP

**EXTG** 

**FLUOR** 

GYP

HVAC

HDW/HDWE

EXT

DOUBLE

POUNDS PER SQUARE INCH POLYVINYLCHLORIDE QUARRY TILE QUANTITY RADIUS REFER(ENCE) REFLECTED REFRIGERATION REINF REINFORCE(D) (ING) REQD REQUIRED RESILIENT REVISION RIGHT HAND RIGHT HAND REVERSE **ROUGH OPENING** RATED **ROOF TOP UNIT** SOLID CORE SCHEDULE(D) SAW CUT JOINT SECTION SERVICE SQUARE FOOT/FEET SHEET SIMILAR SPECIFICATION STAINLESS STEEL SOUND TRANSMISSION CLASS STANDARD STOR STORAGE STRUCTURAL/STRUCTURE SUSP SUSPENDED SYMMETRICAL TELEPHONE TEMPERATURE **TOOLED JOINT** TOP OF JOIST TOP OF SLAB HEATING, VENTILATING AND UNDERCUT UNDERWRITER'S LABORATORY UNLESS OTHERWISE NOTED UTIL UTILITY INSIDE DIAMETER/DIMENSION VINYL COMPOSITION TILE **VERT** VERTICAL VEST VESTIBULE VERIFY IN FIELD VENT THROUGH ROOF WATER CLOSET WOOD WITHOUT WATERPROOF WELDED WIRE MESH

**ABBREVIATIONS** 

- ALL WORK SHALL CONFORM TO THE CURRENT EDITION OF THE FLORIDA BUILDING CODE, AND ALL OTHER GOVERNMENTAL OR REGULATORY - GENERAL CONTRACTOR AND ALL SUBCONTRACTORS TO VERIFY ALL

DIMENSIONS IN THE FIELD. ANY DISCREPANCIES SHALL BE REPORTED TO

THE ARCHITECT PRIOR TO PROCEEDING WITH THE WORK. DO NOT SCALE - THE CONTRACTORS SHALL BE RESPONSIBLE FOR FAMILIARIZING THEMSELVES WITH THE INTENT OF THE DRAWINGS. CONTRACTOR AGREES THAT HE SHALL BE HELD RESPONSIBLE FOR HAVING EXAMINED THE SITE. THE LOCATION OF ALL PROPOSED WORK AND FOR HAVING SATISFIED HIMSELF, AS TO THE CHARACTER AND THE NATURE OF THE EXISTING

CONDITIONS AND WORK TO BE PERFORMED; ALONG WITH THE LOCATION

OF EXISTING UTILITIES AND ANY OTHER OBSTRUCTIONS.

- IT SHALL BE THE RESPONSIBILITY OF ALL SUBCONTRACTORS TO HAVE EXAMINED AND REVIEWED THE COMPLETE SET OF WORKING DRAWINGS AND/OR SPECIFICATIONS TO PROVIDE ALL LABOR AND MATERIALS FOR THEIR RESPECTIVE AREA OF WORK, FOR THE COMPLETE AND FINISHED INSTALLATION IN COMPLIANCE WITH THE INTENT OF THE DRAWINGS AND/OR SPECIFICATIONS WHETHER IT IS INDICATED OR NOT. ALL WORK, WHETHER INDICATED OR NOT, SHALL BE IN COMPLIANCE WITH ALL BUILDING CODES AND ORDINANCES WHICH ARE APPLICABLE TO THE PROJECT.

- CONTRACTOR TO PROVIDE ALL BARRICADES, SCAFFOLDING, SIGNS, LIGHTING AND OTHER MEANS OF PROTECTION AS REQUIRED TO COMPLY WITH ALL STATE LAWS AND LOCAL ORDINANCES TO SAFEGUARD PROPERTY AND PERSONS. OBSTRUCTIONS SHALL BE PLACED SO AS NOT TO DIMINISH THE LIFE SAFETY REQUIREMENTS.

- ALL WORK SHALL BE PERFORMED BY QUALIFIED CONTRACTORS IN STRICT

ACCORDANCE WITH MANUFACTURERS SPECIFICATIONS AND RECOMMENDATIONS. - ALL MATERIAL AND EQUIPMENT SHALL BE NEW, STORED AND INSTALLED IN

A WORKMANLIKE MANNER STANDARD TO THE TRADE AND THE AMERICAN

SOCIETY OF TESTING MATERIALS. - THE DESIGN INFORMATION INDICATED ON THE PLANS ARE INDICATED TO BE A COMPLETE AND WORKABLE SYSTEM IN ACCORDANCE WITH ALL PRODUCT MANUFACTURER'S SPECIFICATIONS, EXISTING AND/OR PROPOSED BUILDING DESIGN, FIELD CONDITIONS, ETC. ALL MISCELLANEOUS MATERIALS, PARTS, DESIGN DIMENSIONS, WHETHER INDICATED ON THE

PLANS OR NOT, SHALL BE INCLUDED AS PART OF THIS DRAWING PACKAGE. - THE GENERAL CONTRACTOR OR SUBCONTRACTORS SHALL BE HELD RESPONSIBLE FOR THE REMOVAL AND THE PROPER DISPOSAL OF MATERIALS AND ITEMS REFERRED TO AS "DEBRIS" OR DETERMINED BY THE OWNER OR ARCHITECT TO BE REFUSED.

- THE GENERAL CONTRACTOR SHALL HAVE MADE ALL REQUIRED PROVISIONS FOR THE REMOVAL OF THE DEBRIS ON SITE.

- GENERAL CONTRACTOR SHALL TAKE ORDINARY PRECAUTIONS TO SECURE AND PROTECT MATERIALS.

- ALL CONCEALED WOOD SHALL BE FIRE-RETARDENT TREATED. - ALL WOOD MEMBERS IN CONTACT WITH MASONRY SHALL BE PRESSURE

- ALL METAL USED FOR CONNECTING WOOD MEMBERS TO BE GALVANIZED

- THE ARCHITECT SHALL NOT BE RESPONSIBLE FOR ANY DEVIATION FROM

- SPECIFIC SECTIONS, DETAILS AND STANDARD DETAILS ARE INDICATED ON THE DWGS AT LOCATIONS WHERE THEY OCCUR, OR AT CHARACTERISTIC LOCATIONS. THEY APPLY, UON, TO OTHER LOCATIONS WHERE IMPLIED BY SIMILARITY OF CONSTRUCTION.

- CONTRACTOR TO COORDINATE SPACE REQUIREMENTS AND INSTALLATION OF MECHANICAL AND ELECTRICAL WORK WHICH ARE INDICATED DIAGRAMMATICALLY ON THE DRAWINGS. FOLLOW ROUTING SHOWN FOR PIPES, DUCTS, AND CONDUIT AS CLOSELY AS PRACTICABLE. PLACE RUNS PARALLEL WITH LINE OF BLDG. UTILIZE SPACES EFFICIENTLY TO MAXIMIZE ACCESSIBILITY FOR OTHER INSTALLATIONS AND FOR MAINTENANCE AND

- IN FINISHED AREAS, UON, CONCEAL PIPES, DUCTS, AND WIRING WITHIN THE CONSTRUCTION. COORDINATE LOCATIONS OF FIXTURES AND OUTLETS

- TRANSPORT AND HANDLE PRODUCTS IN ACCORDANCE W/ MFR

- PROMPTLY INSPECT SHIPMENTS TO ASSURE THAT PRODUCTS COMPLY W/ REQUIREMENTS, QUANTITIES ARE CORRECT, AND PRODUCTS ARE

- SHOULD MFR INSTRUCTIONS CONFLICT W/ THE DWGS, REQUEST CLARIFICATION FROM ARCHITECT/ENGINEER BEFORE PROCEEDING.

- ALL THRESHOLDS SHALL COMPLY WITH FLORIDA ACCESSIBILITY CODE, A. THRESHOLDS NOT TO EXCEED 3/4 INCH FOR EXTERIOR SLIDING DOORS.

C. RAISED THRESHOLDS AND FLOOR LEVEL CHANGES AT ACCESSIBLE

DOORWAYS SHALL BE BEVELED WITH A SLOPE NO GREATER THAN 1:2. - G.C. SHALL FURNISH AND INSTALL CONT. FIRE RETARDANT TREATED WOOD BLOCK'G IN STUD PARTITIONS FOR ANCHORAGE OF WALL ATTACHED ITEMS, INCLUDING BUT NOT LIMITED TO THE FOLLOWING: GRAB BARS, TOILET


FIXTURES, WALL-MOUNTED DOOR STOPS,... - THE OWNER VENDORS SHALL BE RESPONSIBLE FOR PROVIDING THE CONTRACTOR W/ ROUGH-IN INFO. NECESSARY TO ACCOMMODATE THE

ACCESSORIES, HANDRAIL BRACKETS, WALL CABINETS, WALL-MOUNTED

INSTALLATIONS OF OWNER FURNISHED AND INSTALLED ITEMS. - THE CONTRACTOR SHALL INCLUDE ALL OWNER VENDOR FURNISHED AND INSTALLED ITEMS IN THE CONSTRUCTION SCHEDULE, AND SHALL

**GENERAL NOTES** 

COORDINATE W/ THE OWNER'S VENDOR TO ACCOMMODATE THESE ITEMS.

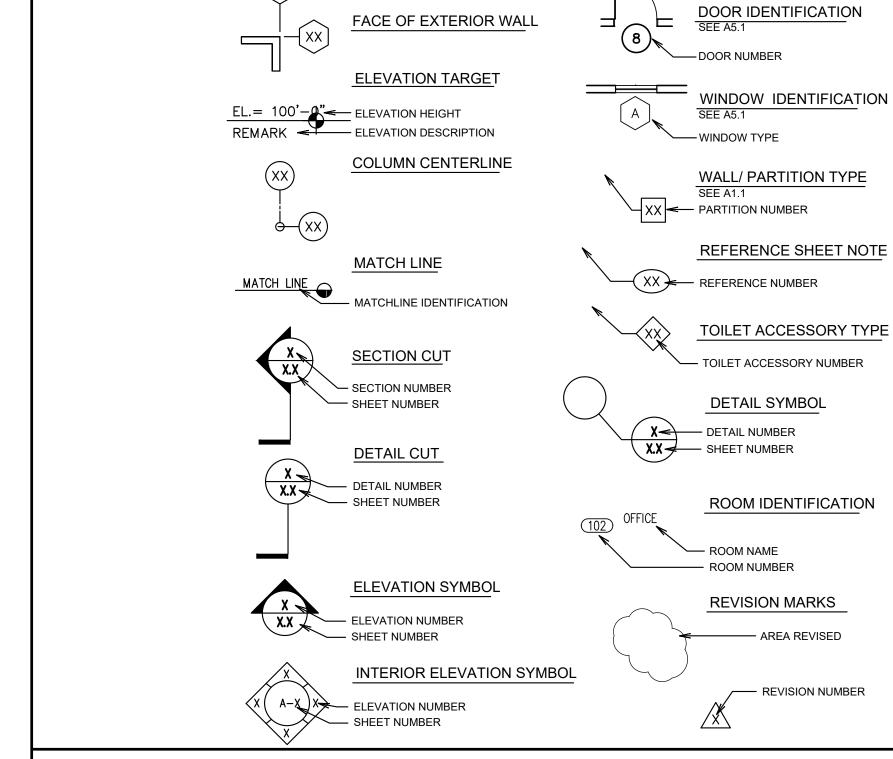


## SYMBOLS

FLORIDA PRODUCT APPROVAL CODES						
APP/SEQ#	MANUFACTURER	DESCRIPTION	APPROVAL STATUS	DESIGN PRESSURE	ATTACHMENT	
FL 21829.4	RUSKIN LOUVER	IMPACT RATED LOUVER	APPROVED	+120/-120 PSF	HILTI- 1/4" -#14 x1" LG. HWH 12" O.C. & 3" ROM EDGE	
FL40569.1	GAF	TPO ROOFING	APPROVED	+0/-297.5 PSF	ATTACHED IN-LAP 6-INCH O.C. W/ HD FASTENERS & PLATES; FASTENERS ROWS 114-INCH O.C.	
FL 8394.2	CURRIES	FLUSH HM DOORS & HM DOORS W/ LOUVERS & GLAZED	APPROVED	+/-50 PSF	3/8"Ø FLATHEAD EXPANSION ANCHOR BOLT @ 22" O.C. MAX.	
FL14287.	KAWNEER	STOREFRONT (TRI-FAB451 - IMPACT))	APPROVED	+/- 65 PSF	1/4"-20 SELF DRILL/TAPPING SCREW - FULL EMBED -MIN. GRADE 5 CORROSION RESISTANT STEEL	
FL8786.1	KAWNEER	EXTERIOR DOORS (TRI-FAB350IR)	APPROVED	+/- 65 PSF	1/4"HILTI KWIK CON II - 1 1/4"MIN. EMBED @ 12" O.C. & 2 1/2" MIN. EDGE DISTANCE	
FL5388.2	KAWNEER	CURTAIN WALL (1600 SYSTEM - IMPACT)	APPROVED	+/-60 PSF	3/8"Ø SIMPSON STRONG TIE TITAN HD SCREW (GALVANIZED)	
FL17819.1	KAWNEER	AUTO SHOWROOM OUTSWING BI-FOLD DOOR (TRI-FAB-350IR)	APPROVED	+/-70 PSF	1/4"HILTI KWIK CON II - 1 1/4"MIN. EMBED @ 13" 1/2" O.C. MAX. & 2 1/2" MIN. EDGE DISTANCE	
FL16113.1	OVERHEAD DOOR COMPANY	INSULATED COILING OVERHEAD DRS (MODEL 625)	APPROVED	+68.9/-68.9 PSF	3/4"Ø HILTI KWIK BOLT III EXPANSION ANCHORS @ 11" O.C. MIN. - MIN. 4 3/4" EMBED	
FL17629.1	OVERHEAD DOOR COMPANY	SECTIONAL OVERHEAD DRS (MODEL 521)	APPROVED	+48/- 54 PSF	3/8"Ø SIMPSON TITEN HD SCREW ANCHORS @ 24" O.C. MIN.ALONG JAMB - MIN. 2 3/4" EMBED	
FL28502.1	RYTEC CORPORATION	HIGH - SPEED SECTIONAL OVERHEAD DRS	APPROVED	+/- 50 PSF	1/2"Ø x4 1/2" L. HILTI KWIK BOLT III EXPANSION ANCHORS - MIN. 2 1/4" EMBED	
FL17187.1	ALPOLIC	ACM WALL PANELS	APPROVED	+66.5/- 66.5 PSF	#12-14 x 2" TEK FASTENER - 8" O.C.	

## PRODUCT APPROVAL

VICINITY MAP<sub>N.T.S.</sub>

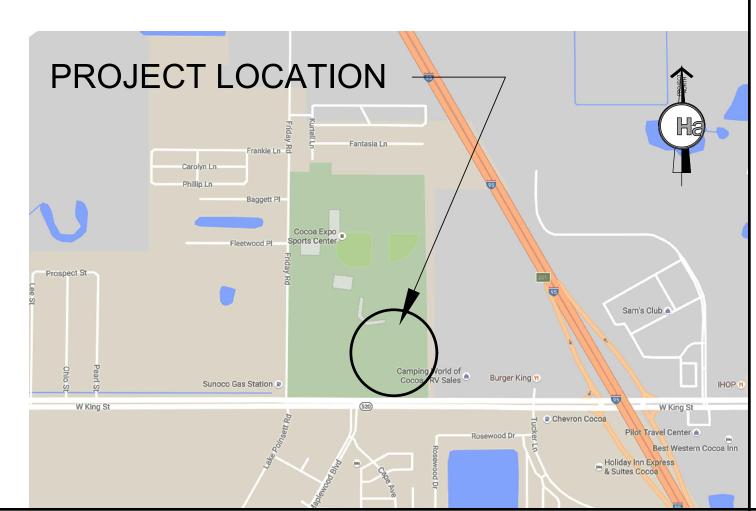

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CIVIL HAS BEEN PREVIOUSLY APPROVED BY CITY OF COCOA
- CITY MINOR SITE PLAN AMENDMENT # PZ-23-00200004

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ENLARGED RESTROOM PLAN

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22026 Drawn By RCK/RLH Checked By

Issue Date 02.09.24

PROJECT DIRECTORY SHEET INDEX 0

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Sheet Title Revisions

State Registration Richard Hartmann AIA. LEED AP

AR 09622




using a Digital Signature and date. Printed copies of this document are not considered signed and sealed and the signature must be verified on any electronic copies. o the best of the knowledge of the architects & engineers, said pla and specifications comply with the applicable building codes and minimum fire safety standards

Project Number

Sheet Number

A001

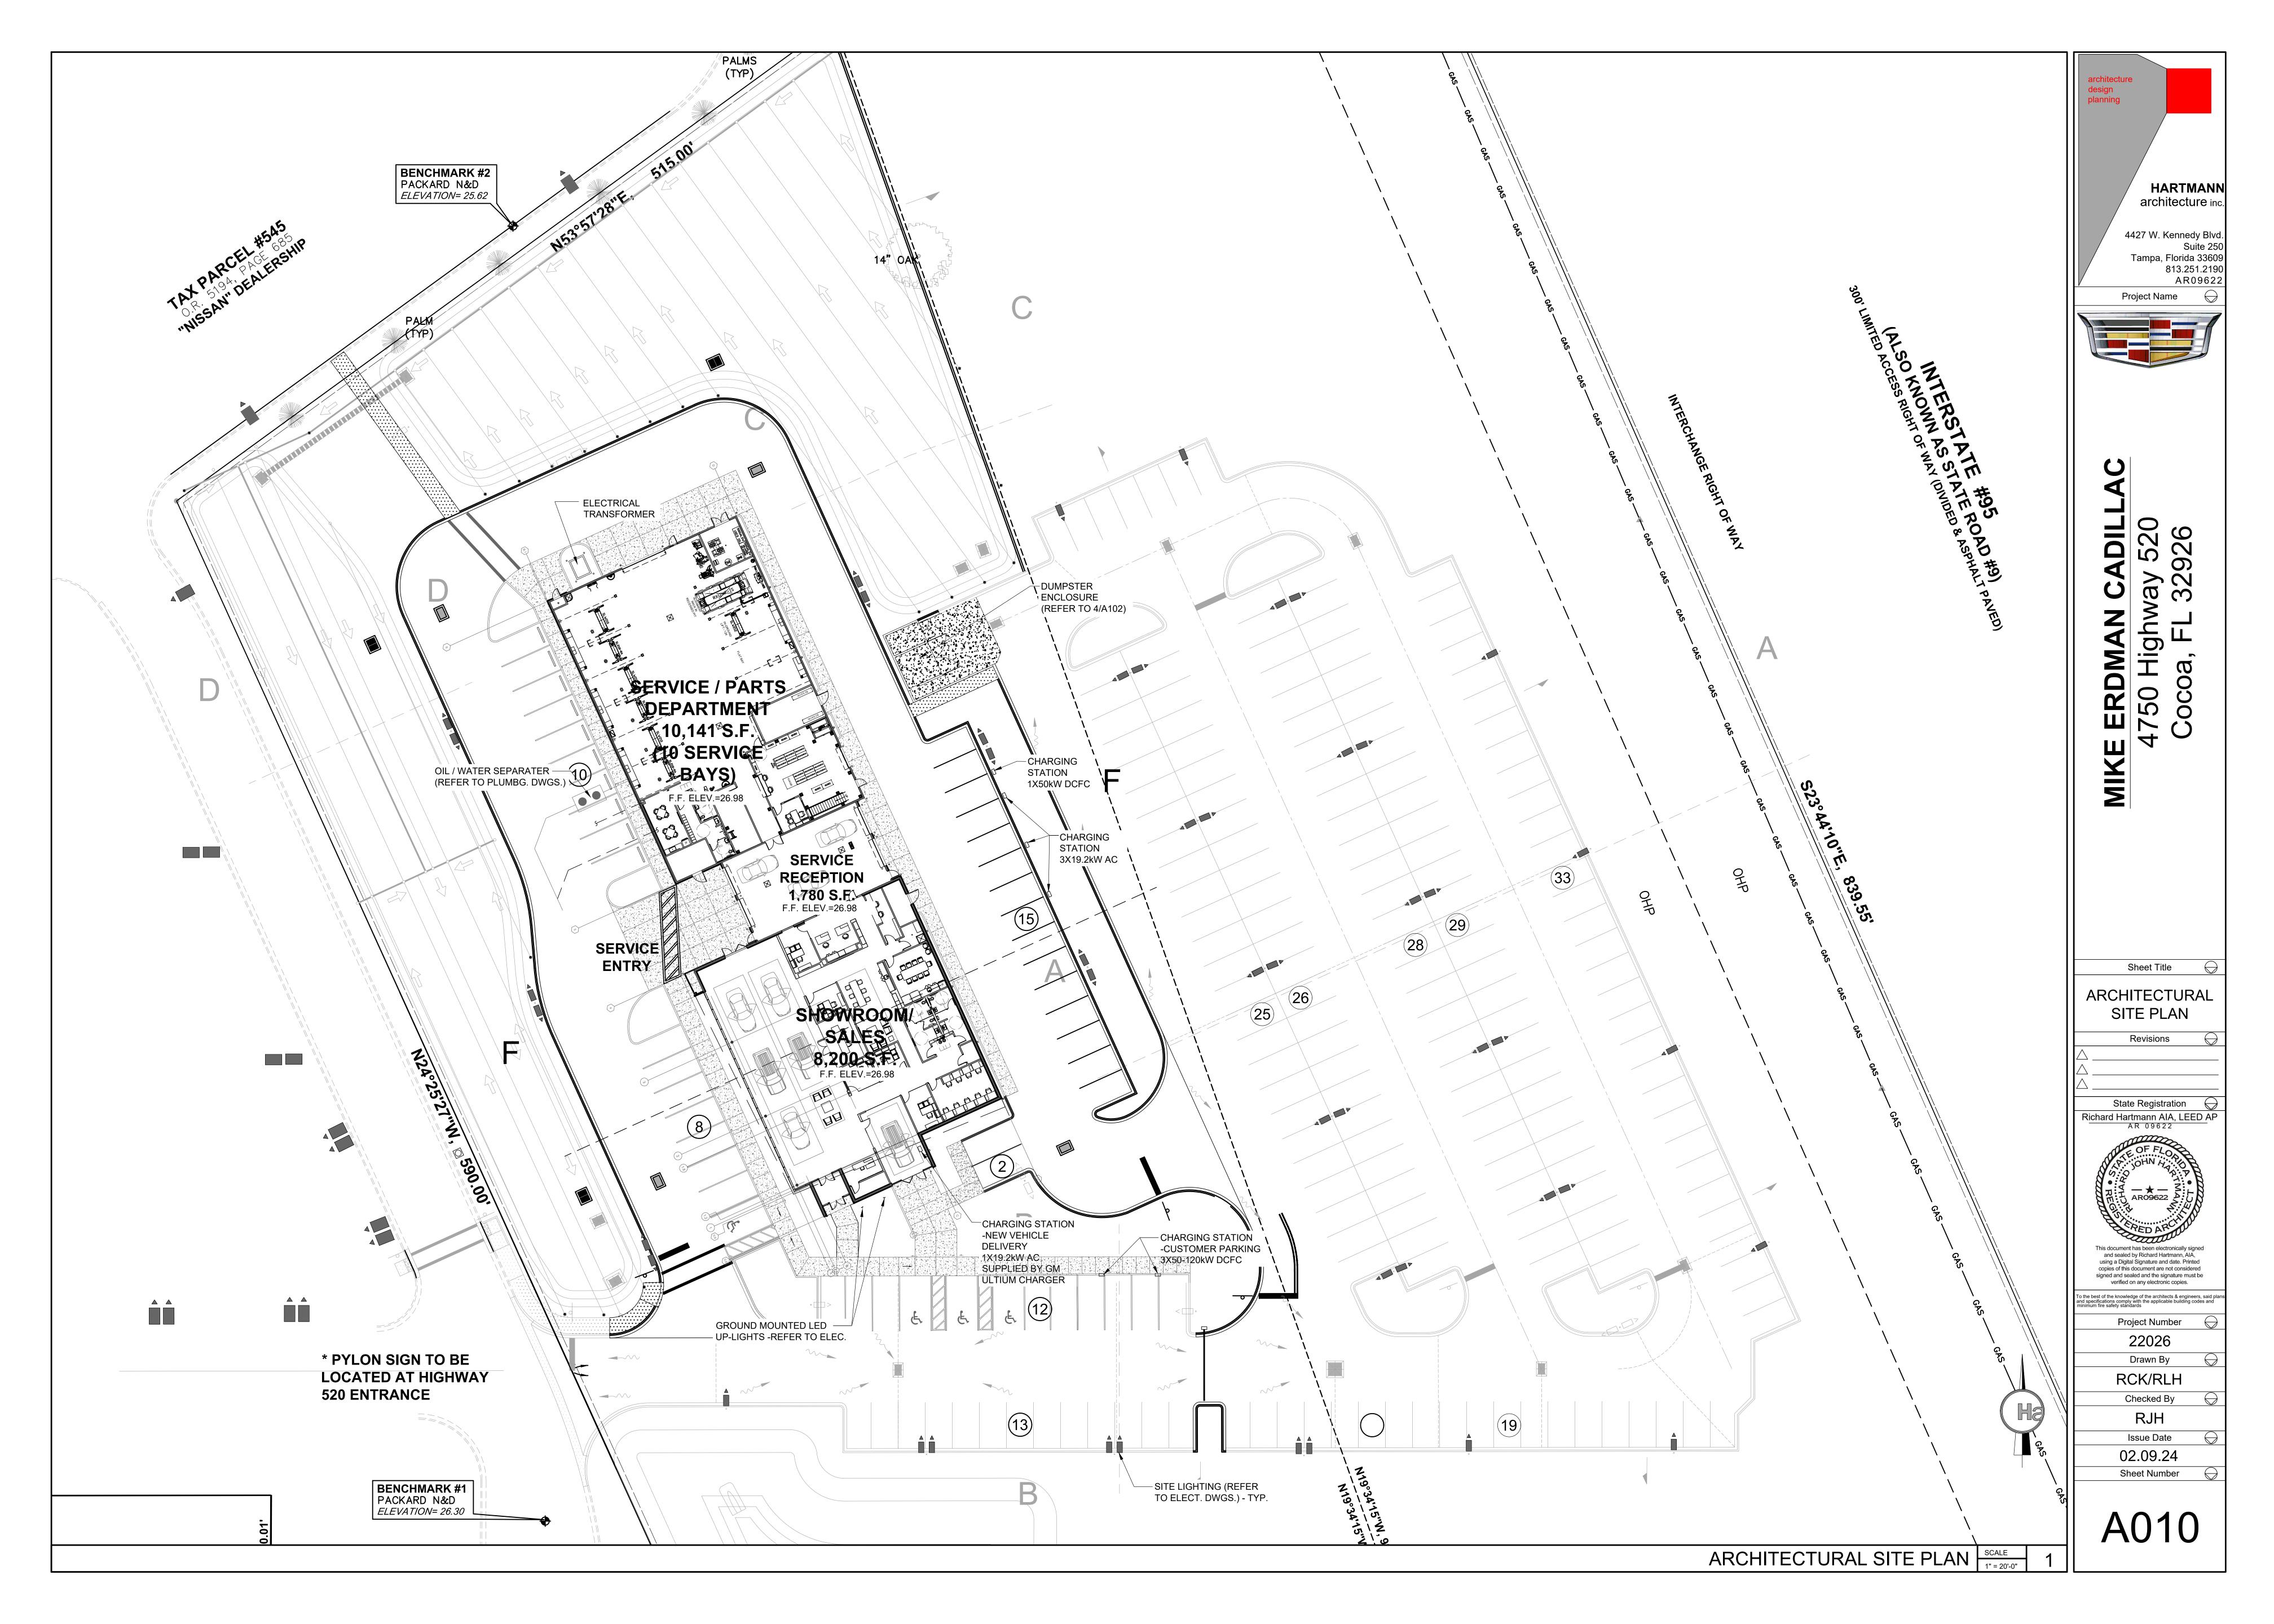

### **APPLICABLE CODES** APPLICABLE CODES: ALL WORK UNDER THIS CONTRACT SHALL COMPLY WITH THE SHOULD INCONSISTENCIES OR DISCREPANCIES OCCUR 1. PROVISIONS OF THE SPECIFICATIONS & DRAWINGS AND SHALL SATISFY ALL APPLICABLE WITHIN THE DRAWINGS OR SPECIFICATIONS, THE BETTER CODES, ORDINANCES, AND REGULATIONS OF ALL GOVERNING BODIES INVOLVED. ANY QUALITY, GREATER QUANTITY AND MOST EXPENSIVE MODIFICATIONS TO THE CONTRACT WORK REQUIRED BY SUCH AUTHORITIES SHALL BE AT PRODUCT OR TASK SHALL BE PERFORMED OR FURNISHED THE EXPENSE OF THE OWNER, SUBJECT TO THE RECEIPT OF AN AFFIDAVIT OR LETTER UNLESS INSTRUCTED OTHERWISE BY THE ARCHITECT. FROM THE GOVERNING BODY AND OWNER'S PRIOR APPROVAL OF ANY ADDITIONAL COST DISCREPANCIES BETWEEN SPECIFIED ITEMS OR TO BE INCURRED. ALL PERMITS AND LICENSES NECESSARY FOR THE PROPER EXECUTION INSTALLATION METHODS SHALL NOT BE CAUSE FOR OF THE WORK SHALL BE SECURED AND PAID FOR BY THE CONTRACTOR INVOLVED. MODIFICATION TO THE CONTRACT SUM OR CONTRACT TIME APPLICABLE CODES INCLUDE, BUT ARE NOT LIMITED TO THE FOLLOWING: BUILDING & STRUCTURAL: FLORIDA BUILDING CODE 8th EDITION (2023) FLORIDA EXISTING BUILDING CODE 8th EDITION (2023) ENERGY: FLORIDA ENERGY CONSERVATION 8th EDITION (2023) PLUMBING: FLORIDA PLUMBING CODE 8th EDITION (2023) TYPE II-B CONSTRUCTION MECHANICAL: FLORIDA MECHANICAL CODE 8th EDITION (2023) ALL INTERIOR FINISHES TO ELECTRICAL: NATIONAL ELECTRIC CODE 2020 BE CLASS B OR CLASS A FIRE CODE: FLORIDA FIRE PREVENTION 8th EDITION FLORIDA STATUTES FLORIDA ADMINISTRATIVE CODE ALL FLOORING FINISHES TO BE CLASS I **BUILDING DATA:** Occupancy: GROUP B - BUSINESS GROUP S-1 - SERVICE BAYS GROUP S-2 - PARTS DEPARTMENT \* REQUIRED FIRE EXTINGUISHER LOCATION WILL BE COORDINATED BY CONSTRUCTION SUPERINTENDANT WITH FIRE MARSHAL'S OFFICE Mixed Occupancy? TO ENSURE PROPER LOCATION AND PLACEMENT OF ALL REQUIRED FIRE EXTINGUISHERS PRIOR TO C.O. INSPECTION. Construction Type: Sprinkled? Protected? Fire Alarm? Fire District? Mezzanine: High Rise? **Building Height** LIFE SAFETY SYSTEM: Emergency Lighting and Exit Signs Fire Alarm and Smoke Detection Systems Panic Hardware Automatic Fire Protection System (sprinkled) Yes Voice Evacuation System Corridor Fire Resistance = 0 HR per FBC Table 1020.2 Means of Egress Allowable Square Footage/Height per floor Type IIB Table 507 Allowable Maximum Travel Distance (Fully Sprinklered): Building area shall be unlimited and no more than two stories above grade plane (per FBC 2023 table 1017.2) where the building is equipped throughout with an automatic sprinkler system per Business 200 Feet FBC 507.4 200 Feet 300 Feet <u>Total</u> 8,200 Allowable Maximum Dead End Corridor Length: 20 Feet (50 feet in Business & Storage Occupancy per 7,814 7,814 FBC 2023 Section 1020.5 exception 2) 2,327 940 1,387 Total Enclosed Space: 18,341 sq. ft. Maximum Common Path of Travel: 100 Feet (per FBC 2023 Section 1006.3.3(2)) Covered Service Reception 1,780 sq. ft. 20,121 sq. ft. Total Under Roof: Minimum Corridor Width = 44" 20,121 sq. ft. Total Building Square Footage: = Required Corridor Fire Resistance Rating = 0 (per FBC 2023 Table 1020.2) **Total Occupancy:** Egress Width per Occupant served = 0.2" (Table 1005.1) 8,200 sq. ft. at 1/150 sq. ft. = 55 people S-1 Service Bays 7,814 sq. ft. at 1/300 sq. ft. = 27 people Egress Credit for 36" door = 32" S-2 Parts 2,327 sq. ft. at 1/300 sq. ft. = 8 people Egress Credit for each stair case = 44" 90 people Required Unit Width per person = 0.2" for doors / 0.3" for stairs (per FBC 2023 Section 1005.3.2) First Floor Doors Other Pertinent Information / Notes: Note: 32" used below is credit allowed for a 36" door. All doors are 36" wide, minimum. 1] Eyewash stations are to be provided within the Service Bay Area so that travel distance to eyewash is less **Business Occupancy** than 100 feet. (Per OSHA) 8,200 sq. ft. at 1/150 sq. ft. = 55 people 2] See Fire Protection Drawings for sprinkler information. Egress width required: 55 x 0.2 = 11.0" 3] See Reflected Ceiling Plans and electrical drawings for exit light and Egress width provided: 128" emergency light information / locations. 4] See Mechanical Drawings for ventilation requirements. S-2 Parts Occupancy 5] Fire Extinguisher size, type, location and mounting height to be as 2,327 sq. ft. at 1/300 sq. ft. = 8 people approved by Fire Marshal and/or Fire Prevention Official. Egress width required: 8 x 0.2 = 1.6" 6] The Oil /Compressor Room will contain Class IIIB Combustible liquid (as Egress width provided: 32" defined in NFPA 30 Section 1.7.3.1) in double walled steel tanks. FBC Table 307.1 (1) does not require a Fire Separation for this S-1 Service Bay Occupancy Incidental Use. NFPA 30 3.3.37.1 requires 1 hour wall 7,814 sq. ft. at 1/300 sq. ft. = 27 people separation. See Drawing A023 for further analysis. Egress width required: 27 x 0.2 = 5.4" 7] Fire Extinguishers are to be provided in all electrical rooms. Egress width provided: 32" 8] Maximum Travel Distance to a Fire Extinguisher to be 75'-0" 9] See Drawing A023 for further storage analysis. TOILET FIXTURES REQUIRED per FBC PLUMBING TABLE 403.1 DRINKING SERVICE SHOWERS FOUNTAINS SINKS LAVS REQUIRED: 1 per 25\*=2 1 per 40\*\*=1 1 per 25\*=2 1 per 40\*\*=1 1 per 100 PROVIDED: 2 1 (Hi-Lo) 1 per 100=1 GROUP S REQUIRED: 1 per 100=1 1 per 100=1 Per FPC 411 1 per 1,000 -OCCUPANTS:

1 (Hi-Lo)

(Eye Wash / Drench)

IN ADDITION TO FIXTURES ABOVE, THERE WILL ALSO BE (2) FLOOR MOUNTED (ADA) HAND WASH FOUNTAIN IN THE SERVICE DEPARTMENT


PROVIDED: 1

SEE STRUCTURAL

PARKING SPACES:

\* 1 per 25 FOR THE FIRST 50, AND 1 per 50 FOR THE REMAINING 50.

DESIGN LOADS / COMPONENTS AND CLADDING:

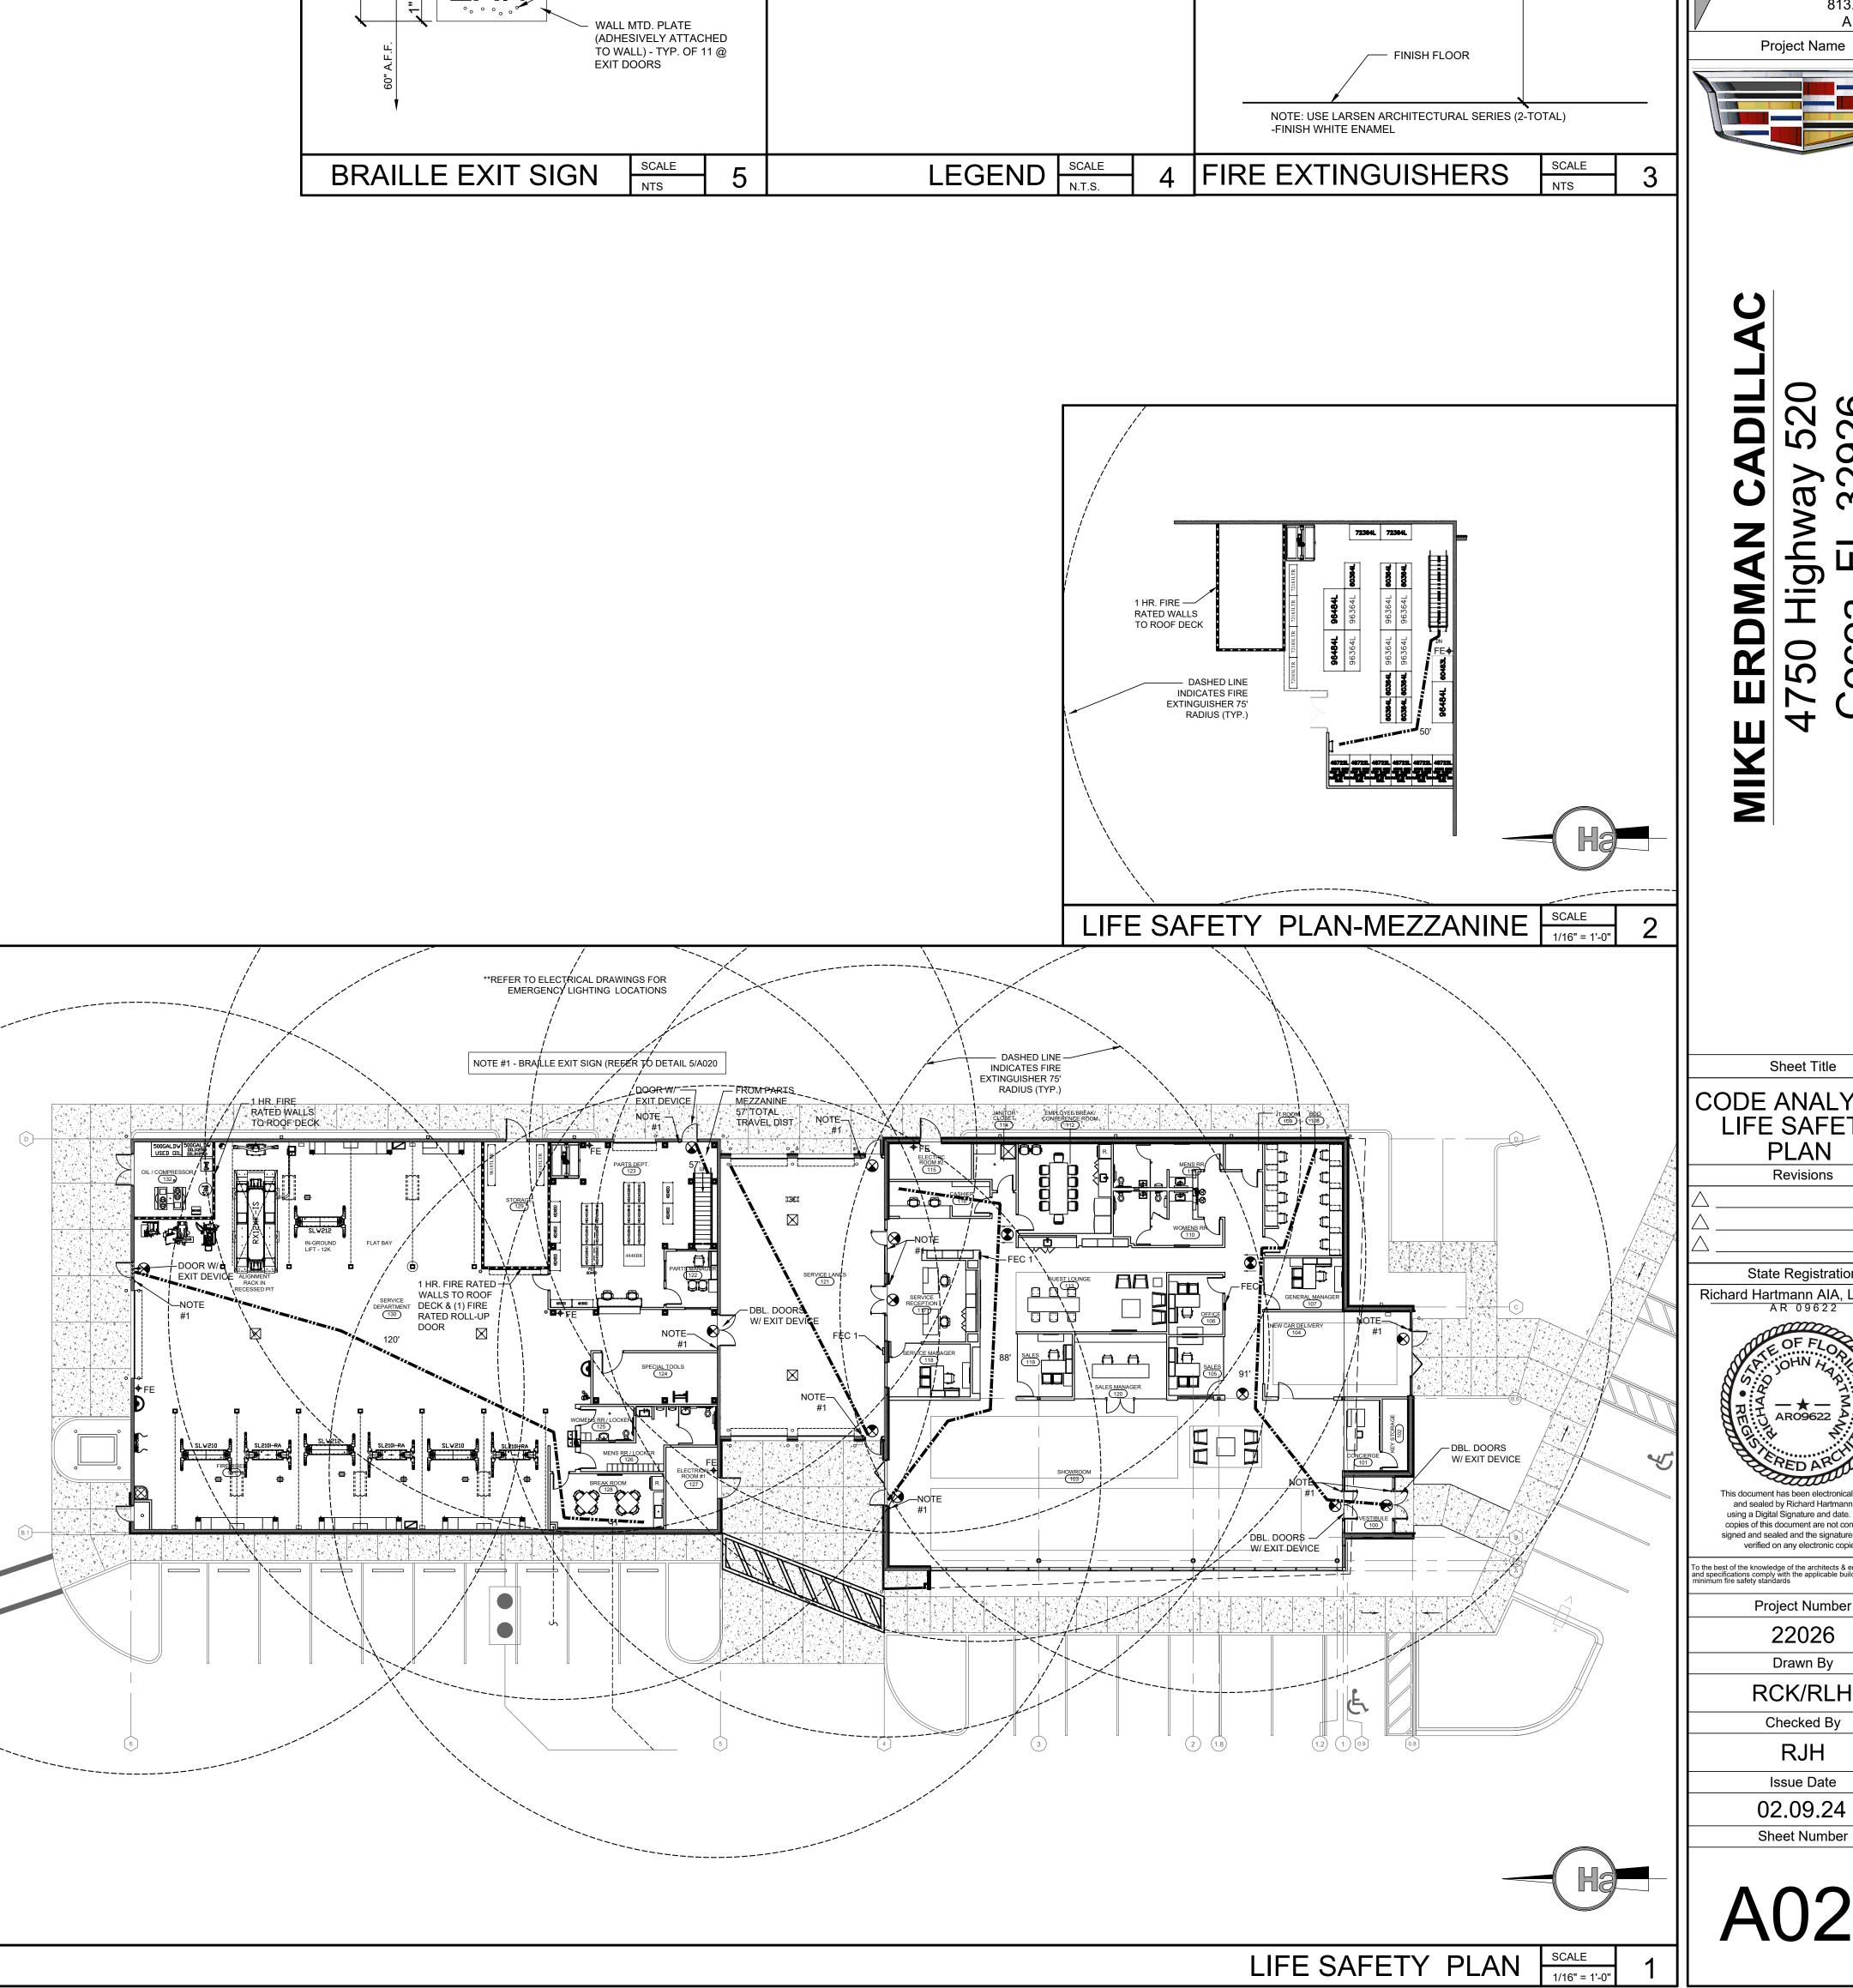

FIRE EXTINGUISHER IN SEMI-RECESSED CABINET -

2409-R4 W/ VERTICAL DUO CLEAR ACRYLIC DOOR


WITH LARSON LOCK

✓ 1" LETTERS

BRAILLE 'EXIT' TEXT

TYPE 4A-60B:C - LARSEN ARCHITECTURAL SERIES/

FIRE EXTINGUISHER WALL MOUNTED - TYPE 4A-60B:C

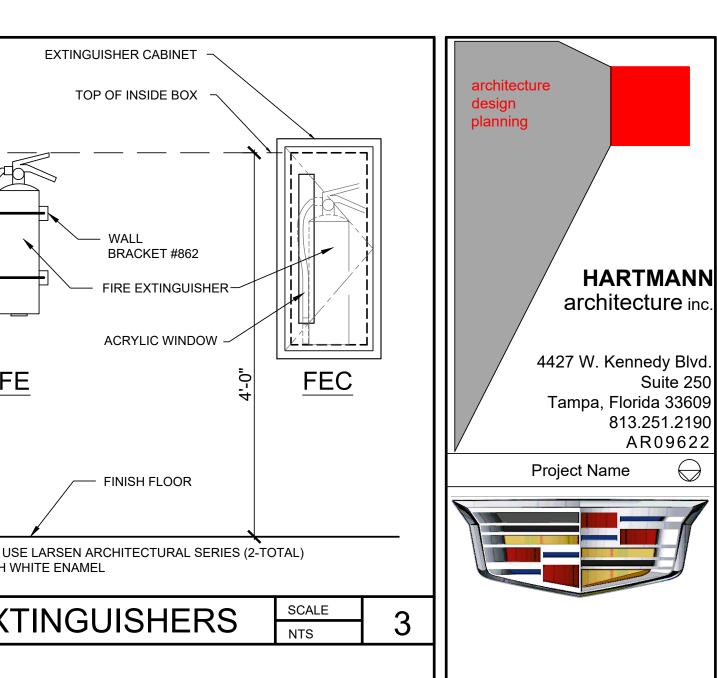

Tampa, Florida 33609 813.251.2190 AR09622 Project Name

50

Sheet Title CODE ANALYSIS-LIFE SAFETY **PLAN** Revisions

State Registration Richard Hartmann AIA, LEED AP

This document has been electronically signed and sealed by Richard Hartmann, AIA, using a Digital Signature and date. Printed copies of this document are not considered signed and sealed and the signature must be verified on any electronic copies.

on the best of the knowledge of the architects & engineers, said planged specifications comply with the applicable building codes and mainimum fire safety standards Project Number

22026 Drawn By RCK/RLH

Checked By

Issue Date 02.09.24

1.1 CONTRACT RESPONSIBILITIES

- A. THE TERMS GENERAL CONTRACTOR, G.C. AND CONTRACTOR SHALL BE
- INTERCHANGEABLE. 1.2 FIELD CONDITIONS
- A. THE GENERAL CONTRACTOR IS TO VERIFY ALL DIMENSIONS AND FIELD CONDITIONS IN COMPLIANCE WITH OVERALL WALL DIMENSIONS. THE G.C. SHALL NOTIFY THE ARCHITECT IN WRITTEN FORM OF ANY VARIANCES PRIOR TO COMMENCING WORK. FAILURE TO REPORT DISCREPANCIES SHALL MAKE ANY COSTS INCURRED ARISING FROM THESE CONDITIONS THE SOLE RESPONSIBILITY OF THE
- B. THE G.C. SHALL VERIFY SIZE AND LOCATION OF ALL FLOOR, ROOF AND WALL PENETRATIONS, EQUIPMENT ETC. AND COORDINATE WITH MECHANICAL AND ELECTRICAL ENGINEER. SEE THE LIFE SAFETY PLAN FOR LOCATIONS OF FIRE RATED PARTITIONS AND SECURE PENETRATIONS TO THE SATISFACTION OF THE FIRE MARSHAL
- C. PRIOR TO EXCAVATION OR TRENCHING THE G.C. SHALL DETERMINE AND VERIFY LOCATION OF UTILITY SERVICES IN ALL AREAS TO BE EXCAVATED.
- D. THE G.C. SHALL COORDINATE ALL MILLWORK INSTALLATION WITH ELECTRICAL WORK AS REQUIRED. 1.3 FIELD REVISIONS
- A. ANY CHANGES IN PLAN ARRANGEMENT OR DETAILING AND SPECIFIC INSTRUCTIONS FOR THE PROJECT WITHOUT THE PRIOR WRITTEN NOTIFICATION AND APPROVAL OF THE ARCHITECT WILL VOID ANY OBLIGATIONS AND LIABILITIES SET FORTH BY THE OWNER AND THE ARCHITECT.
- B. IF ANY SUBSTITUTIONS ARE PROPOSED AND APPROVED FOR SPECIFIC EQUIPMENT, THE G.C. AND HIS SUBCONTRACTORS SHALL BE RESPONSIBLE FOR ALL COORDINATION INCLUDING HVAC, PLUMBING AND ELECTRICAL.

## 1.4 PERMITTING / CODE COMPLIANCE

- A. THE G.C. SHALL APPLY FOR ALL PERMITS WHICH INVOLVE DRAWING SUBMITTAL AND PROCESSING (I.E. BUILDING, ELECTRICAL, MECHANICAL, PLUMBING, FIRE AND HEALTH PERMITS) THE G.C.. SHALL OBTAIN THESE PERMITS AND PAY ALL PERMITTING FEES.
- B. THE G.C. SHALL ASSURE THAT ALL WORK IS DONE IN ACCORDANCE WITH ALL APPLICABLE NATIONAL. STATE AND LOCAL CODES, ORDINANCES AND REQUIREMENTS BY GOVERNING AGENCIES, WHETHER OR NOT SAID CODES, ORDINANCES, REQUIREMENTS, ETC. ARE SPECIFICALLY SHOWN ON THE
- DRAWINGS AND OR SPECIFICATIONS. C. CONSTRUCTION MATERIAL, ASSEMBLIES AND PROCEDURES ARE TO COMPLY WITH ALL APPLICABLE CODES AND SUPPLEMENTARY ORDINANCES. WHEN A CONFLICT OCCURS BETWEEN SUCH CODES AND INFORMATION SHOWN ON THE DRAWINGS, THE G.C. SHALL CONSULT WITH THE OWNER'S REPRESENTATIVE OR ARCHITECT FOR RESOLUTION PRIOR TO COMMENCING WORK.
- CONSTRUCTION SHALL COMPLY WITH ALL APPLICABLE ACCESSIBILITY GUIDELINES (I.E. ADA) FOR BUILDINGS AND FACILITIES PER THE CURRENT FEDERAL REGISTER, INCLUDING MOUNTING HEIGHTS, CLEARANCES, ACCESSORIES, ETC.
- D. THE G.C. SHALL BE RESPONSIBLE FOR SCHEDULING INSPECTIONS BY CODE OFFICIALS AND SHALL PAY INSPECTION FEES ASSOCIATED WITH THE WORK.
- E. PRIOR TO ISSUANCE OF THE BUILDING PERMIT, THE G.C. SHALL HAVE EVIDENCE OF CURRENT WORKER'S COMPENSATION INSURANCE COVERAGE ON FILE WITH THE DEPARTMENT IN COMPLIANCE WITH THE LOCAL LABOR CODE.
- F. AFTER OBTAINING THE BUILDING PERMIT AND BEFORE COMMENCING WITH THE WORK, THE G.C. SHALL SHOW EVIDENCE OF ALL INSURANCE REQUIREMENTS AS REQUIRED BY THE OWNER.

## 1.5 G.C. / OWNER COORDINATION

A. THE G.C. IS TO BECOME FAMILIAR WITH THE OWNER / DESIGN CRITERIA, SPECIAL WORKING CONDITIONS PERTAINING TO BARRICADES, NOISE, DUST, TRASH REMOVAL, ETC. AND SHALL COORDINATE WITH THE OWNER, ANY WORK WHICH IS REQUIRED TO TAKE PLACE AT NIGHT OR DURING OFF HOURS SHALL BE VERIFIED WITH THE THE OWNER'S REPRESENTATIVES. ANY ASSOCIATED COSTS SHALL BE INCLUDED IN THE BID. IN ADDITION, THE G.C. SHALL PROVIDE ANY SAFETY OR WARNING DEVICES REQUIRED TO PROTECT THE PUBLIC FROM ANY DAMAGE ARISING FROM THEIR WORK. SITE SECURITY IS THE RESPONSIBILITY OF THE G.C.

- A. A. PRODUCTS: MEANS NEW MATERIAL, MACHINERY, COMPONENTS, EQUIPMENT, FIXTURES, AND SYSTEMS FORMING THE WORK. DOES NOT INCLUDE MACHINERY AND EQUIPMENT USED FOR PREPARATION, FABRICATION, CONVEYING AND ERECTION OF THE WORK. PRODUCTS MAY ALSO INCLUDE EXISTING MATERIALS OR COMPONENTS REQUIRED FOR REUSE IF PRE-APPROVED OR SPECIFIED WITHIN THESE DOCUMENTS AS EXISTING TO BE REUSED OR RELOCATED.
- B. DO NOT USE MATERIALS AND EQUIPMENT REMOVED FROM EXISTING PREMISES, EXCEPT AS SPECIFICALLY PERMITTED BY THE CONTRACT DOCUMENTS.
- C. PROVIDE INTERCHANGEABLE COMPONENTS OF THE SAME MANUFACTURER, FOR SIMILAR COMPONENTS.
- ALL MATERIAL SPECIFIED IS TO BE INSTALLED IN ACCORDANCE WITH MANUFACTURERS INSTRUCTIONS AND SPECIFICATIONS. THE G.C. IS TO CONSTRUCT THE PROJECT IN ACCORDANCE WITH THE DOCUMENTS. ANY DEVIATIONS FROM THE INTENT OF THE DOCUMENTS WITHOUT THE ARCHITECTS WRITTEN APPROVAL IS AT THE CONTRACTOR'S OWN RISK AND MAY RESULT IN THE WORK BEING REDONE AT THE CONTRACTOR'S EXPENSE.
- E. IN THE EVENT THAT THE QUALITY OR GRADE OF MATERIAL OR WORK IS NOT CLEARLY SPECIFIED, THE G.C. SHALL REQUEST CLARIFICATION FROM THE ARCHITECT. UNDER NO CIRCUMSTANCES SHALL THE CONTRACTOR ASSUME GRADE OR QUALITY.
- F. IN THE EVENT A DISCREPANCY OCCURS FROM ONE DRAWING TO ANOTHER OR THE SPECIFICATIONS, THE BETTER QUALITY, LARGER QUANTITY OR HIGHER QUALITY SHALL PREVAIL.

## 1.7 MATERIAL HANDLING

- A. THE G.C. SHALL BE RESPONSIBLE FOR RECEIVING ALL OWNER SUPPLIED MATERIALS AND SUPPLYING THE MANPOWER AS REQUIRED TO OFF LOAD SHIPMENTS. WITHIN FIVE WORKING DAYS AFTER AWARD OF CONTRACT, THE G.C. SHALL PROVIDE THE OWNER WITH A PROPOSED PROJECT SCHEDULE INDICATING REQUESTED DATES OF DELIVERY OF OWNER FURNISHED MATERIALS.
- B. THE G.C. SHALL CONFIRM THE RECEIPT OF ALL MATERIALS AND VERIFY QUANTITIES WITH THE SHIPPING MANIFEST OR BILL OF LADING. THE G.C. SHALL NOTIFY THE OWNER WITHIN 24 HOURS AFTER RECEIPT OF ANY MATERIALS MISSING FROM SHIPMENTS OR MATERIALS DAMAGED DURING SHIPPING. FAILURE TO DO SO WILL RESULT IN THE G.C. PAYING FOR OVERNIGHT FREIGHT (IF REQUIRED) FOR JOB COMPLETION.
- C. THE G.C. IS RESPONSIBLE FOR FILING FREIGHT CLAIMS DIRECTLY WITH THE CARRIER AND FOLLOWING THROUGH AS NECESSARY WITH ALL SUBSEQUENT PROCEDURES, INCLUDING INSPECTIONS AND REMOVAL OF DAMAGED MATERIALS. THIS APPLIES TO VISIBLE AND CONCEALED DAMAGES OF ALL OWNER SUPPLIED MATERIALS. FAILURE TO DO SO WILL RESULT IN BACK CHARGE EXPENSES TO
- D. THE G.C. SHALL BE RESPONSIBLE FOR PROTECTING ALL OWNER SUPPLIED MATERIALS THROUGHOUT THE WORK AND IS TO MAKE TOUCH UP REPAIRS AS REQUIRED.

## 2.1 GENERAL CONSTRUCTION

- A. WITHIN TEN DAYS OF THE AWARD OF THE CONTRACT, THE GENERAL CONTRACTOR SHALL PROVIDE THE OWNER WITH A PROPOSED PROJECT SCHEDULE (BAR GRAPH FORMAT) INDICATING THE START AND COMPLETION DATES OF EACH STAGE OF THE WORK BY TRADE. AT THE SAME TIME THE CONTRACTOR SHALL ALSO SUBMIT TO THE ARCHITECT DOCUMENTATION INDICATING ORDERING AND DELIVERY DATES OF ALL MAJOR EQUIPMENT, MATERIALS AND FINISHES.
- B. THE G.C. IS TO HAVE THE SAME FULL TIME QUALIFIED SUPERVISOR ON THE SITE THROUGHOUT THE ENTIRE PROJECT SCHEDULE. OR, DIFFERENT SUPERVISOR'S MAY BE USED AT DIFFERENT PROJECT PHASES IF PRE-APPROVED BY OWNER. ALL SUPERVISORS MUST BE PRESENT AT THE PRE-CONSTRUCTION MEETING.
- C. EACH CONTRACTOR SHALL BE RESPONSIBLE FOR REPAIR OF DAMAGE TO THE WORK OF OTHER TRADES CAUSED BY HIS OPERATIONS. THE NATURE OF SUCH REPAIR WORK MUST RECEIVE THE PRIOR APPROVAL OF THE OWNER'S REPRESENTATIVE.

## 2.2 GENERAL CONTRACTOR'S RESPONSIBILITY

- A. THE PURPOSE OF THE ARCHITECTURAL PLANS IS TO DEFINE SCOPE OF WORK, GENERAL CHARACTER OF WORK AND MATERIALS. THE ARCHITECT HAS RETAINED STRUCTURAL, MECHANICAL, ELECTRICAL AND PLUMBING CONSULTANTS WHO HAVE PROVIDED DRAWINGS INCLUDED IN THIS SET. IT IS THE GENERAL CONTRACTOR'S RESPONSIBILITY TO CONCEIVE OF THE PROJECT IN THREE DIMENSION AND DEVISE MEANS AND METHODS OF CONSTRUCTION. THE GENERAL CONTRACTOR MUST SEEK OUT CONFLICTS AND DEVISE ALTERNATES TO ALLOW FOR CONSTRUCTION. THE ARCHITECT MUST APPROVE SUCH ALTERNATE PRIOR TO IMPLEMENTATION. SUCH ADJUSTMENTS SHALL BE AT NO ADDITIONAL COST TO THE OWNER.
- B. THE STRUCTURAL DRAWINGS DESCRIBE THE SYSTEM TO WITH STAND NATURAL FORCES. IT IS THE GENERAL CONTRACTOR'S RESPONSIBILITY TO COMPARE THE ARCHITECTURAL AND STRUCTURAL DRAWINGS AND REPORT CONFLICTS TO THE ARCHITECT. TO FULFILL THE DESIGN CONCEPT, IT MAY BE NECESSARY TO PROVIDE ITEMS NOT EXPRESSLY SHOWN OR CALLED FOR BUT WHICH ARE NEVER THE LES REQUIRED. IT MAY BE NECESSARY TO EXTEND STRUCTURE TO ALLOW FOR ARCHITECTURAL DETAILING. SUCH ITEMS AND ADJUSTMENTS SHALL BE AT NO ADDITIONAL COST TO THE OWNER.
- C. THE MECHANICAL, ELECTRICAL AND PLUMBING DRAWINGS ARE SCHEMATIC IN NATURE. THEY MAY NOT ACCURATELY SHOW LOCATIONS OF VARIOUS DEVISES AND ITEMS. IT IS THE GENERAL CONTRACTOR'S RESPONSIBILITY TO COORDINATE THE VARIOUS TRADES AND LOCATE THE VARIOUS ITEMS AS REQUIRED TO NEAREST VERTICAL EDGE OF THE GLAZING IS WITHIN A 24-INCH (610 MM) ARC OF EITHER ALLOW FOR PROPER FUNCTION. ADJUSTMENTS MAY BE REQUIRED TO "FIT" VARIOUS ITEMS INTO A GIVEN SPACE. SOME DEVISES AND ITEMS MAY REQUIRE ADDITIONAL BLOCKING AND SUPPORT NOT SHOWN ON THE DRAWINGS. THE GENERAL CONTRACTOR SHALL COMPARE ALL DEVICE REQUIREMENTS WITH DEVISE PROVISIONS AND REPORT DISCREPANCIES TO THE ARCHITECT. THE CONTRACTOR SHALL PROVIDE PROPER SUPPORT (STRUCTURAL, POWER, WATER, ETC.) FOR ALL DEVISES AND ITEMS SHOWN ON DRAWINGS AT NO ADDITIONAL COST TO OWNER.
- D. THE GENERAL CONTRACTOR AGREES TO DELIVER A BUILDING WITH PROPER AND PROFESSIONAL FIT AND FINISH, ALL SYSTEMS FUNCTIONING PROPERLY AND 100% WEATHER TIGHT FOR A PERIOD OF ONE YEAR: HE WILL REPAIR ANY FIT AND FINISH ITEM REQUIRING ATTENTION DUE TO NORMAL SETTLEMENT OF THE BUILDING. POOR WORKMANSHIP OR DEFECTIVE PRODUCTS. HE WILL REPAIR ALL WEATHER TIGHTNESS ISSUES NOT DUE TO ABUSE OR WINDSTORM IN EXCESS OF THE WIND LOADING REQUIREMENT. HE WILL REPAIR OR REPLACE ANY SYSTEM NOT FUNCTIONING PROPERLY.
- E. IT IS THE GENERAL CONTRACTOR'S RESPONSIBILITY TO COORDINATE ALL WORK BETWEEN THE VARIOUS BULIDING AND SITE CONTRACTORS. THE GENERAL CONTRACTOR WILL SEE TO IT THAT ALL FINAL CONNECTIONS ARE MADE. ANY EXTRA COSTS INCURRED DUE TO LACK OF FINAL CONNECTION COORDINATION WILL NOT BE PASSED TO THE OWNER.

- 2.3 PROJECT CLEAN UP / COMPLETION
- A. THE G.C. SHALL BE RESPONSIBLE FOR OVERALL CONSTRUCTION SITE CLEANLINESS, INCLUDING PROVISIONS OF A DUMPSTER WITH WEEKLY SERVICING, REMOVAL OF ALL CONTRACTOR / SUBCONTRACTOR REFUSE AND DEBRIS AND SWEEPING OF THE ENTIRE SITE AT THE COMPLETION OF THE WORKDAY.
- B. THE PREMISES SHALL BE TURNED OVER CLEAR OF ALL DEBRIS, PACKING, BOXES, WRAPPINGS AND EXCESS MATERIALS AND LEFT IN VACUUMED, MOPED CLEAN AND BROOM SWEPT CONDITION. C. ALL MIRROR AND GLASS TO BE CLEANED OF PROTECTIVE PADS, MASTICS, MARKINGS, DIRT AND
- FINGER PRINTS.. D. ALL ELECTRICAL PANELS AND BREAKERS TO BE PROPERLY MARKED W/ TYPED LEGEND.
- E. THE G.C. SHALL SET ALL TIMERS FOR PROPER TIMES OF OPERATION AS REQUIRED BY THE OWNER AND LANDLORD.
- F. THE G.C. SHALL MOUNT A PERMANENTLY FRAMED CERTIFICATE OF OCCUPANCY. LOCATION TO BE DETERMINED BY THE OWNER AND BUILDING OFFICIALS.
- G. THE C.C.. SHALL PROVIDE A WAX COAT ON ALL VINYL FLOORS. H. THE C.C. SHALL REPLACE ALL LAMPS AND PROVIDE REPLACEMENT FOR A PERIOD OF 30 DAYS COMMENCING AT DATE OF SUBSTANTIAL COMPLETION.
- I. THE C.C. SHALL REPLACE ALL AIR CONDITIONING FILTERS ON DATE OF SUBSTANTIAL COMPLETION. OWNER FURNISHED ITEMS, GENERAL NOTES

### 1.1 PROJECT/WORK IDENTIFICATION

- A. THE PROJECT CONSISTS OF CONSTRUCTION OF A NEW AUTOMIBILE DEALERSHIP AS SHOWN ON CONTRACT DOCUMENTS PREPARED BY ARCHITECT AND CONSULTANTS. 1.2 OWNER OCCUPANCY
- A. PARTIAL TENANT OCCUPANCY: THE OWNER RESERVES THE RIGHT TO PLACE AND INSTALL EQUIPMENT AS NECESSARY IN COMPLETED AREAS OF THE BUILDING AND TO OCCUPY SUCH COMPLETED AREAS PRIOR TO SUBSTANTIAL COMPLETION, PROVIDED THAT SUCH OCCUPANCY DOES NOT SUBSTANTIALLY INTERFERE WITH COMPLETION OF THE WORK. SUCH PLACING OF EQUIPMENT AND PARTIAL OCCUPANCY SHALL NOT CONSTITUTE ACCEPTANCE OF THE WORK OR ANY PART OF THE WORK.
- B. G.C. SHALL OBTAIN A CERTIFICATE OF OCCUPANCY FROM LOCAL BUILDING OFFICIALS PRIOR TO OWNER OCCUPANCY.
- UPON OWNER OCCUPANCY OF A PORTION OF THE PROJECT, THE CONTRACTOR WILL PROVIDE OPERATION AND MAINTENANCE OF MECHANICAL AND ELECTRICAL SYSTEMS IN SUCH OWNER OCCUPIED PORTIONS OF THE BUILDING.

## 3 PRE-ORDERED PRODUCTS

- A. GENERAL: THE OWNER MAY NEGOTIATE PURCHASE ORDERS WITH SUPPLIERS OF MATERIAL AND EQUIPMENT TO BE INCORPORATED INTO THE WORK. THESE PURCHASE ORDERS ARE ASSIGNED TO THE CONTRACTOR AND COSTS FOR RECEIVING, HANDLING, STORAGE, IF REQUIRED, AND INSTALLATION ARE INCLUDED IN THE CONTRACT SUM. B. THE CONTRACTOR'S RESPONSIBILITIES ARE THE SAME AS IF THE CONTRACTOR NEGOTIATED
- PURCHASE ORDERS, INCLUDING RESPONSIBILITY TO RENEGOTIATE PURCHASE IF NECESSARY AND TO EXECUTE FINAL PURCHASE ORDER AGREEMENTS.
- C. THE OWNER RESERVES THE RIGHT TO ORDER AND PURCHASE ANY ITEMS IDENTIFIED IN THE CONSTRUCTION DOCUMENTS.

### .4 OWNER -FURNISHED ITEMS

- A. THE OWNER WILL PROVIDE MATERIAL AS DESCRIBED IN THE DRAWINGS. THE GENERAL CONTRACTOR'S WORK INCLUDES PROVIDING SUPPORT SYSTEMS TO RECEIVE OWNER'S EQUIPMENT, AND MECHANICAL, PLUMBING AND ELECTRICAL CONNECTIONS.
- B. THE OWNER WILL ARRANGE AND PAY FOR DELIVERY OF OWNER-FURNISHED ITEMS IN ACCORDANCE WITH THE CONTRACTOR'S CONSTRUCTION SCHEDULE.
- C. IF OWNER -FURNISHED ITEMS ARE DAMAGED DURING DELIVERY, DEFECTIVE OR MISSING, THE CONTRACTOR WILL ARRANGE FOR REPLACEMENT.
- D. THE CONTRACTOR WILL INCLUDE THE MANUFACTURER'S WARRANTIES AND BONDS FOR THE OWNER SUPPLIED EQUIPMENT IN THE CONTRACTOR ASSEMBLED CLOSE OUT PACKAGE.
- E. THE CONTRACTOR IS RESPONSIBLE FOR DESIGNATING THE DELIVERY DATES OF OWNER-FURNISHED ITEMS IN THE CONTRACTOR'S CONSTRUCTION SCHEDULE AND FOR RECEIVING, UNLOADING AND HANDLING OWNER-FURNISHED ITEMS AT THE SITE. THE CONTRACTOR IS RESPONSIBLE FOR PROTECTING OWNER-FURNISHED ITEMS FROM DAMAGE. INCLUDING DAMAGE FROM EXPOSURE TO THE ELEMENTS, AND TO REPAIR OR REPLACE ITEMS DAMAGED AS A RESULT OF HIS OPERATIONS.

## **TERMITE NOTES:**

- A PERMANENT SIGN WHICH IDENTIFIES THE TERMITE TREATMENT PROVIDER AND NEED FOR RE-INSPECTION AND TREATMENT CONTRACT RENEWAL SHALL BE PROVIDED. THE SIGN SHALL BE POSTED NEAR THE WATER HEATER OR ELECTRIC PANEL. FBC 105.11
- 2. CONDENSATE AND ROOF DOWNSPOUTS SHALL DISCHARGE AT LEAST 1'-0" AWAY FROM BUILDING SIDE WALLS FBC 1503.7 (UNDERGROUND STORM DRAINAGE SYSTEM TO BE USED)
- 3. IRRIGATION/SPRINKLER SYSTEM INCLUDING ALL RISERS AND SPRAY HEADS SHALL NOT BE INSTALLED WITHIN 1'-0" OF THE BUILDING SIDE WALLS.
- 4. TO PROVIDE FOR INSPECTOR FOR TERMITE INFESTATION BETWEEN WALL COVERING AND FINAL EARTH GRADE SHALL NOT BE LESS THAN 6". EXCEPTION: PAINT OR DECORATIVE CEMENTITIOUS FINISH LESS THAN 5/8" THICK ADHERED DIRECTLY TO THE FOUNDATION WALL.
- 5. IF SOIL TREATMENT IS USED FOR SUBTERRANEAN TERMITE PREVENTION, THE INITIAL CHEMICAL SOIL TREATMENT INSIDE THE FOUNDATION PERIMETER SHALL BE DONE AFTER ALL EXCAVATION, BACKFILLING AND COMPACTION IS COMPLETE. FBC 1816.1.1

6. IF SOIL TREATMENT IS USED FOR SUBTERRANEAN TERMITE PREVENTION, SOIL AREA

- DISTURBED AFTER INITIAL CHEMICAL SOIL TREATMENT SHALL BE RETREATED WITH A CHEMICAL SOIL TREATMENT, INCLUDING SPACES BOXED OR FORMED FBC 1816.1.2 7. IF SOIL TREATMENT IS USED FOR SUBTERRANEAN TERMITE PREVENTION, SPACE IN CONCRETE FLOORS BOXED OUT OR FORMED FOR THE SUBSEQUENT INSTALLATION OF PLUMBING TRAPS,
- DRAINS OR ANY OTHER PURPOSE SHALL BE CREATED BY USING PLASTIC OR METAL PERMANENTLY PLACED FORMS OF SUFFICIENT DEPTH TO ELIMINATE ANY PLANNED SOIL DISTURBANCE AFTER INITIAL CHEMICAL SOIL TREATMENT. FBC 1816.1.3 8. IF SOIL TREATMENT IS USED FOR SUBTERRANEAN TERMITE PREVENTION, CHEMICALLY TREATED SOIL SHALL BE PROTECTED WITH A MINIMUM 6 MILLIMETER VAPOR RETARDER TO PROTECT AGAINST RAINFALL DILUTION. IF RAINFALL OCCURS BEFORE VAPOR RETARDER
- STEEL, DONE AFTER CHEMICAL TREATMENT UNTIL THE CONCRETE FLOOR IS POURED, SHALL BE DONE IN SUCH MANNER AS TO AVOID PENETRATING OR DISTURBING TREATED SOIL. FBC 1816.1.4 IF SOIL TREATMENT IS USED FOR SUBTERRANEAN TERMITE PREVENTION, CONCRETE OVERPOUR OR MORTAR ACCUMULATED ALONG THE EXTERIOR FOUNDATION PERIMETER SHALL BE REMOVED PRIOR TO EXTERIOR CHEMICAL SOIL TREATMENT, TO ENHANCE VERTICAL

PLACEMENT, RETREATMENT IS REQUIRED. ANY WORK, INCLUDING PLACEMENT OF REINFORCING

- 10. F SOIL TREATMENT IS USED FOR SUBTERRANEAN TERMITE PREVENTION, CHEMICAL SOIL TREATMENTS SHALL ALSO BE APPLIED UNDER ALL EXTERIOR CONCRETE OR GRADE WITHIN 1 FOOT (305 MM) OF THE PRIMARY STRUCTURE SIDEWALLS. ALSO, A VERTICAL CHEMICAL BARRIER SHALL BE APPLIED PROMPTLY AFTER CONSTRUCTION IS COMPLETED, INCLUDING INITIAL LANDSCAPING AND IRRIGATION/SPRINKLER INSTALLATION. ANY SOIL DISTURBED AFTER THE
- 11. A CERTIFICATE OF COMPLIANCE MUST BE ISSUED TO THE BUILDING DEPARTMENT BY A LICENSED PEST CONTROL COMPANY BEFORE A CERTIFICATE OF OCCUPANCY IS ISSUED.

CHEMICAL VERTICAL BARRIER IS APPLIED SHALL BE PROMPTLY RETREATED. FBC 1816.1.6

## SAFETY GLAZING NOTES:

PENETRATION OF THE CHEMICALS. FBC 1816.1.5

- 2406.4 HAZARDOUS LOCATIONS THE FOLLOWING SHALL BE CONSIDERED SPECIFIC HAZARDOUS LOCATIONS FOR THE PURPOSE OF GLAZING:
- 1. GLAZING IN SWINGING DOORS AND FIXED AND SLIDING PANELS OF SLIDING DOOR ASSEMBLIES.
- 2. GLAZING IN ALL FIXED AND OPERABLE PANELS OF SWINGING, SLIDING, AND BIFOLD DOORS SHALL BE CONSIDERED A HAZARDOUS LOCATION.
- 3. GLAZING IN AN INDIVIDUAL FIXED OR OPERABLE PANEL ADJACENT TO A DOOR WHERE THE VERTICAL EDGE OF THE DOOR IN A CLOSED POSITION AND WHERE THE BOTTOM EXPOSED EDGE OF THE GLAZING IS LESS THAN 60 INCHES (1524 MM) ABOVE THE WALKING SURFACE SHALL BE CONSIDERED A HAZARDOUS LOCATION.
- 4. GLAZING IN AN INDIVIDUAL FIXED OR OPERABLE PANEL THAT MEETS ALL OF THE FOLLOWING CONDITIONS SHALL BE CONSIDERED A HAZARDOUS LOCATION: 4.1 EXPOSED AREA OF AN INDIVIDUAL PANE GREATER THAN 9 SQ. FT.
- 4.2 BOTTOM EDGE LESS THAN 18 INCHES ABOVE FLOOR. 4.3 TOP EDGE GREATER THAN 36 INCHES ABOVE THE FLOOR. 4.4 ONE OR MORE WALKING SURFACES WITHIN 36 INCHES HORIZONTALLY OF THE PLANE OF THE GLAZING.
- 5. GLAZING IN GUARDS AND RAILINGS, INCLUDING STRUCTURAL BALUSTER PANELS AND NONSTRUCTURAL IN-FILL PANELS, REGARDLESS OF AREA OR HEIGHT ABOVE A WALKING SURFACE SHALL BE CONSIDERED A HAZARDOUS LOCATION.


SHOULD INCONSISTENCIES OR DISCREPANCIES OCCUR WITHIN THESE DRAWINGS OR SPECIFICATIONS, THE BETTER QUALITY, GREATER QUANTITY AND MOST EXPENSIVE PRODUCT OR TASK SHALL BE PERFORMED OR FURNISHED, UNLESS INSTRUCTED OTHERWISE BY THE ARCHITECT. DISCREPANCIES BETWEEN SPECIFIED ITEMS OR INSTALLATION METHODS SHALL NOT BE CAUSE FOR MODIFICATION TO THE CONTRACT SUM OR CONTRACT TIME.

1.) PIPING FOR NEW OIL AND ATF (CLASS IIIB) WILL BE 7/8 STEEL TUBING OR GALVINIZED PIPE. 2.) WASTE OIL AND WASTE ANTIFREEZE PIPING WILL BE OF BLACK

ACCORDANCE WITH NFPA 30.

PIPE. IN ACCORDANCE WITH NFPA 30. 3.) ALL PIPE AND FITTINGS WILL BE ABOVE GROUND. IN ACCORDANCE WITH NFPA 30.

4.) ALL TANKS WILL BE DOUBLE WALLED AND UL LISTED IN

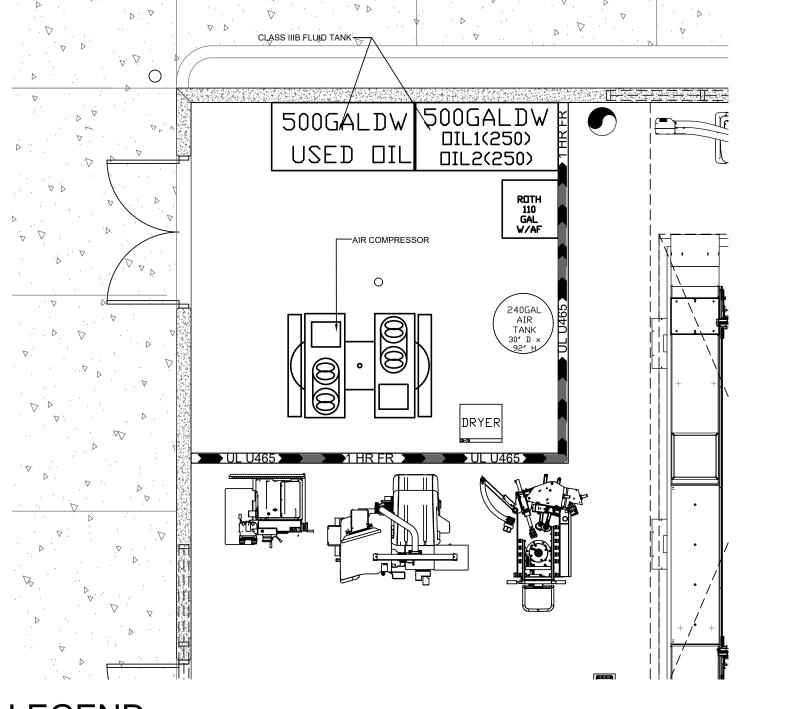

\*\* NOTE: ALL STORAGE TANKS TO BE DOUBLE WALLED

1 HR FR

1 HOUR FIRE RATED CMU WALL PER UL - U465

NOTE: SEE MECHANICAL PLANS FOR VENTILATION.

## FIRE SEPARATIONS

PER NFPA 30 SECTION 3.3.37.1 THE OIL STORAGE ROOM IS A CUTOFF ROOM AND THEREFORE PER 6.4.2.1 AND TABLE 6.4.2.1 THE INTERIOR WALLS SHALL BE PROVIDED WITH 1 HOUR FIRE RESISTANT PROTECTION.

COMBUSTIBLE LIQUID ANALYSIS

PER NFPA 30A 1.7.3.1 CLASS IIIB COMBUSTIBLE LIQUID IS ANY LIQUID THAT HAS A CLOSED-CUP FLASH POINT AT OR ABOVE 200° F (93° C).

OIL STORAGE ROOM WILL CONTAIN: CLASS IIIB LIQUID

(NOTE: VALUES BELOW HAVE BEEN OBTAINED FROM NATIONALLY KNOW PRODUCTS MSDS SHEETS AVAILABLE VIA MANUFACTURER'S WEB SITES. THEY ARE REPRESENTATIVE OF THE LIQUIDS WHICH WILL BE CONTAINED BY THE THE TANKS SHOWN)

NEW OIL - CLOSED-CUP FLASH POINT 401° F (205° C) ATF (AUTOMATIC TRANSMISSION FLUID) - CLOSED-CUP FLASH POINT 350° F (177° C) WASTE COOLANT (ANTIFREEZE) - CLOSED-CUP FLASH POINT 247° F (119° C) WASTE OIL - TANKS AND CONTAINERS THAT CONTAIN ONLY CRANKCASE DRAININGS SHALL BE CONSIDERED AS CONTAINING CLASS IIIB LIQUIDS - NFPA 30A 4.3.9.3

## STORAGE ANALYSIS

## ENGINES AND TRANSMISSIONS MAY BE DELIVERED AND STORED ON PALLETS. NONE OF THE

UNITS SHOWN ABOVE ARE RATED FOR THE WEIGHT OF THESE ITEMS. THE ITEMS ARE NOT PACKAGED IN WEIGHT BEARING CRATES, THEREFORE THESE ITEMS WILL NOT BE STACKED. OTHER ITEMS WHICH MAY BE DELIVERED AND OFF LOADED ON PALLETS WILL BE REMOVED FROM THE PALLETS AND STORED ON SHELVES, IN DRAWERS OR BINS. IT IS NOT STANDARD PRACTICE TO STORE STACKED PALLETS OR TO RETAIN PALLETS IN ANY QUANTITY.

ITEMS WHICH MAY BE STORED IN PARTS STORAGE INCLUDE ANY ITEM WHICH MAY BE PART OF AN AUTOMOBILE. SUCH ITEMS WILL BE STORED WITHIN SEPARATE CARTONS OR LEFT LOOSE. ITEMS WHICH WOULD BE STORED IN CARTONS INCLUDE MECHANICAL PARTS SUCH AS WATER PUMPS, BRAKE ROTORS, CV JOINTS, ALTERNATORS, POWER STEERING PUMPS WINDSHIELD WIPER BLADES, FILTERS, FUEL PUMPS, TAIL LIGHT ASSEMBLIES, ETC. ITEMS WHICH WOULD BE STORED LOOSE WOULD TEND TO BE LARGE ITEMS WHICH WOULD INCLUDE BUMPERS, FENDERS, SEAT ASSEMBLIES, HOODS, TRUNK LIDS, ETC. LOOSE NUTS AND BOLTS, EMISSION ITEMS (T's AND FITTINGS), HOSES, ELECTRICAL CONNECTIONS, AND SUCH WILL BE STORED IN DRAWERS OR BINS. BELTS TEND TO BE HUNG ON PEG BOARD.

**HARTMANN** architecture ind 4427 W. Kennedy Blvc Tampa, Florida 33609 813.251.2190 AR0962 Project Name

> 0

Sheet Title **EQUIPMENT** STORAGE

Revisions

State Registration Richard Hartmann AIA, LEED AP AR 09622




signed and sealed and the signature must be verified on any electronic copies. d specifications comply with the applicable building codes and nimum fire safety standards Project Number 22026 Drawn By


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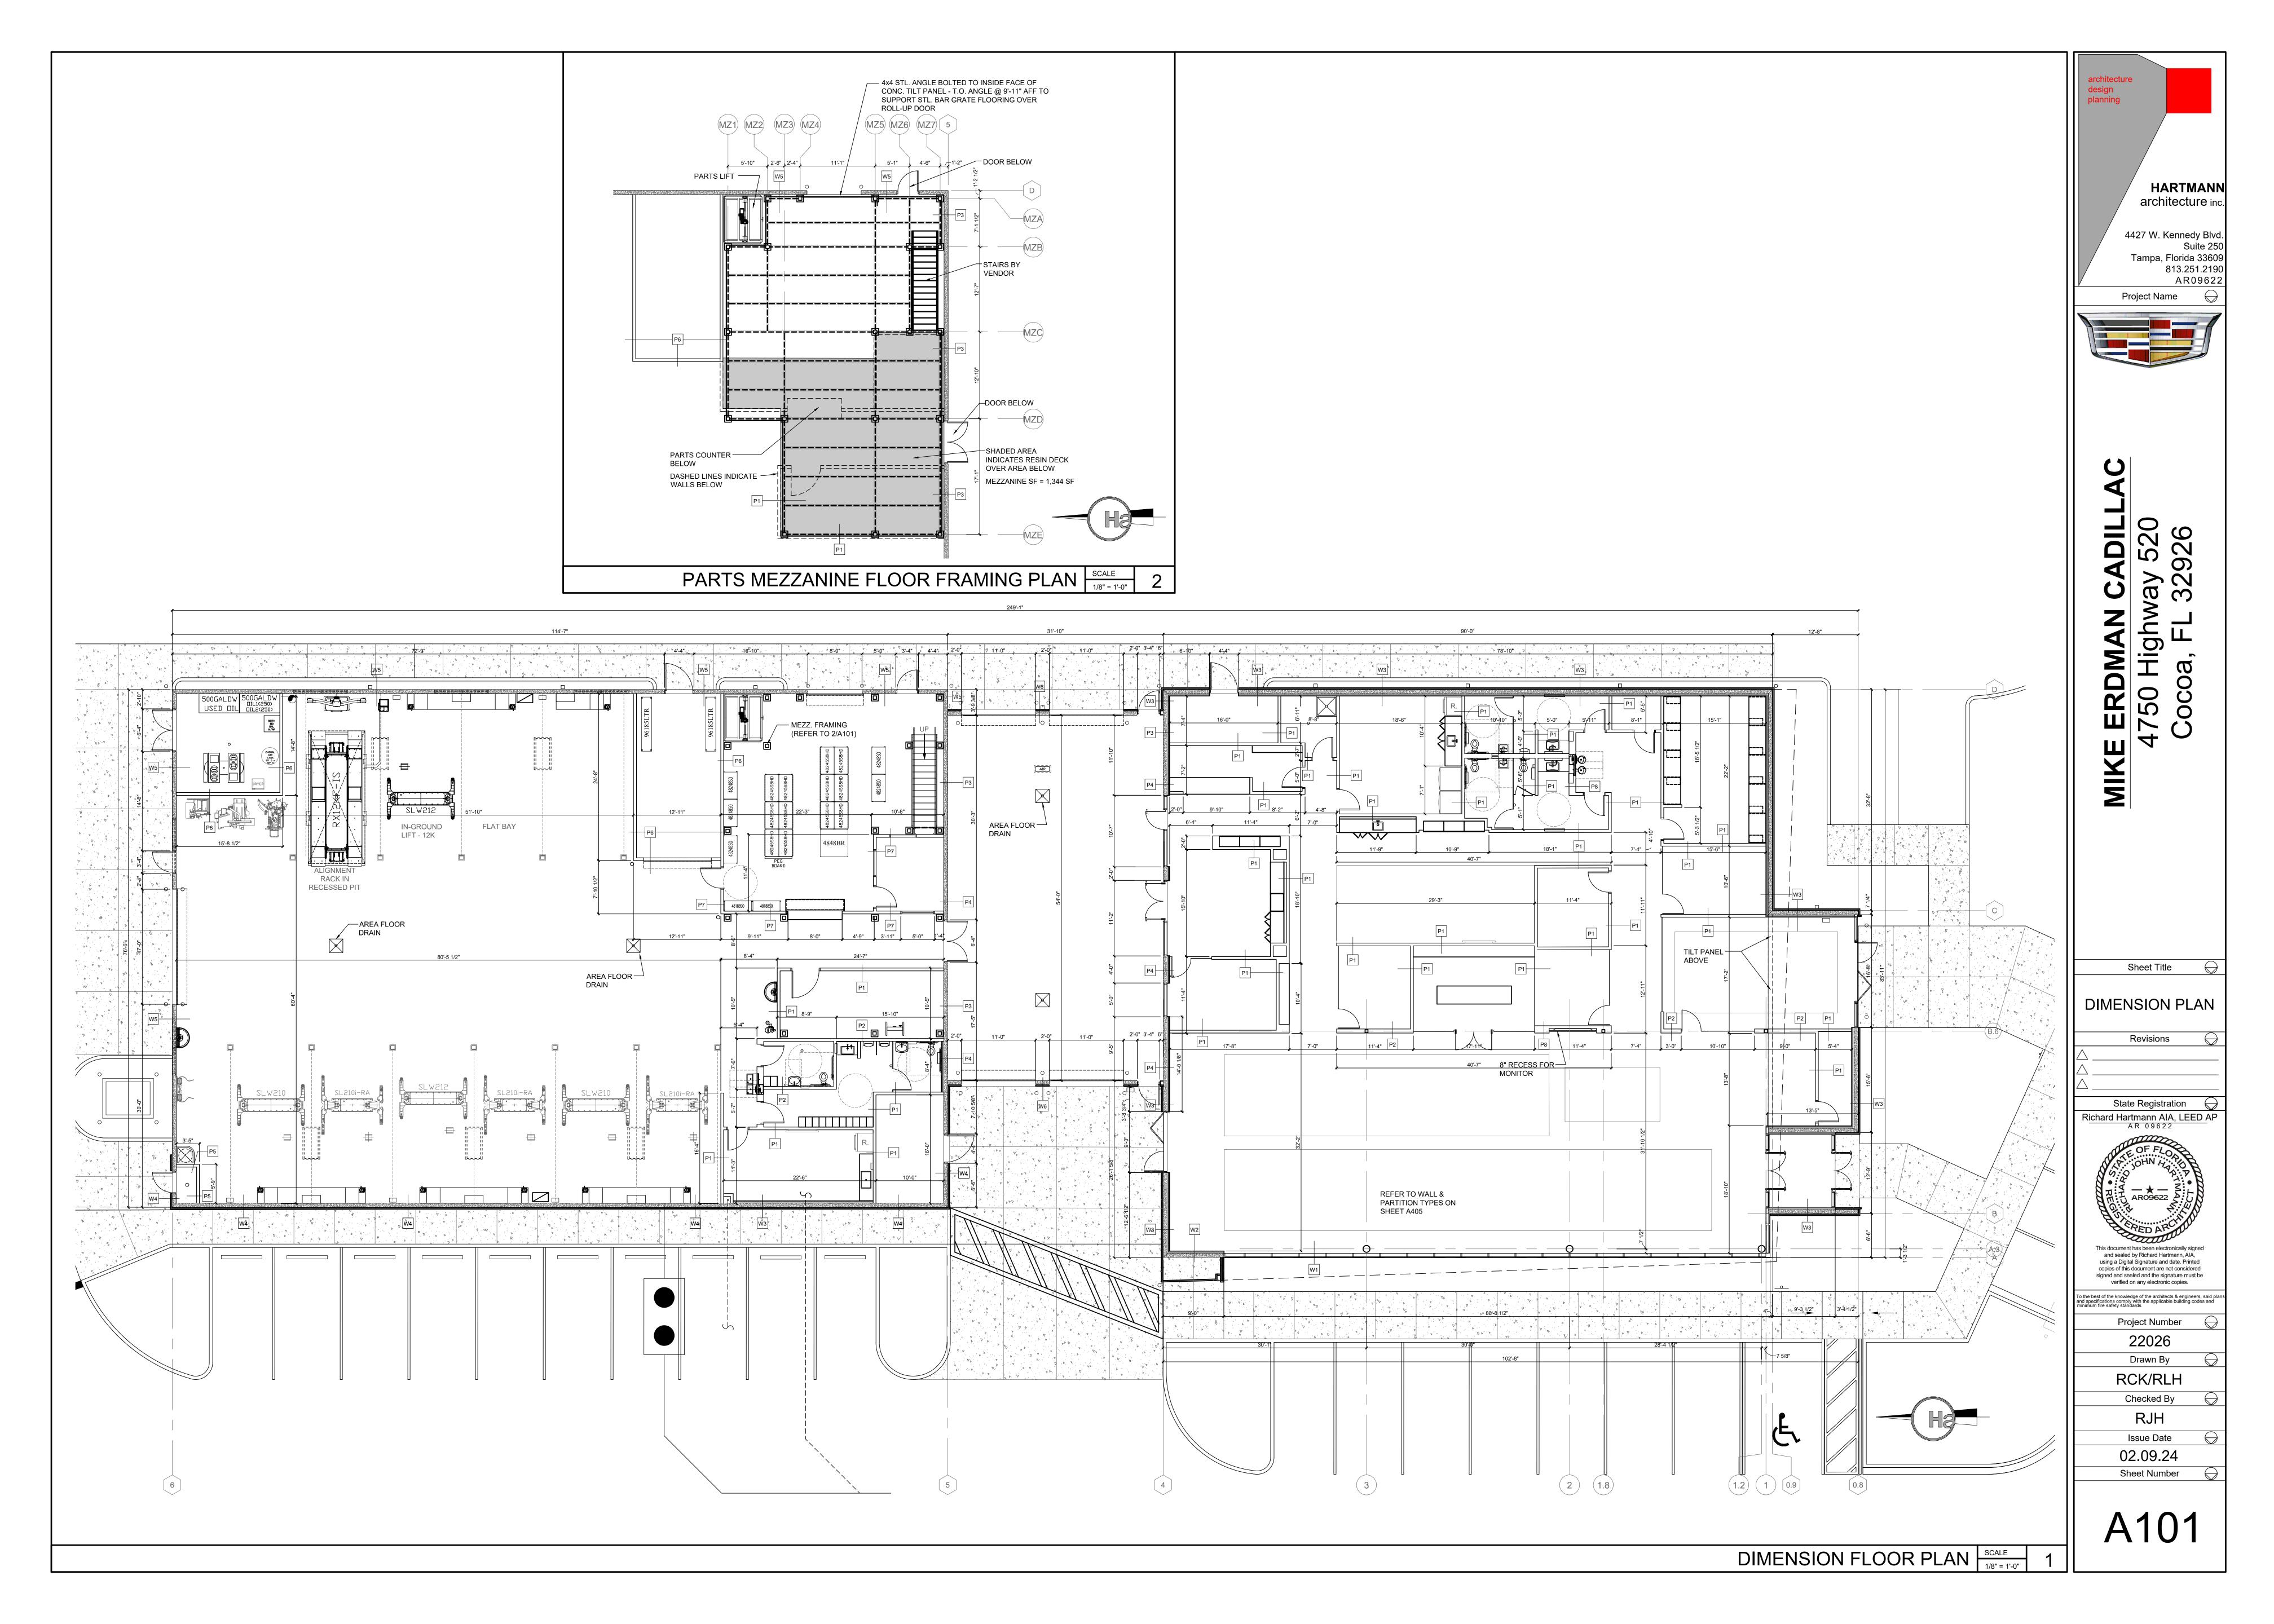
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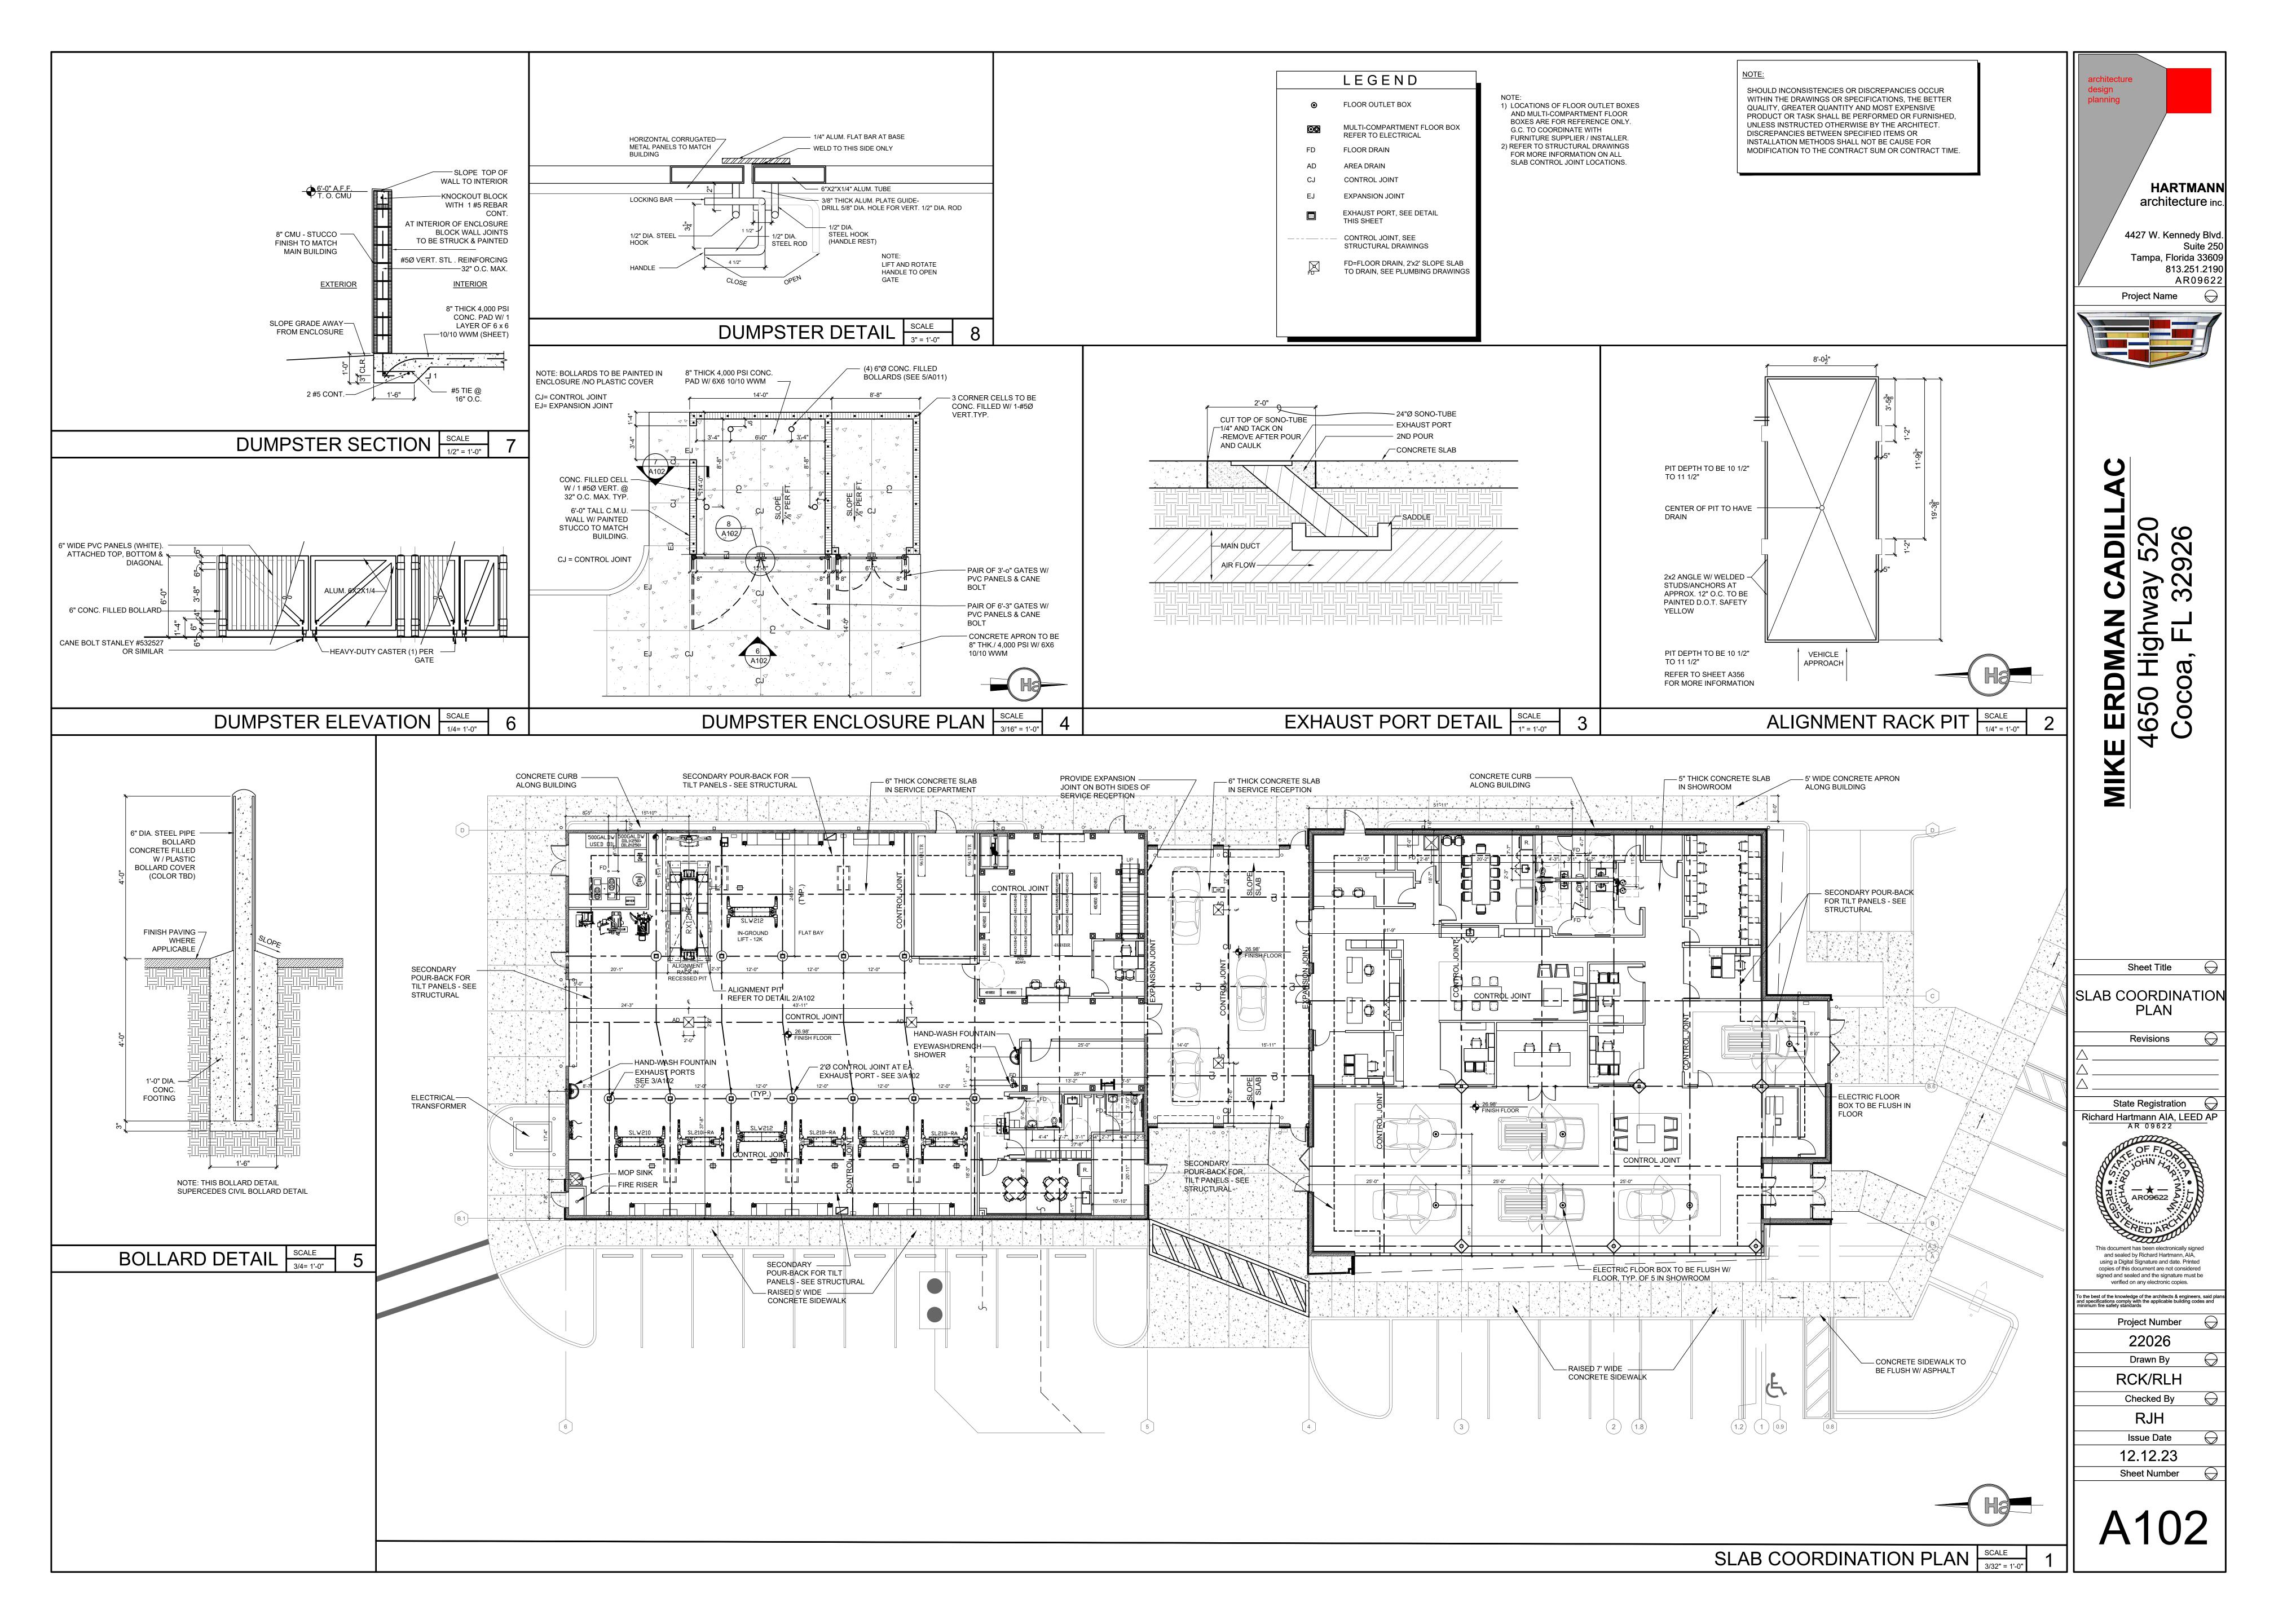
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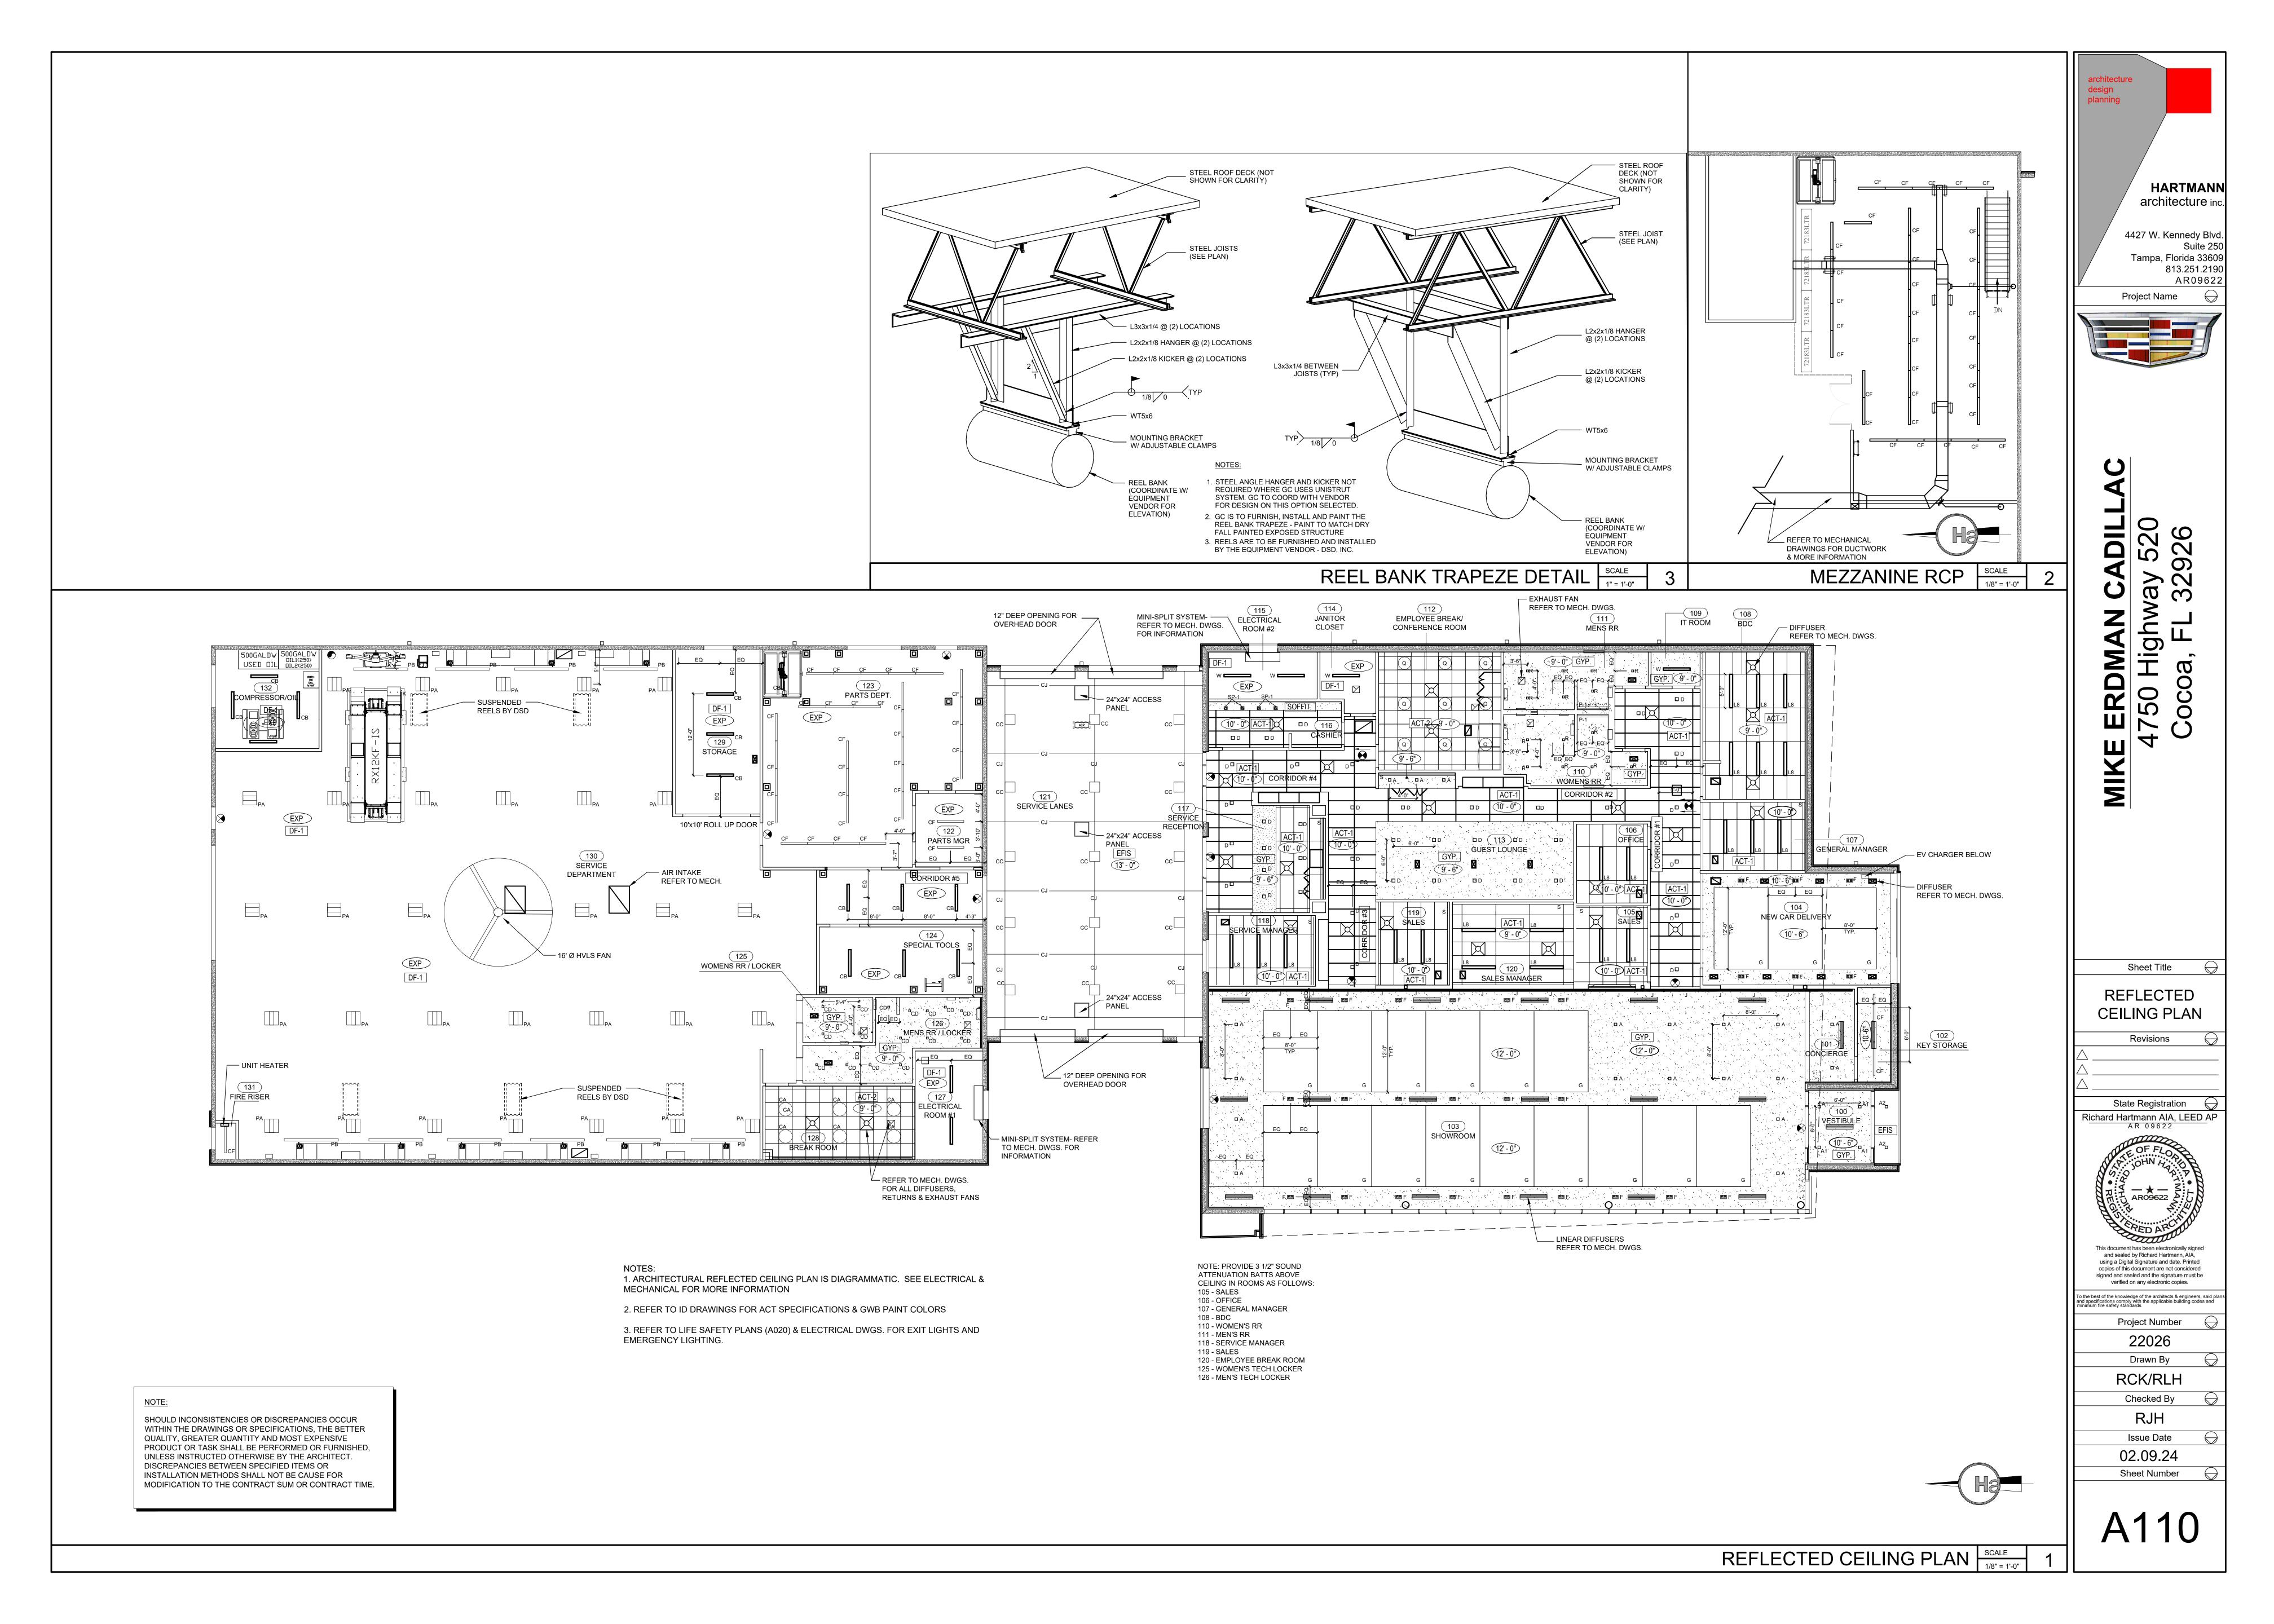
OIL/COMPRESSOR 132 PLAN | SCALE ANALYSIS SCALE NTS










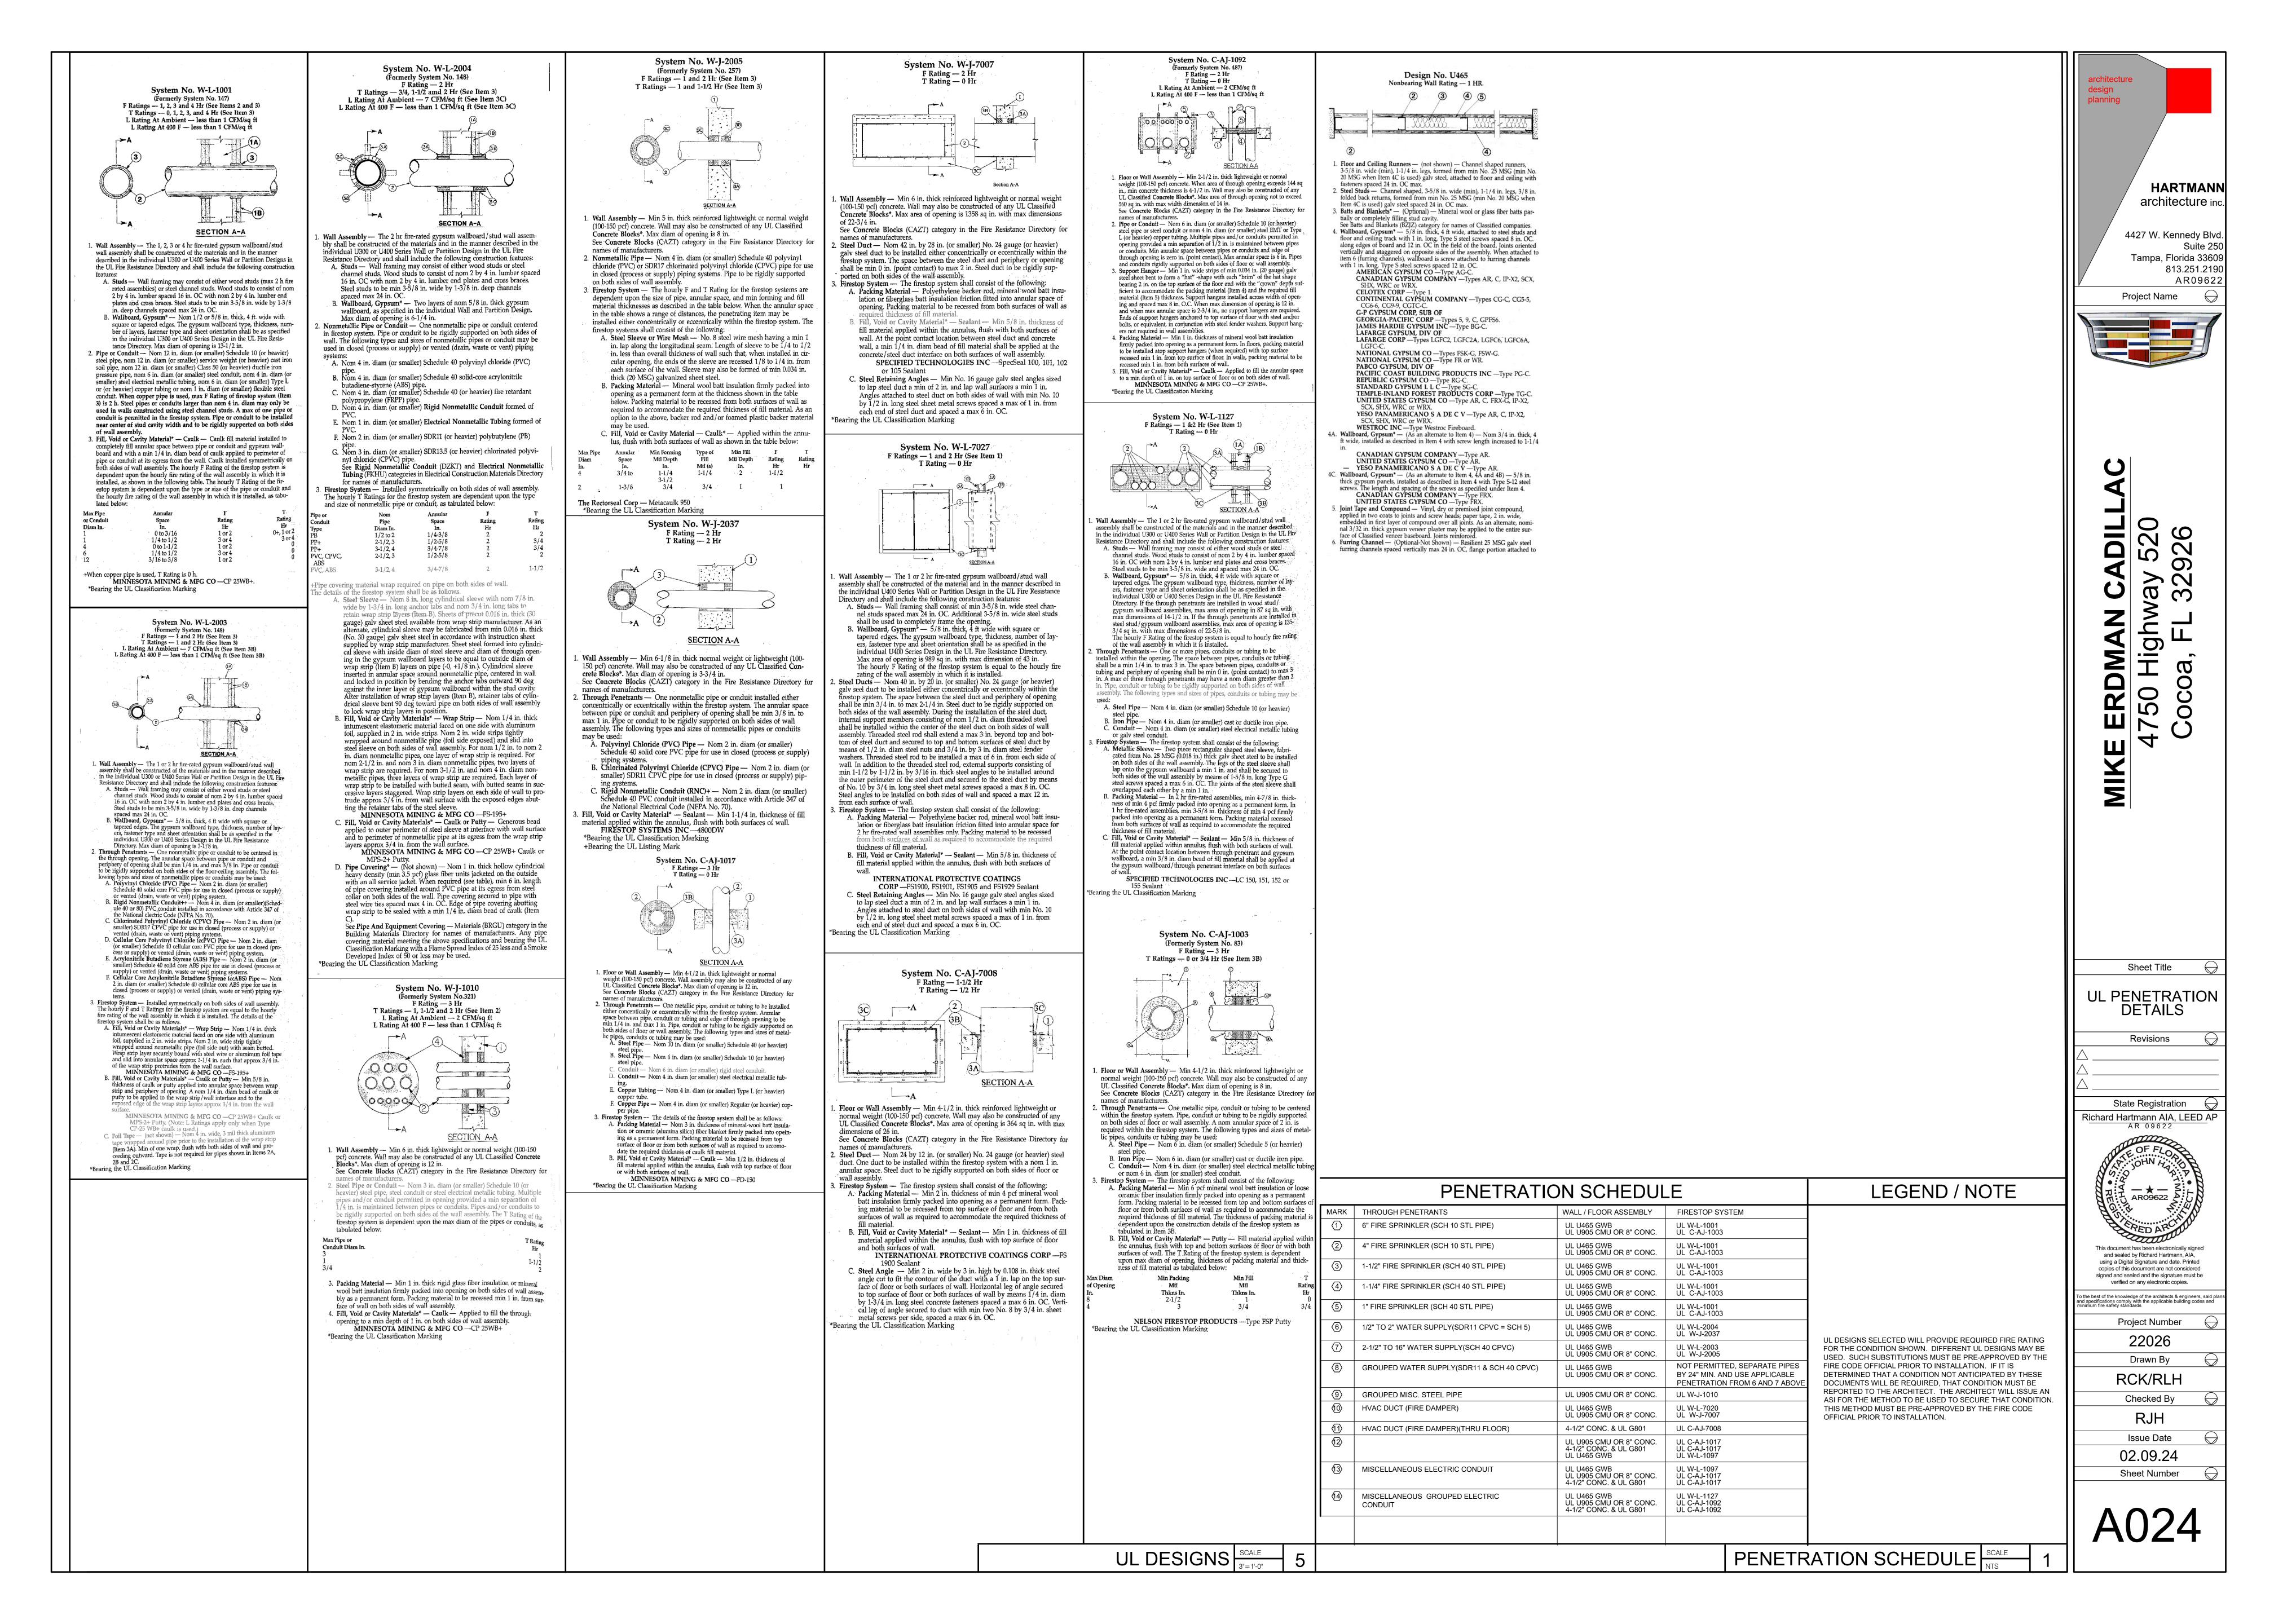

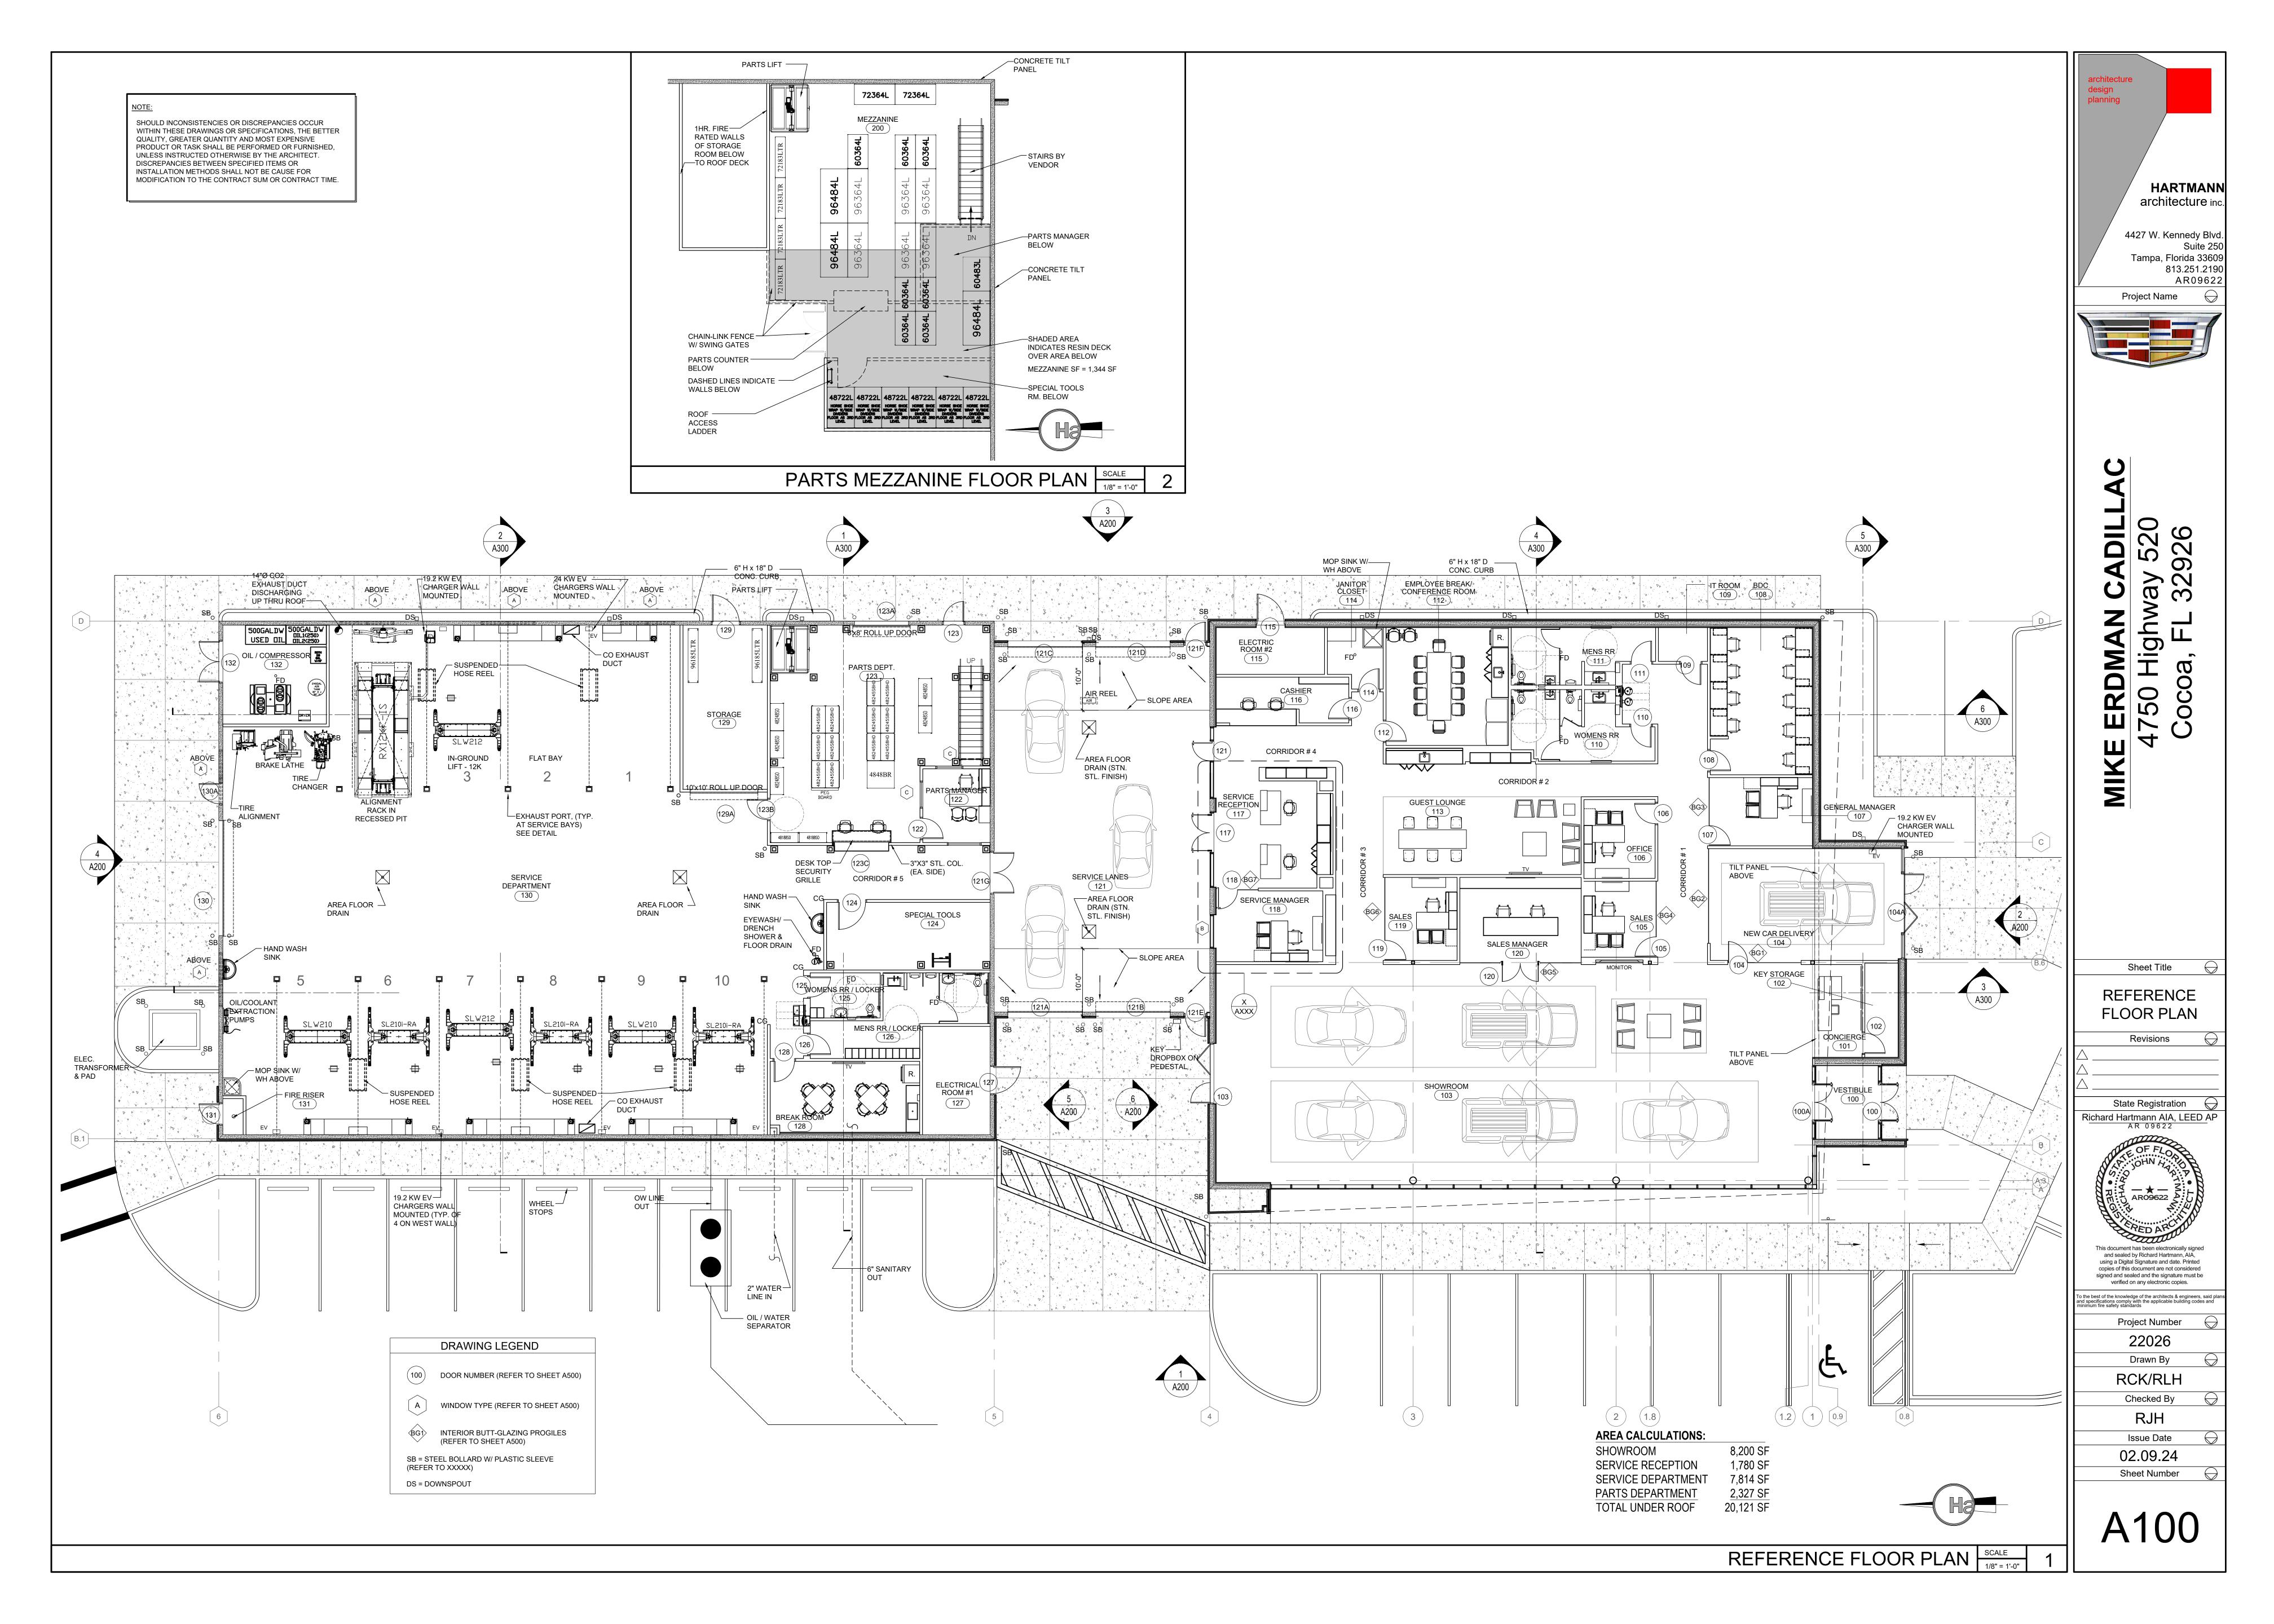


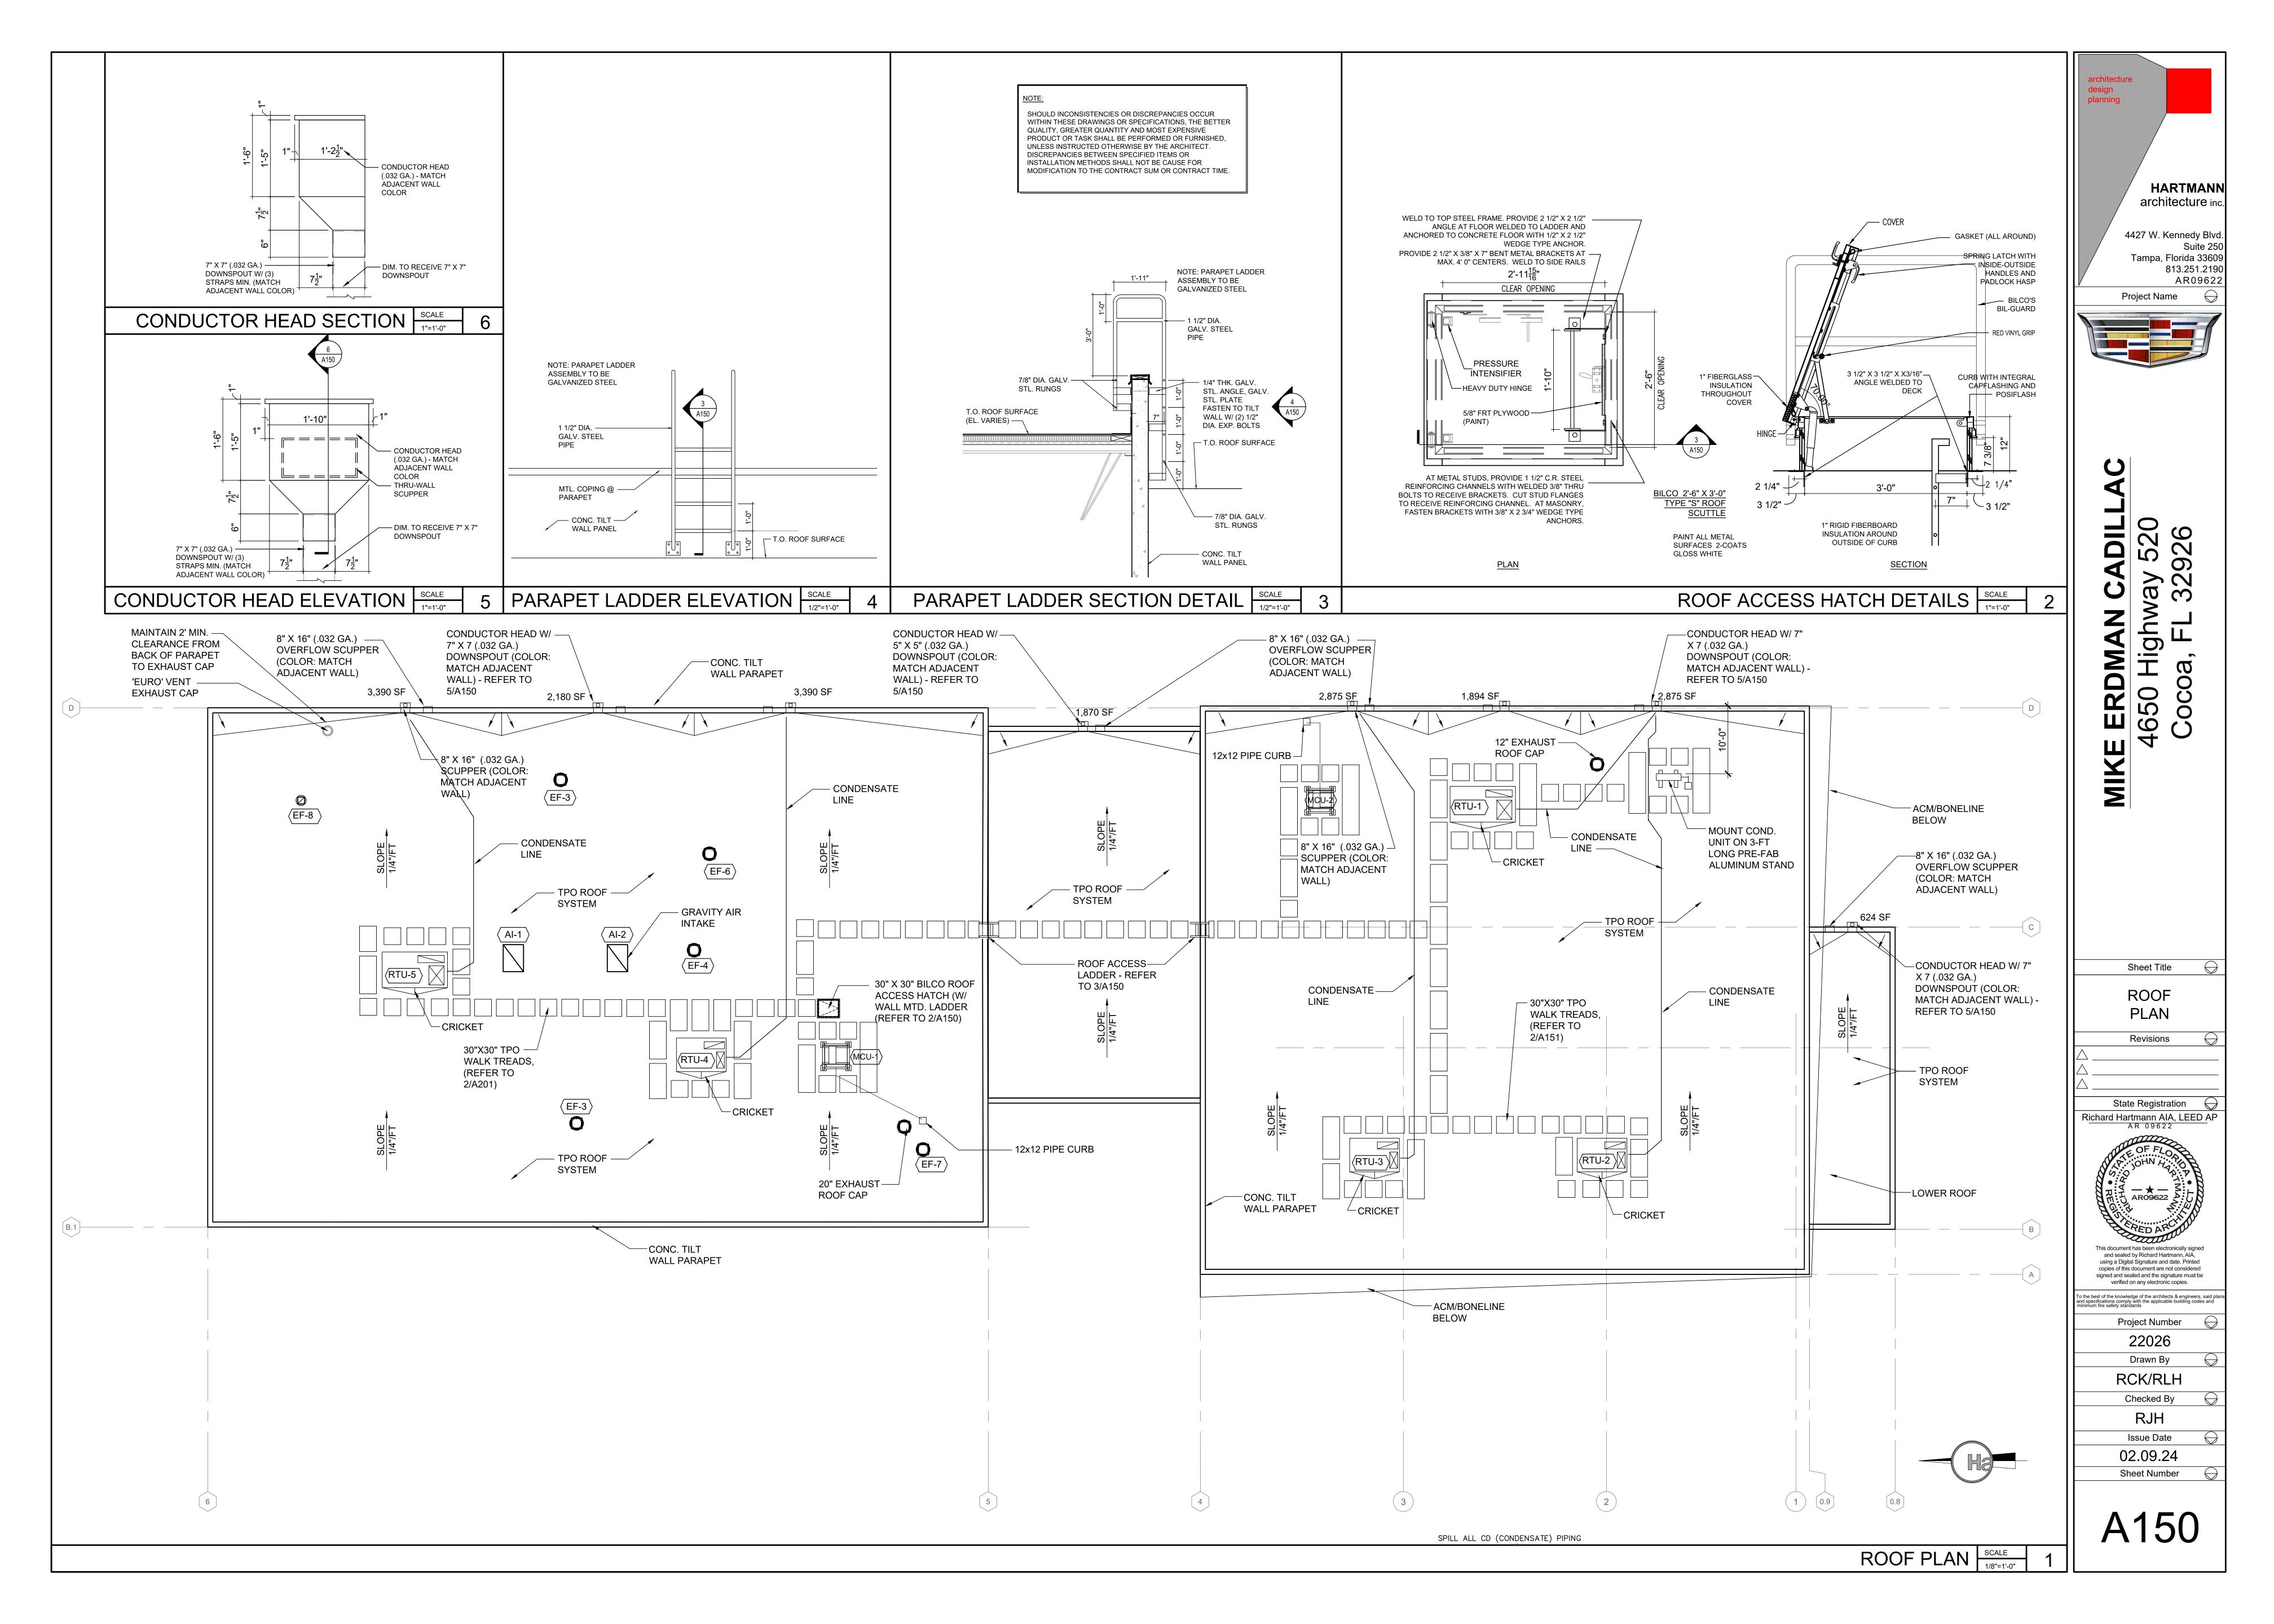

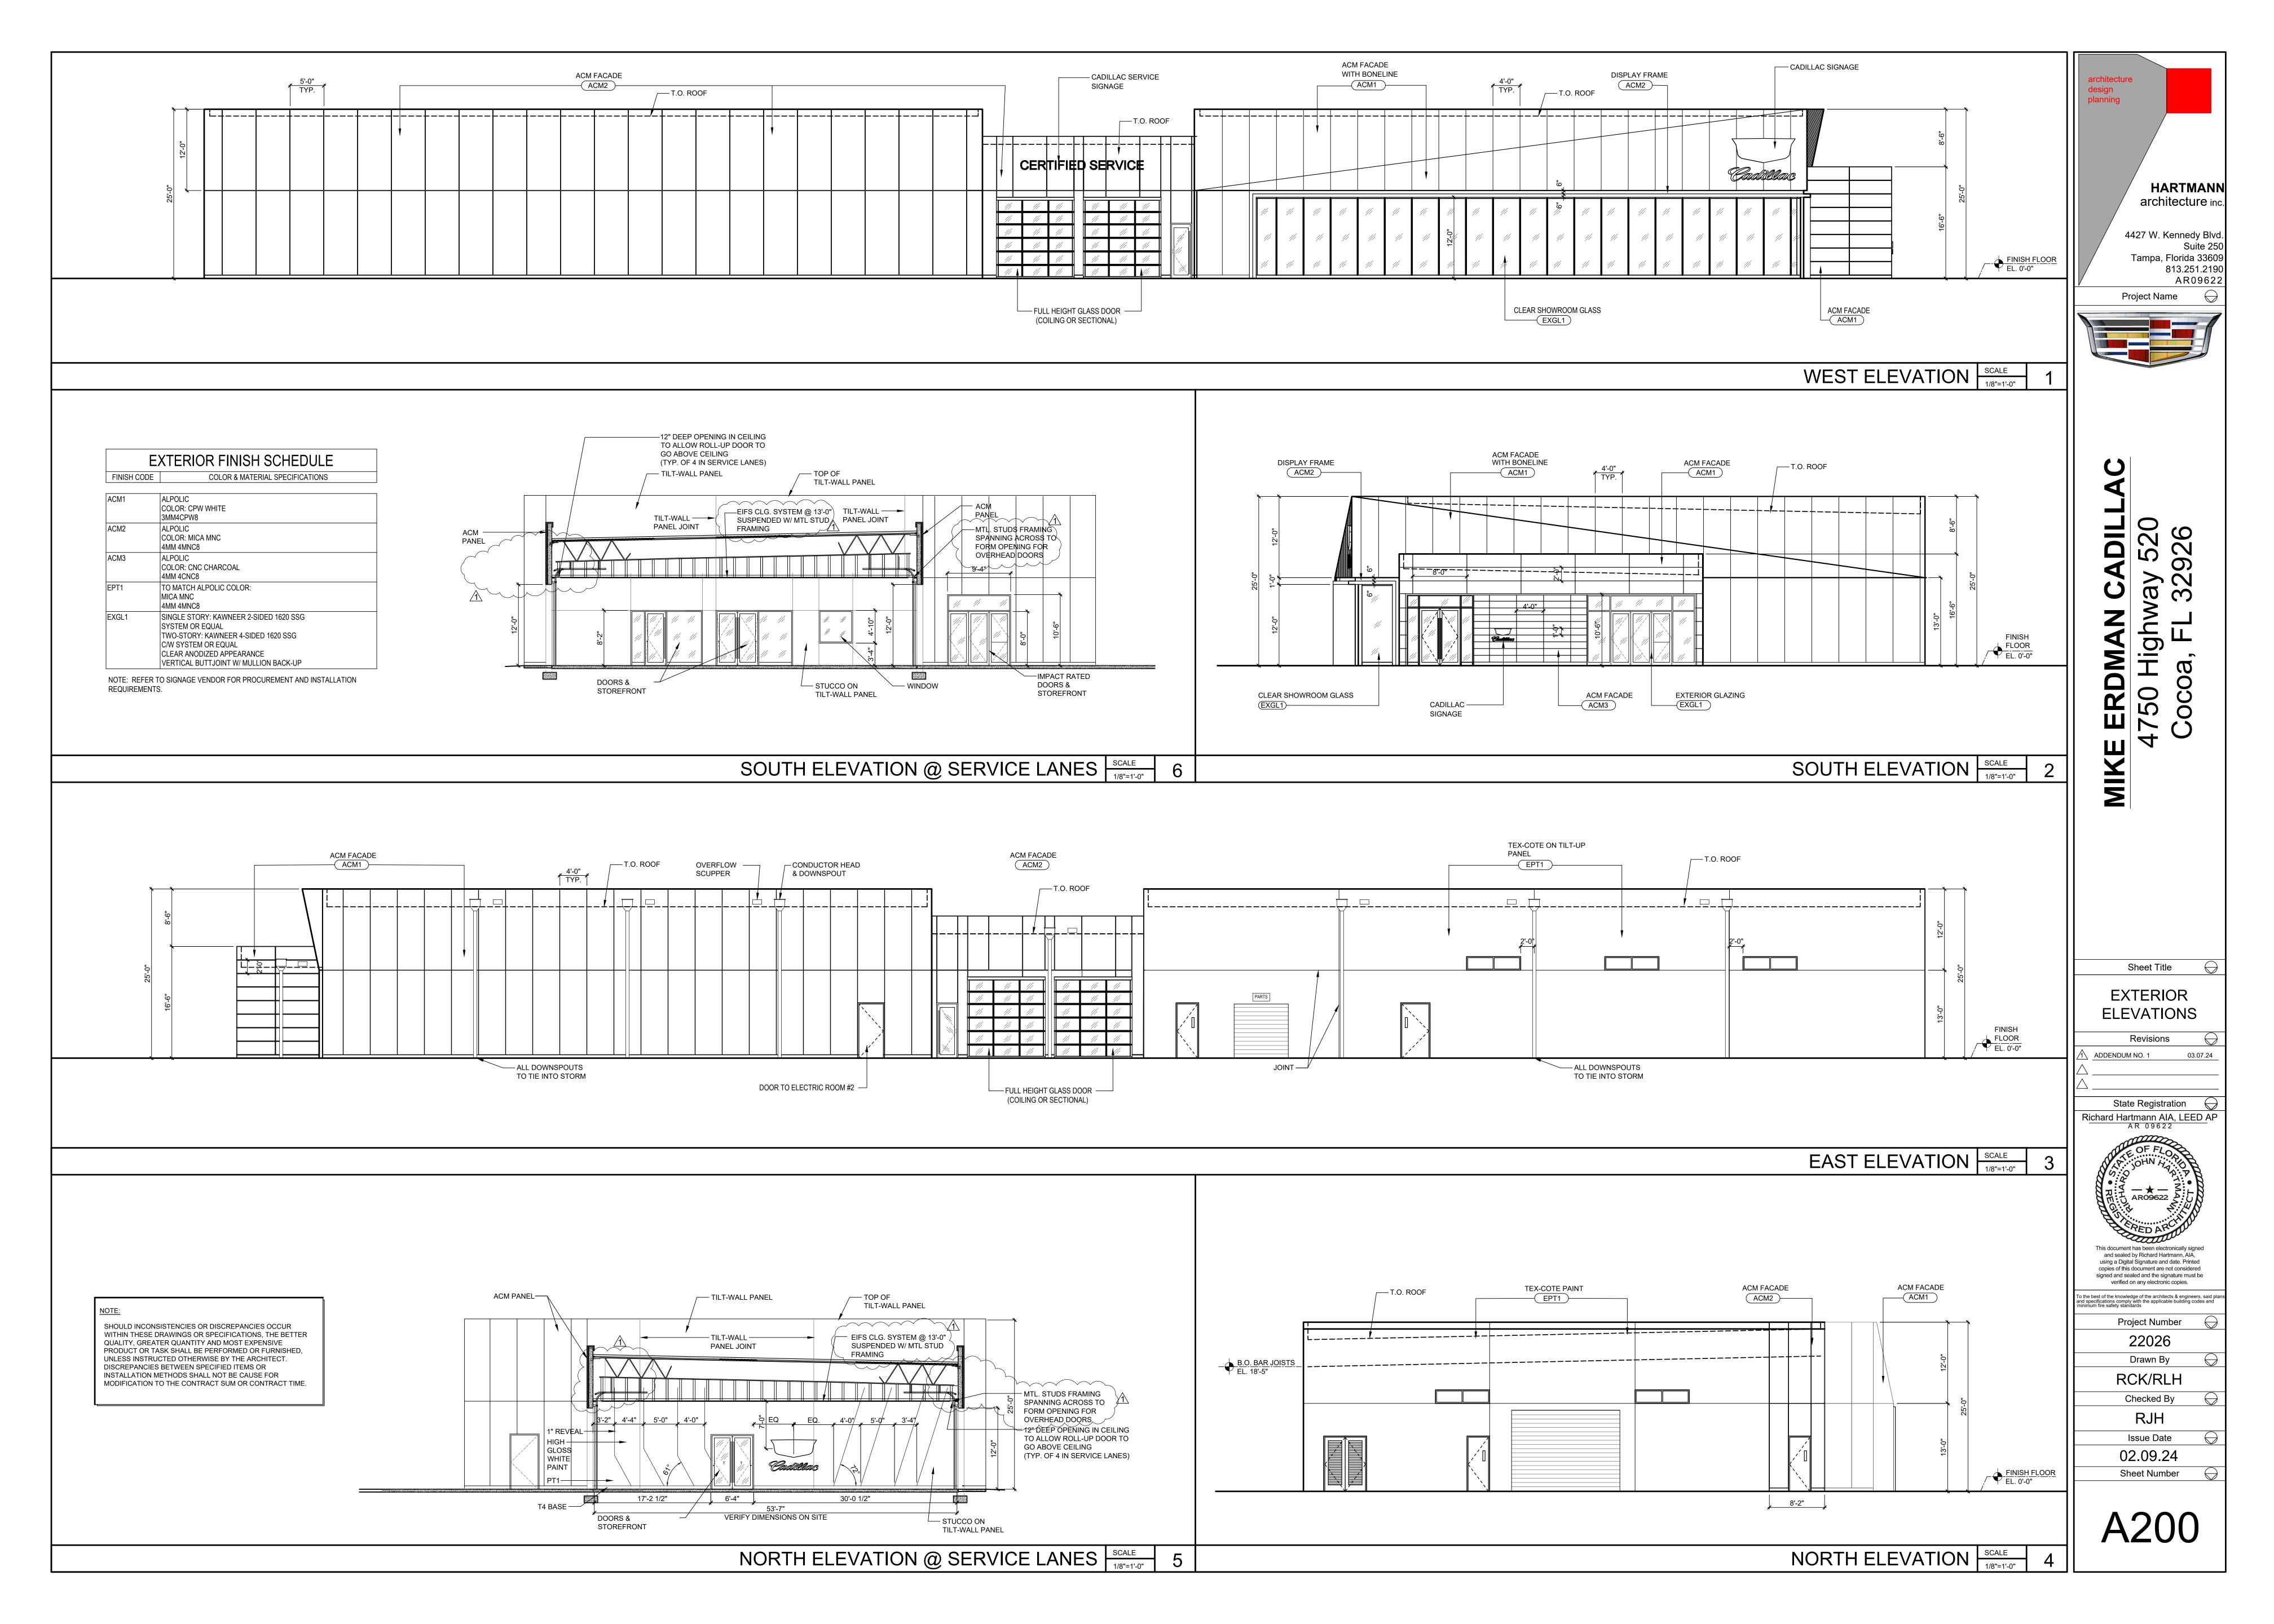

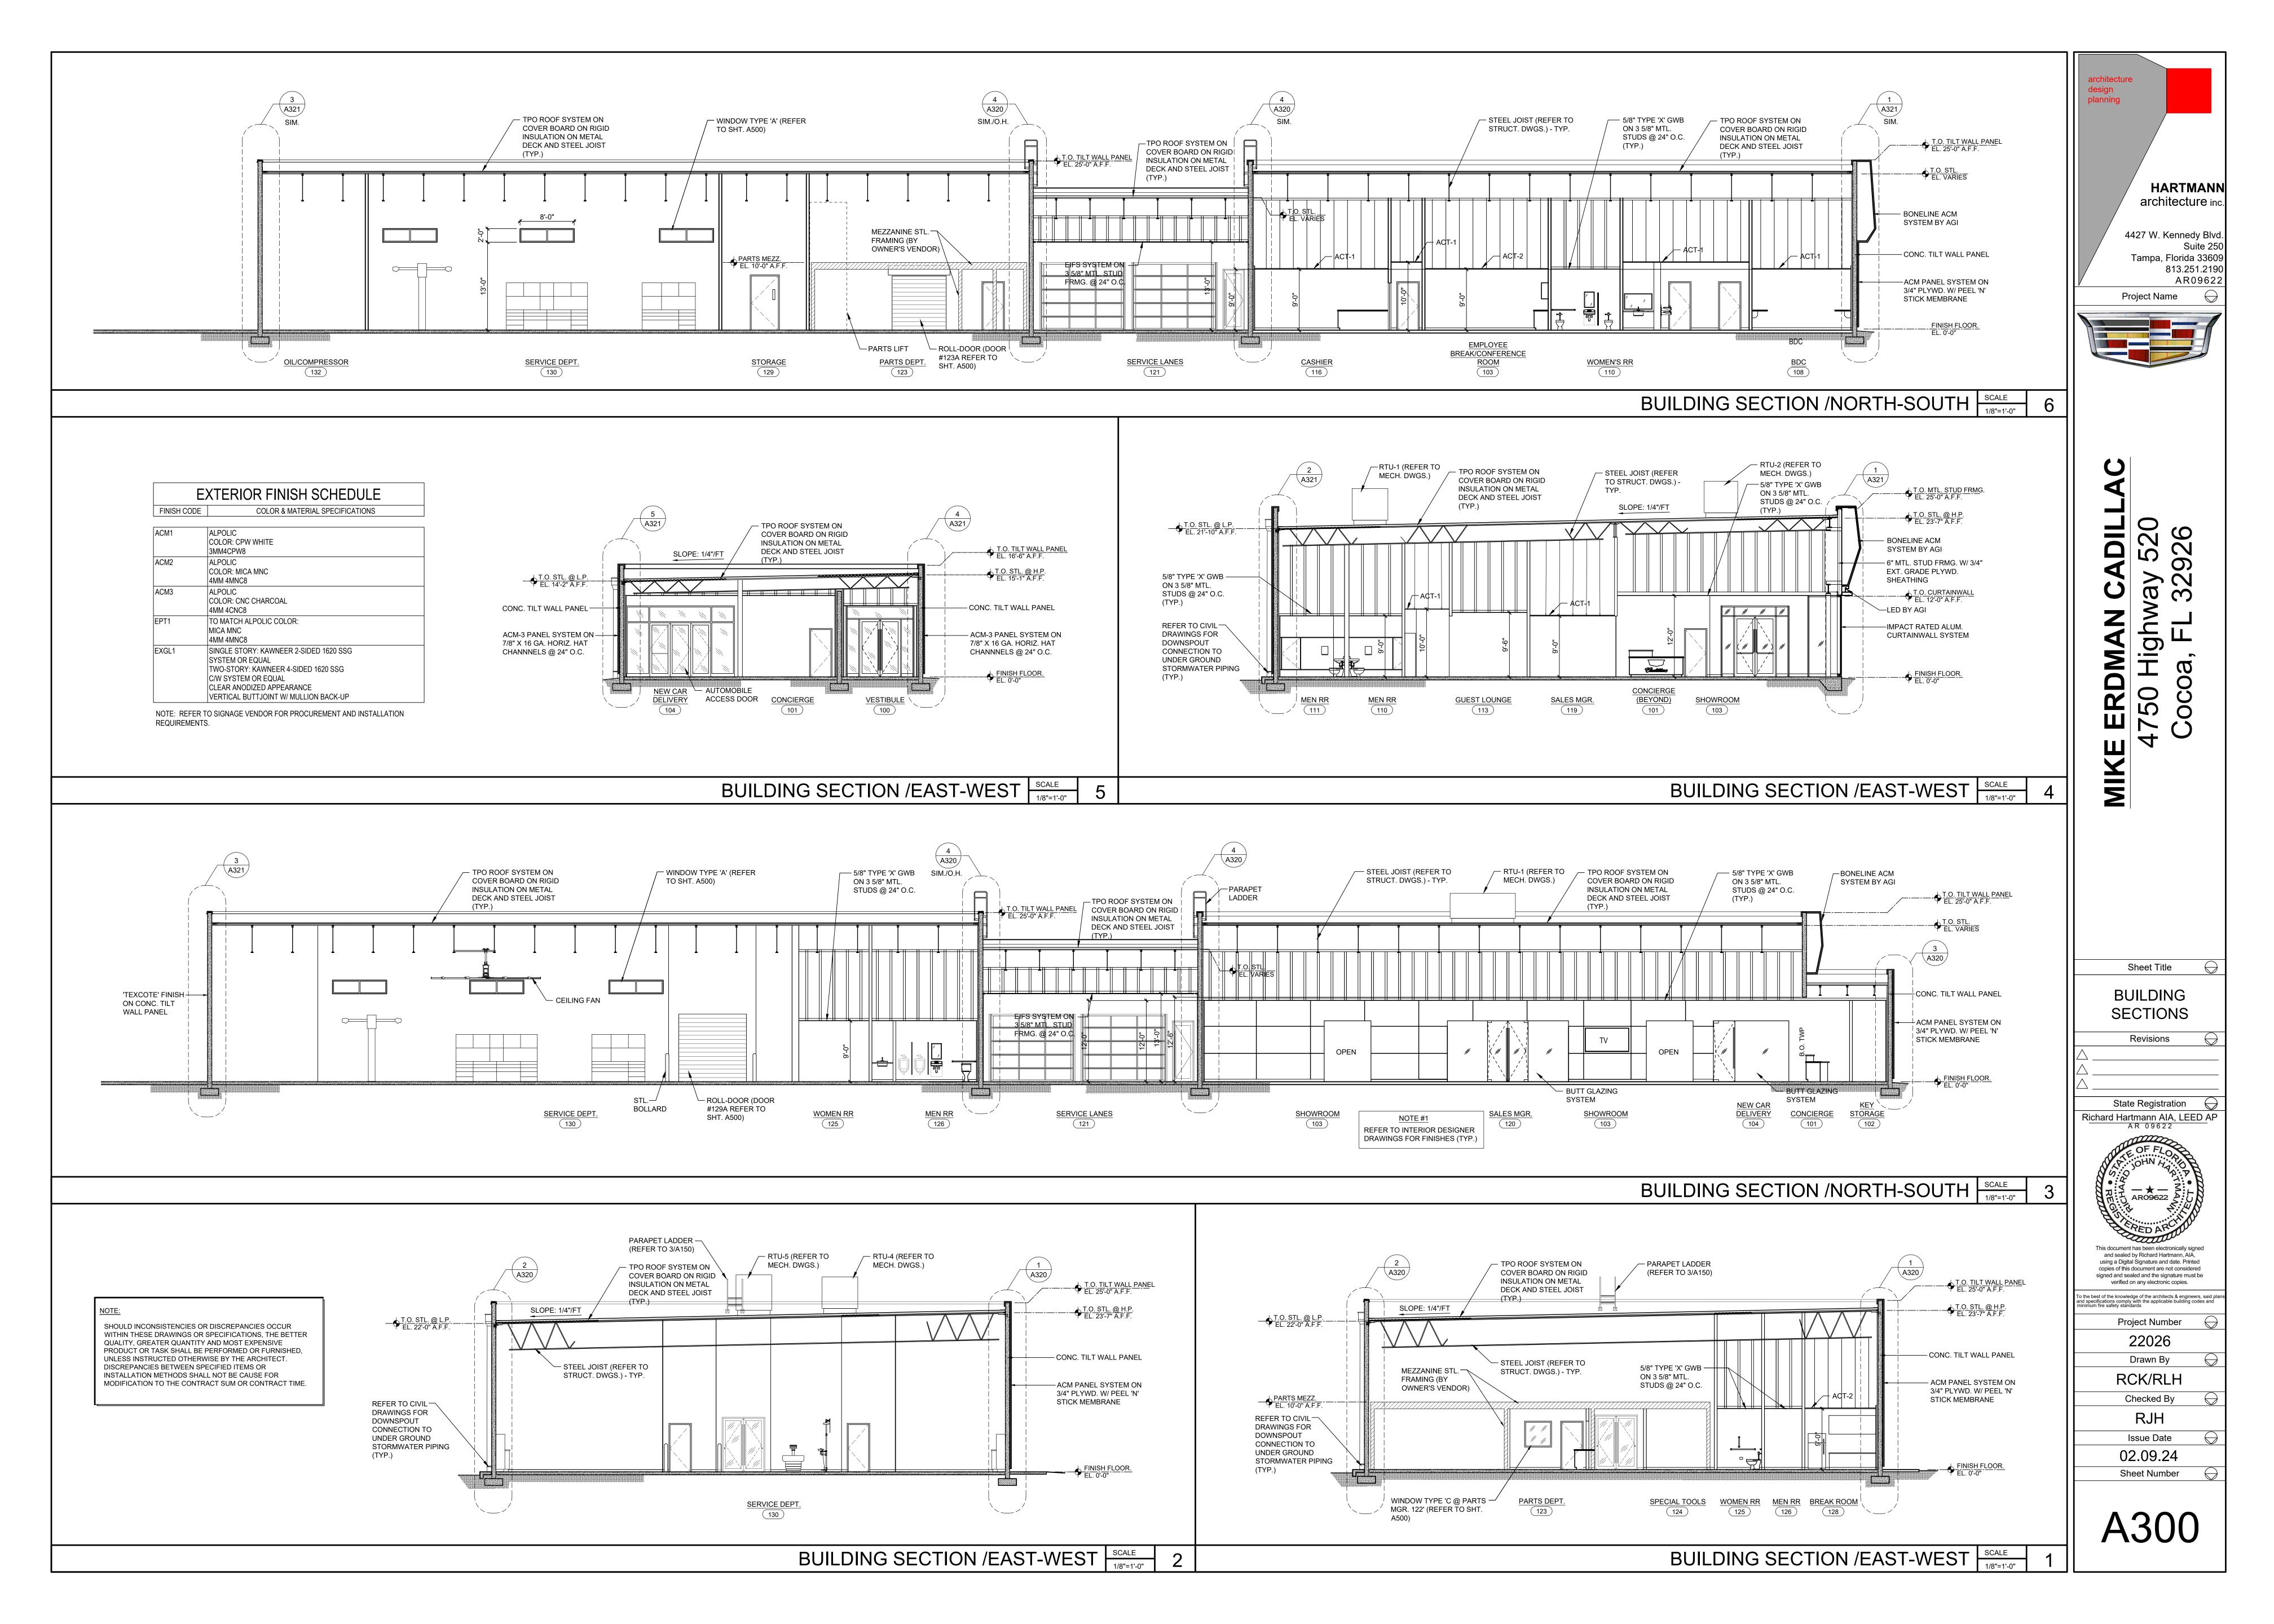

SHOULD INCONSISTENCIES OR DISCREPANCIES OCCUR WITHIN THESE DRAWINGS OR SPECIFICATIONS. THE BETTER QUALITY, GREATER QUANTITY AND MOST EXPENSIVE PRODUCT OR TASK SHALL BE PERFORMED OR FURNISHED, UNLESS INSTRUCTED OTHERWISE BY THE ARCHITECT. DISCREPANCIES BETWEEN SPECIFIED ITEMS OR HARTMANN INSTALLATION METHODS SHALL NOT BE CAUSE FOR MODIFICATION TO THE CONTRACT SUM OR CONTRACT TIME. architecture ind 4427 W. Kennedy Blvd. Tampa, Florida 33609 813.251.2190 AR09622 (REFER TO 3/A150) — ACM PARAPET CAP 50 - TPO ROOF SYSTEM ON — TPO ROOF SYSTEM ON CONC. TILT-WALL PANEL TPO ROOF SYSTEM ON CONC. TILT-WALL PANEL OVER LAP TPO ROOFING ——— CONC. TILT-WALL PANEL - OVER LAP TPO ROOFING OVER LAP TPO ROOFING — - TPO ROOF SYSTEM ON COVER SYSTEM @ PARAPET SYSTEM @ PARAPET — TPO ROOF SYSTEM ON COVER SYSTEM @ PARAPET BOARD ON RIGID INSULATION - TPO ROOF SYSTEM ON COVER BOARD ON RIGID INSULATION (TYP.) ON METAL DECK AND STEEL BOARD ON RIGID INSULATION MIKE ON METAL DECK AND STEEL GALV. MTL. COPING — JOIST (TYP.) ON METAL DECK AND STEEL — ACM PARAPET CAP JOIST (TYP.) JOIST (TYP.) T.O. TILT WALL PANEL EL. 25'-0" A.F.F. T.O. STL.
EL. VARIES SLOPE: 1/4"/FT. CONDUCTOR HEAD — (REFER TO ROOF T.O. STL. @ H.P. EL. 23'-7" A.F.F. TPO ROOF SYSTEM ON -PLAN - SHT. A150 FOR SLOPE: 1/4"/FT. CONC. TILT-WALL PANEL LOCATIONS) ACM PARAPET CAP ----T.O. STL. @ L.P. EL. 22'-0" A.F.F. TPO ROOF SYSTEM ON COVER — BOARD ON RIGID INSULATION ON METAL DECK AND STEEL JOIST (TYP.) T.O. STL. EL. VARIES - TPO ROOF SYSTEM ON CONC. TILT-WALL PANEL - TPO ROOF SYSTEM ON COVER BOARD ON RIGID INSULATION ON METAL DECK AND STEEL JOIST (TYP.) — ACM PARAPET CAP Sheet Title PAINT ON CONC.-WALL TILT WALL PANEL T.O. TILT WALL PANEL
EL. 16'-6" A.F.F. 'TEXCOTE' FINISH ON -CONC. TILT-WALL PANEL Revisions —CONC. TILT WALL PANEL PAINT ON CONC. EIFS CEILING
EL. 13'-0" A.F.F. TILT WALL PANEL - ACM PANEL SYSTEM W/ 40 MIL. PEEL 'n' STICK State Registration MEMBRANE ON 3/4" CDX Richard Hartmann AIA, LEED AP PLYWD. ON 16 GA. HORZ. AR 09622 HAT CHANNELS @ 24" O.C. EIFS SYSTEM ON — 5/8" TYPE 'X' — 3 5/8" MTL. STUD GWB ON 3 5/8" FRMG. @ 24" O.C. MTL. STUDS @ 5/8" TYPE 'X' — 24" O.C. (TYP.) GWB ON 3 5/8" CONT. 4" WIDE EIFS-MTL. STUDS @ DOWNSPOUT (REFER -SOFFIIT VENT SHOWROOM 24" O.C. (TYP.) TO ROOF PLAN - SHT. - APPLY A LIQUID WRB COATING (103) A150 FOR LOCATIONS) STUCCO ON CONC.-TO FACE OF CONC. TILT WALL TILT-WALL PANEL - 5/8" TYPE 'X' GWB (PAINT) U.O.N. KEY STORAGE —CONC. TILT WALL PANEL — 1 5/8" 22 GA. MTL. This document has been electronically signed STUDS @ 16" O.C. W/ SERVICE DEPT. EQUIP. (BY and sealed by Richard Hartmann, AIA, SERVICE DEPT. EQUIP. (BY —— ANGLE CLIPS AT 5'-0" SERVICE LANES OWNER'S VENDOR-TYP.) using a Digital Signature and date. Printed - ACM-3 PANEL SYSTEM ON OWNER'S VENDOR-TYP.) O.C. VERTICAL copies of this document are not considered 7/8" X 16 GA. HORZ. HAT HEIGHT (TYP.) signed and sealed and the signature must be CHANNNELS @ 24" O.C. verified on any electronic copies. 5/8" TYPE 'X' GWB ─── o the best of the knowledge of the architects & engineers, said plans and specifications comply with the applicable building codes and minimum fire safety standards (PAINT) U.O.N. – 2" THK. RIGID INSULATION BD. Project Number (R-13) 1 5/8" 22 GA. MTL. STUDS @ 16" O.C. W/ 22026 REFER TO CIVIL— ANGLE CLIPS AT 5'-0" DRAWINGS FOR O.C. VERTICAL DOWNSPOUT CONNECTION TO Drawn By HEIGHT (TYP.) UNDER GROUND RCK/RLH STORMWATER PIPING — REINF. CONC. SLAB ON TERMITE TREATED 2" THK. RIGID —— INSULATION BD. (R-13) REINF. CONC. SLAB ON TERMITE TREATED COMPACTED FILL (TYP.) REINF. CONC. SLAB ON TERMITE TREATED COMPACTED FILL Checked By COMPACTED FILL FIN. FLOOR EL. 0'-0" CONC. —— CURB RJH Issue Date 02.09.24 Sheet Number 1/2" EXP. BD. (TYP.) — 1/2" EXP. BD. (TYP.) -FOUNDATION (REFER — TO STRUCT. DWGS.) FOUNDATION (REFER TO STRUCT. DWGS.) FOUNDATION (REFER-FOUNDATION (REFER TO STRUCT. DWGS.) A320 TO STRUCT. DWGS.) WALL SECTION SCALE 1/2"=1'-0" WALL SECTION SCALE
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3400 CORPORATE WAY SUITE A

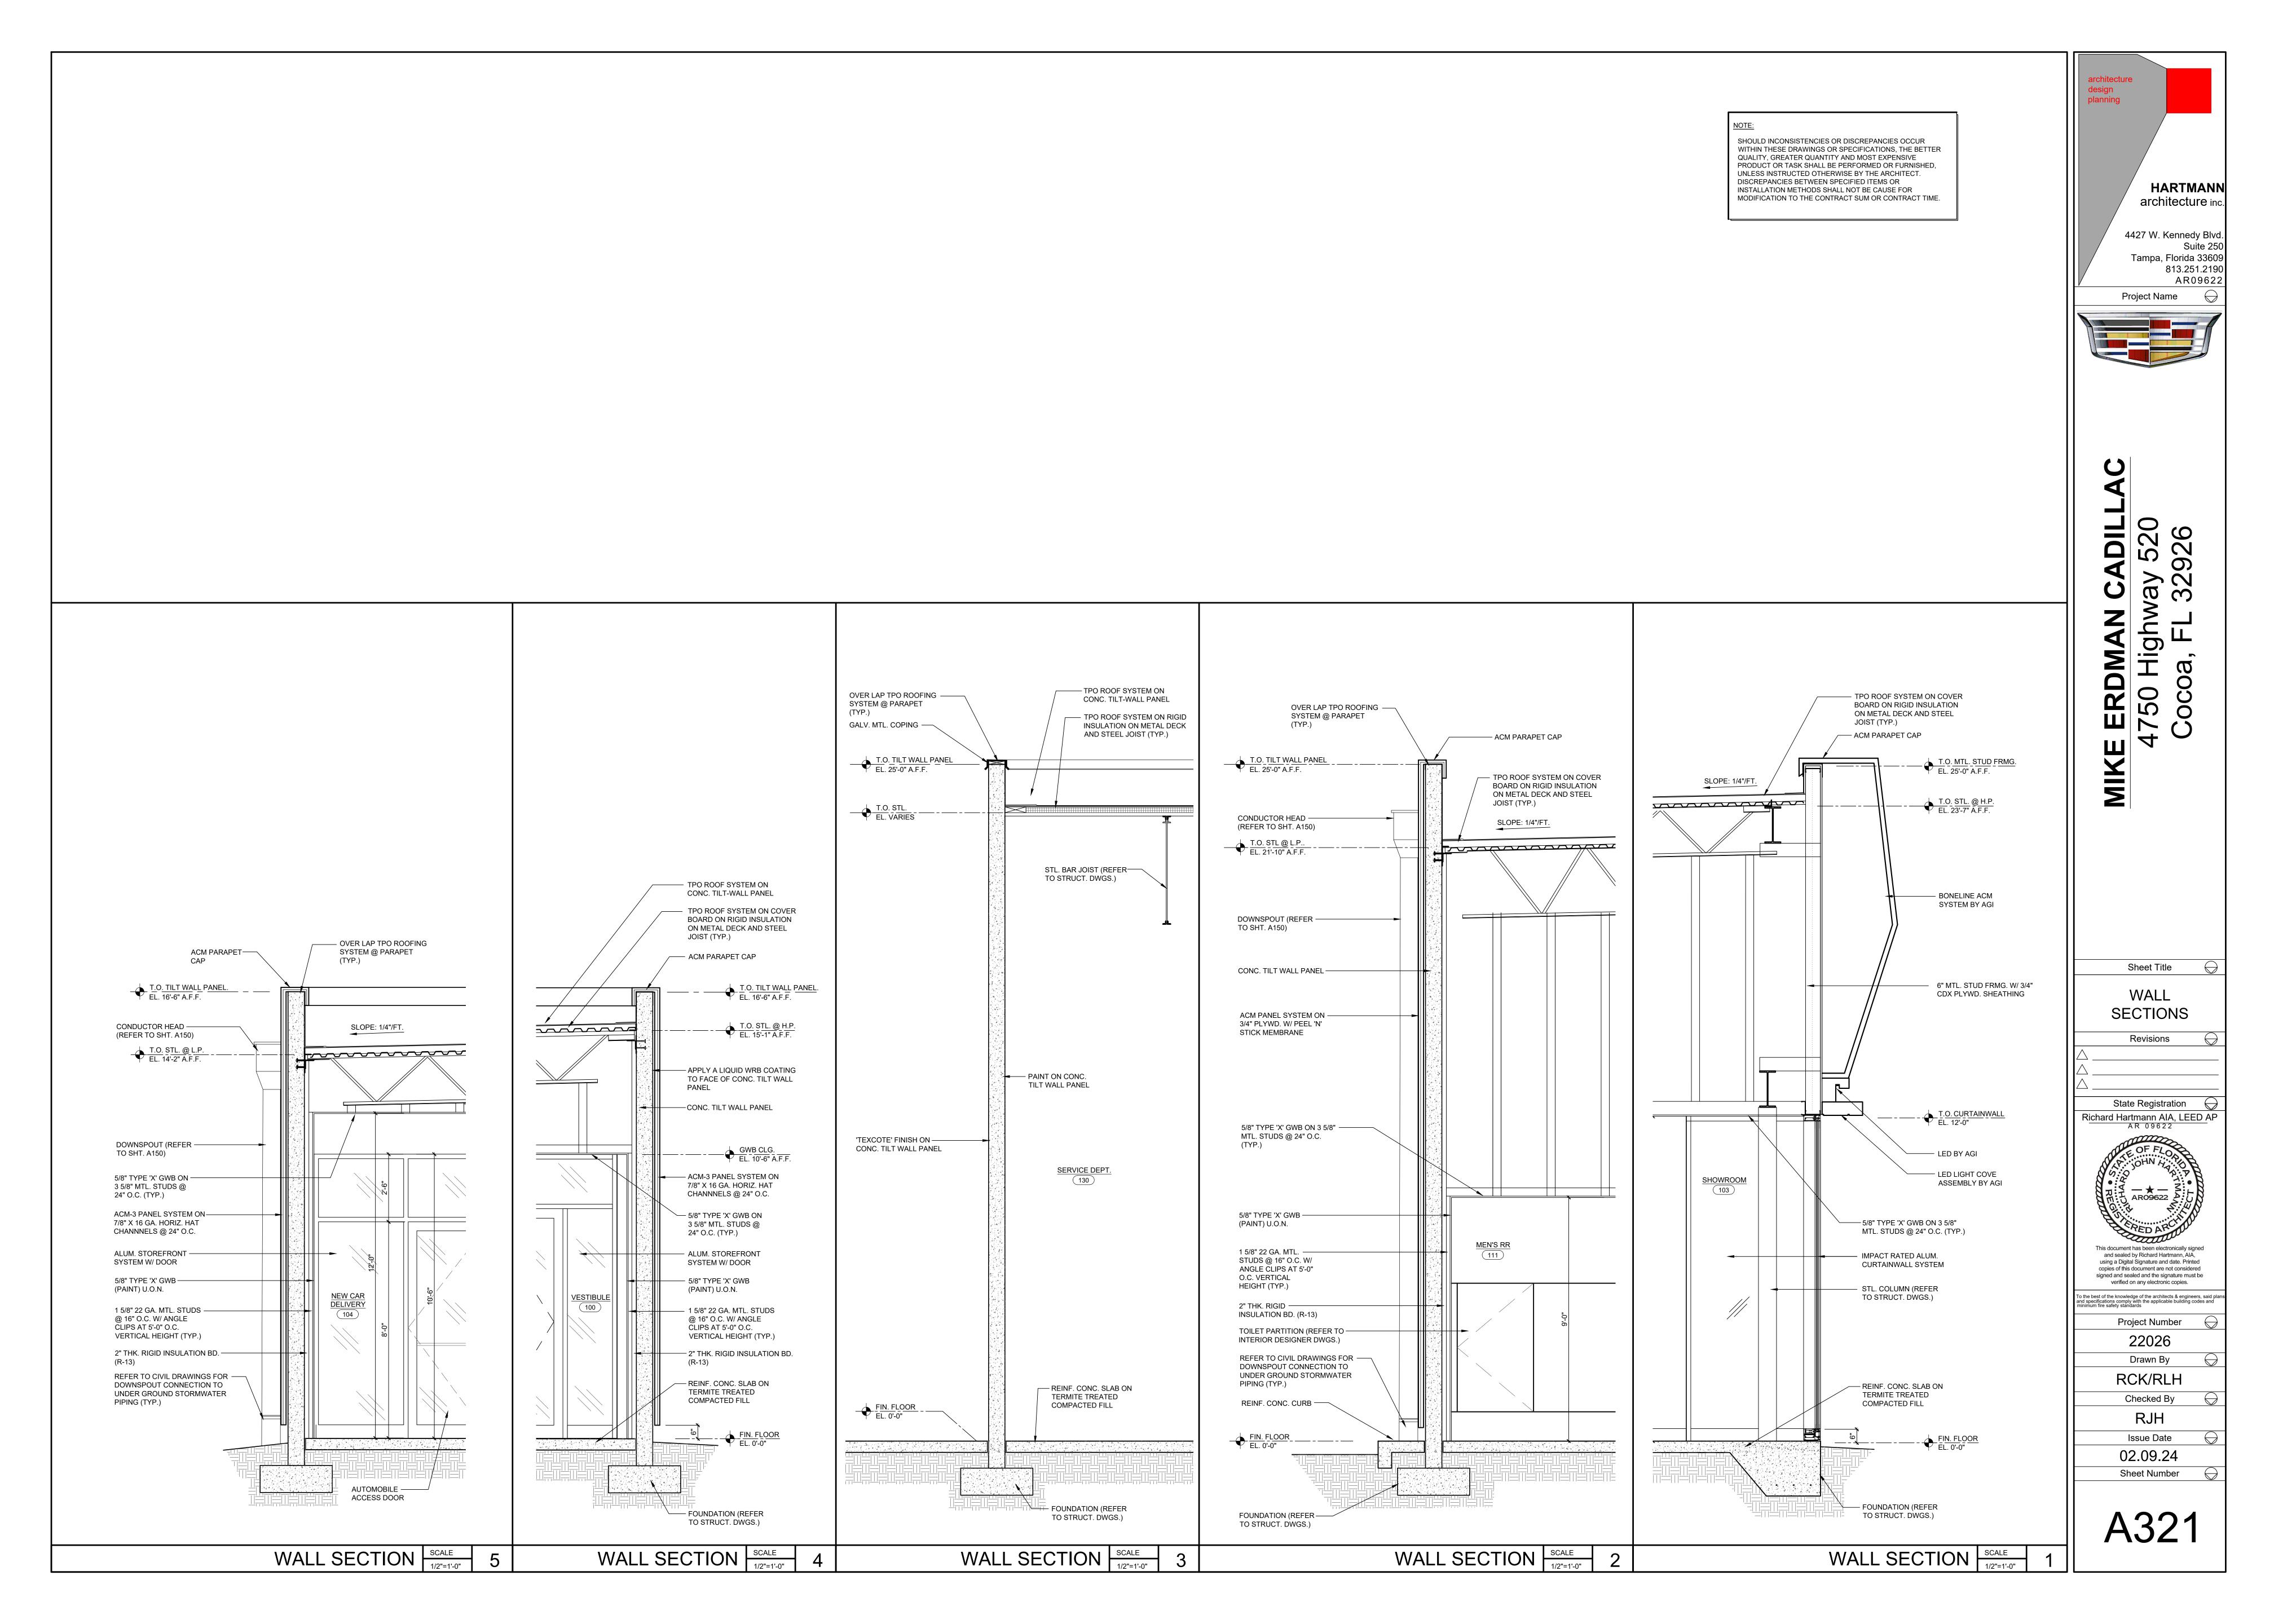DULUTH, GA 30096

770 - 274 - 3500 OFFICE

770 - 349 - 3461 FAX

Dealer Solutions
& Design IIc

## OWNER EQUIPMENT VENDOR


\*\*NOTE: STEEL HOSE REEL BRACKETS BY G.C. COORDINATE W/ EQUIPMENT VENDOR - SEE 3/A110

NOTE:


SHOULD INCONSISTENCIES OR DISCREPANCIES OCCUR
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QUALITY, GREATER QUANTITY AND MOST EXPENSIVE
PRODUCT OR TASK SHALL BE PERFORMED OR FURNISHED,
UNLESS INSTRUCTED OTHERWISE BY THE ARCHITECT.
DISCREPANCIES BETWEEN SPECIFIED ITEMS OR
INSTALLATION METHODS SHALL NOT BE CAUSE FOR
MODIFICATION TO THE CONTRACT SUM OR CONTRACT TIME.

## \*\* FOR REFERENCE ONLY

MEP SCHEDULE FOR Dealer Solutions and Design						
Symbols	Equipment	Manufacturer	Voltage	Phase	HP/Amp	Comments
AC	Air Compressor	Saylor Beall	230	3	5hp/16A	2- Connections by GC. Disconnects per local code. Includes Mag Starters mounted and prewired to motors
AD	Air Dryer 20-165CFM	Saylor Beall	115	1	9 A	Quad Outlet. Disconnects per local code.
AF	Air Fan 16-24'	Eurovent	460	3	3 A	Connections by GC. Fused Disconnect.
AFC	Air Fan Controller	Eurovent				Conduit in the wall down to a J-Box 60" AFF. Cat 5 cable to be ran by DSD to fans.
ALP	Align Lift Power	Hunter Engineering	208 / 230	1	26 A	Connections by GC. Disconnects per local code.
AM	Align Machine	Hunter Engineering	115	1	6 A	Duplex Outlet. Isolated Ground. Data Jack Required
BL	Brake Lathe	Hunter Engineering	115	1	15 A	Duplex Outlet.
DP	Data Port					Data Jack Required. By GC
EB	Exhaust Blower	Eurovent	460	3	3hp / 4 A	Connections by GC. Disconnects per local code.
EBC	Exhaust Blower Control	Eurovent	460	3	3hp / 4 A	Mag Starter provided by DSD. Installed by GC.
ED	Electric Drain	Saylor Beall	115	1	2A	Quad Outlet
ER	Electric Reel	Graco	115	1	25 A	Duplex Outlet mounted on reel bank. GFCI Breaker Req
FD	Floor Drain					Floor Drain by GC
FT	Pulse Hub	Graco	115	1	15 A	Duplex Outlet, Data Jack, & Iso Ground Required. 96" AFF
LP1	Lift Power Unit	Rotary Lift	208 / 230	1	2hp / 20 A	Connections by GC. Disconnects per local code.
PL	Parts Lift	CIP	460	3	5 A	Connections by GC. Disconnects per local code.
PS	Power Strip	Shure	115	1	25 A	Duplex Outlet
RC	Roof Curb	GC				Specs for curbing in Specification Book
SE	Small Equipment	Various	115	1	15 A	Duplex Outlet
TC1	Tire Changer	Hunter Engineering	208 / 230	1	15 A	Use NEMA Recepticle L6-20R
TM	Tank Monitor	BJ Enterprises	115	1	2 A	Duplex Outlet 72" AFF
WB	Wheel Balancer	Hunter Engineering	208 / 230	1	10 A	Use NEMA Recepticle L6-20R
WR	Water Reel	GC				½" Water supply w/ Ball Valve, ½" NPT

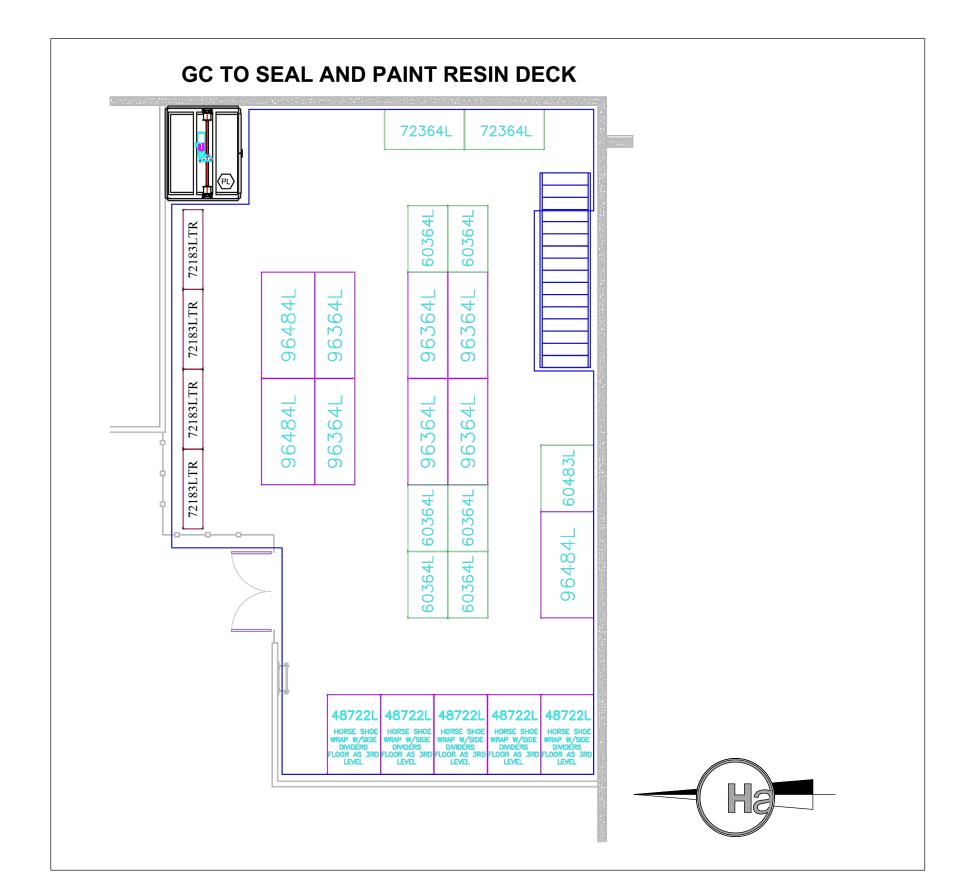

EQUIPMENT VENDOR REFERENCE PLAN - MEZZANINE SCALE NTS 2

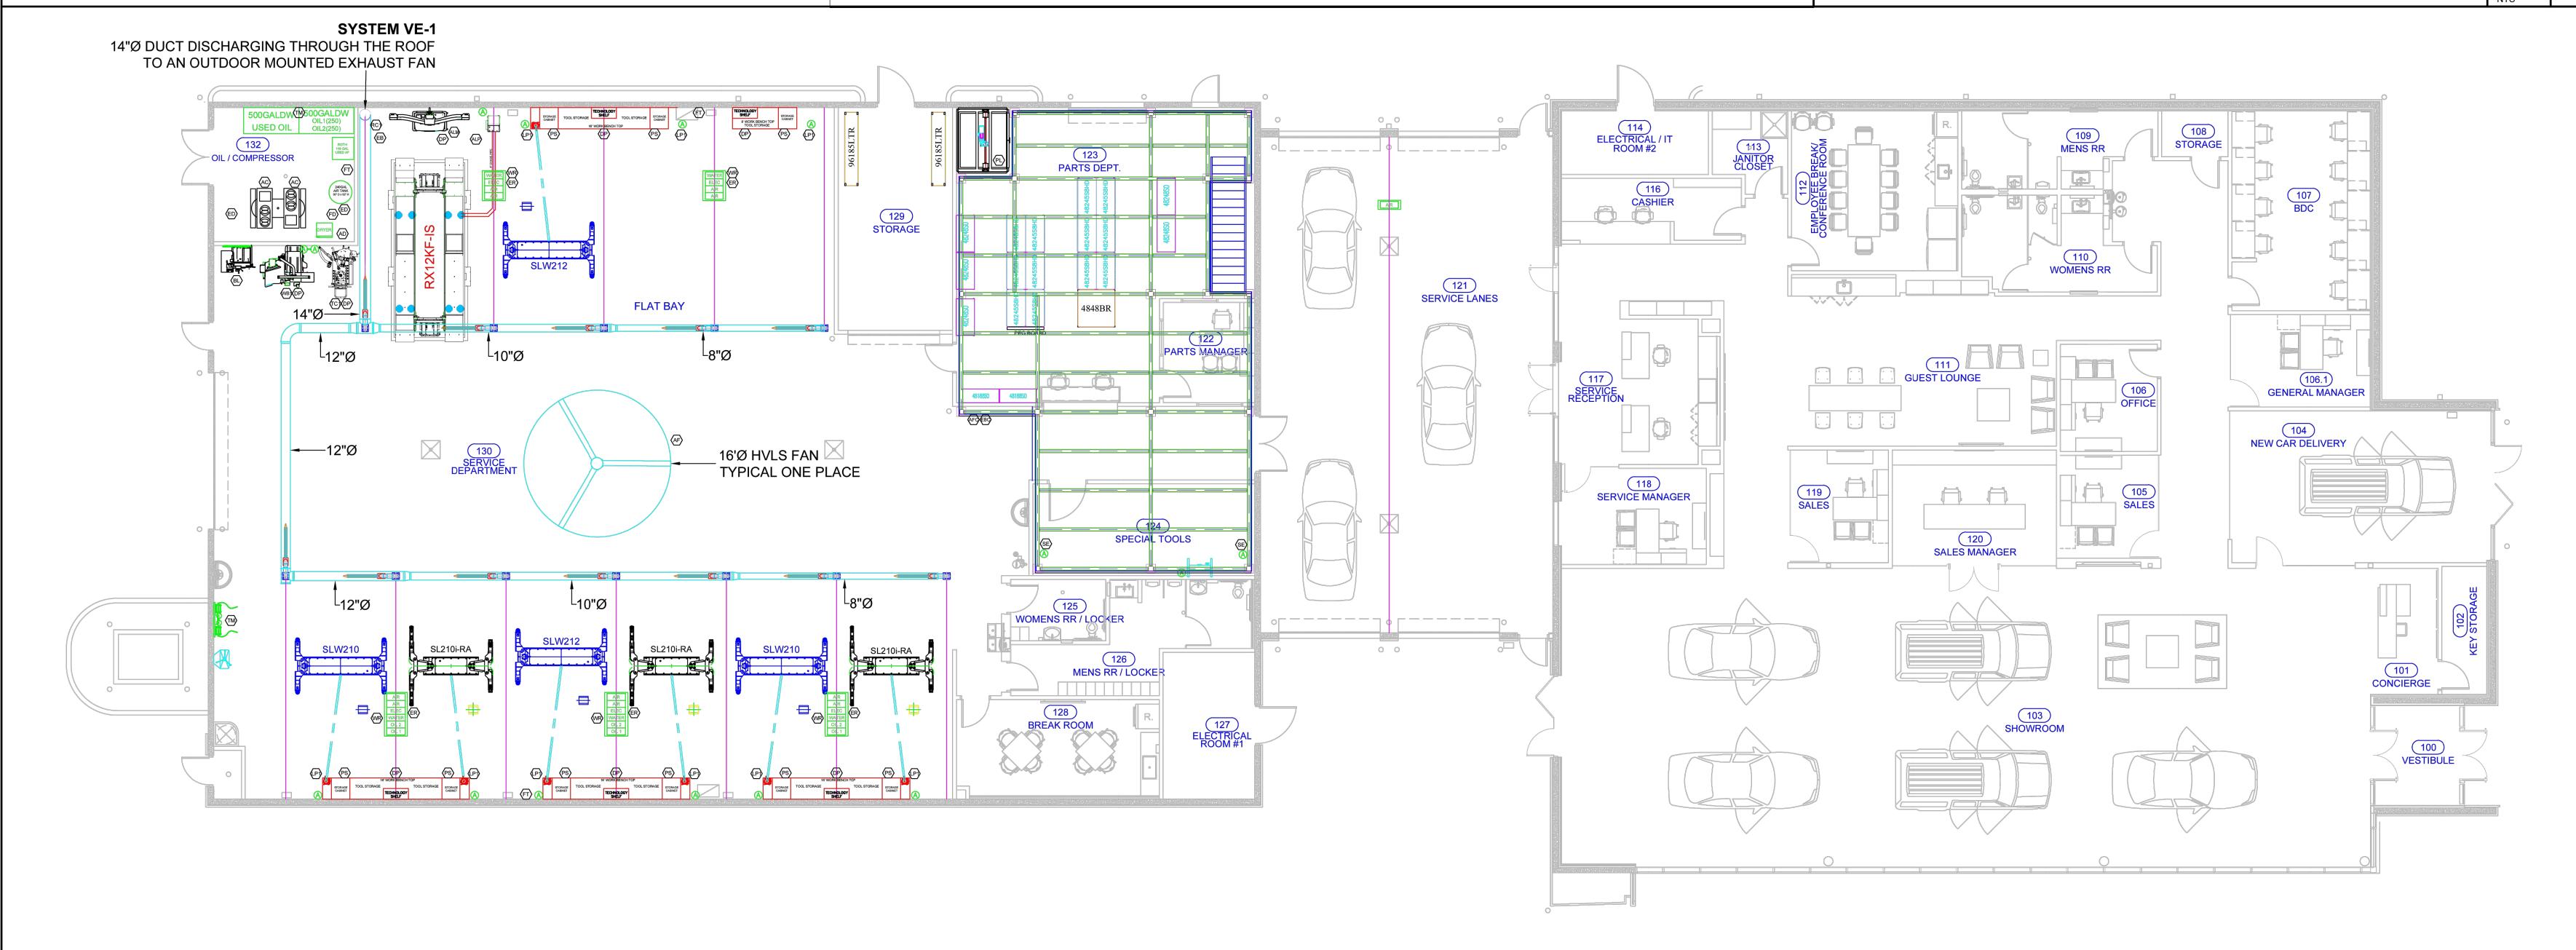

\*\* FOR REFERENCE ONLY



EQUIPMENT VENDOR REFERENCE PLAN SCALE NTS

HARTMANN
architecture inc.


4427 W. Kennedy Blvd.
Suite 250
Tampa, Florida 33609
813.251.2190
AR09622
Project Name

MIKE ERDMAN CAD
4750 Highway 5

Sheet Title

EQUIPMENT VENDOR
REFERENCE PLAN

Revisions

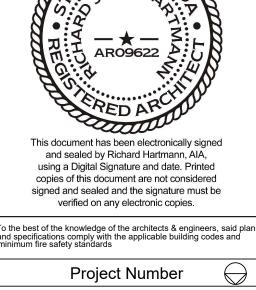

Project Number

22026


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RJH
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Sheet Number

A350




NOTE:

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NOTE:

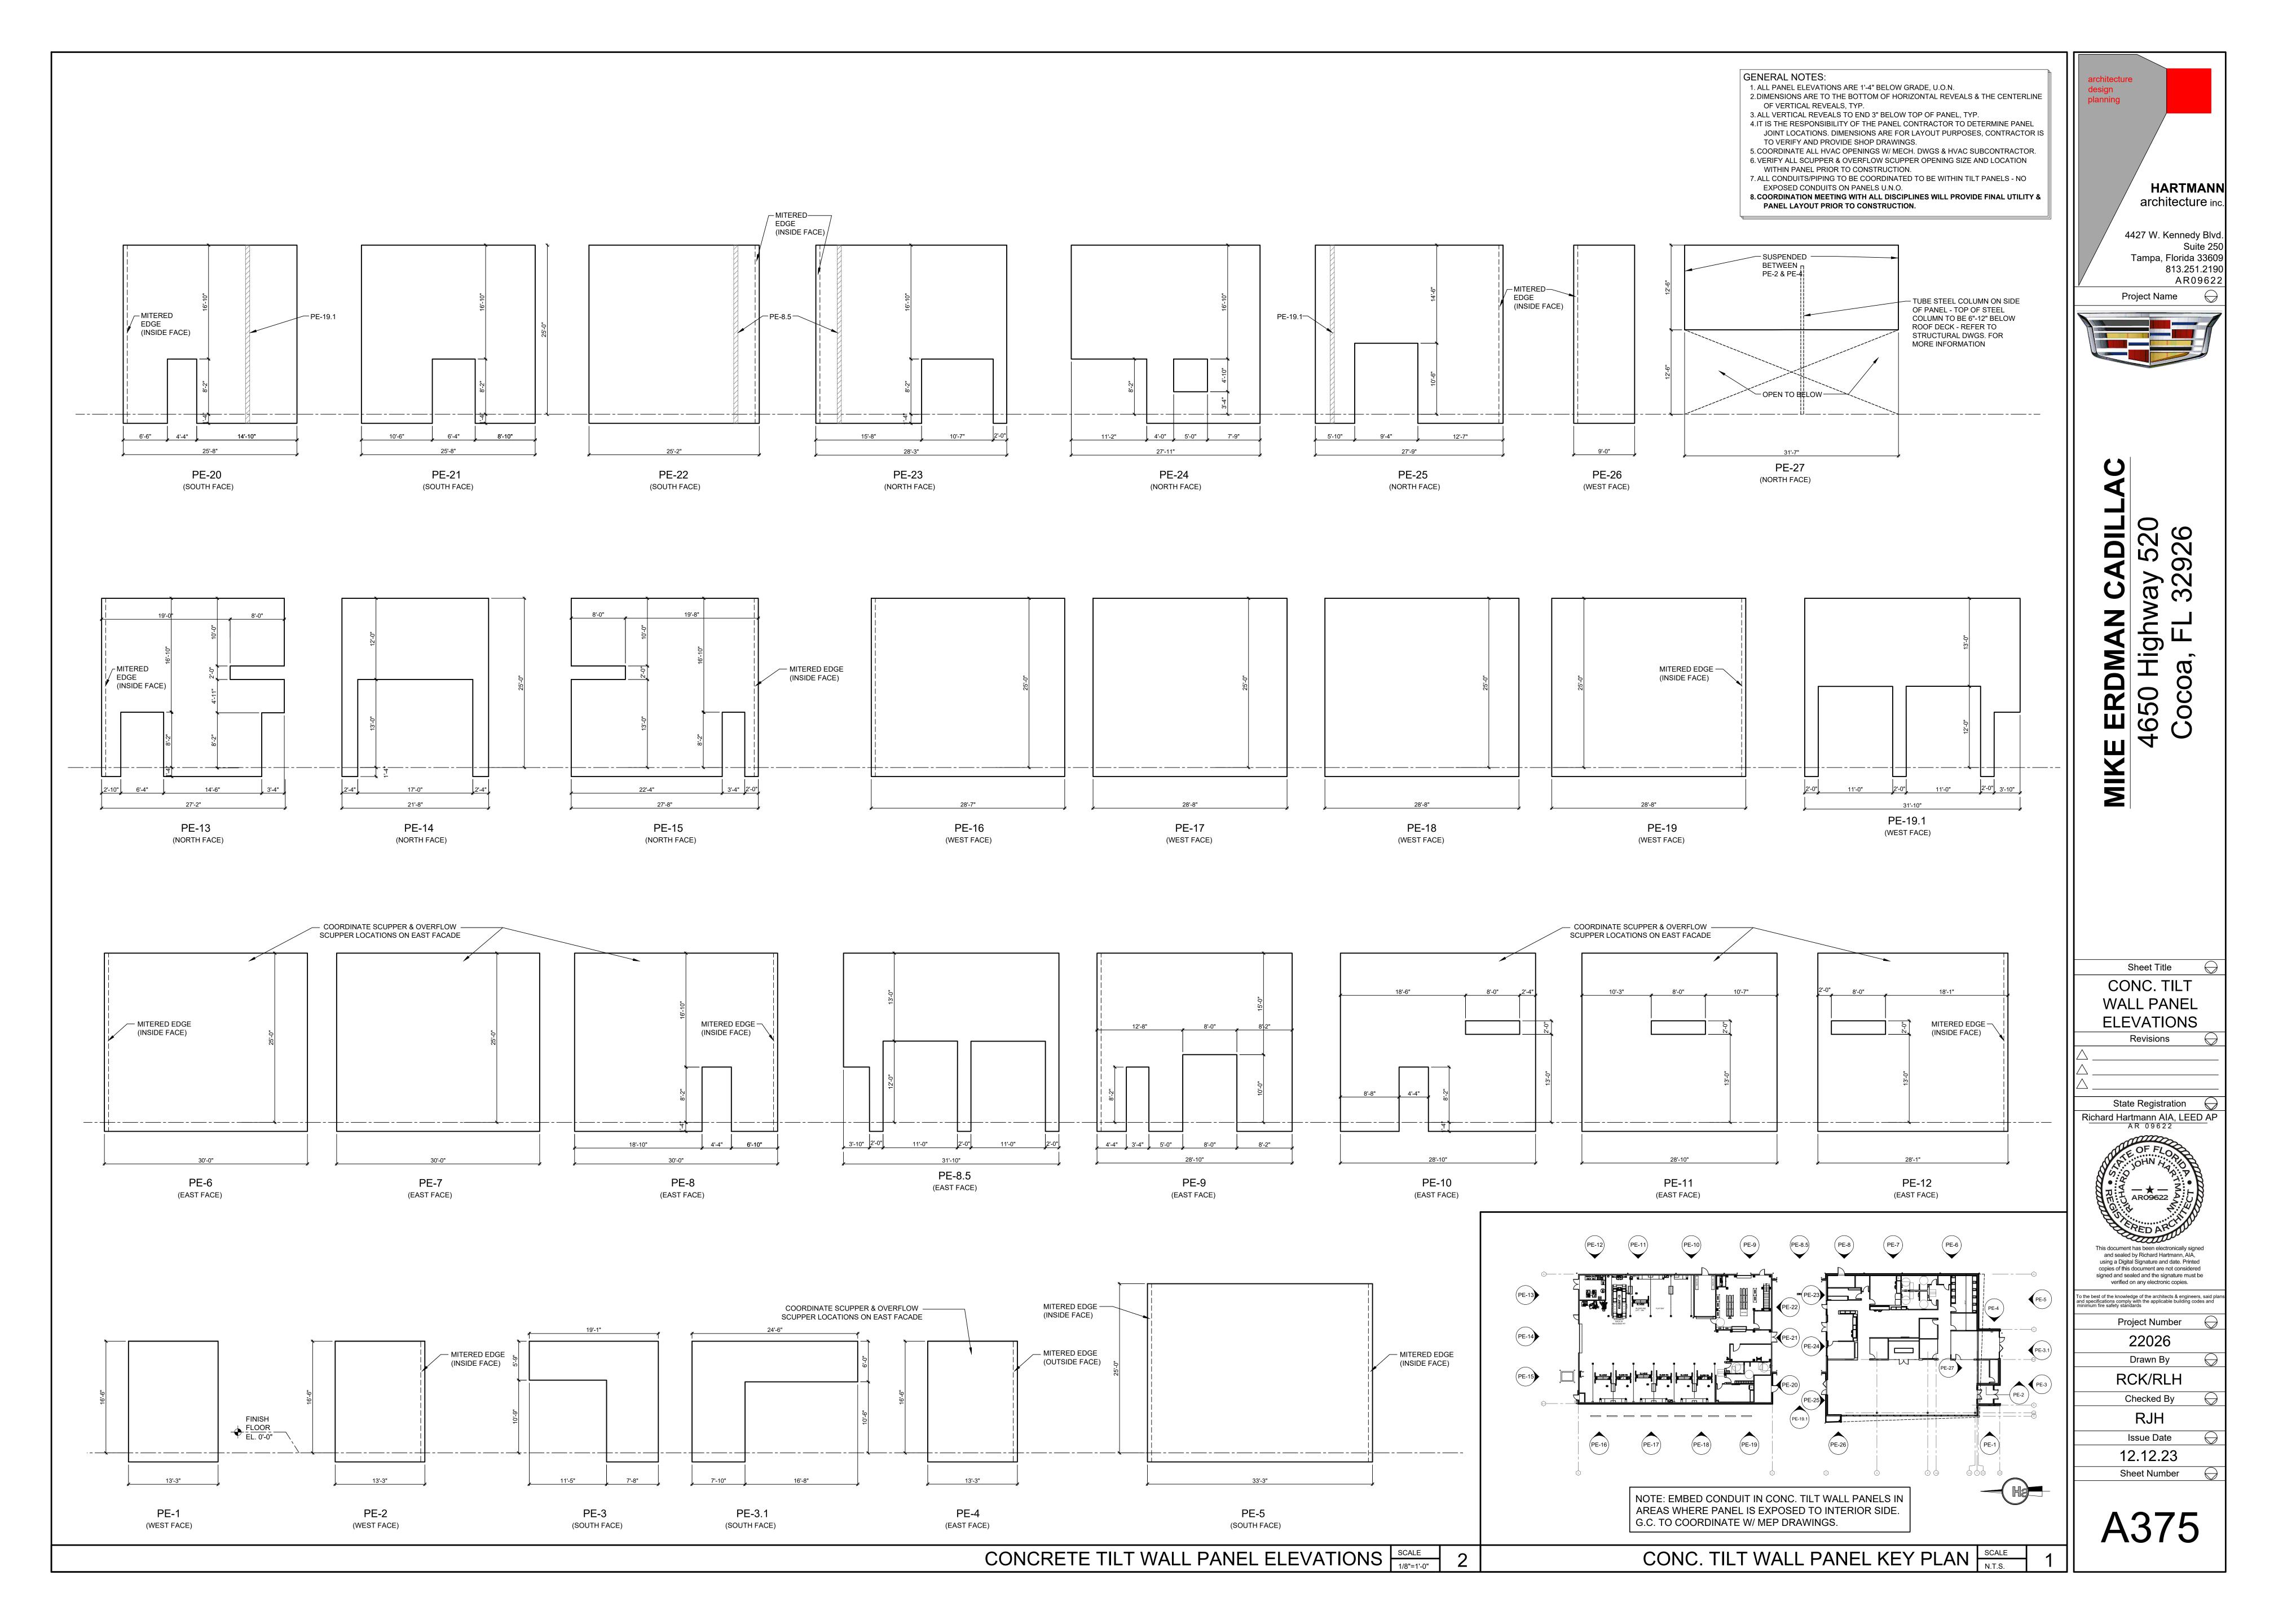SEE SHEET A024 FOR UL ASSEMBLIES. ALL MASONRY FIRE WALLS SHALL BE SECURED AT TOP (HEAD OF WALL) UL SYSTEM No. HW-D-0007. ALL STUD WALLS SHALL BE SECURED AT TOP (HEAD OF WALL) UL SYSTEM No. HW-D-0001. SEE NOTES ON SHEET A024 FOR MORE INFORMATION

PROVIDE CEMENT BACKER BOARD IN LIEU OF GWB AT ALL PARTITIONS TO RECEIVE TILE FINISH (SEE ROOM FINISH SCHEDULE ID1.0).

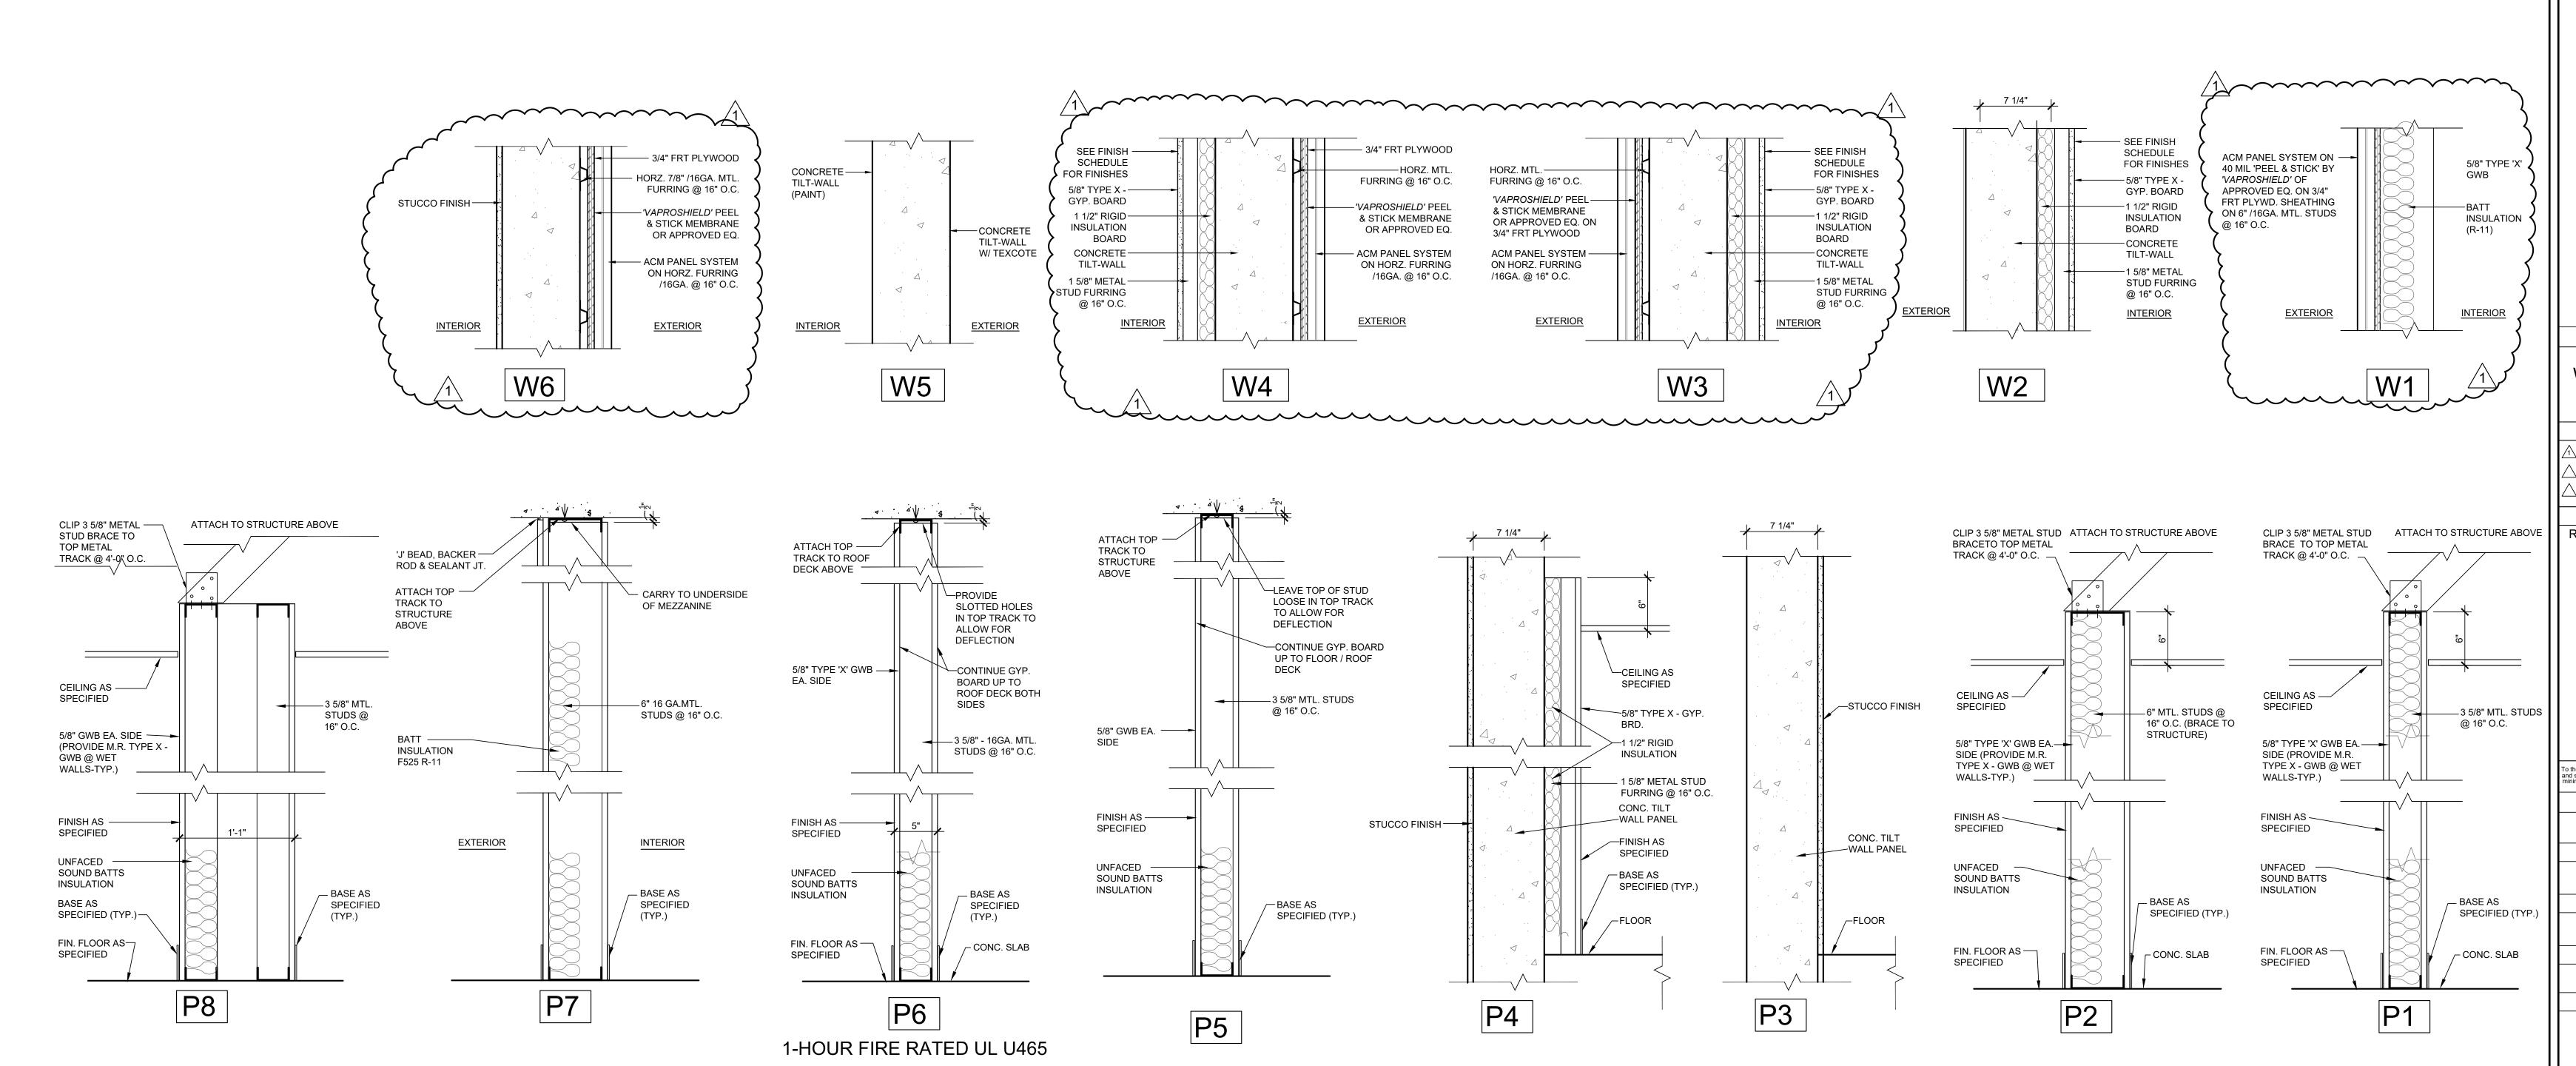

HARTMANN architecture ind 4427 W. Kennedy Blvd. Tampa, Florida 33609 813.251.2190 AR09622 Project Name E ERD 4750 | MIKE

Object Title

Sheet Title

WALL & PARTITION

TYPES

Revisions

MISC. REVISIONS

02.15.23

State Registration

State Registration

Richard Hartmann AIA, LEED AP

AR 09622

AR09622

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To the best of the knowledge of the architects & engineers, said plans and specifications comply with the applicable building codes and minimum fire safety standards

Project Number

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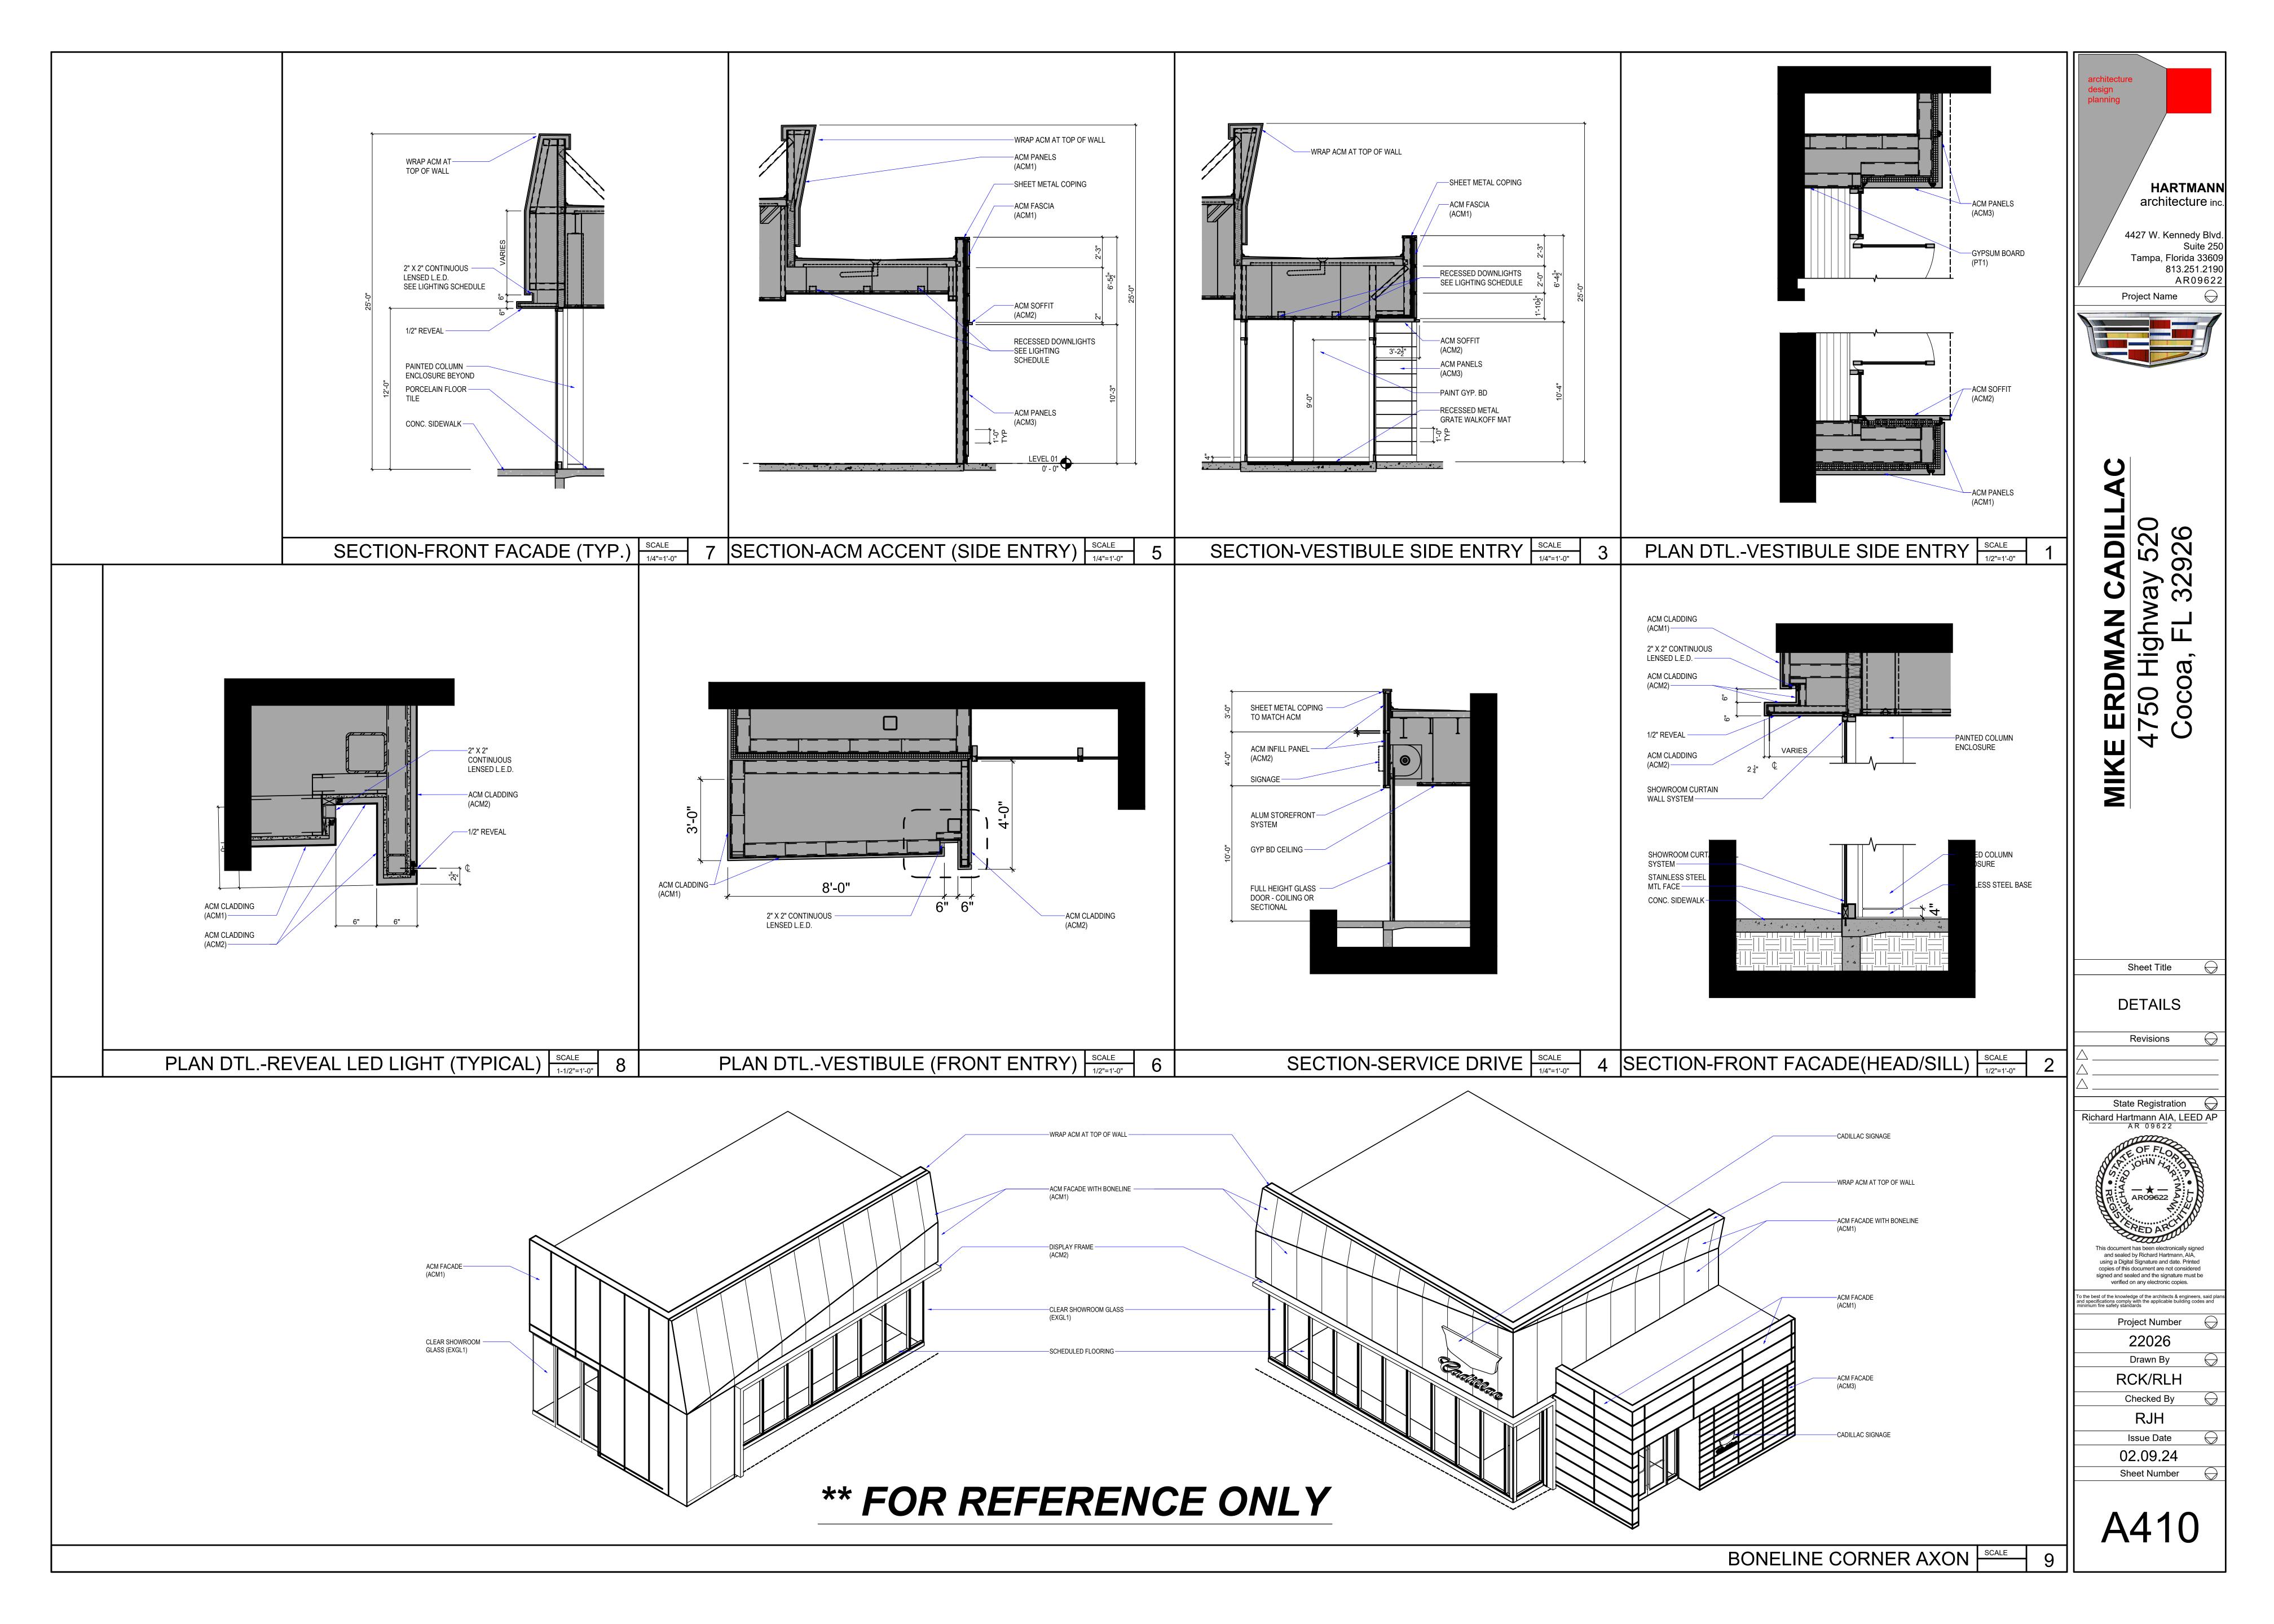
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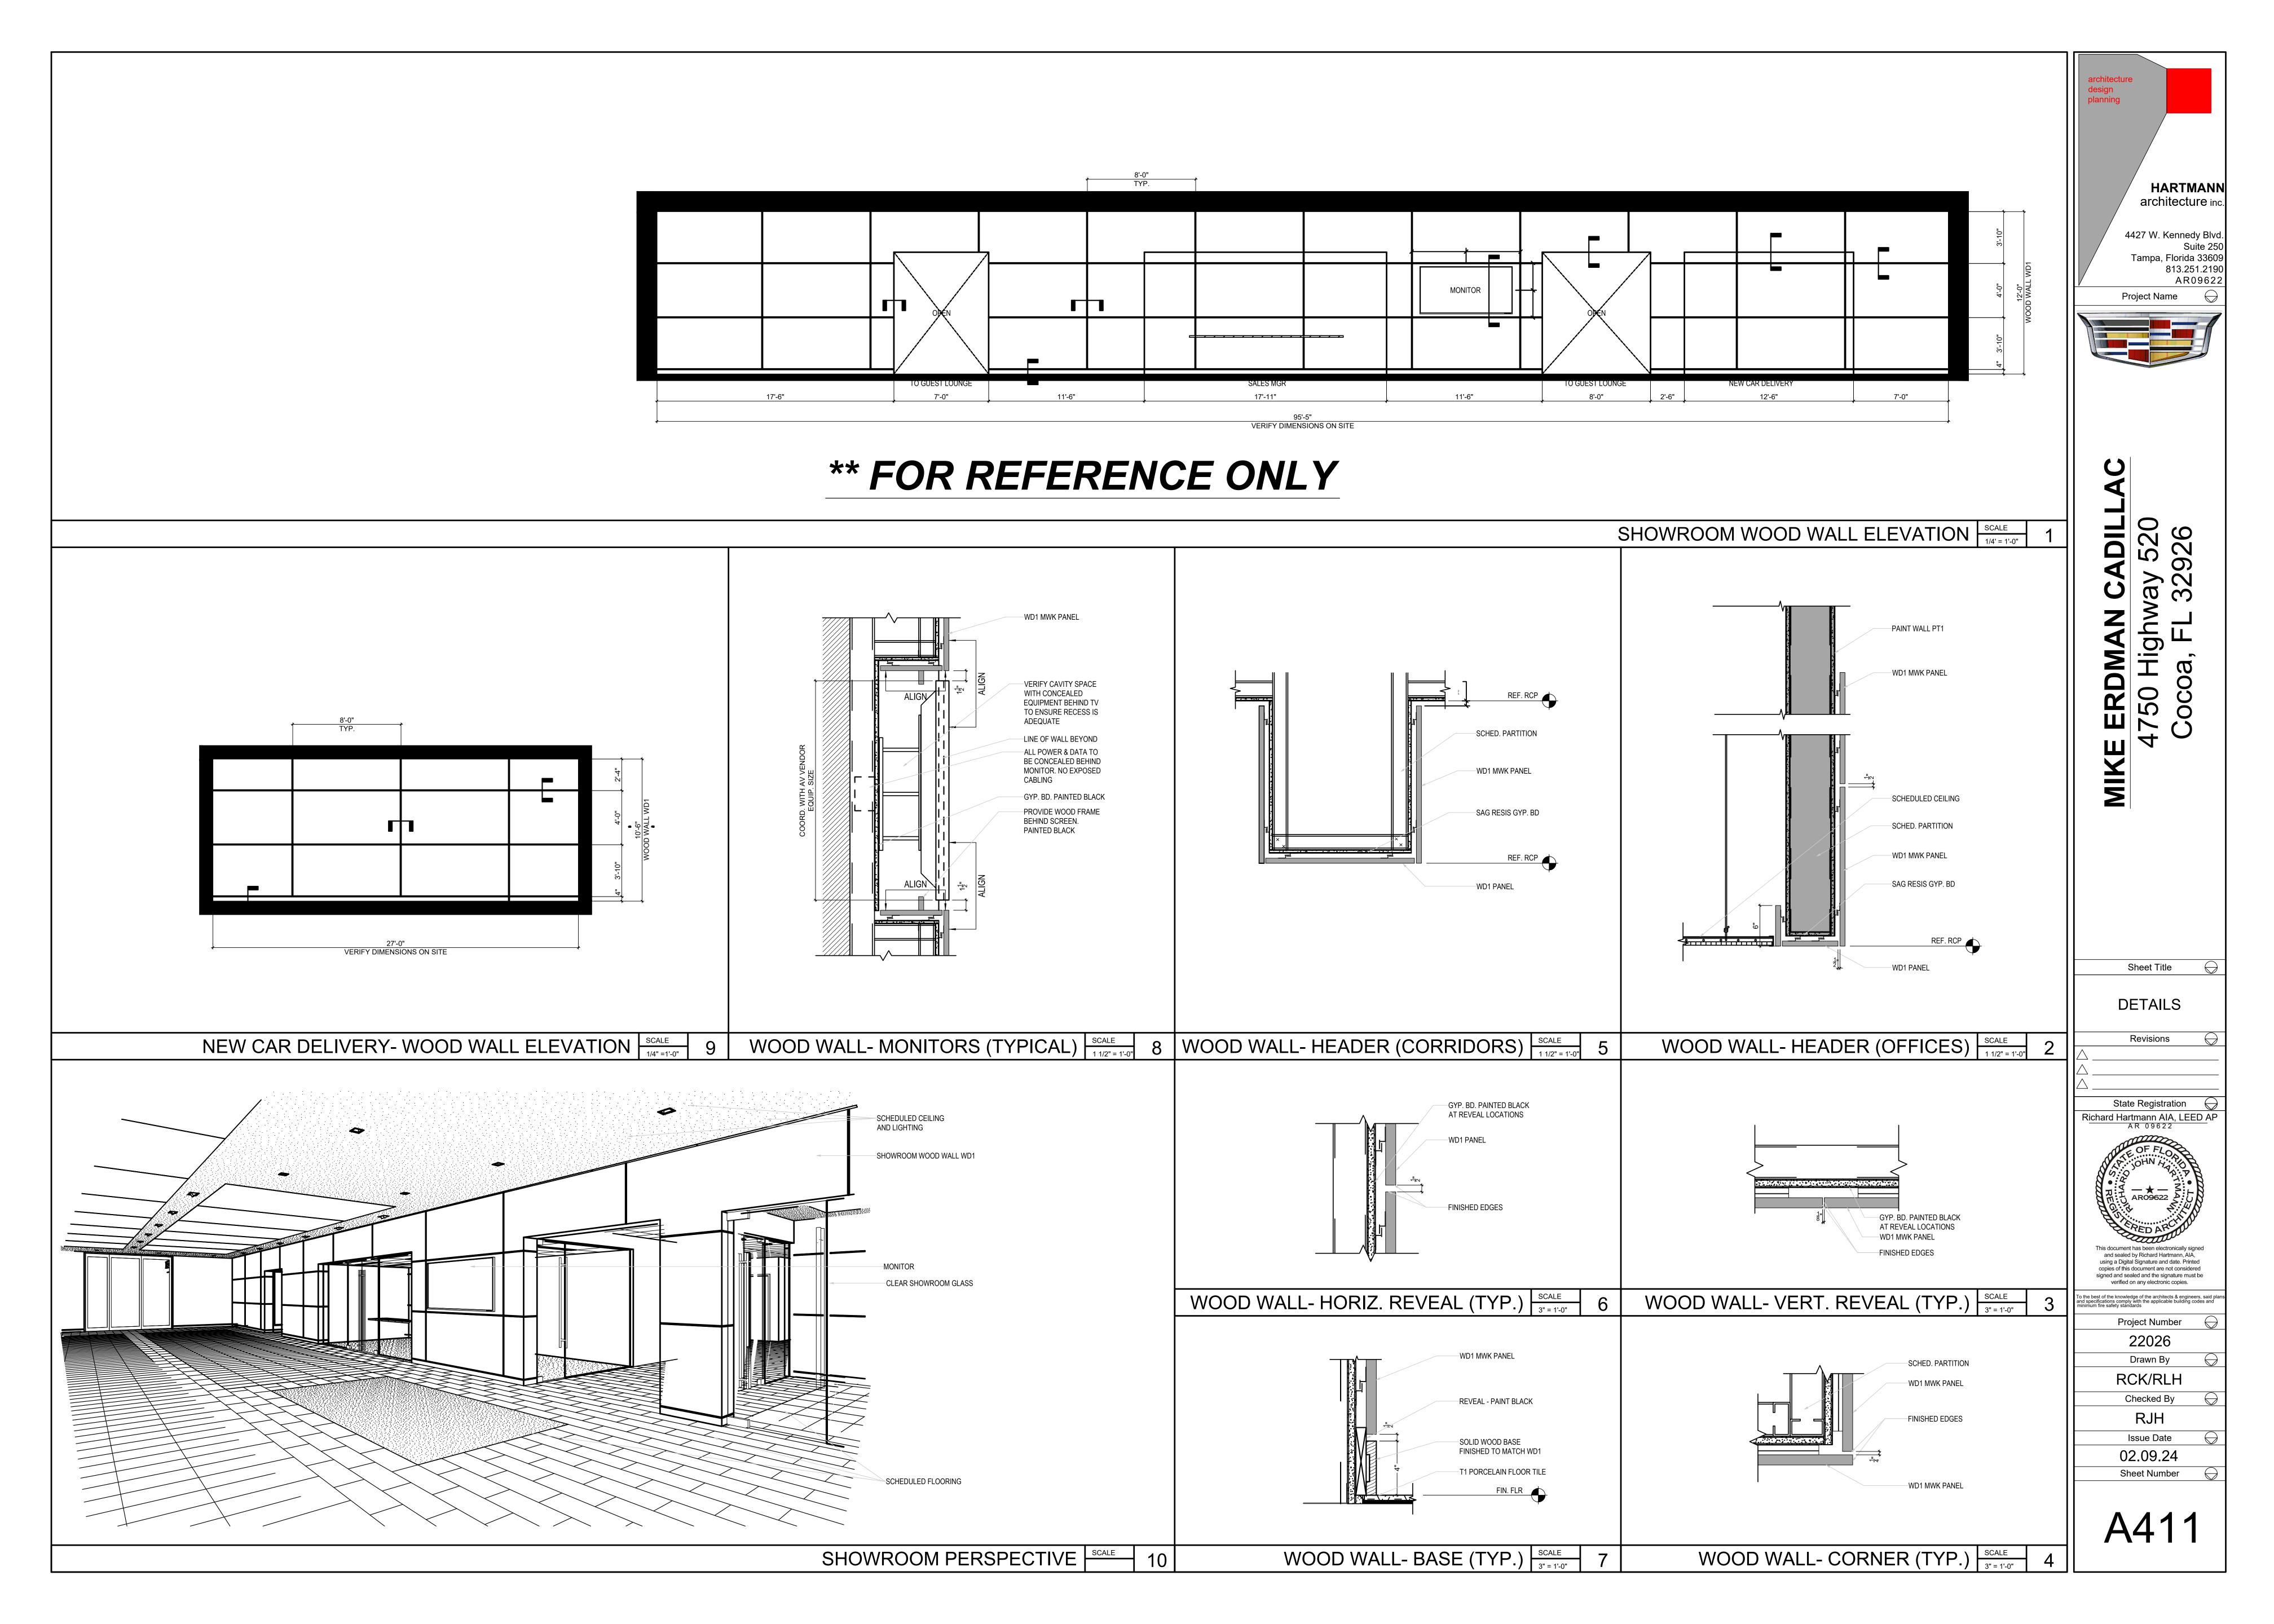
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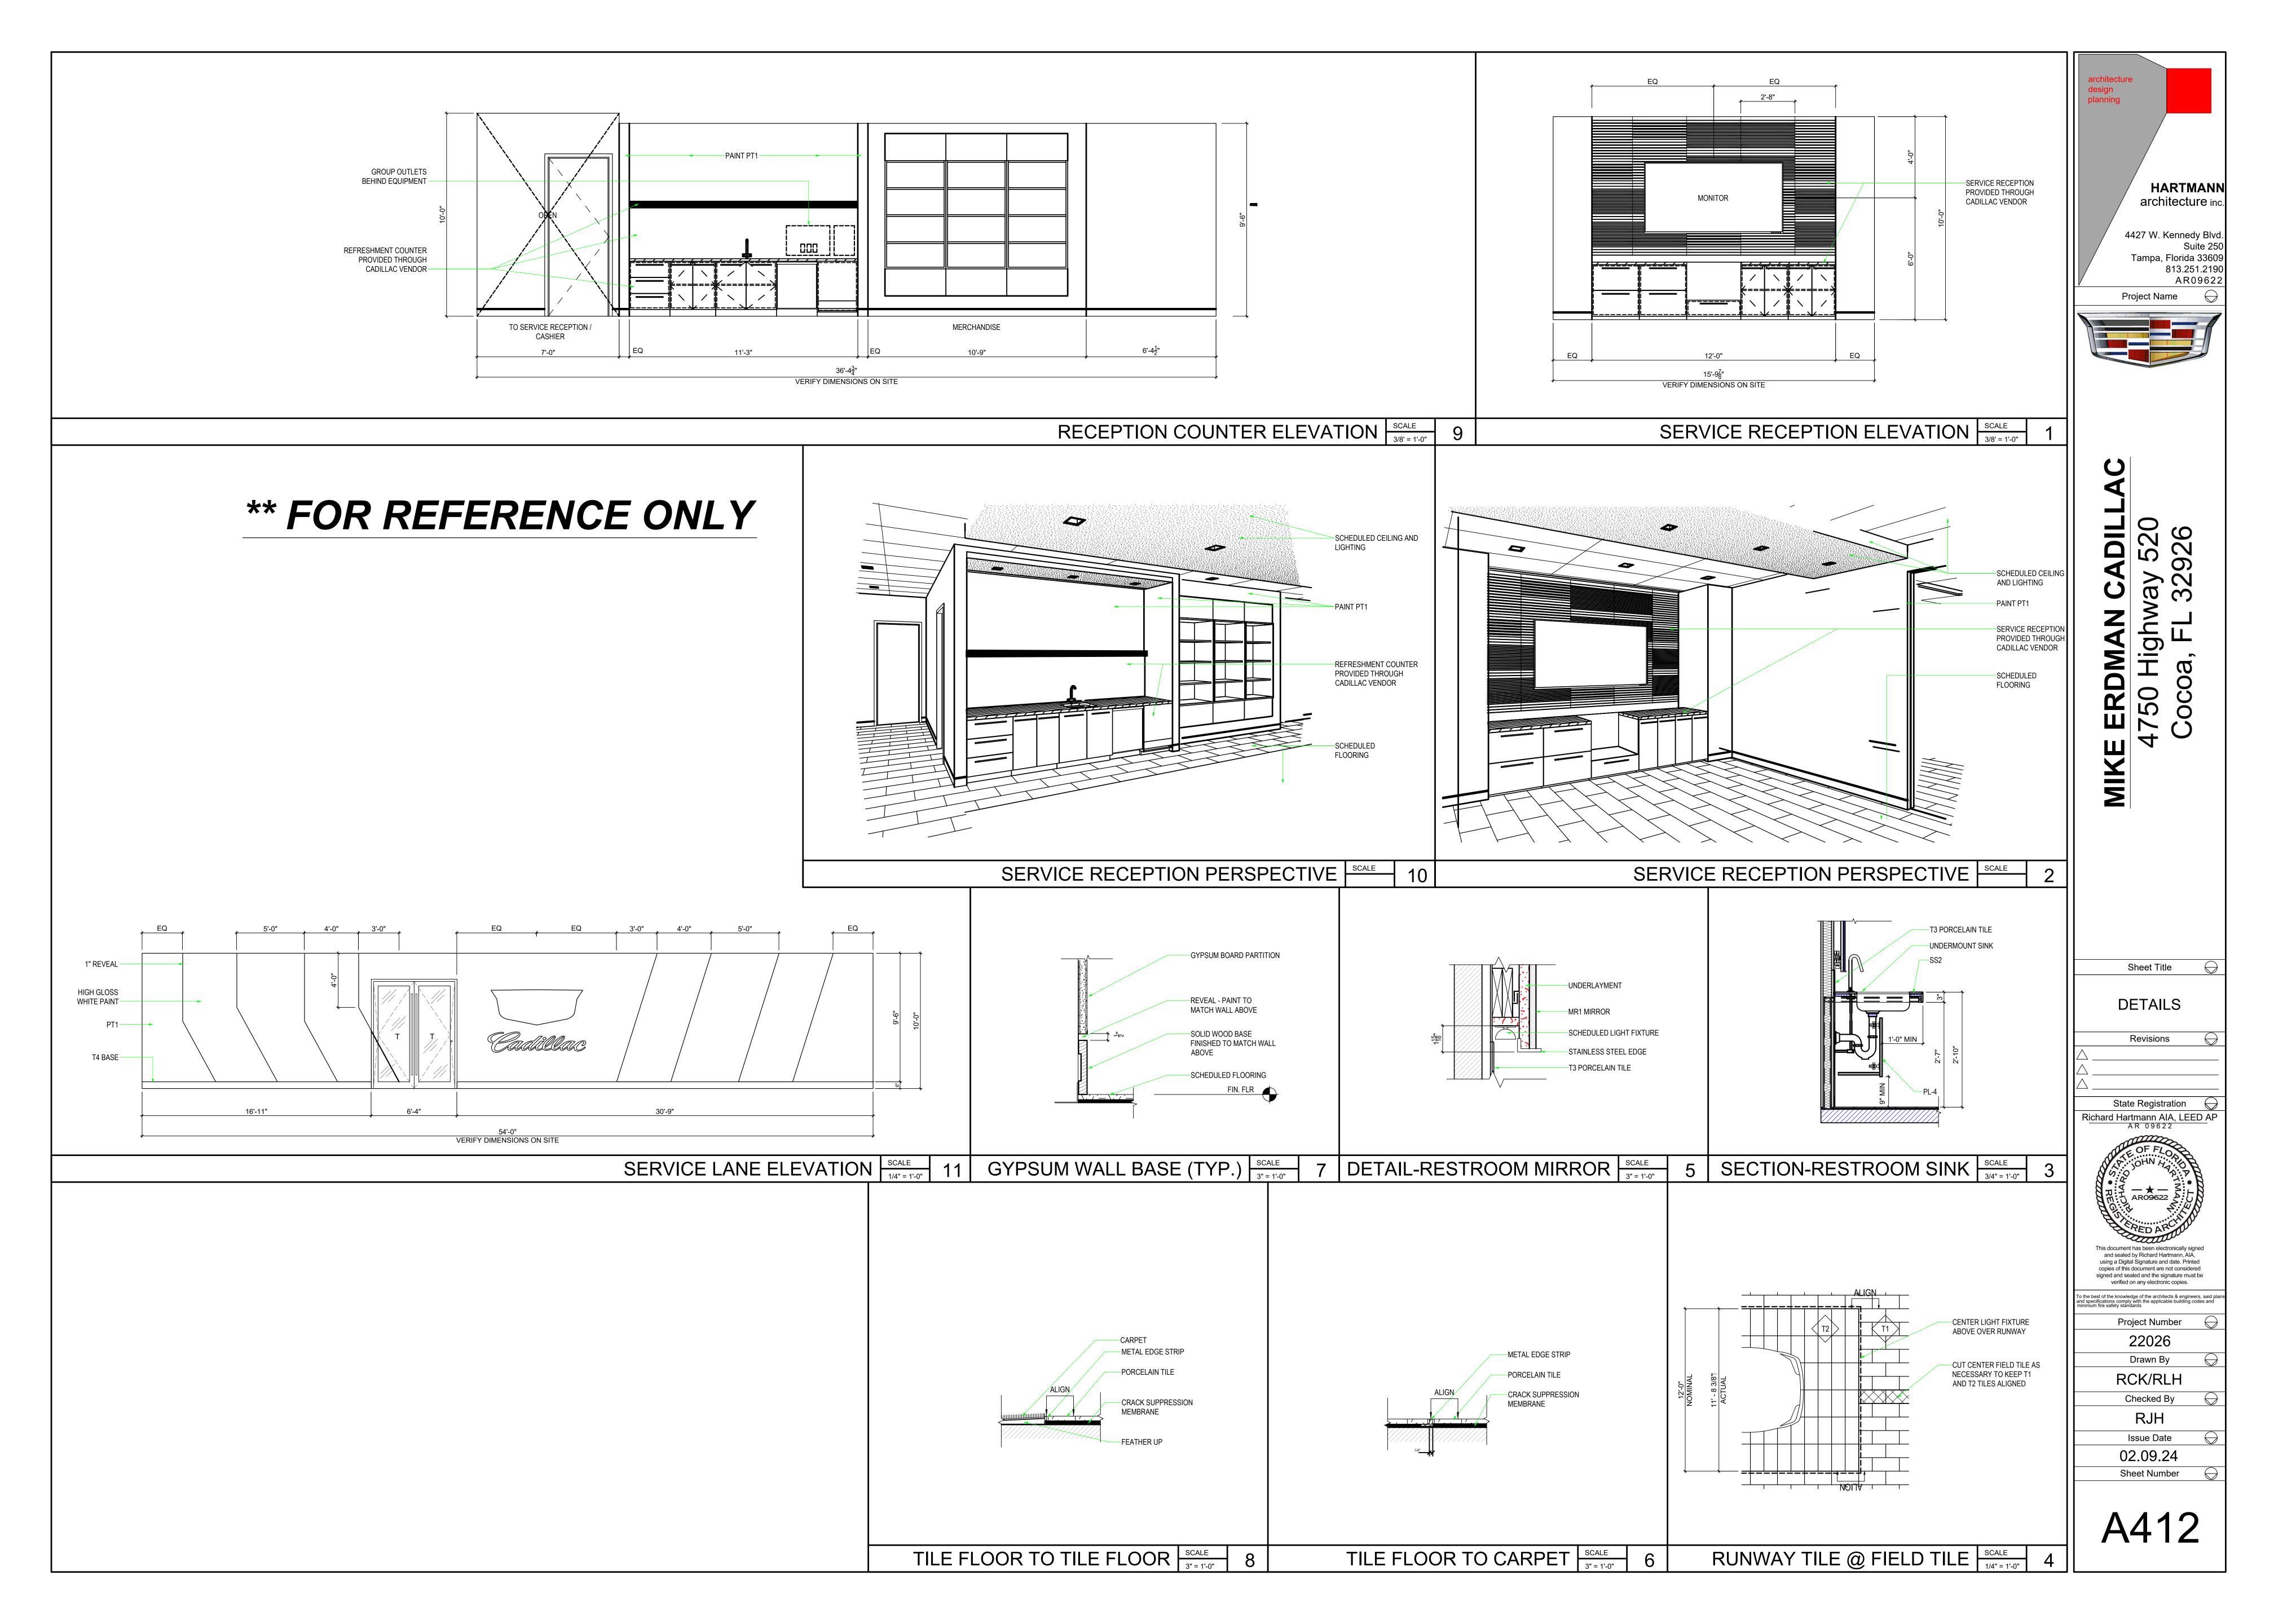
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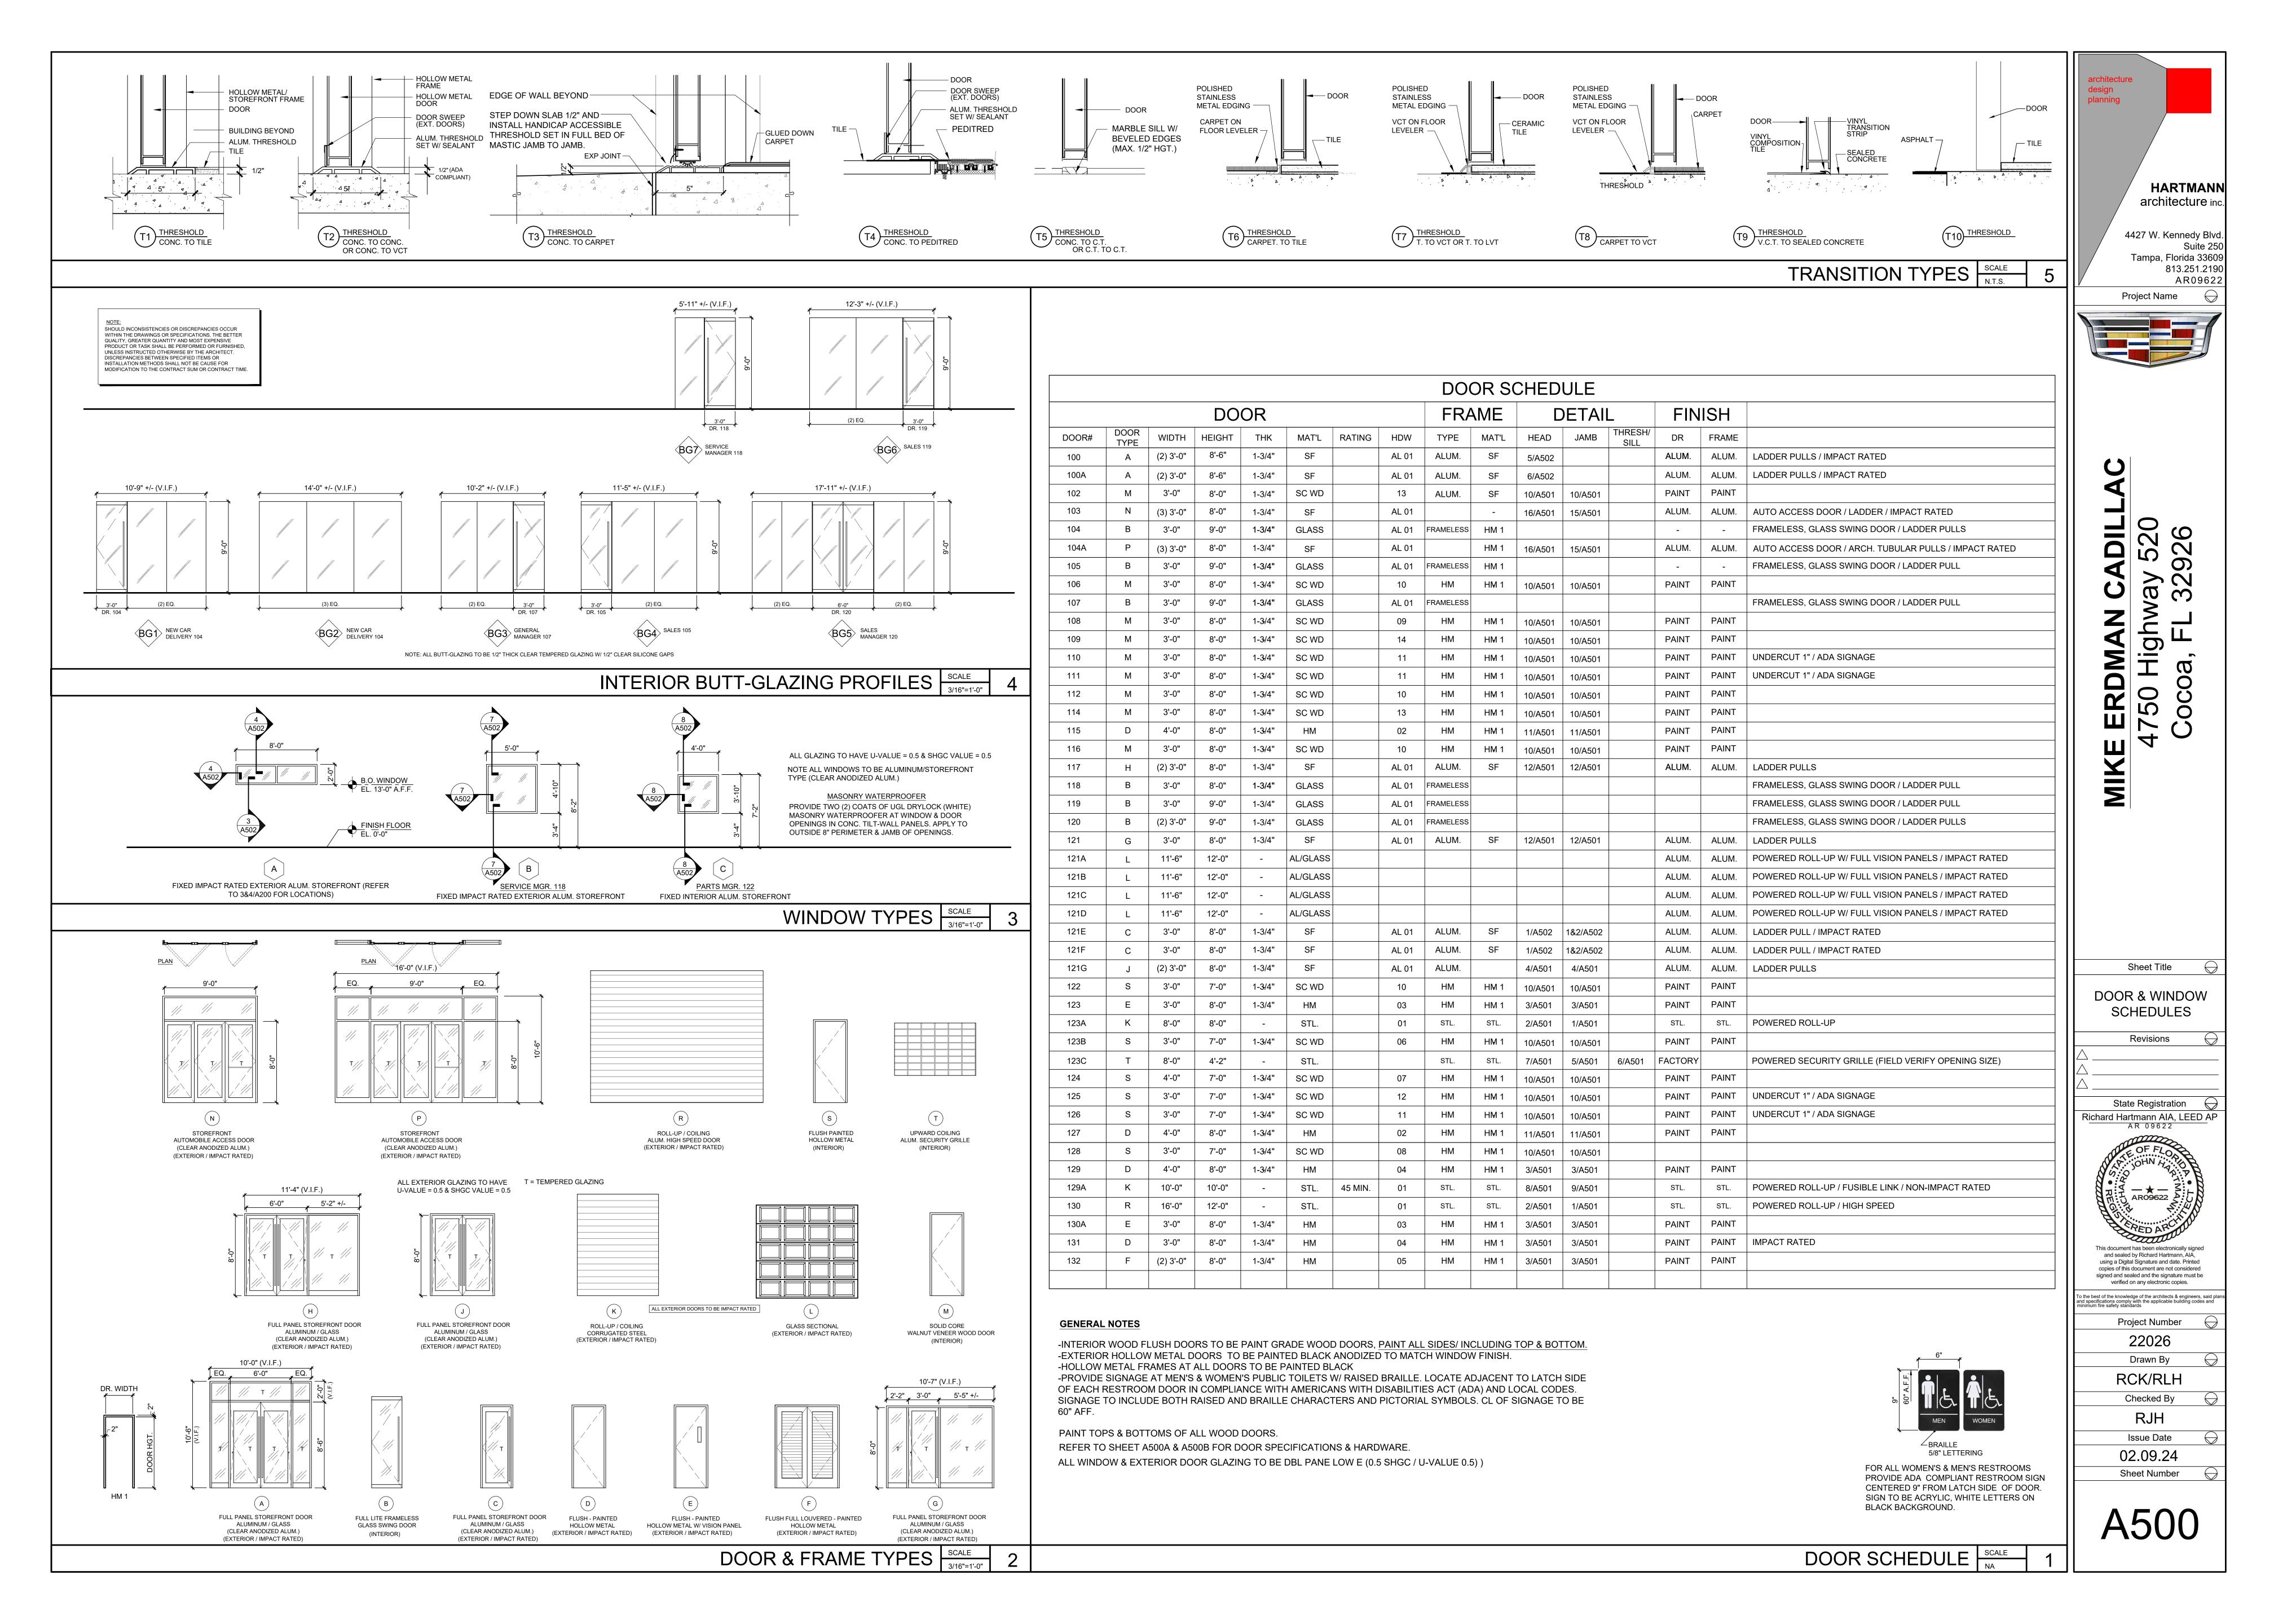
PARTITION & WALL TYPE DETAILS SCALE
1 1/2" = 1'-0"

Sheet Number









**HARTMANN** architecture ind 4427 W. Kennedy Blvd

Tampa, Florida 33609

AR09622

Project Name

Sheet Title

Revisions

State Registration

Richard Hartmann AIA, LEED AP AR 09622

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Project Number Drawn By

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Issue Date

02.09.24 Sheet Number

Ъ	01 DORS: 100, 100A, 103, 104, 104A, 10 1 CYLINDER(S)	5, 107, 117, 118, 119, 120, 121, 121A, 121B, 121C, 3901/3902 AS REQ'D	, 121D, 121E, 12 US26D	1F, 121G HA
GET HOL		WARE BY DOOR/FRAME MFR./SUPPLIER	03200	THY
SET #01 DO	OORS: 123A, 129A, 130 1 HARDWARE BY DOO	R MFR./SUPPLIER		
SET #02	OORS: 115, 127			
1 1	CONTINUOUS HINGE(S) EXIT DEVICE(S)	SL18HD X LAR 4501 RIM FEC	CL US32D	SLCT HA
1	NIGHT LATCH EXIT TRIM(S) RIM CYLINDER(S)	45NL AUG 3901	US26D US26D	НА НА
1 1	CLOSER(S) KICK PLATE(S)	5100 HDCS 190S 10" X 2" LDW	ALM US32D	НА НА
1 1	THRESHOLD WEATHERSTRIP	520S N X LAR 881S N X LAR	MIL MIL	HA HA
1 1	SWEEP(S) RAIN DRIP CAP	750S N X LAR 810S X LAR	CLR MIL	HA HA
	HARDWARE SET IS INTENDI REQUIRED RATINGS ARE MI	ED AS A GUIDE. CONFIRM WITH DOOR AND ET.	FRAME MANU	FACTURER TO ENSU
	OORS: 123, 130A			
1	CONTINUOUS HINGE(S) CORRIDOR LOCKSET	SL18HD X LAR 3856 SECT AUG ADA TURN	CL US26D	SLCT HA
1 1 1	CLOSER(S)  KICK PLATE(S)  THRESHOLD	5100 HDCS 190S 10" X 2" LDW 520S N X LAR	ALM US32D MIL	HA HA HA
1	WEATHERSTRIP SWEEP(S)	881S N X LAR 750S N X LAR	MIL CLR	HA HA
1	RAIN DRIP CAP HARDWARE SET IS INTENDI	810S X LAR ED AS A GUIDE. CONFIRM WITH DOOR AND	MIL	НА
SET #04	REQUIRED RATINGS ARE MI	ET.		
	OORS: 129, 131 CONTINUOUS HINGE(S)	SL18HD X LAR	CL	SLCT
1	STOREROOM LOCKSET CLOSER(S)	3881 SECT AUG ADA TURN 5100 HDCS	US26D ALM	HA HA
1 1	KICK PLATE(S) THRESHOLD	190S 10" X 2" LDW 520S N X LAR	US32D MIL	HA HA
1	WEATHERSTRIP SWEEP(S)	881S N X LAR 750S N X LAR	MIL CLR	HA HA
1	RAIN DRIP CAP HARDWARE SET IS INTENDI REQUIRED RATINGS ARE MI	810S X LAR ED AS A GUIDE. CONFIRM WITH DOOR AND ET.	MIL FRAME MANU	HA FACTURER TO ENSU
SET #05				
2	OORS: 132 CONTINUOUS HINGE(S)	SL18HD X LAR	CL	SLCT
2	SURFACE BOLT(S) STOREROOM LOCKSET	276D 12" 3881 SECT AUG ADA TURN	US26D US26D	НА НА
1	OVERHEAD STOP(S) INACTIVE LEAF	7016 SRF	US32D	НА
2	CLOSER(S)  ACTIVE LEAF  KICK PLATE(S)	5100 HDCS 190S 10" X 1" LDW	ALM US32D	НА НА
1	THRESHOLD WEATHERSTRIP	520S N X LAR 881S N X LAR	MIL MIL	HA HA
2	SWEEP(S) ASTRAGAL	750S N X LAR 874S N X LAR	CLR MIL	HA HA
1		810S X LAR ED AS A GUIDE. CONFIRM WITH DOOR AND	MIL FRAME MANU	HA FACTURER TO ENSU
SET #06	REQUIRED RATINGS ARE MI	ET.		
	OORS: 123B HINGE(S)	BB1279 4 1/2" X 4 1/2" NRP	US26D	НА
1 1	OFFICE LOCKSET CLOSER(S)	3550 AUG 5200 HDCS	US26D ALM	НА НА
1 1	KICK PLATE(S) THRESHOLD	190S 10" X 2" LDW 413S X LAR	US32D MIL	HA HA
1	SEAL SWEEP(S)	726 X LAR 750S N X LAR	S CLR	НА НА
SET #07	OORS: 124			
3	HINGE(S) STOREROOM LOCKSET	BB1279 5" X 4 1/2" 3580 AUG	US26D US26D	HA HA.
3	HINGE(S)			
3 1 1	HINGE(S) STOREROOM LOCKSET CLOSER(S)	3580 AUG 5200	US26D ALM	HA. HA
3 1 1 1 1 1 SET #08	HINGE(S) STOREROOM LOCKSET CLOSER(S) KICK PLATE(S) CONVEX WALL STOP(S) SEAL	3580 AUG 5200 190S 10" X 2" LDW 232W	US26D ALM US32D US32D	НА. НА НА НА
3 1 1 1 1 1 1 SET #08 DC	HINGE(S) STOREROOM LOCKSET CLOSER(S) KICK PLATE(S) CONVEX WALL STOP(S) SEAL  DORS: 128 HINGE(S)	3580 AUG 5200 190S 10" X 2" LDW 232W 726 X LAR BB1168 4 1/2" X 4 1/2"	US26D ALM US32D US32D S	НА. НА НА НА НА
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3 1 1 1 1 1 SET #10 DC 4 1 1 1 1 1 1 1 1 1 1 1 1 1 1 1 1 1 1	HINGE(S) STOREROOM LOCKSET CLOSER(S) KICK PLATE(S) CONVEX WALL STOP(S) SEAL  DORS: 128 HINGE(S) CLASSROOM LOCKSET CLOSER(S) KICK PLATE(S) CONVEX WALL STOP(S) THRESHOLD SEAL SWEEP(S)  DORS: 108 HINGE(S) CLASSROOM LOCKSET CLOSER(S) KICK PLATE(S) CONVEX WALL STOP(S)  DORS: 108 HINGE(S) CLASSROOM LOCKSET CLOSER(S) KICK PLATE(S) CONVEX WALL STOP(S)  DORS: 106, 112, 116, 122 HINGE(S) OFFICE LOCKSET CONCAVE WALL STOP(S) SILENCERS  DORS: 110, 111, 126 HINGE(S) PUSH PLATE CLOSER(S) KICK PLATE(S) MOP PLATE CLOSER(S) KICK PLATE(S) MOP PLATE(S) CONVEX WALL STOP(S) SILENCERS  DORS: 125 HINGE(S) PRIVACY SET W/ INDICATOR CLOSER(S) KICK PLATE(S) MOP PLATE(S) CONVEX WALL STOP(S) SILENCERS  DORS: 125 HINGE(S) PRIVACY SET W/ INDICATOR CLOSER(S) KICK PLATE(S) MOP PLATE(S) CONVEX WALL STOP(S) SEAL	3580 AUG 5200 190S 10" X 2" LDW 232W 726 X LAR  BB1168 4 1/2" X 4 1/2" 3570 AUG 5200 190S 10" X 2" LDW 232W 413S X LAR 726 X LAR 750S N X LAR  BB1168 4 1/2" X 4 1/2" 3570 AUG 5200 190S 10" X 2" LDW 232W  BB1279 4 1/2" X 4 1/2" 3550 AUG 236W 307D  BB1168 4 1/2" X 4 1/2" 358 8" X 16" H 34J 4" X 16" 5200 190S 10" X 2" LDW 190S 4" X 1" LDW 232W 307D  BB1279 4 1/2" X 4 1/2" R 3796 AUG 5200 190S 10" X 2" LDW 190S 4" X 1" LDW 232W 307D  BB1279 4 1/2" X 4 1/2" R 3796 AUG 5200 190S 10" X 2" LDW 190S 4" X 1" LDW 232W 726 X LAR	US26D ALM US32D US32D S  US26D ALM US32D MIL S CLR  US26D ALM US32D MIL S CLR  US26D US26D ALM US32D US32D US32D US32D GREY  US26D US32D GREY  US26D US32D US32D S  US26D US32D	на. на

SET #14

DOORS: 109

1 STOREROOM LOCKSET

1 CONVEX WALL STOP(S)

1 KICK PLATE(S)

3 SILENCERS


190S 10" X 2" LDW


232W


US26D HA

US32D HA

HARTMANN architecture ind 4427 W. Kennedy Blvd. Tampa, Florida 33609 Revisions State Registration Richard Hartmann AIA, LEED AP AR 09622 This document has been electronically signed and sealed by Richard Hartmann, AIA, using a Digital Signature and date. Printed copies of this document are not considered signed and sealed and the signature must be verified on any electronic copies. To the best of the knowledge of the architects & engineers, said plans and specifications comply with the applicable building codes and minimum fire safety standards Project Number Drawn By RCK/RLH Checked By Issue Date 02.09.24 Sheet Number

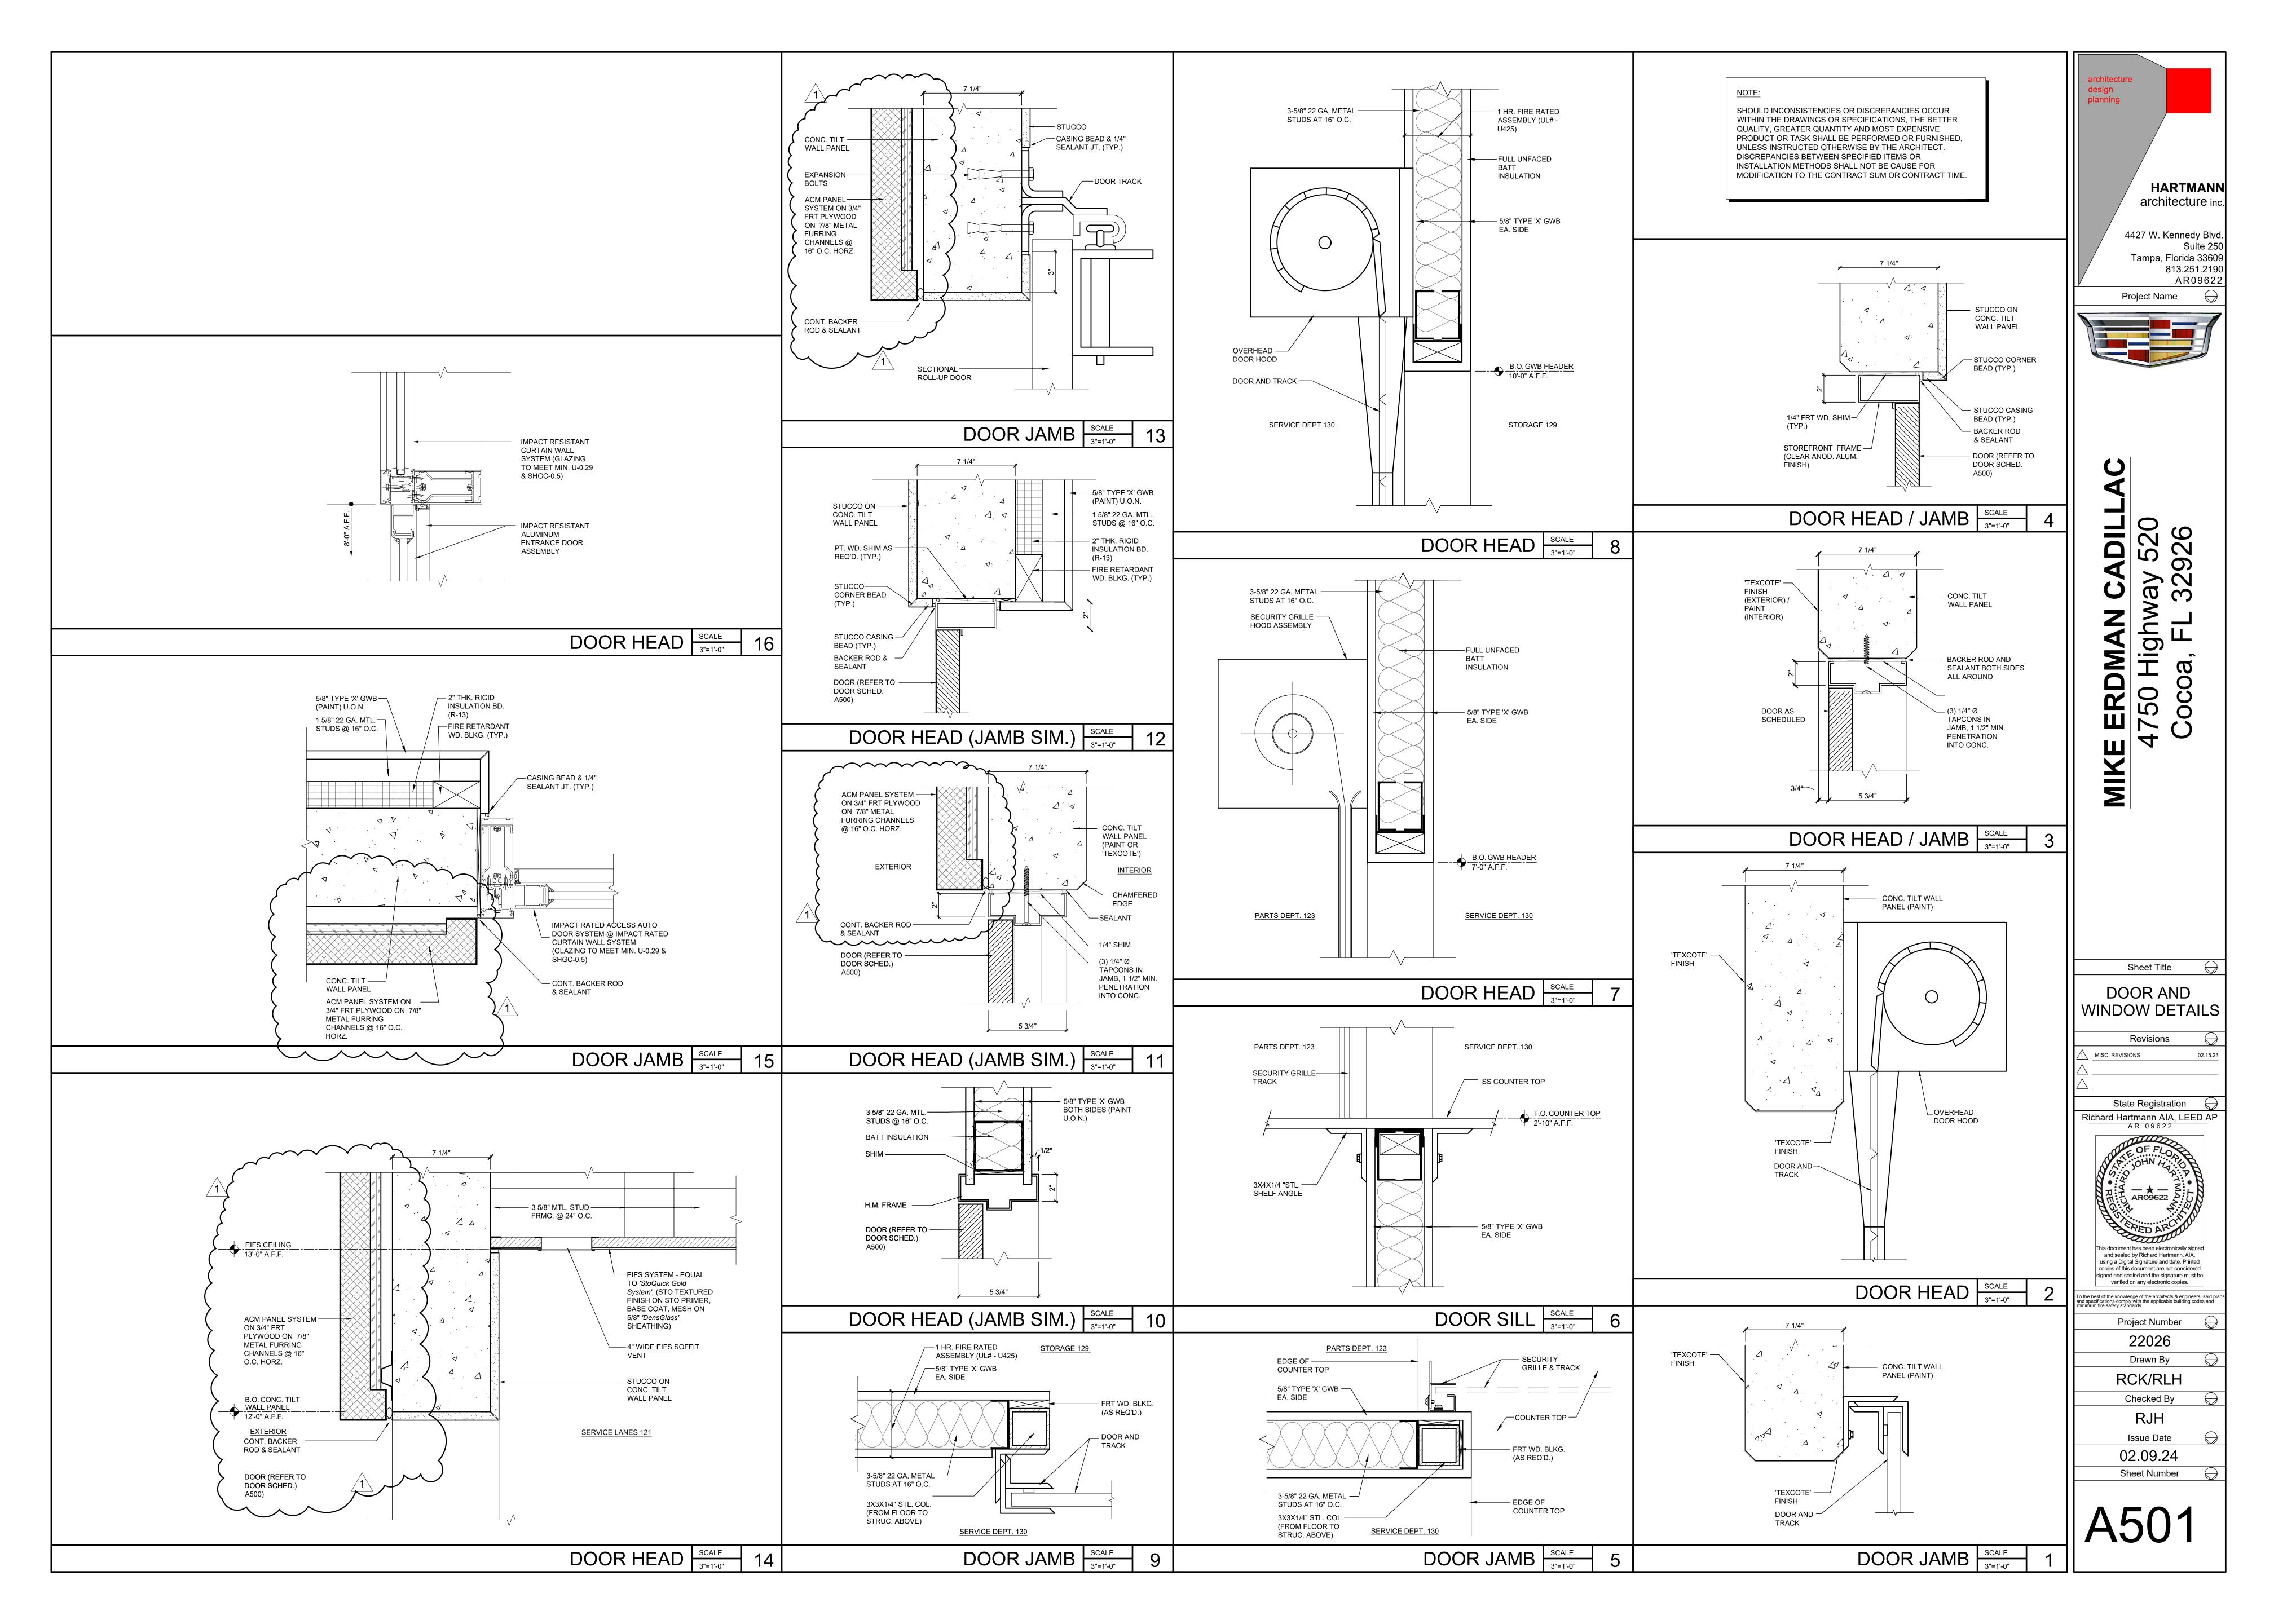

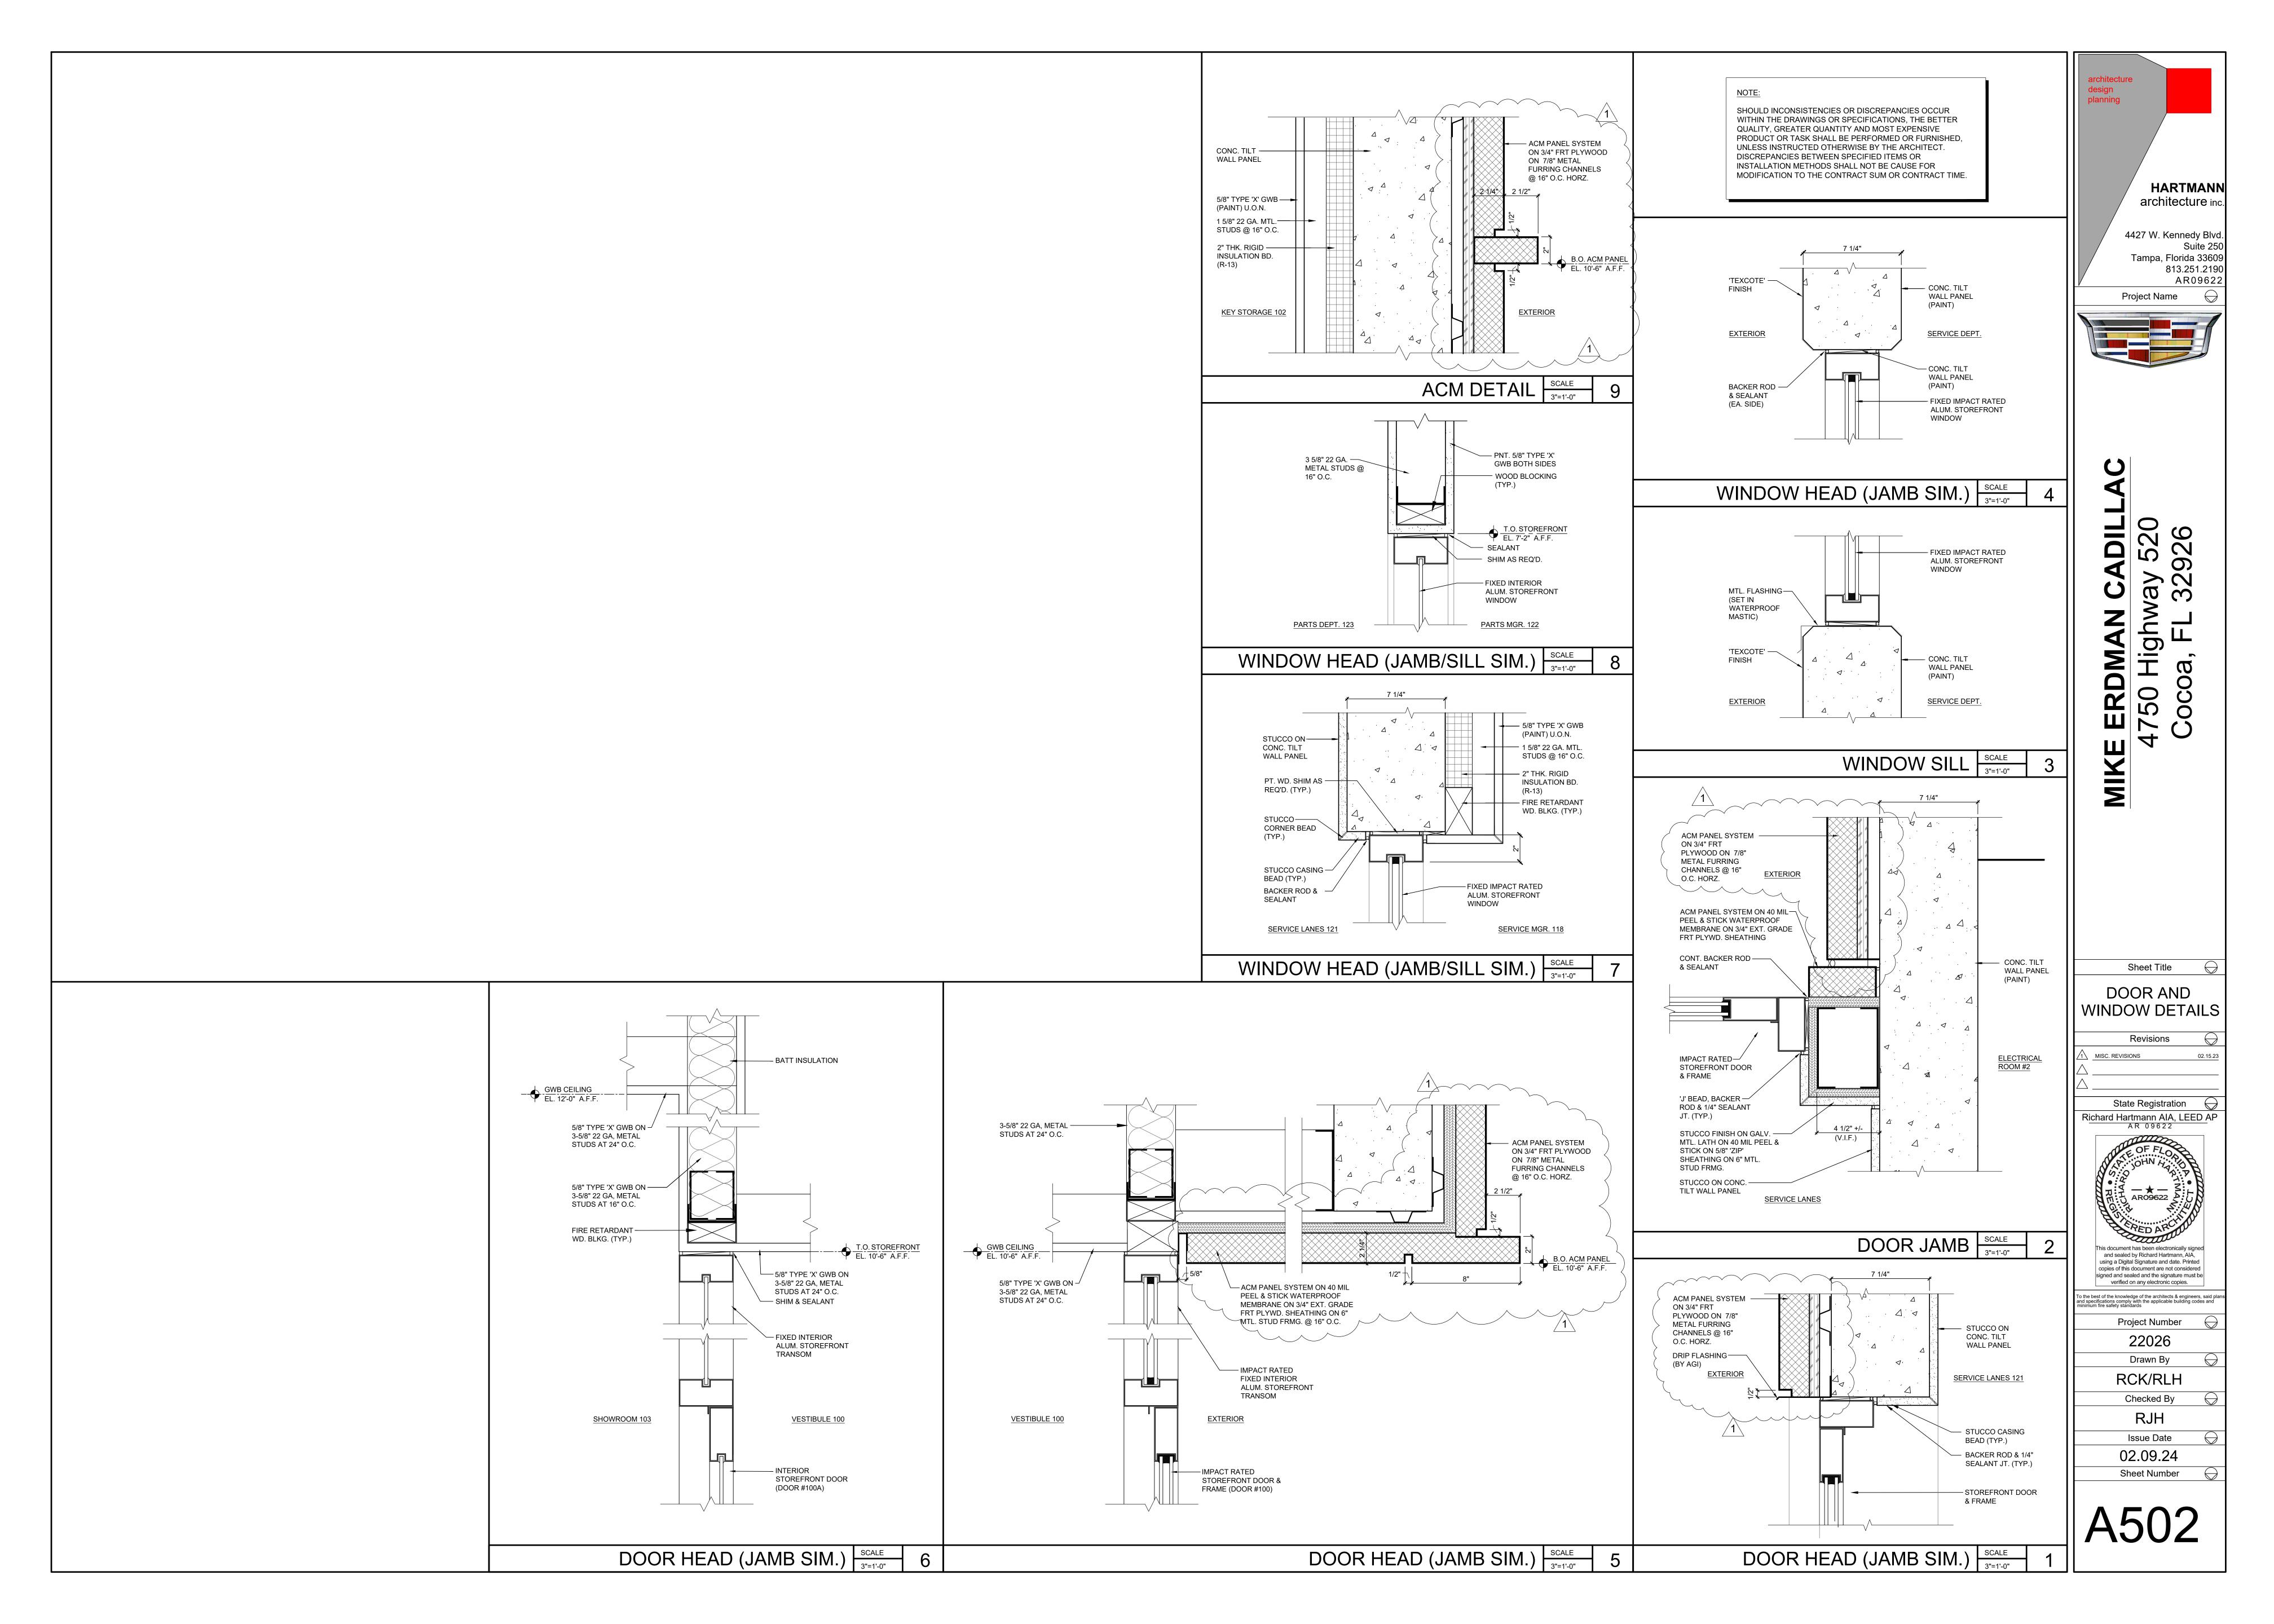

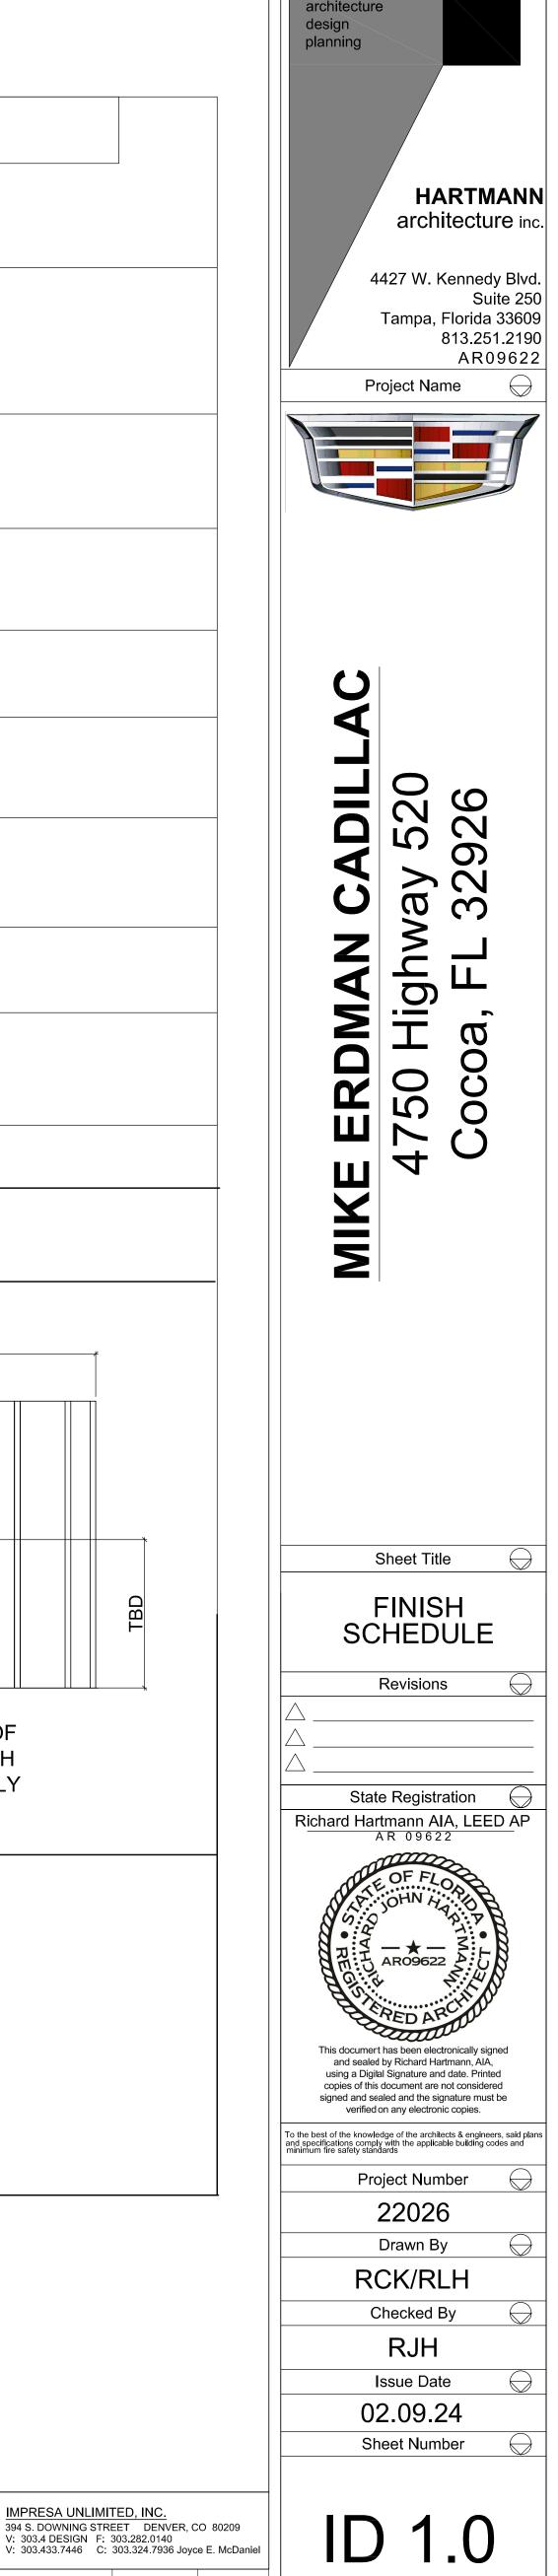

IMPRESA UNLIMITED, INC.

FINISH SCHEDULE

PT-3 -7 BLOCK PT-3 -7 BLOCK PT-3 -7 BLOCK

DRY FALL (DF-1) TO MATCH PT-1

ABREVIATIONS	NON CUSTOMER CONTACT		
	MILLWORK NOTES		
WALL & CEILING TYPES			
STR = STOREFRONT GLZ = GLAZING	ALL MILLWORK TO COMPLY WITH AWI CUSTOM GRADE STANDARDS		
GYP BD = GYPSUM WALL BOARD DENZ = DENS SHIELD BOARD	ALL INTERIOR TO BE WHITE MELAMINE WITH ADJUSTABLE SHELVES ON ADJUSTABLE PINS, UNLESS OTHERWISE NOTED		
INTERIOR FINISHES-FLOORING	INSERTA BLUM HINGES 120° CLIPTOP. MODEL # : B71T559		
FG - VESTIBULE PEDITRED OR EQUAL CPT = CARPET TILE T = CERAMIC TILE AND/OR PORCELAIN TILE	WATER SUPPLY GROMMET: DOUG MOCKETT MODEL: OG/BLACK (1")		
VT = LUXURY VINYL TILE  VST = VINYL STATIC DISSAPATIVE TILE  SC = SEALED CONCRETE  RTP = HIGHLY POLISHED DIAMOND GRING CONCRETE SYSTEM	TRASH GROMMETS: DOUG MOCKETT TM2B-PSS (POLISHED STAINLESS STEEL- 6")		
INTERIOR FINISHES-WALL SURFACES	MILLWORK GROMMETS: DOUG MOCKETT. MODEL: EDP		
FRP = FIBER RE-ENFORCED PANELS  GRP = GRAPHIC VINYL WALL COVERING OR VINYL	WHITE - HOLE SIZE TO CUT 2-1/2"		
ON 3/4" BLACK GATOR BOARD PT-PAINT F = FLAT FINISH (NOTED AFTER THE NUMBER) DF = DRY FALL FLAT FINISH (NOTED AFTER THE NUMBER) E = EGGSHEL, SATIN - ONE SHEEN UP FROM FLAT OR MATTE SG = SEMI GLOSS FINISH - DOOR JAMBS (NOTED AFTER THE NUMBER)	ACCURIDE 3732 FULL EXTENSION DRAWER GLIDES 100 LBS. LOAD CAPACITY ZINC PLATED		
G = GLOSS FINISH (NOTED AFTER THE NUMBER)	NATIONAL LOCK - CAM LOCK		

INTERIOR FINISHES-WALL BASES

PL = PLASTIC LAMINATE

WC = VINYL WALL COVERING

TB = CERAMIC TILE BASE WB = WOOD BASE PAINTED RBC = RUBBER BASE (COVED) RBS = RUBBER STRAIGHT BASE FOR CARPET

VB = VINYL BASE (COVED) TS = TRIM BETWEEN SIMILIAR OR DISSIMILAR FLOORING OR WALL/FLOOR. CONTRACTOR TO PROVIDE CORRECT SIZE AS PER THICKNESS OF THE EACH MATERIAL

NATIONAL LOCK - CAM LOCK MODEL #: N8053

SHELF BRACKETS - KNAPE & VOGT #85 DOUBLE SLOT HEAVY DUTY STANDARD / 185 SERIES DOUBLE BRACKETS

\*GROMMENTS HOLES TO BE FIELD CUT/VERIFIED, EXCEPT IN STAINLESS WILL BE CUT AT THE **FABRICATORS** 

ALL SOLID SURFACE ARE MITERED EDGES

CONTRACTOR IS RESPONSIBLE TO CHECK ON ALL FINISH MATERIALS' LEAD TIME AFTER THE BID IS AWARDED. 12 WEEKS PRIOR TO SUBMITTAL, REPORT ALL LEAD TIMES OF MATERIALS TO THE ARCHITECT AND INTERIOR DESIGNER

SHOULD INCONSISTENCIES OR DISCREPANCIES OCCUR WITHIN THESE DRAWINGS OR SPECIFICATIONS, THE BETTER QUALITY, GREATER QUANTITY AND MOST EXPENSIVE PRODUCT OR TASK SHALL BE PERFORMED OR FURNISHED, UNLESS INSTRUCTED OTHERWISE BY THE OWNER AND/OR ARCHITECT DISCREPANCIES BETWEEN SPECIFIED ITEMS OR INSTALLATION METHODS SHALL NOT BE CAUSE FOR MODIFICATION TO THE CONTRACT SUM OR CONTRACT TIME.

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X Z

architecture

**HARTMANN** 

architecture inc

4427 W. Kennedy Blvd.

Tampa, Florida 33609


Project Name

813.251.2190

AR09622

Sheet Title

**ROOM FINISH** SCHEDULE Revisions

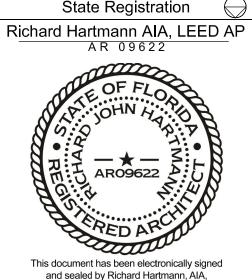

copies of this document are not considered signed and sealed and the signature must be verified on any electronic copies.


using a Digital Signature and date. Printed

To the best of the knowledge of the architects & engineers, said plans and specifications comply with the applicable building codes and minimum fire safety standards Project Number 22026 Drawn By


RCK/RLH Checked By

Issue Date 02.09.24


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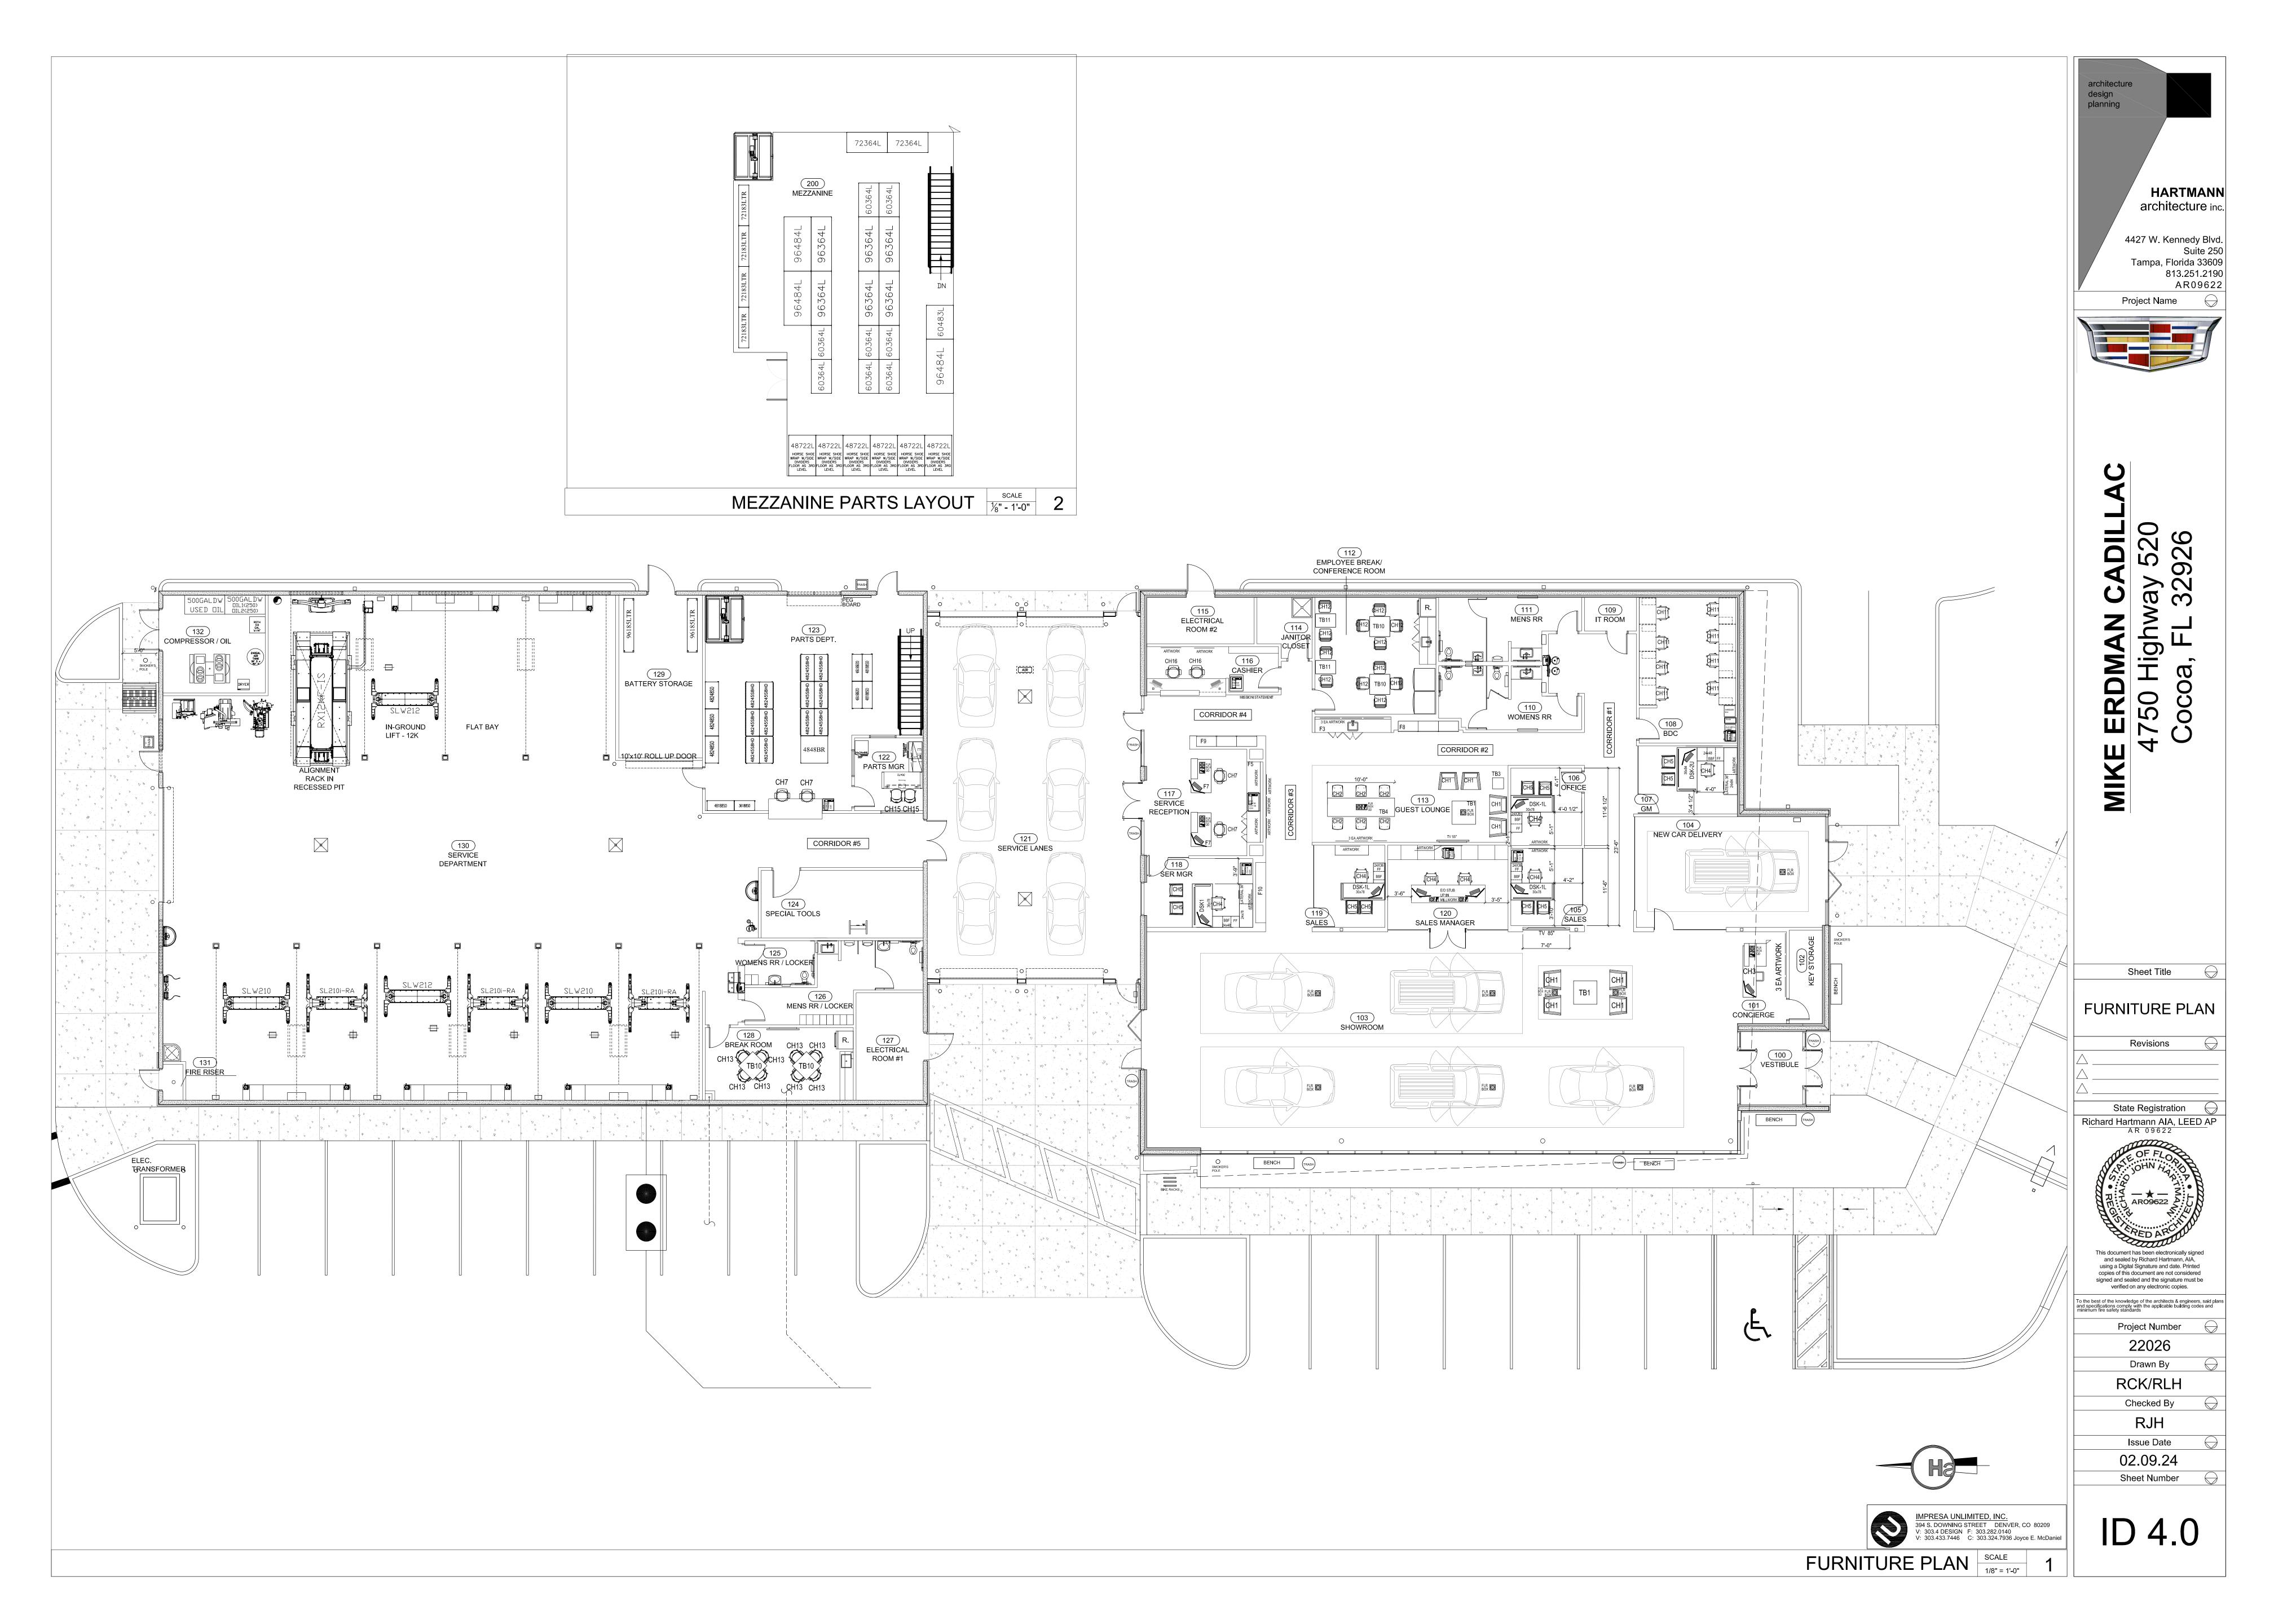


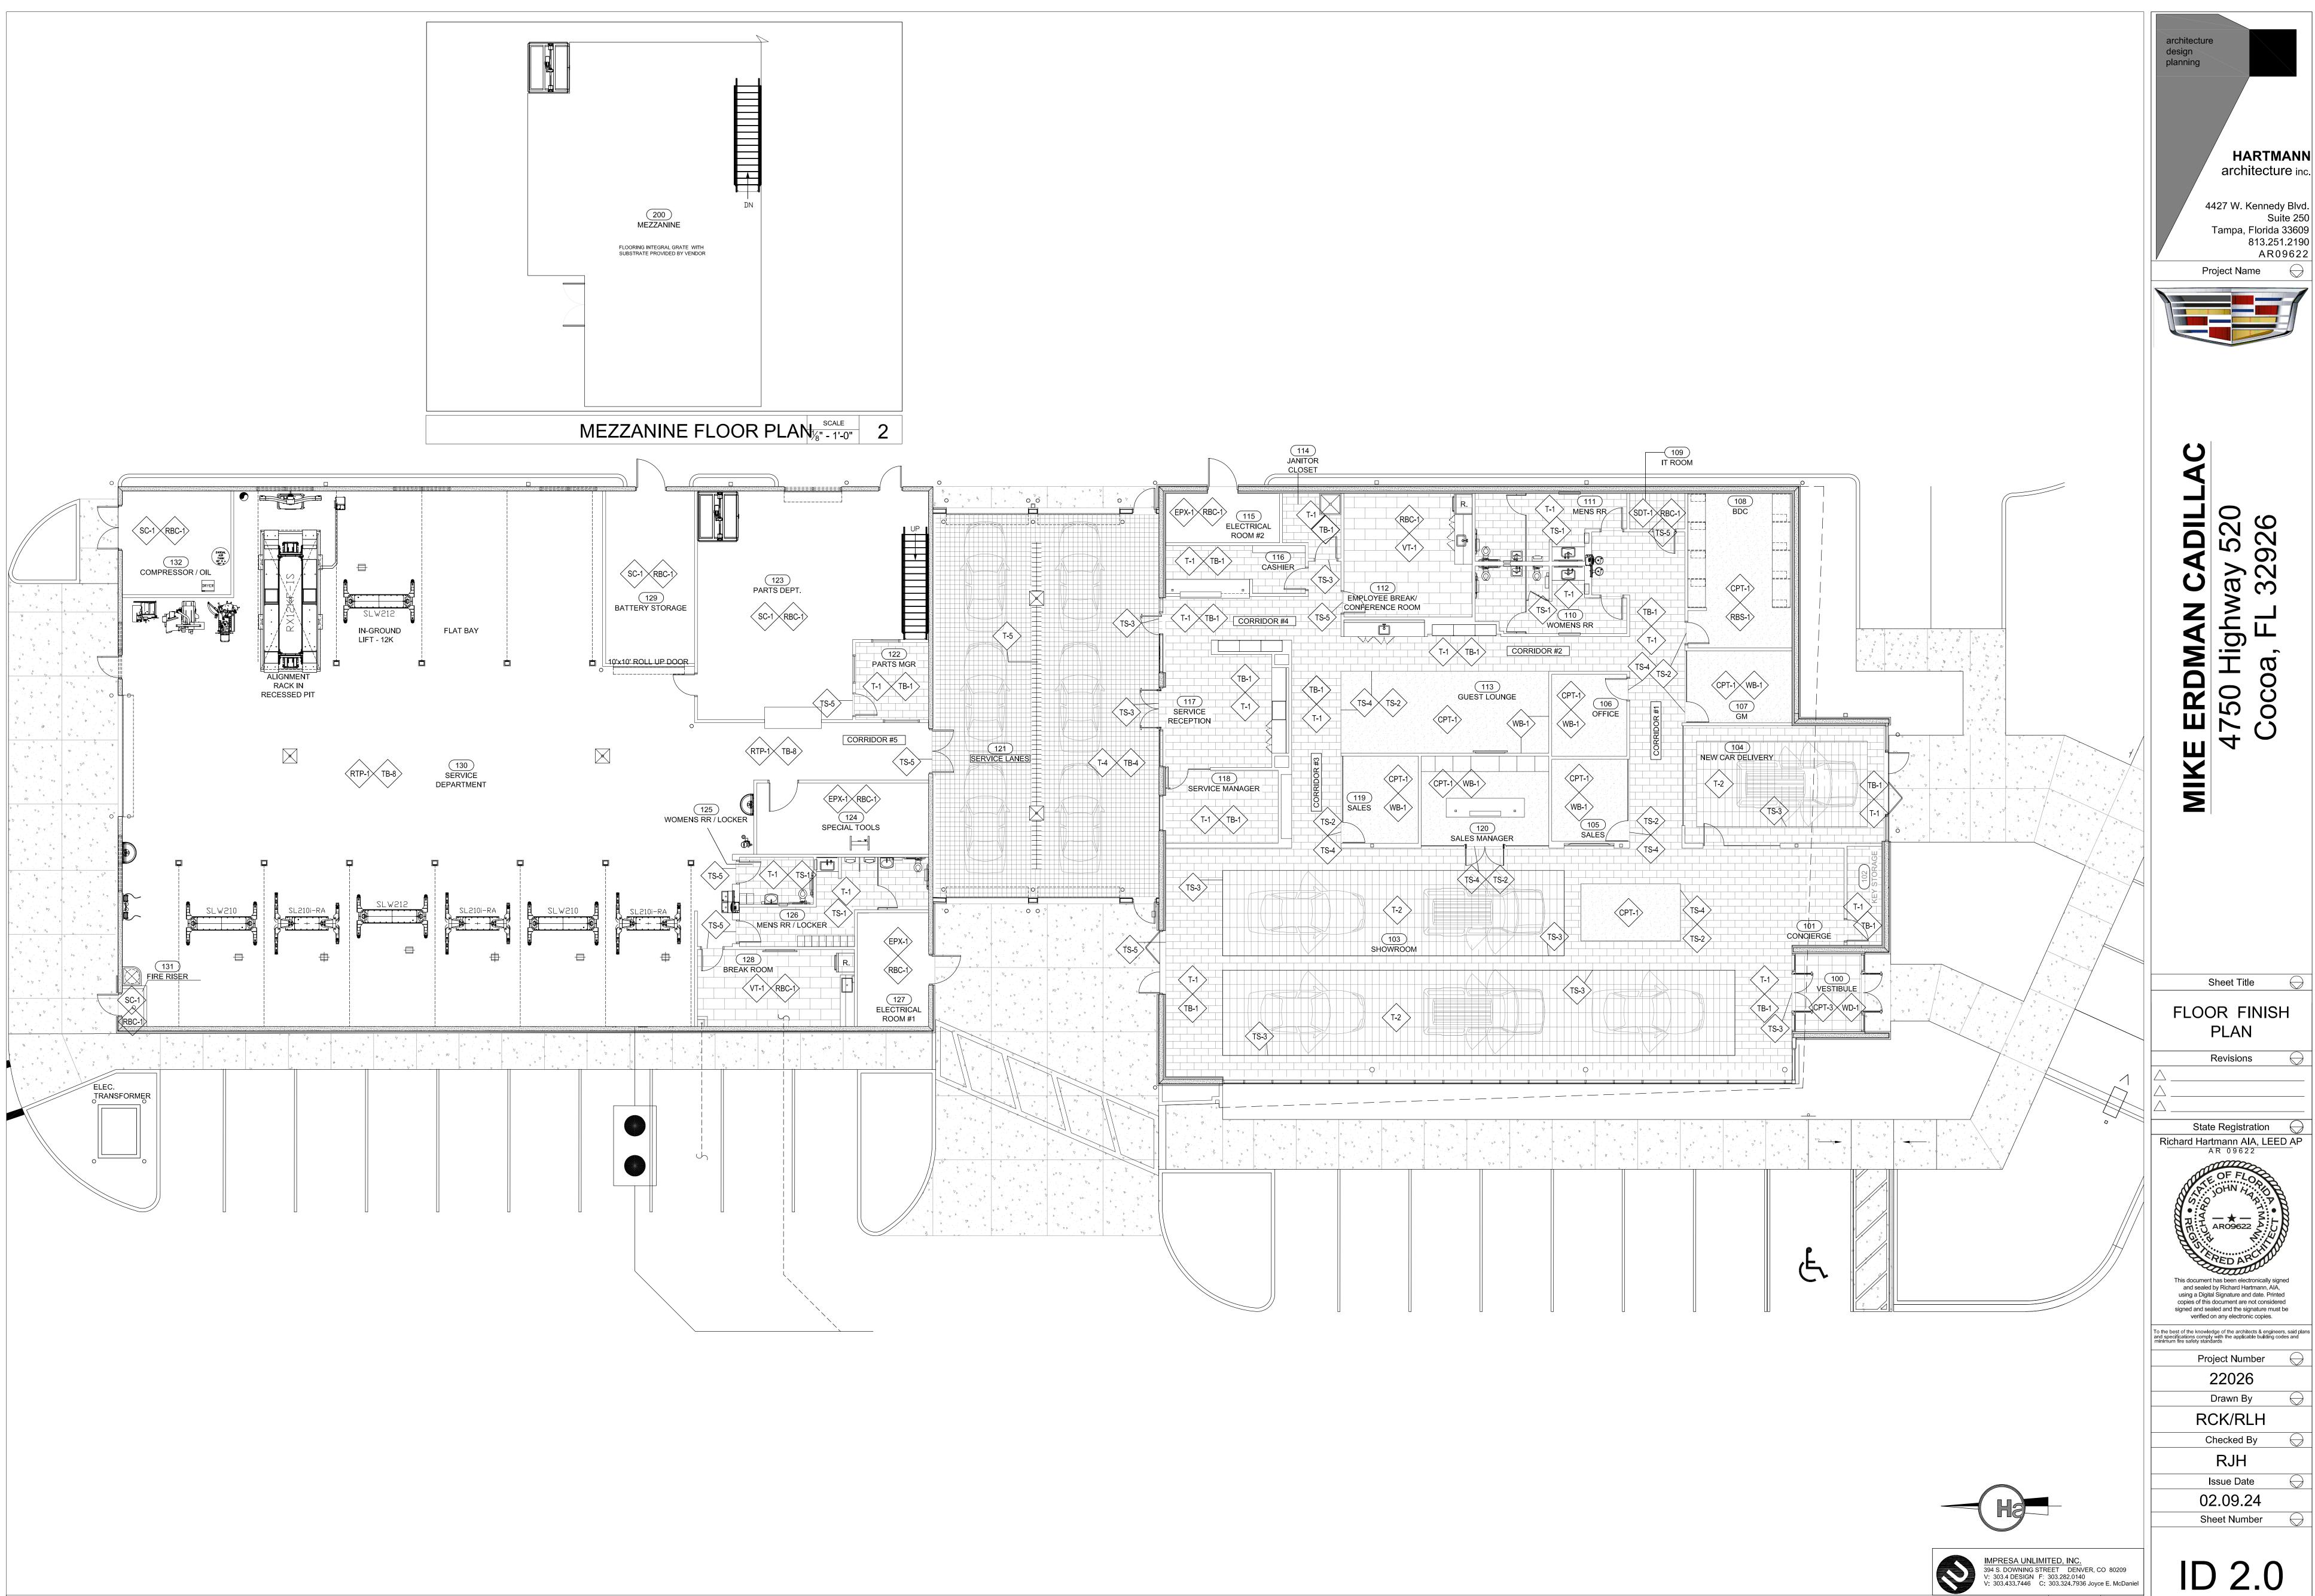
HARTMANN architecture inc. 4427 W. Kennedy Blvd. Suite 250 Tampa, Florida 33609 813.251.2190 AR09622

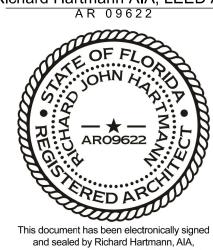


FLOOR FINISH PLAN




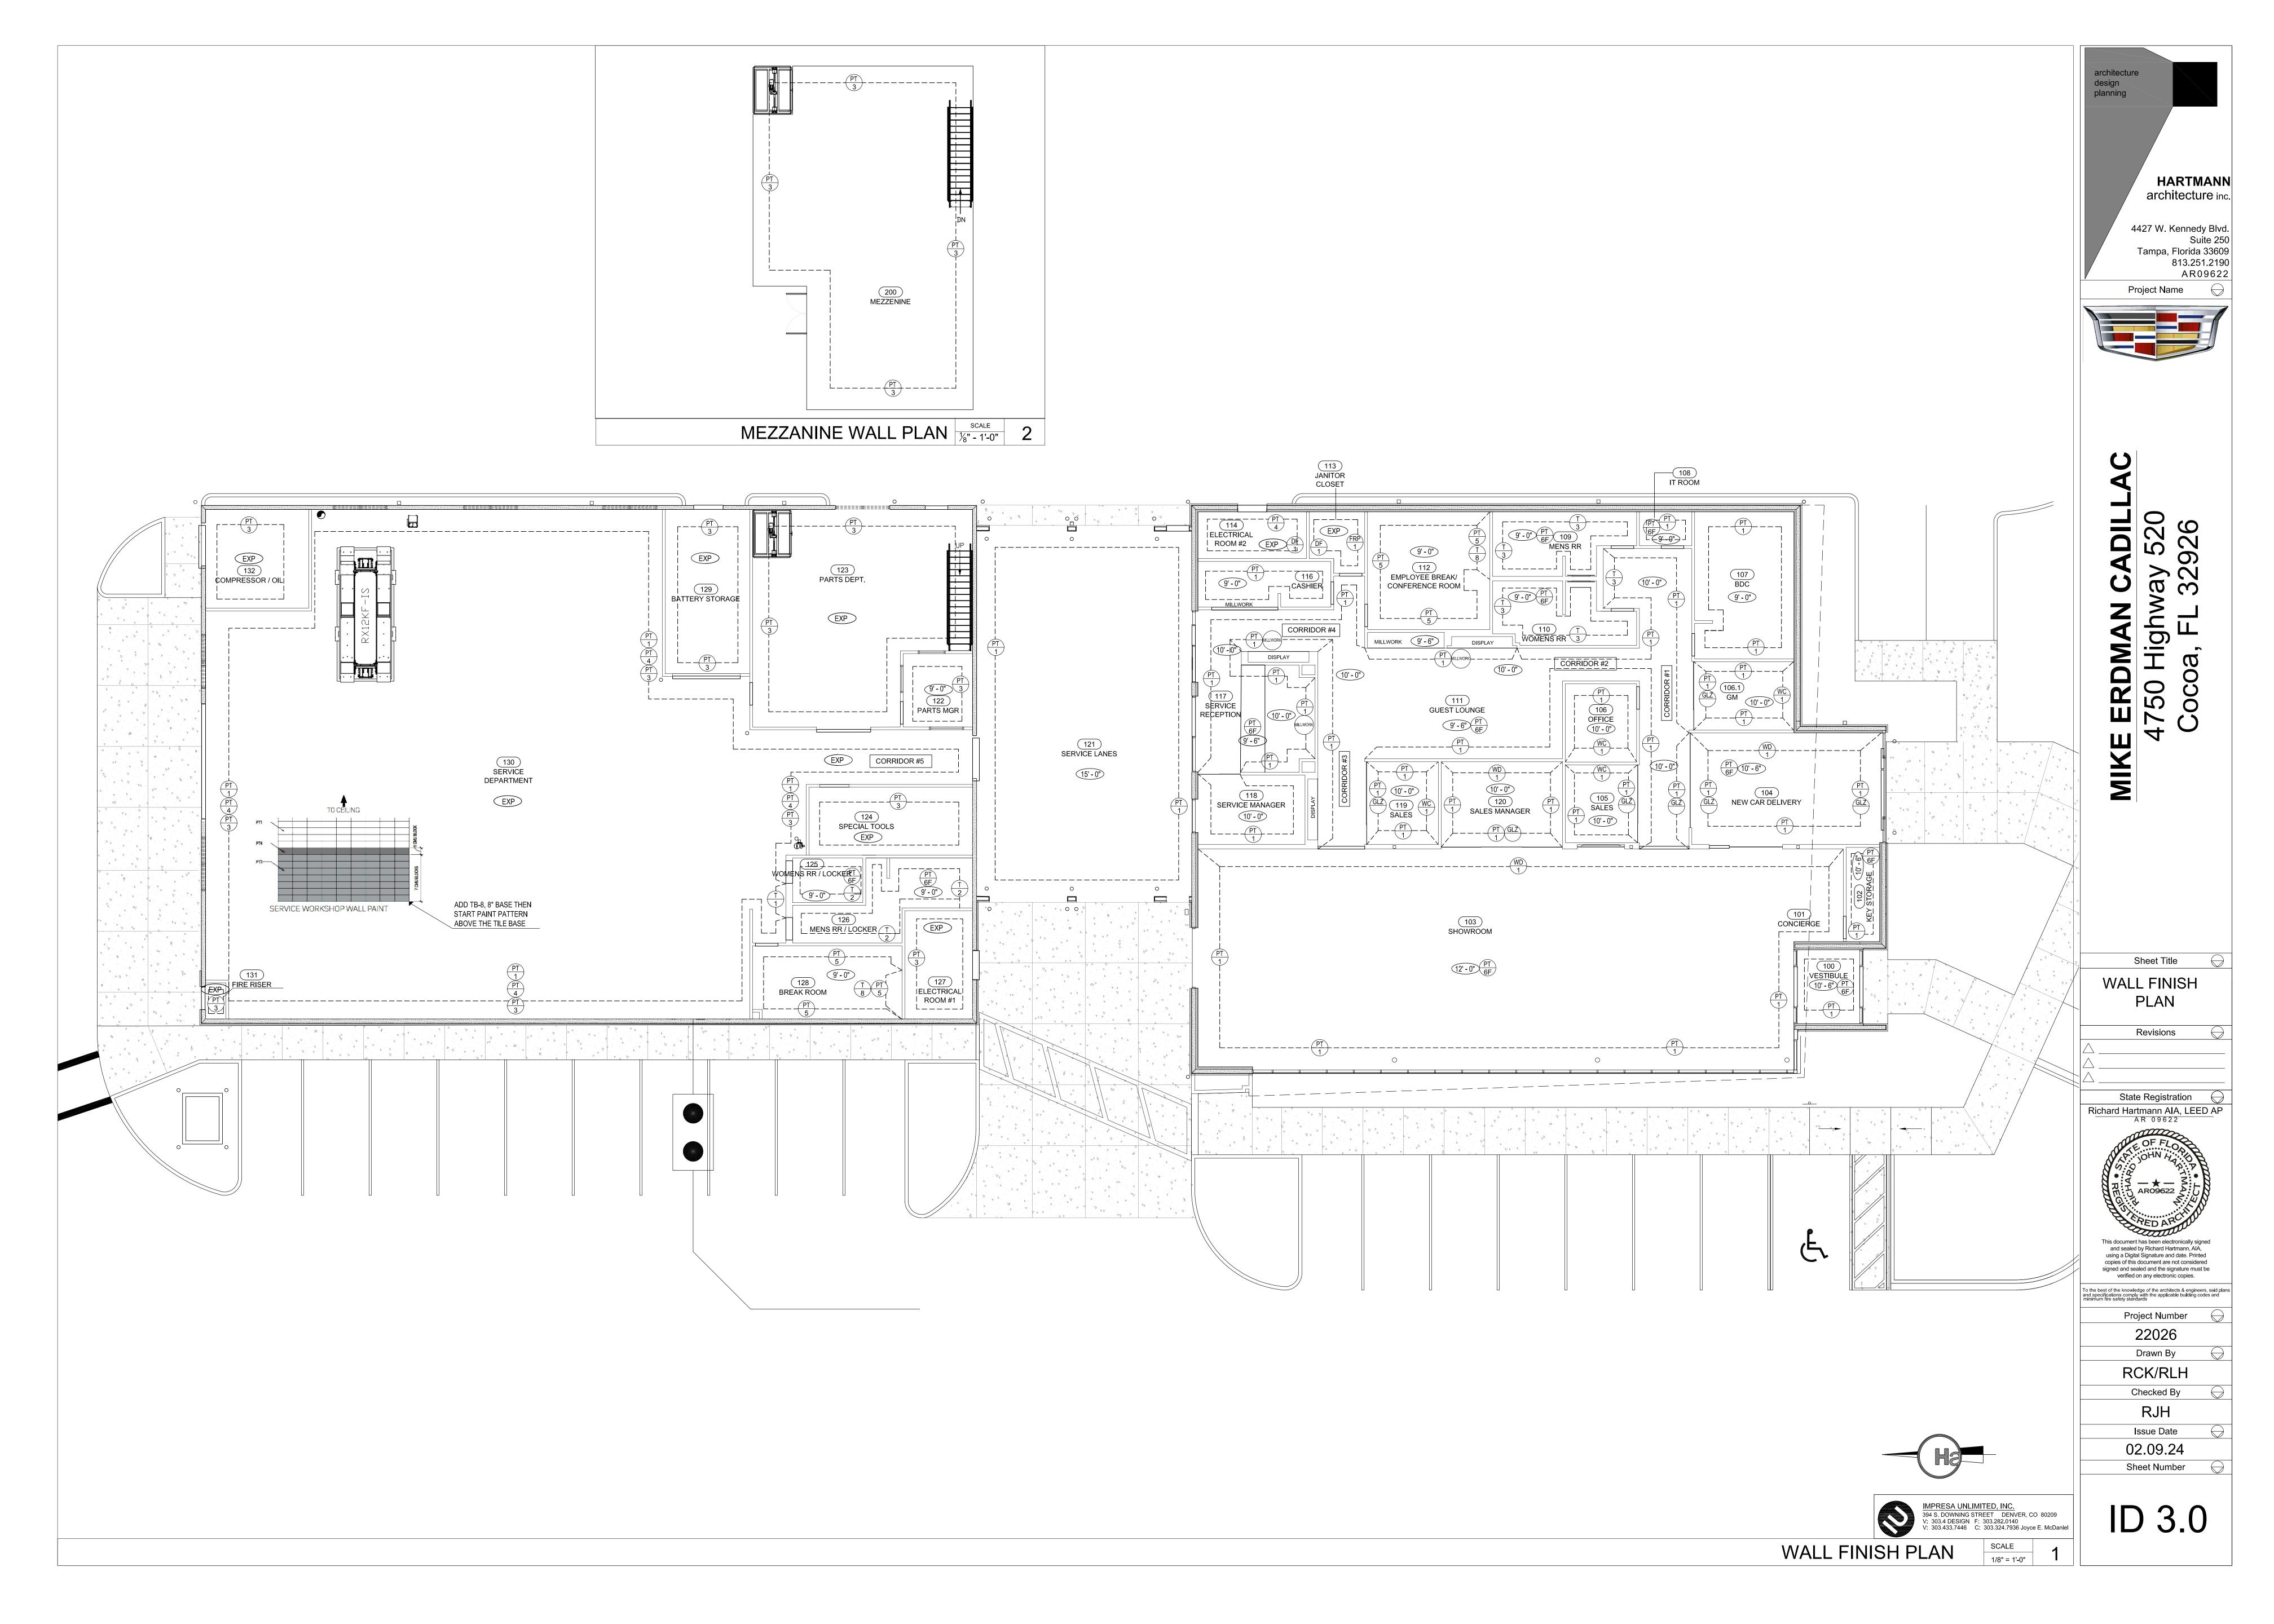


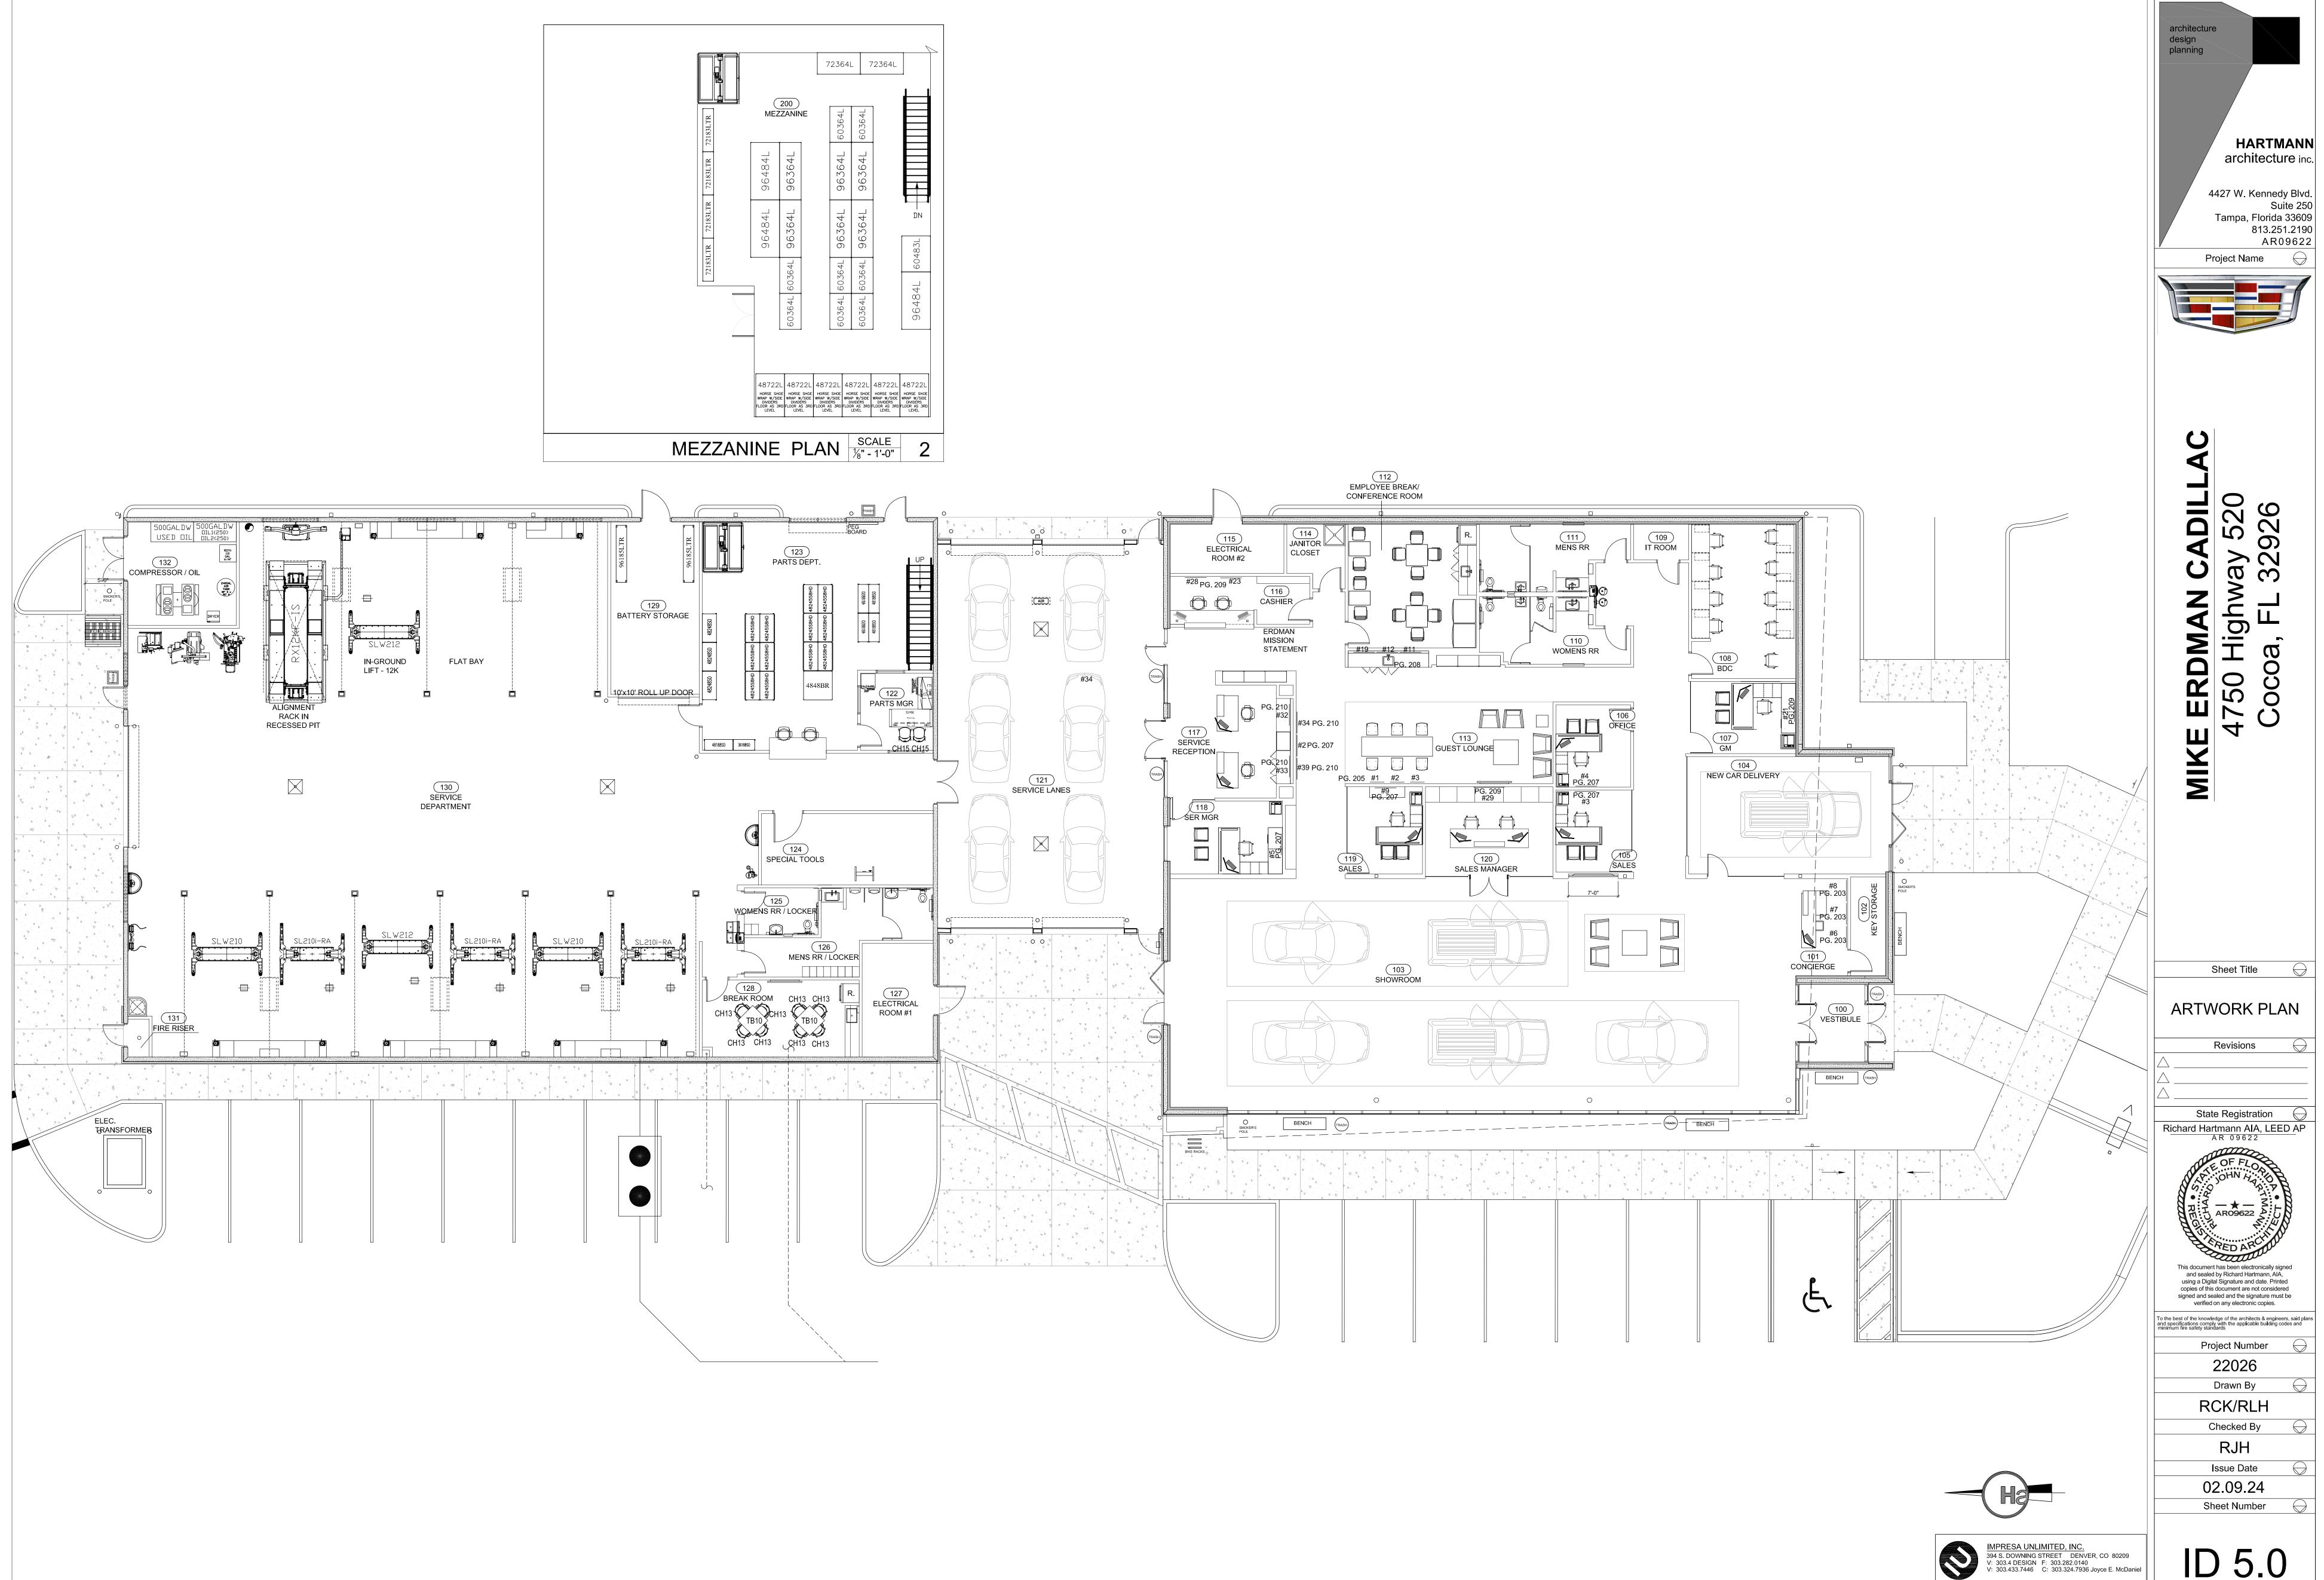



ARTWORK SCALE
1/8" = 1'-0"

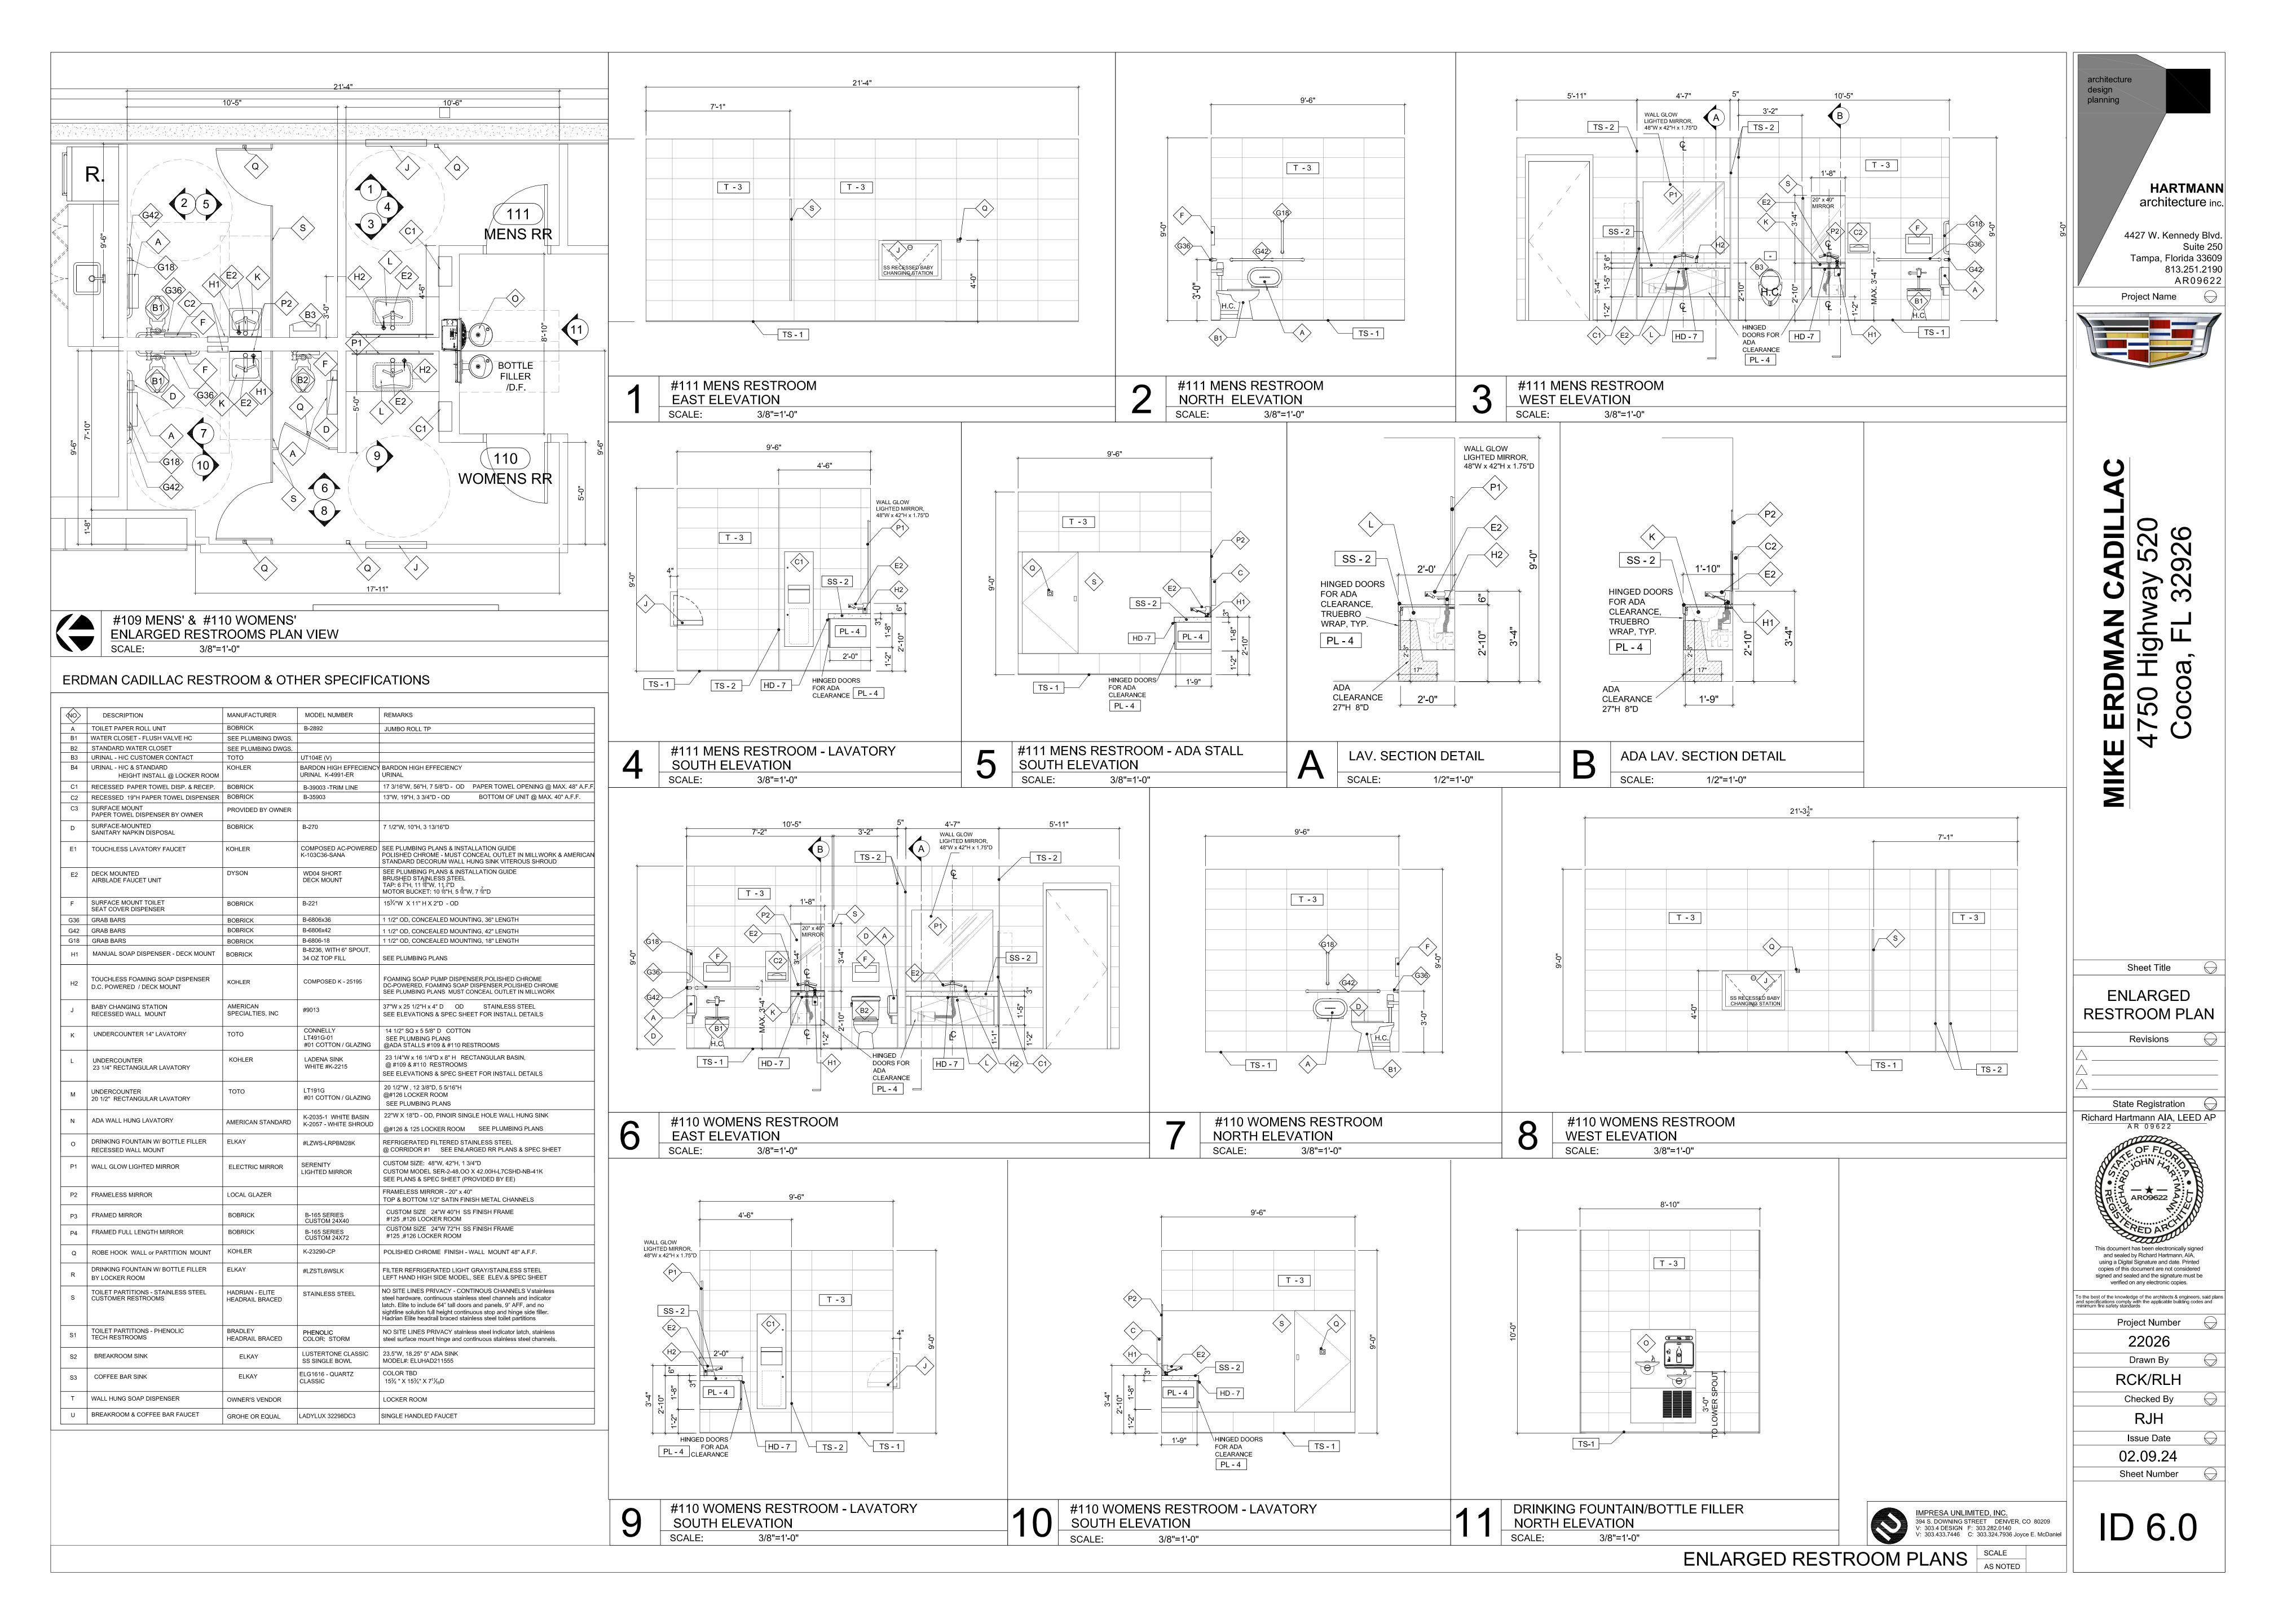

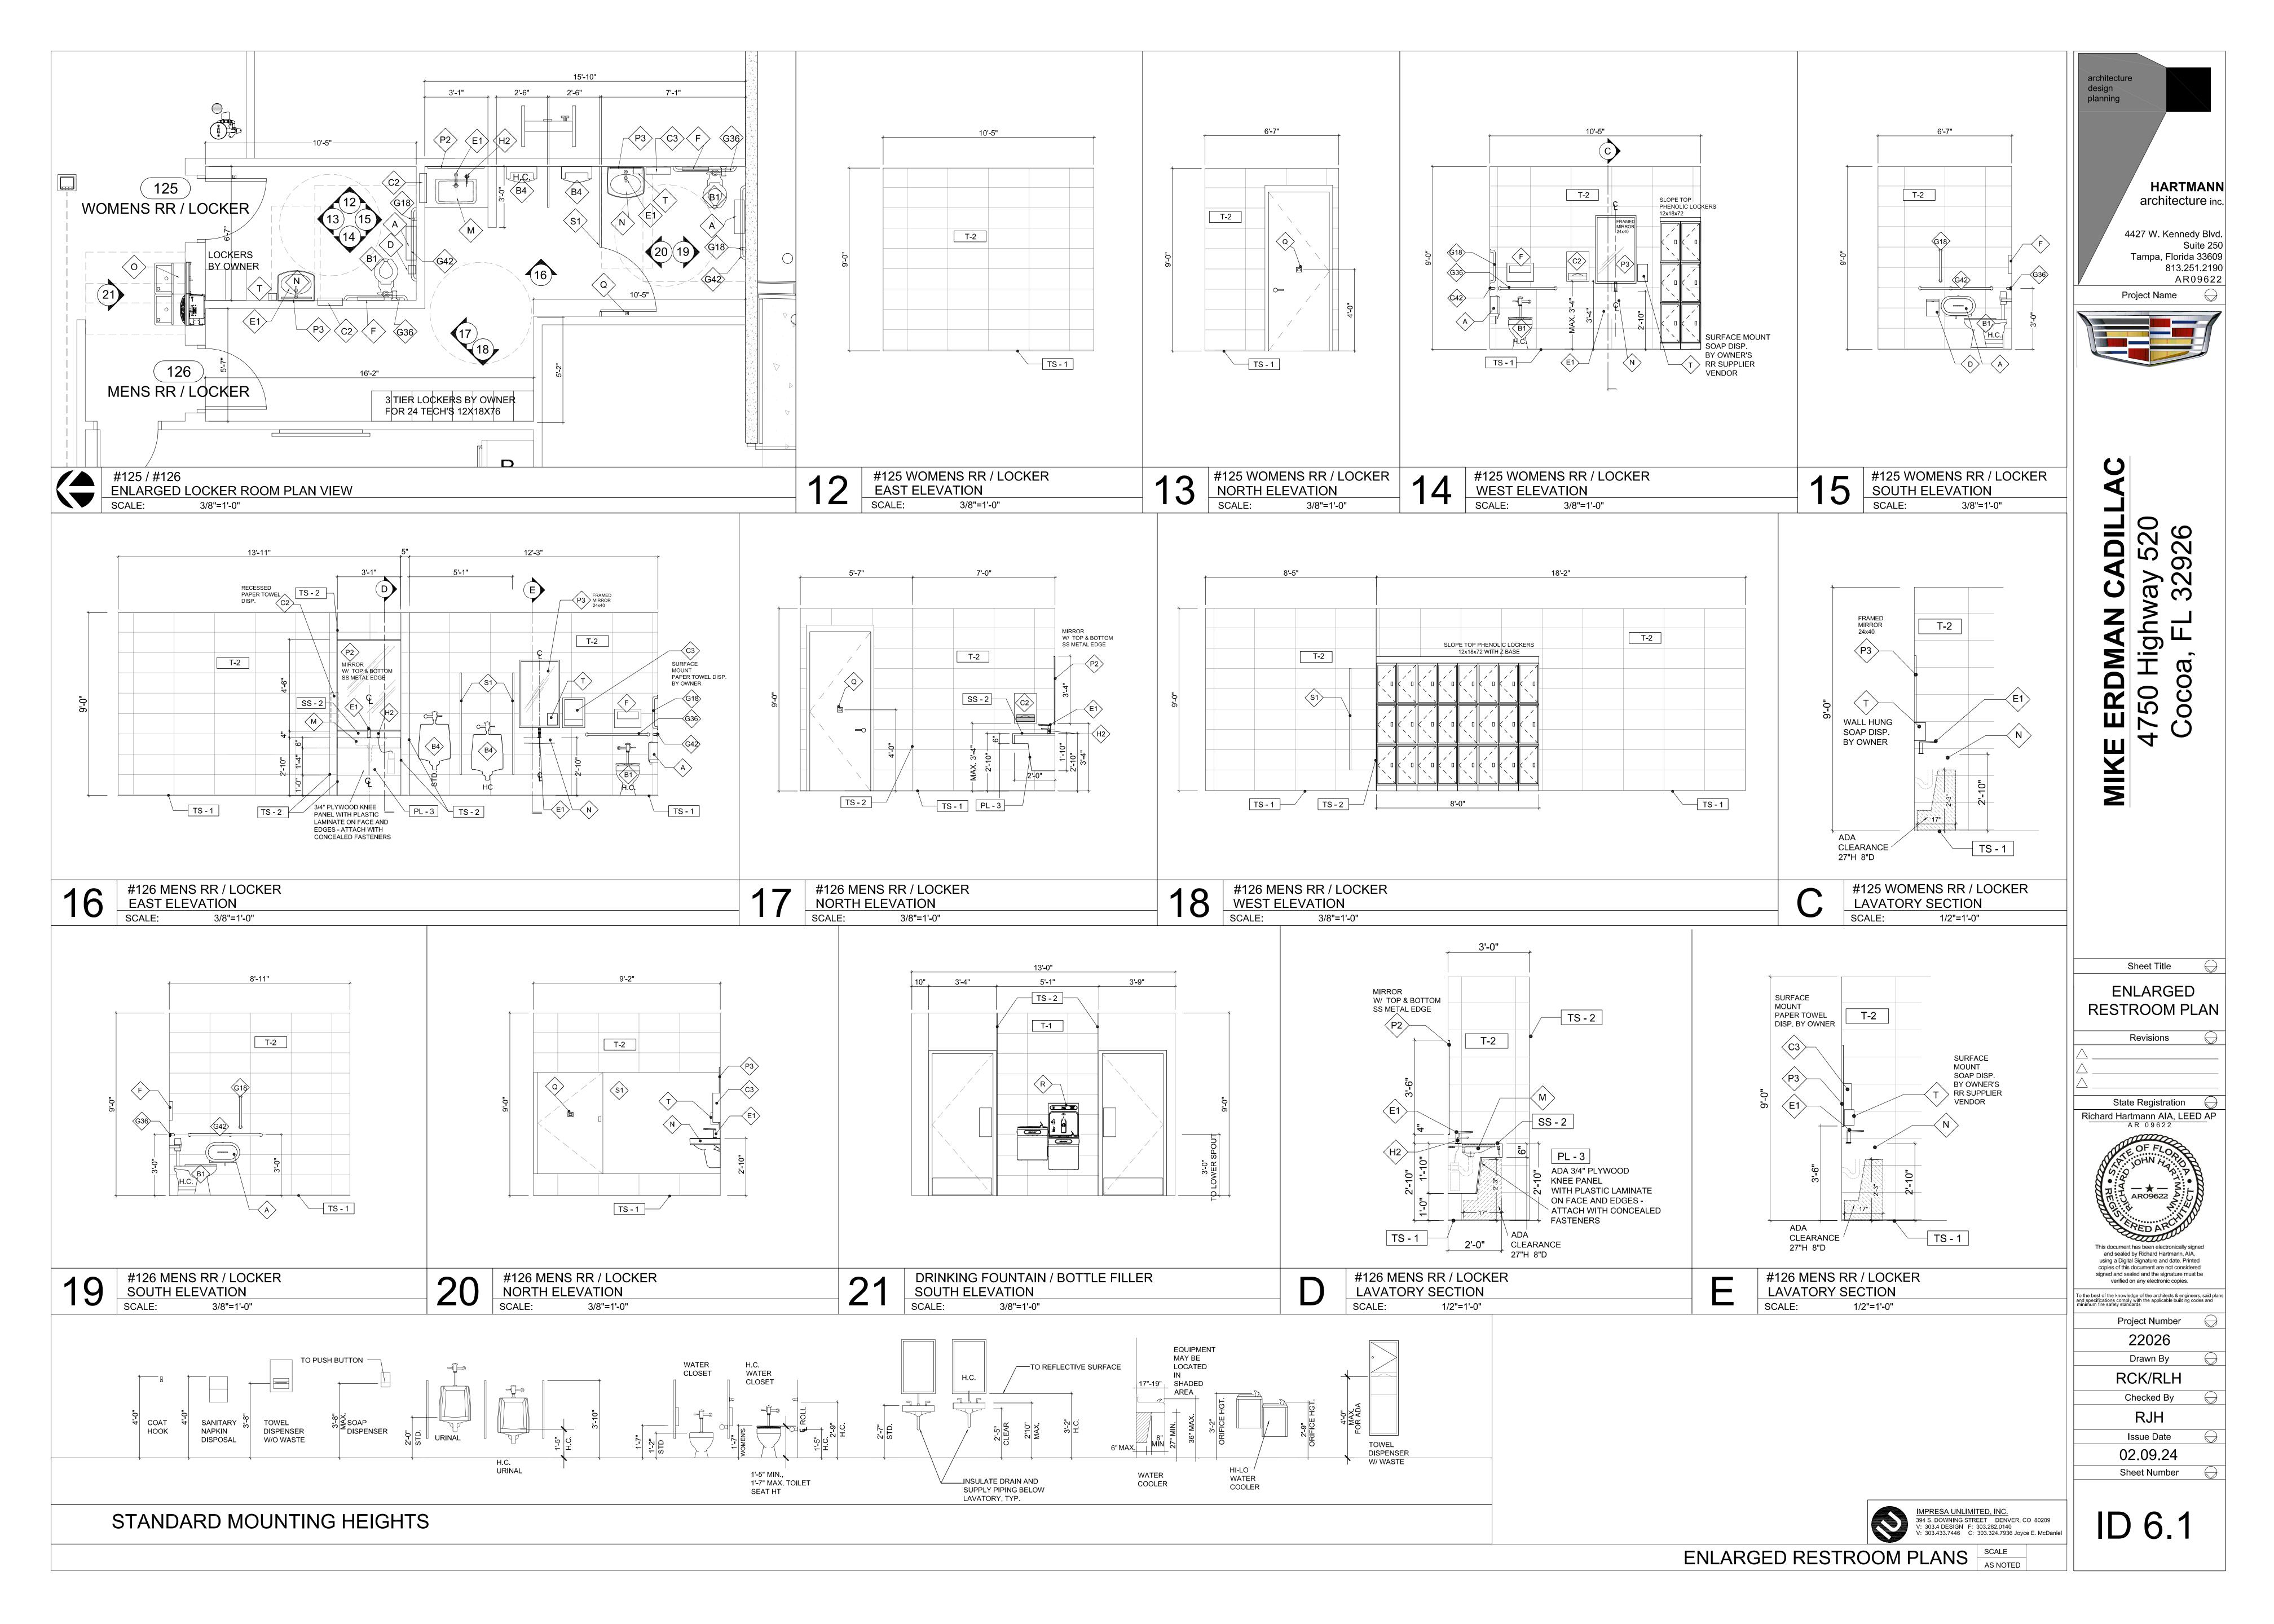

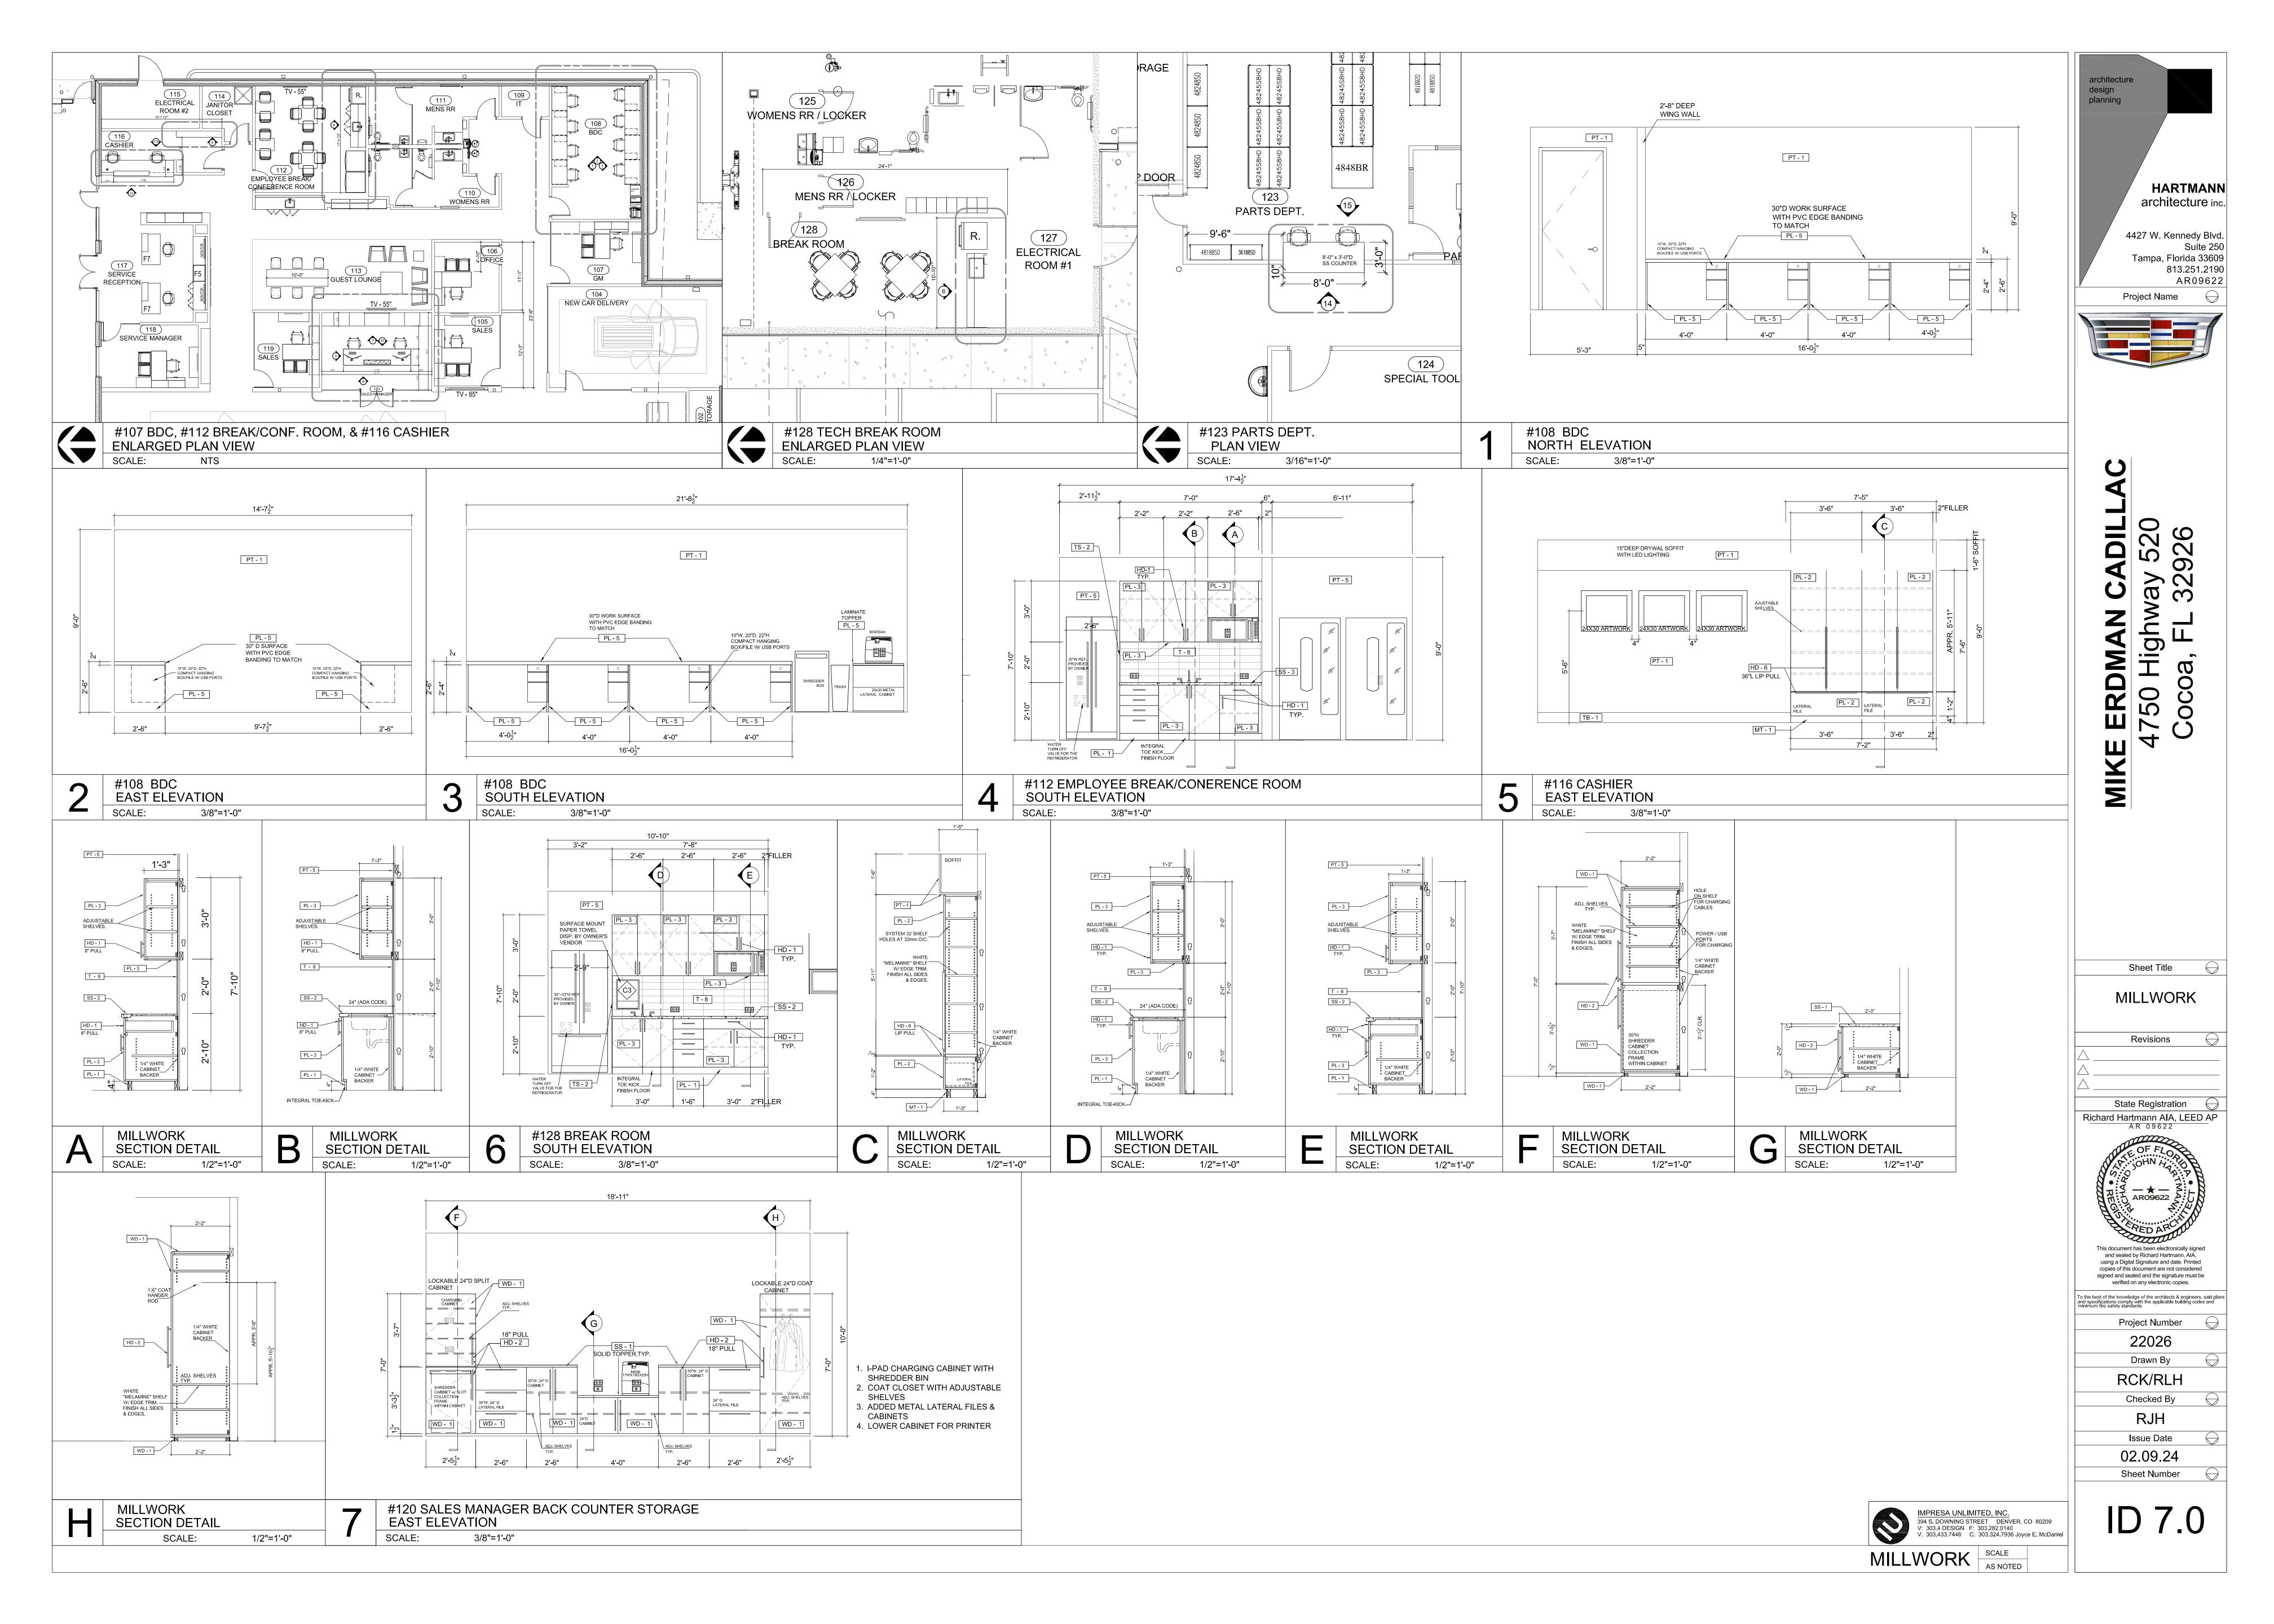

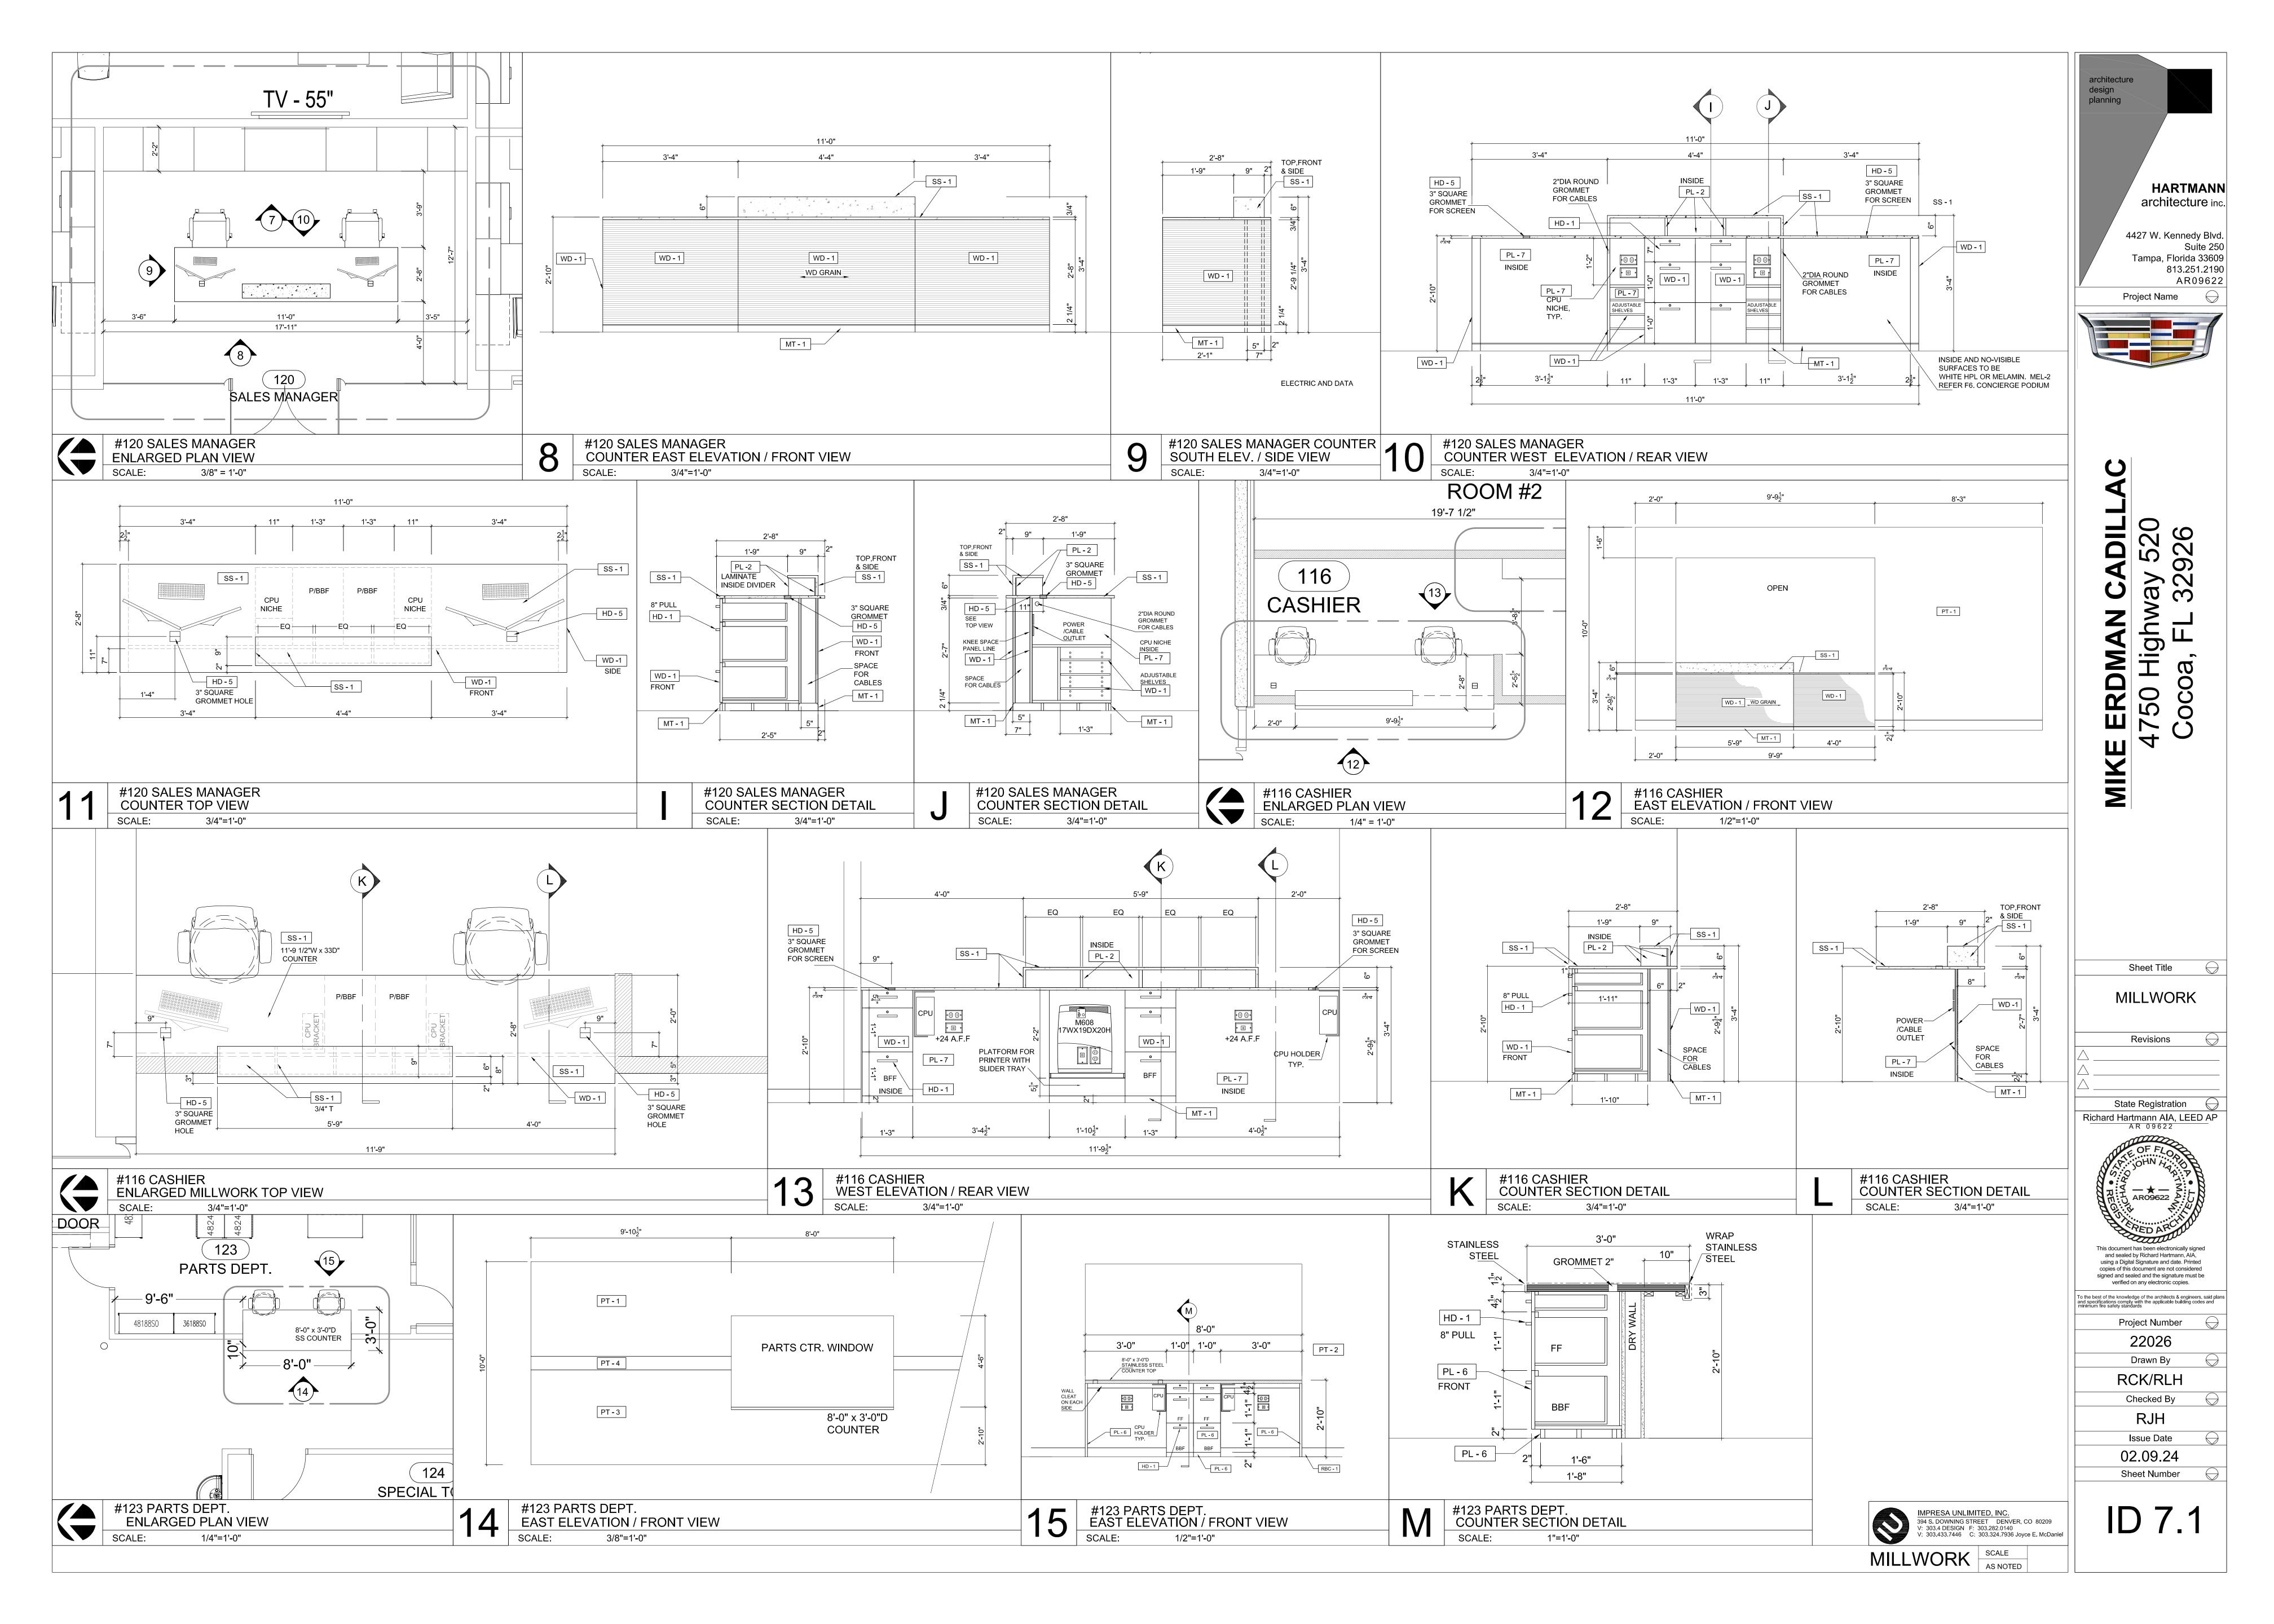

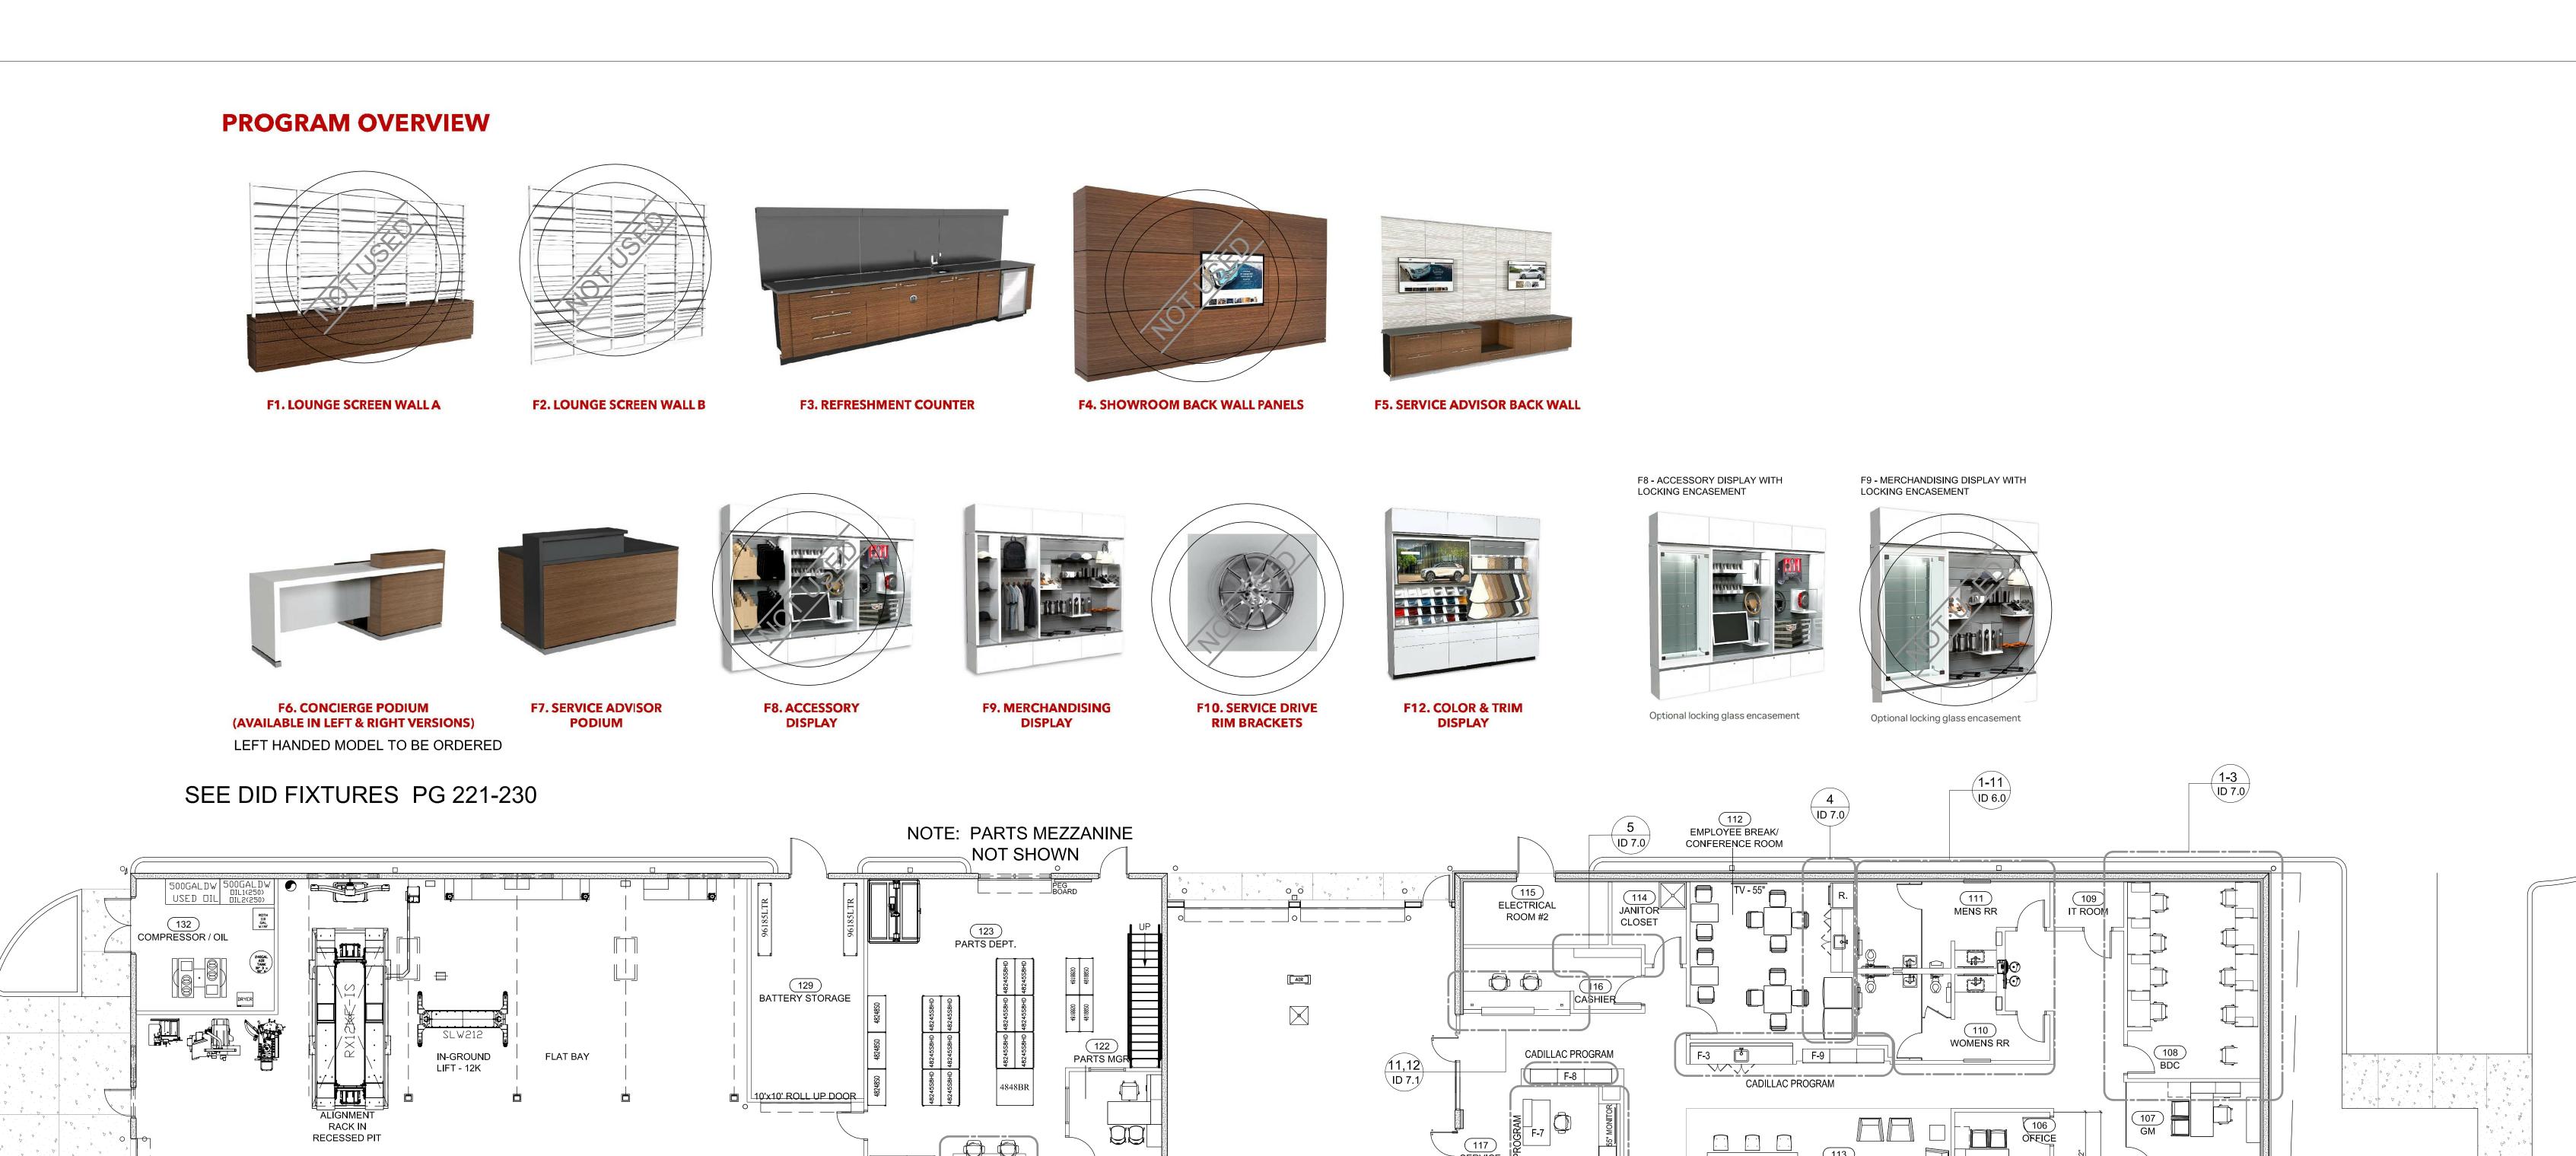

121 SERVICE LANES

13,14 ID 7.1

SPECIAL TOOLS

\_WOMENS RR / LOCKER

MENS RR / LOCKER

ELECTRICAL

130 SERVICE

DEPARTMENT

TRANSFORMER


RECEPTION

SERVICE MANAGER

CADILLAC PROGRAM SHOWROOM WOOD WALL SEE PLAN XXX

SALES MANAGER

103 SHOWROOM 8,9 ID 7.1

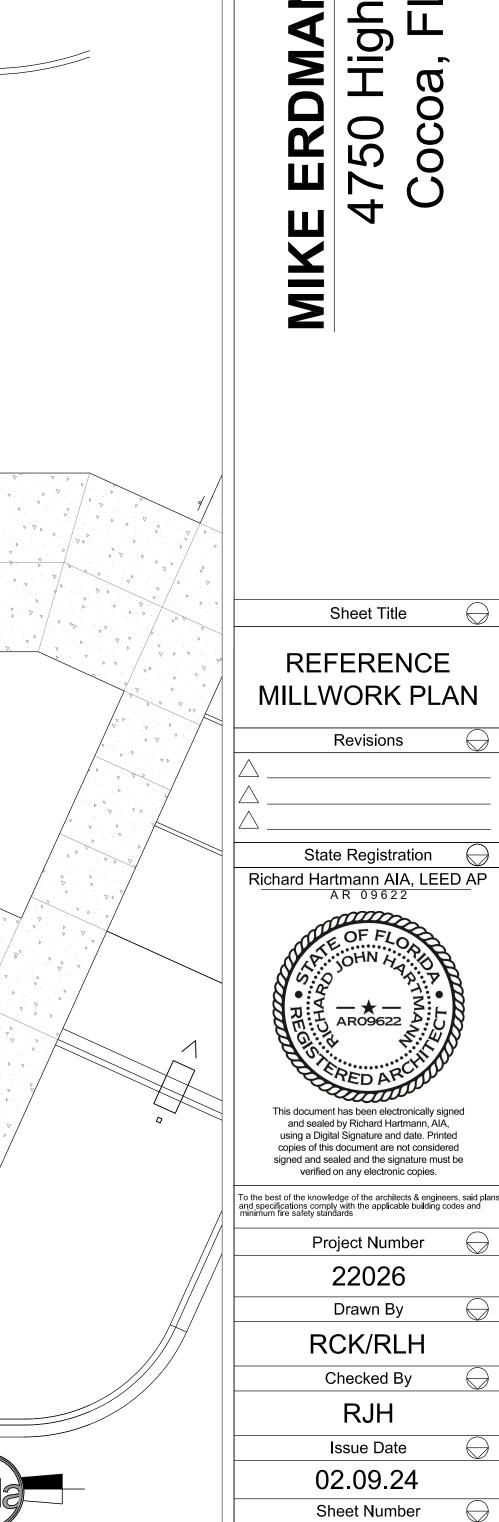

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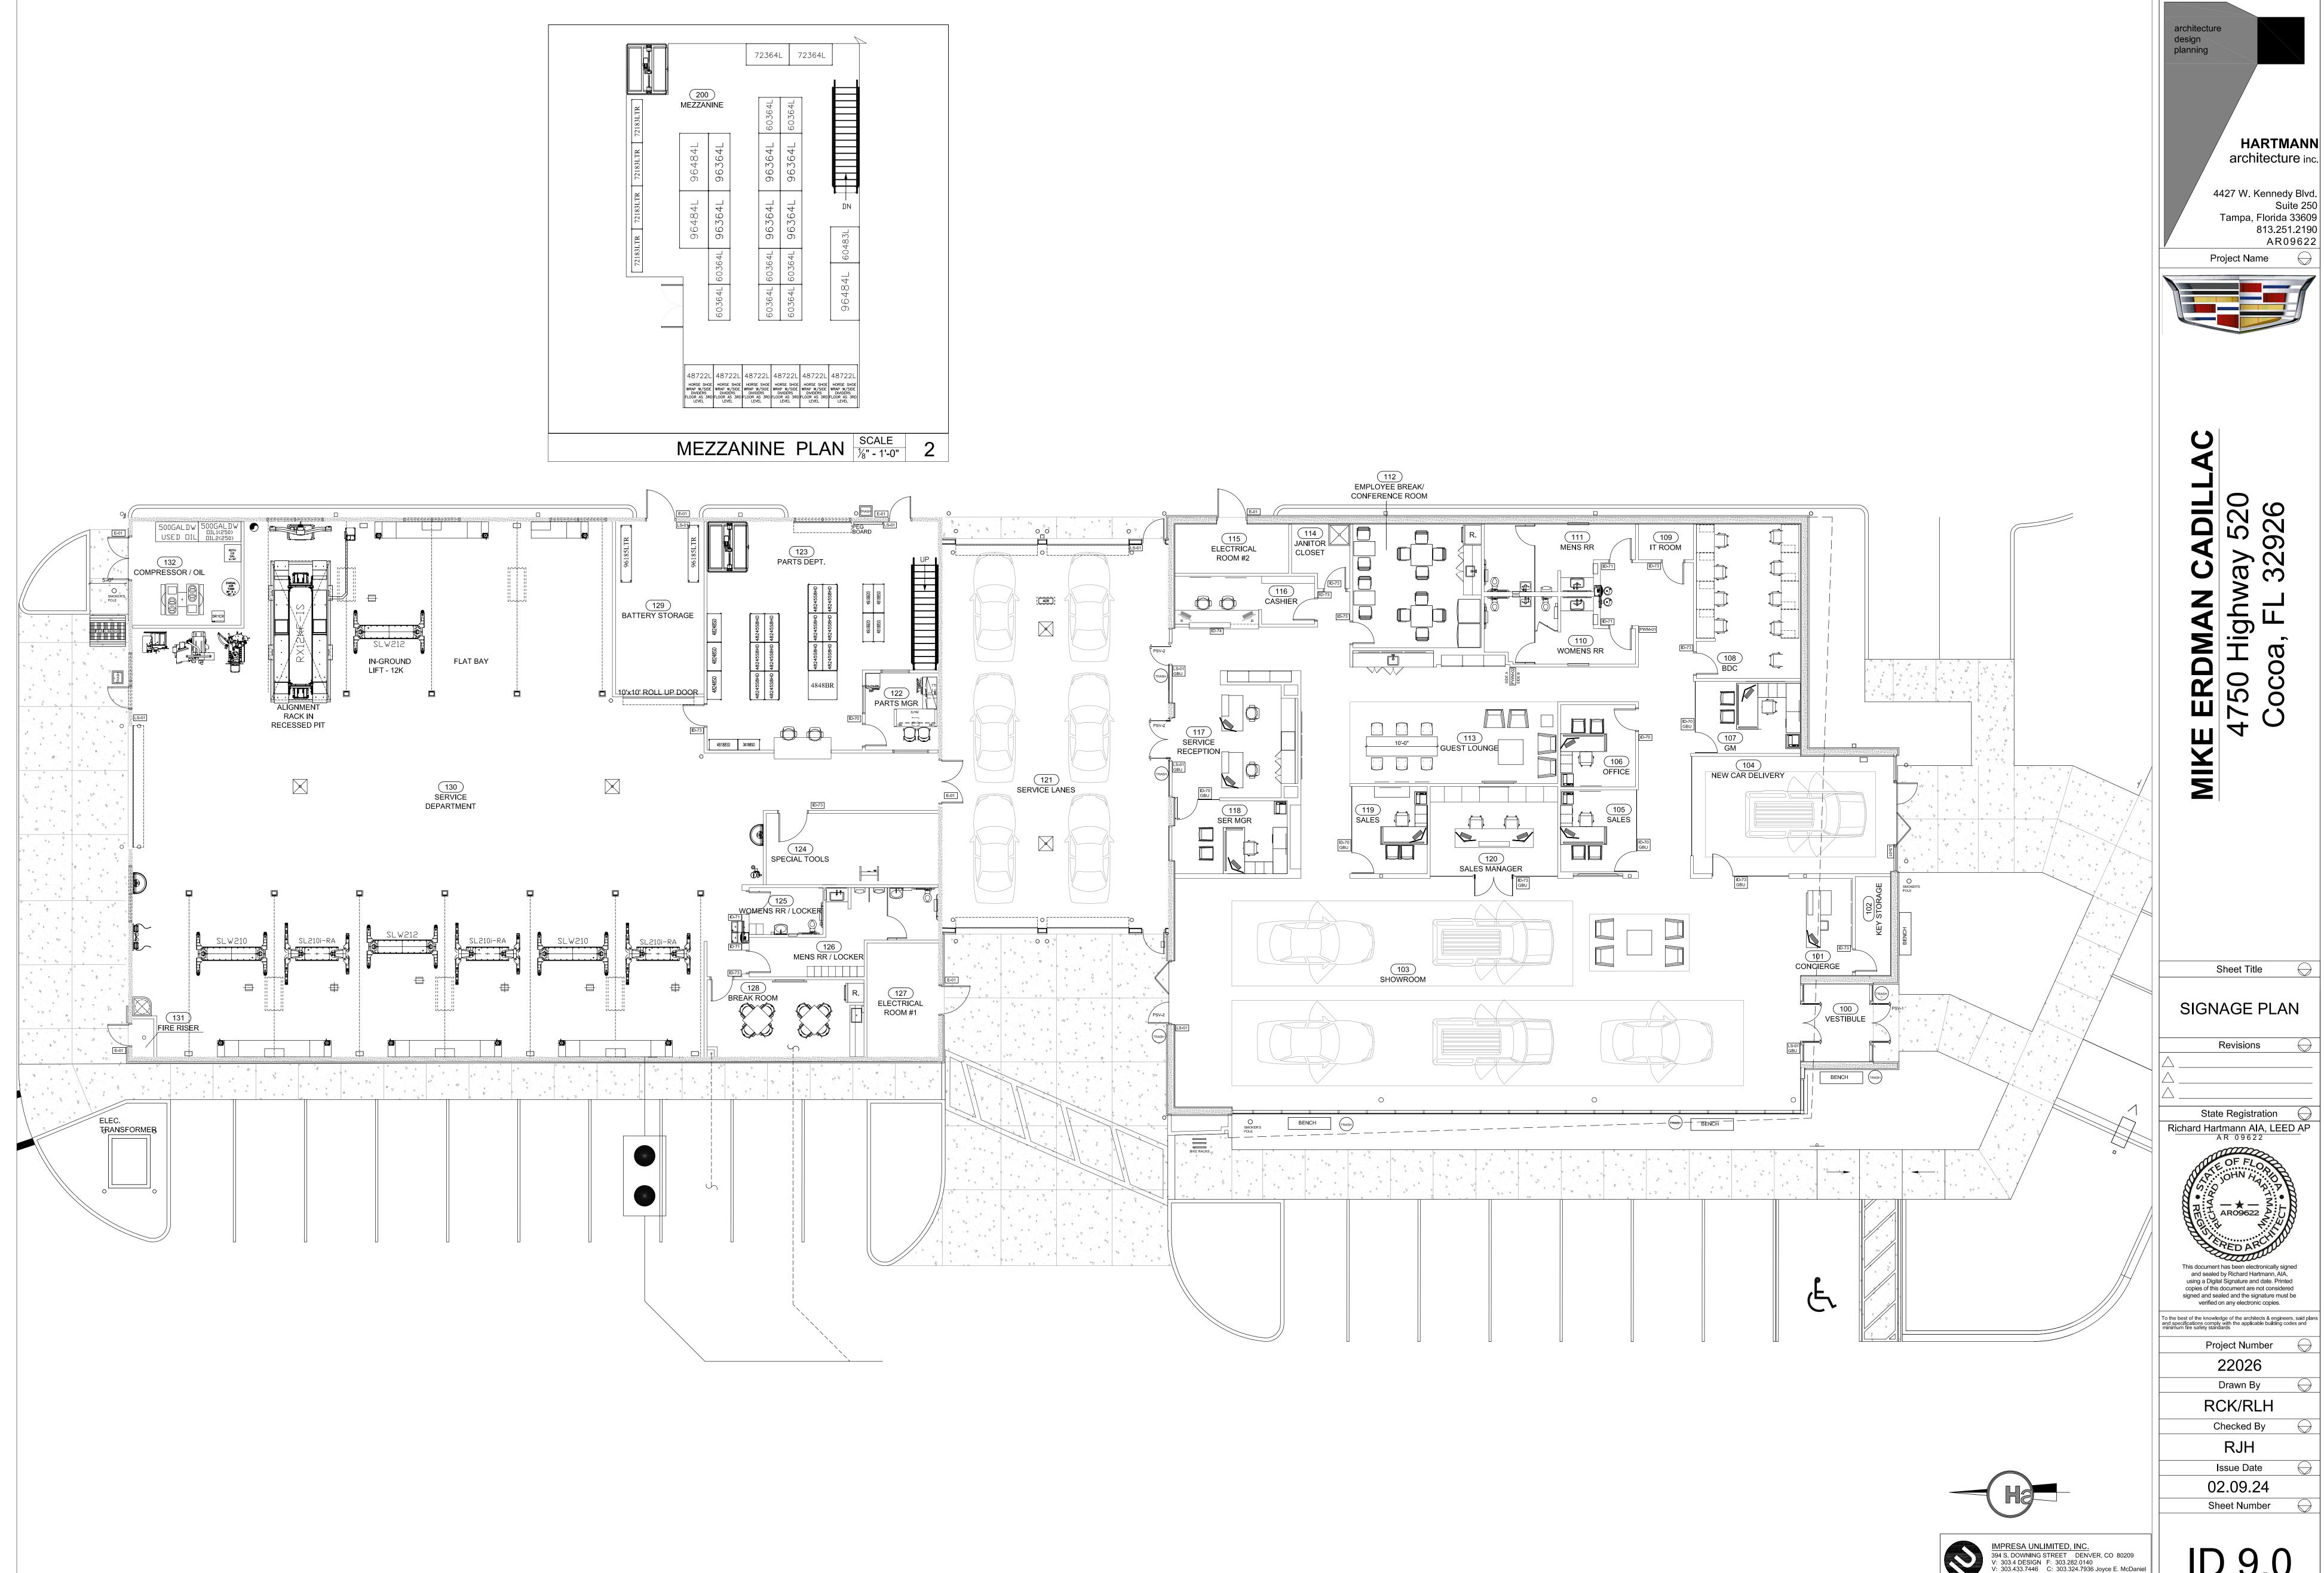
Tampa, Florida 33609

813.251.2190 AR09622

CADILLAC PROGRAM NEW CAR DELV. WOOD WALL SEE PLAN XXX

100 VESTIBULE

104 NEW CAR DELIVERY



SIGNAGE PLAN SCALE
1/8" = 1'-0"