
# CROSSTOWN RETAIL

# CIVIL CONSTRUCTION PLANS & SPECIFICATIONS

SECTION 4, TOWNSHIP 37 S, RANGE 39 E CITY OF PORT ST. LUCIE, FLORIDA

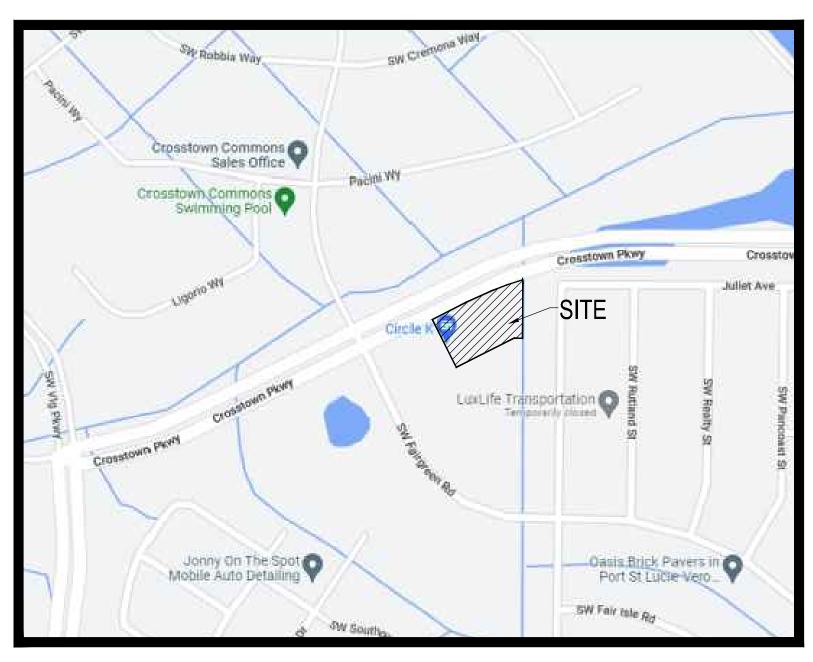

**LOCATION MAP** 

LEGAL DESCRIPTION

PARCEL 2 OF TRADITION PLAT NO. 82, ACCORDING TO THE PLAT THEREOF AS RECORDED IN PLAT BOOK 86, PAGE 29, OF THE PUBLIC RECORDS OF ST. LUCIE COUNTY, FLORIDA.



VICINITY \ AERIAL MAP

PLAN FOR THE MAYFAIR, LLC.

# **ENGINEER & SURVEYOR**



**ENGINEERING & SURVEYING, LLC.** 

1449 NW COMMERCE CENTRE DR PORT ST. LUCIE, FL 34986 PHONE: (772) 879-0477

SHEET NO.	DESCRIPTION
COV.	COVER SHEET
01	OVERALL SITE PLAN
00	CITE DI ANI

SITE PLAN

PAVING, GRADING & DRAINAGE PLANS

PAVING, GRADING & DRAINAGE DETAILS AND SPECIFICATIONS

WATER & WASTEWATER DETAILS AND SPECIFICATIONS **CLEARING AND SEDIMENT & EROSION CONTROL PLAN** 

STORMWATER POLLUTION PREVENTION PLAN

**GOVERNING DESIGN STANDARDS:** 

FLORIDA DEPARTMENT OF TRANSPORTATION, FY2023-24 STANDARDS PLANS FOR ROAD AND BRIDGE CONSTRUCTION AND APPLICABLE INTERIM REVISIONS (IRS).

STANDARD PLANS FOR ROAD CONSTRUCTION AND ASSOCIATED IRS ARE AVAILABLE AT THE FOLLOWING WEBSITE:

http://www.fdot.gov/design/standardplans

APPLICABLE IRS:

**GOVERNING STANDARD SPECIFICATIONS:** FLORIDA DEPARTMENT OF TRANSPORTATION, 2023-24 STANDARD SPECIFICATIONS FOR ROAD AND BRIDGE CONSTRUCTION AT THE FOLLOWING WEBSITE:

http://www.dot.state.fl.us/programmanagement/Implemented/SpecBooks

**GOVERNING SPECIFICATIONS:** 

CITY OF PORT ST. LUCIE PUBLIC WORKS DEPARTMENT ENGINEERING STANDARDS FOR LAND DEVELOPMENT (MOST CURRENT EDITION), AS AMENDED BY CONTRACT DOCUMENTS.

INDEX OF DRAWINGS

DESCRIPTION

SITE PLAN DETAILS

WATER & WASTEWATER PLAN

PORT ST. LUCIE, FL 34986

**NOT FOR CONSTRUCTION** 

DARREN GUETTLER, PI FLORIDA LICENSE No. 74637


CHECKED BY:

**COVER SHEET** 

SHEET NUMBER: COV.

ALWAYS CALL 81

CITY OF PSL PROJECT NO. P19-133-A PSLUSD FILE NO. 5342C

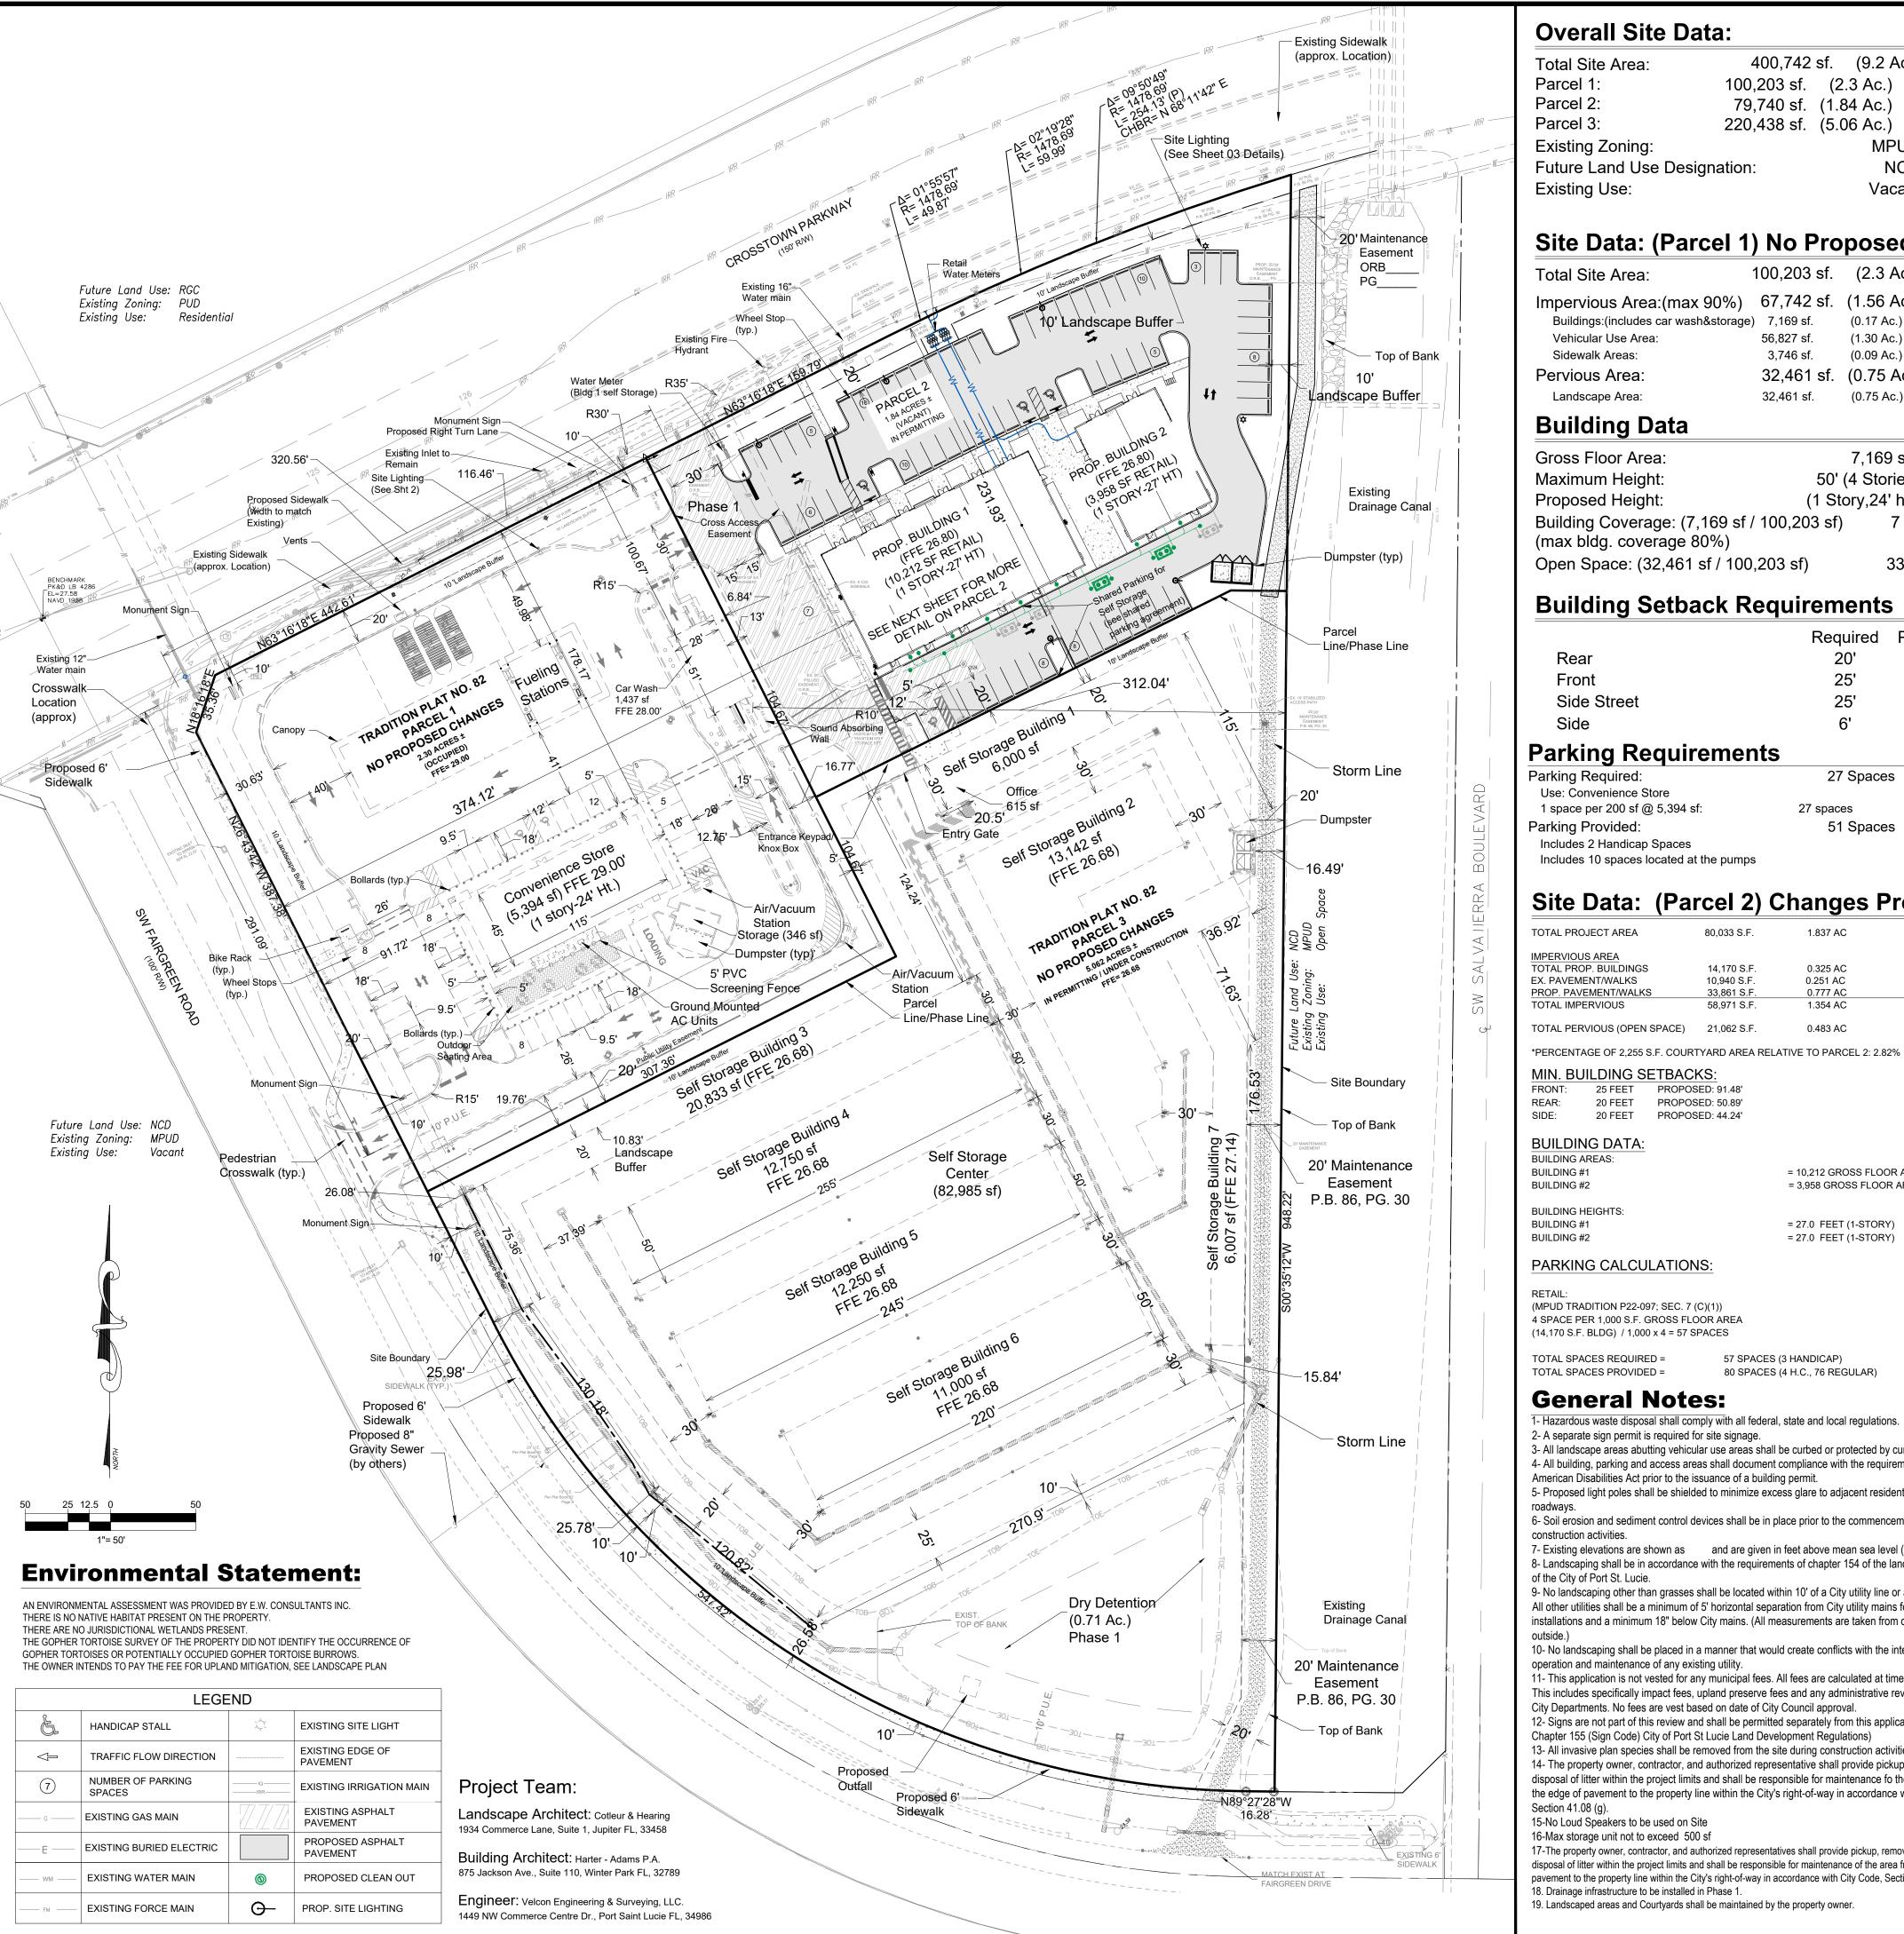

## **Overall Site Data:**

400,742 sf. (9.2 Ac.) Total Site Area: 100,203 sf. (2.3 Ac.) Parcel 1: Parcel 2: 79,740 sf. (1.84 Ac.) Parcel 3: 220,438 sf. (5.06 Ac.) Existing Zoning: Future Land Use Designation: NCD Existing Use: Vacant

# Site Data: (Parcel 1) No Proposed Changes

100,203 sf. (2.3 Ac.) Total Site Area: 67,742 sf. (1.56 Ac.) (67%) Impervious Area:(max 90%) Buildings:(includes car wash&storage) 7,169 sf. Vehicular Use Area: (1.30 Ac.) Sidewalk Areas: (0.09 Ac.) 3,746 sf. Pervious Area: 32,461 sf. (0.75 Ac.) (33%) 32,461 sf. Landscape Area: (0.75 Ac.)

# **Building Data**

7,169 s.f. **Gross Floor Area:** Maximum Height: 50' (4 Stories) (1 Story,24' ht.) Proposed Height: Building Coverage: (7,169 sf / 100,203 sf) (max bldg. coverage 80%)

### **Building Setback Requirements**

	Required	Provided	
Rear	20'	57.91'	
Front	25'	71'	
Side Street	25'	91.72'	
Side	6'	6'	

# **Parking Requirements**

Parking Required: 27 Spaces Use: Convenience Store 1 space per 200 sf @ 5,394 sf: 27 spaces 51 Spaces Parking Provided: Includes 2 Handicap Spaces

### Includes 10 spaces located at the pumps

# Site Data: (Parcel 2) Changes Proposed

TOTAL PROJECT AREA	80,033 S.F.	1.837 AC	100.00%
IMPERVIOUS AREA			
TOTAL PROP. BUILDINGS	14,170 S.F.	0.325 AC	17.70%
EX. PAVEMENT/WALKS	10,940 S.F.	0.251 AC	13.67%
PROP. PAVEMENT/WALKS	33,861 S.F.	0.777 AC	42.31%
TOTAL IMPERVIOUS	58,971 S.F.	1.354 AC	73.68%
TOTAL PERVIOUS (OPEN SPACE)	21,062 S.F.	0.483 AC	26.32%

= 27.0 FEET (1-STORY)

= 27.0 FEET (1-STORY)

### MIN. BUILDING SETBACKS: 25 FEET PROPOSED: 91.48' 20 FEET PROPOSED: 50.89'

**BUILDING DATA: BUILDING AREAS:** 

= 10.212 GROSS FLOOR AREA **BUILDING #1** = 3,958 GROSS FLOOR AREA **BUILDING #2** BUILDING HEIGHTS:

PROPOSED: 44.24'

**BUILDING #1 BUILDING #2** 

20 FEET

### PARKING CALCULATIONS:

(MPUD TRADITION P22-097; SEC. 7 (C)(1)) 4 SPACE PER 1,000 S.F. GROSS FLOOR AREA (14,170 S.F. BLDG) / 1,000 x 4 = 57 SPACES

TOTAL SPACES REQUIRED = 57 SPACES (3 HANDICAP) TOTAL SPACES PROVIDED = 80 SPACES (4 H.C., 76 REGULAR)

# **General Notes:**

1- Hazardous waste disposal shall comply with all federal, state and local regulations. 2- A separate sign permit is required for site signage.

3- All landscape areas abutting vehicular use areas shall be curbed or protected by curb stops. 4- All building, parking and access areas shall document compliance with the requirements of the American Disabilities Act prior to the issuance of a building permit. 5- Proposed light poles shall be shielded to minimize excess glare to adjacent residential areas and

6- Soil erosion and sediment control devices shall be in place prior to the commencement of construction activities.

7- Existing elevations are shown as and are given in feet above mean sea level (NAVD 1988). 8- Landscaping shall be in accordance with the requirements of chapter 154 of the landscape code of the City of Port St. Lucie.

9- No landscaping other than grasses shall be located within 10' of a City utility line or appurtenance. All other utilities shall be a minimum of 5' horizontal separation from City utility mains for parallel installations and a minimum 18" below City mains. (All measurements are taken from outside to

10- No landscaping shall be placed in a manner that would create conflicts with the intended

operation and maintenance of any existing utility. 11- This application is not vested for any municipal fees. All fees are calculated at time of payment. This includes specifically impact fees, upland preserve fees and any administrative review fees for City Departments. No fees are vest based on date of City Council approval.

12- Signs are not part of this review and shall be permitted separately from this application. (See Chapter 155 (Sign Code) City of Port St Lucie Land Development Regulations) 13- All invasive plan species shall be removed from the site during construction activities. 14- The property owner, contractor, and authorized representative shall provide pickup, removal, and disposal of litter within the project limits and shall be responsible for maintenance fo the area from the edge of pavement to the property line within the City's right-of-way in accordance with City Code,


15-No Loud Speakers to be used on Site 16-Max storage unit not to exceed 500 sf

17-The property owner, contractor, and authorized representatives shall provide pickup, removal, and disposal of litter within the project limits and shall be responsible for maintenance of the area from the edge of pavement to the property line within the City's right-of-way in accordance with City Code, Section 41.08 (g). 18. Drainage infrastructure to be installed in Phase 1.

19. Landscaped areas and Courtyards shall be maintained by the property owner.

# **Drainage Note:**

1- Project is required to meet the requirements of SFWMD and the City 2- On site stormwater drainage shall be a detention area. Water quality and continuation will be provided in accordance with the SFWMD permi 3-THE PROJECT IS LOCATED IN BASIN BCANAL-4 OF TRADITION CONTROLLED DISCHARGE TO THE EAST AND INTO THE BCANAL VIA THE EXISTIN CONTROL STRUCTURE DS-LBC4.

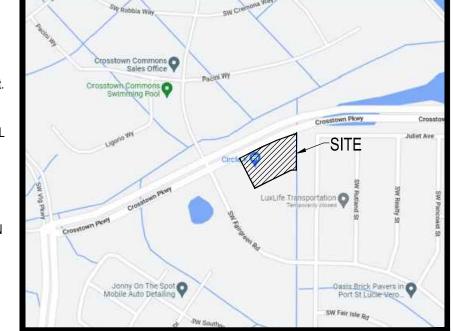

**LOCATION MAP** SEC. 04, TWN 37S, RANGE 39E

### **Legal Description:**

TO THE PLAT OF TRADITION PLAT NO. 32, AS RECORDED IN PLAT BOOK 62, PAGE 5, PUBLIC RECORDS OF ST. LUCIE COUNTY, FLORIDA CONTAINING 9.20 ACRES, MORE OR LESS.

# Site Data: (Parcel 3) No Proposed Changes

Total Site Area:	220,524.85 sf.	(5.06 Ac.)	
Impervious Area:(max 9	90%) 150,868 sf.	(3.46 Ac.)	(70%)
Buildings:	82,597 sf.	(1.87 Ac.)	
Vehicular Use Area:	67,989 sf.	(1.56 Ac.)	
Sidewalk Areas:	282 sf.	(0.01 Ac.)	
Pervious Area:	69,656.85 sf.	(1.6 Ac.)	(30%)
Dry Retention:	34,237 sf.	(0.78 Ac.)	
Landscape Area:	35,419.85 sf.	(0.75 Ac.)	

### **Building Data**

**Gross Floor Area:** 82,597 s.f. Maximum Height: 50' (4 Stories) Proposed Height: (1 Story-28' ht.) Building Coverage: (82,5597 sf / 220,438 sf) 37 % (max bldg. coverage 80%) StorageUnits: (approx. 600)

Open Space: (69,656 sf / 220,438 sf)

# **Building Setback Requirements**

	Required	Provided
Side East	20'	20'
Side Street	25'	231.93'
Front	10'	26.56'

# **Parking Requirements**

Parking Required: 9 Spaces Use: Self Storage (office) 1 space per 250 sf @ 615 sf: 3 Spaces Storage Bays 1 per 100 bays (approx 600) Parking Provided: 9 Spaces (shared parking with parcel 2) Includes 1 Handicap Spaces

# **Traffic Statement:**

TRIP GENERATION FOR THIS SITE IS BASED UPON THE INSTITUTE OF TRANSPORTATION ENGINEERS (ITE) MANUAL, 11TH EDITION

### Traffic Generation

The daily and peak hour traffic generation for the development used the trip generation rates for Convenience Store/Gas Station (ITE Land Use 945) Strip Retail Plaza (ITE Land Use 822), and Self Storage (ITE Land Use 151). The proposed development plan consists of the following:

### Proposed Use

• 5,394 SF Convenience Store - GFA (4-.5.5k s.f.)(ITE Land Use 945)

Based on the number of vehicle fueling positions (20 provided) Weekday Daily Trips: avg. rate = 257.13 x (# OF) V.F.P.

257.13 x 20 (V.F.P.) = **5,143 trips** A.M. Peak Hour Trips: avg. rate = 27.04 x (# OF) V.F.P.

27.04 x 20 (V.F.P.) = **541 trip**s P.M. Peak Hour Trips: avg. rate = 23.88 x (# OF) V.F.P.

23.88 x 20 (V.F.P.) = **478 trip**s

13.24 x 14,170 s.f. /1000 s.f. = **188 trips** 

• 14,170 SF Strip Retail Plaza (ITE Land Use 822) Weekday Daily Trips: avg. rate = 54.45 / 1000 s.f.

54.45 x 14,170 s.f. /1000 s.f. = **772 trips** 

**A.M. Peak Hour Trips**: avg. rate = 7.60 / 1000 s.f. 7.60 x 14,170 s.f. /1000 s.f. = **108 trips** 

**P.M. Peak Hour Trips**: avg. rate = 13.24 / 1000 s.f.

• 82,985 SF Mini-Warehouse (ITE Land Use 151)

Weekday Daily Trips: avg. rate = 1.45 / 1000 s.f.

1.45 x 82,597 s.f. /1000 s.f. = **120 trips A.M .Peak Hour Trips**: avg. rate = 0.18 / 1000 s.f.

0.18 x 82,597 s.f. /1000 s.f. = **15 trips** 

**P.M.Peak Hour Trips**: avg. rate = 0.18 / 1000 s.f.

0.18 x 82,597 s.f. /1000 s.f. = **15 trips** 

The proposed project is expected to generate the following net external trips: 6,035 daily, 664 AM peak hour, and 681 PM peak hour.

> KNOW WHAT'S BELO' ALWAYS CALL 81 BEFORE YOU DIC www.callsunshine.com

**OVERALL SITE PLAN** 

SHEET TITLE:

PSLUSD FILE NO. 5342C

1449 NW COMMERCE CENTRE DR PORT ST. LUCIE, FL 34986

**NOT FOR CONSTRUCTION** 

PER CITY OF PS

SPRC COMMENTS

PER CITY OF PSL SPRC COMMENTS

PER CITY OF PSL


SPRC COMMENTS


DARREN GUETTLER, PE FLORIDA LICENSE No. 74637 5/11/23

PROJECT No. DRAWN BY: CHECKED BY: CAD I.D.: 22- 1033 - SITE PLAN

SHEET NUMBER:

CITY OF PSL PROJECT NO. P19-133-A

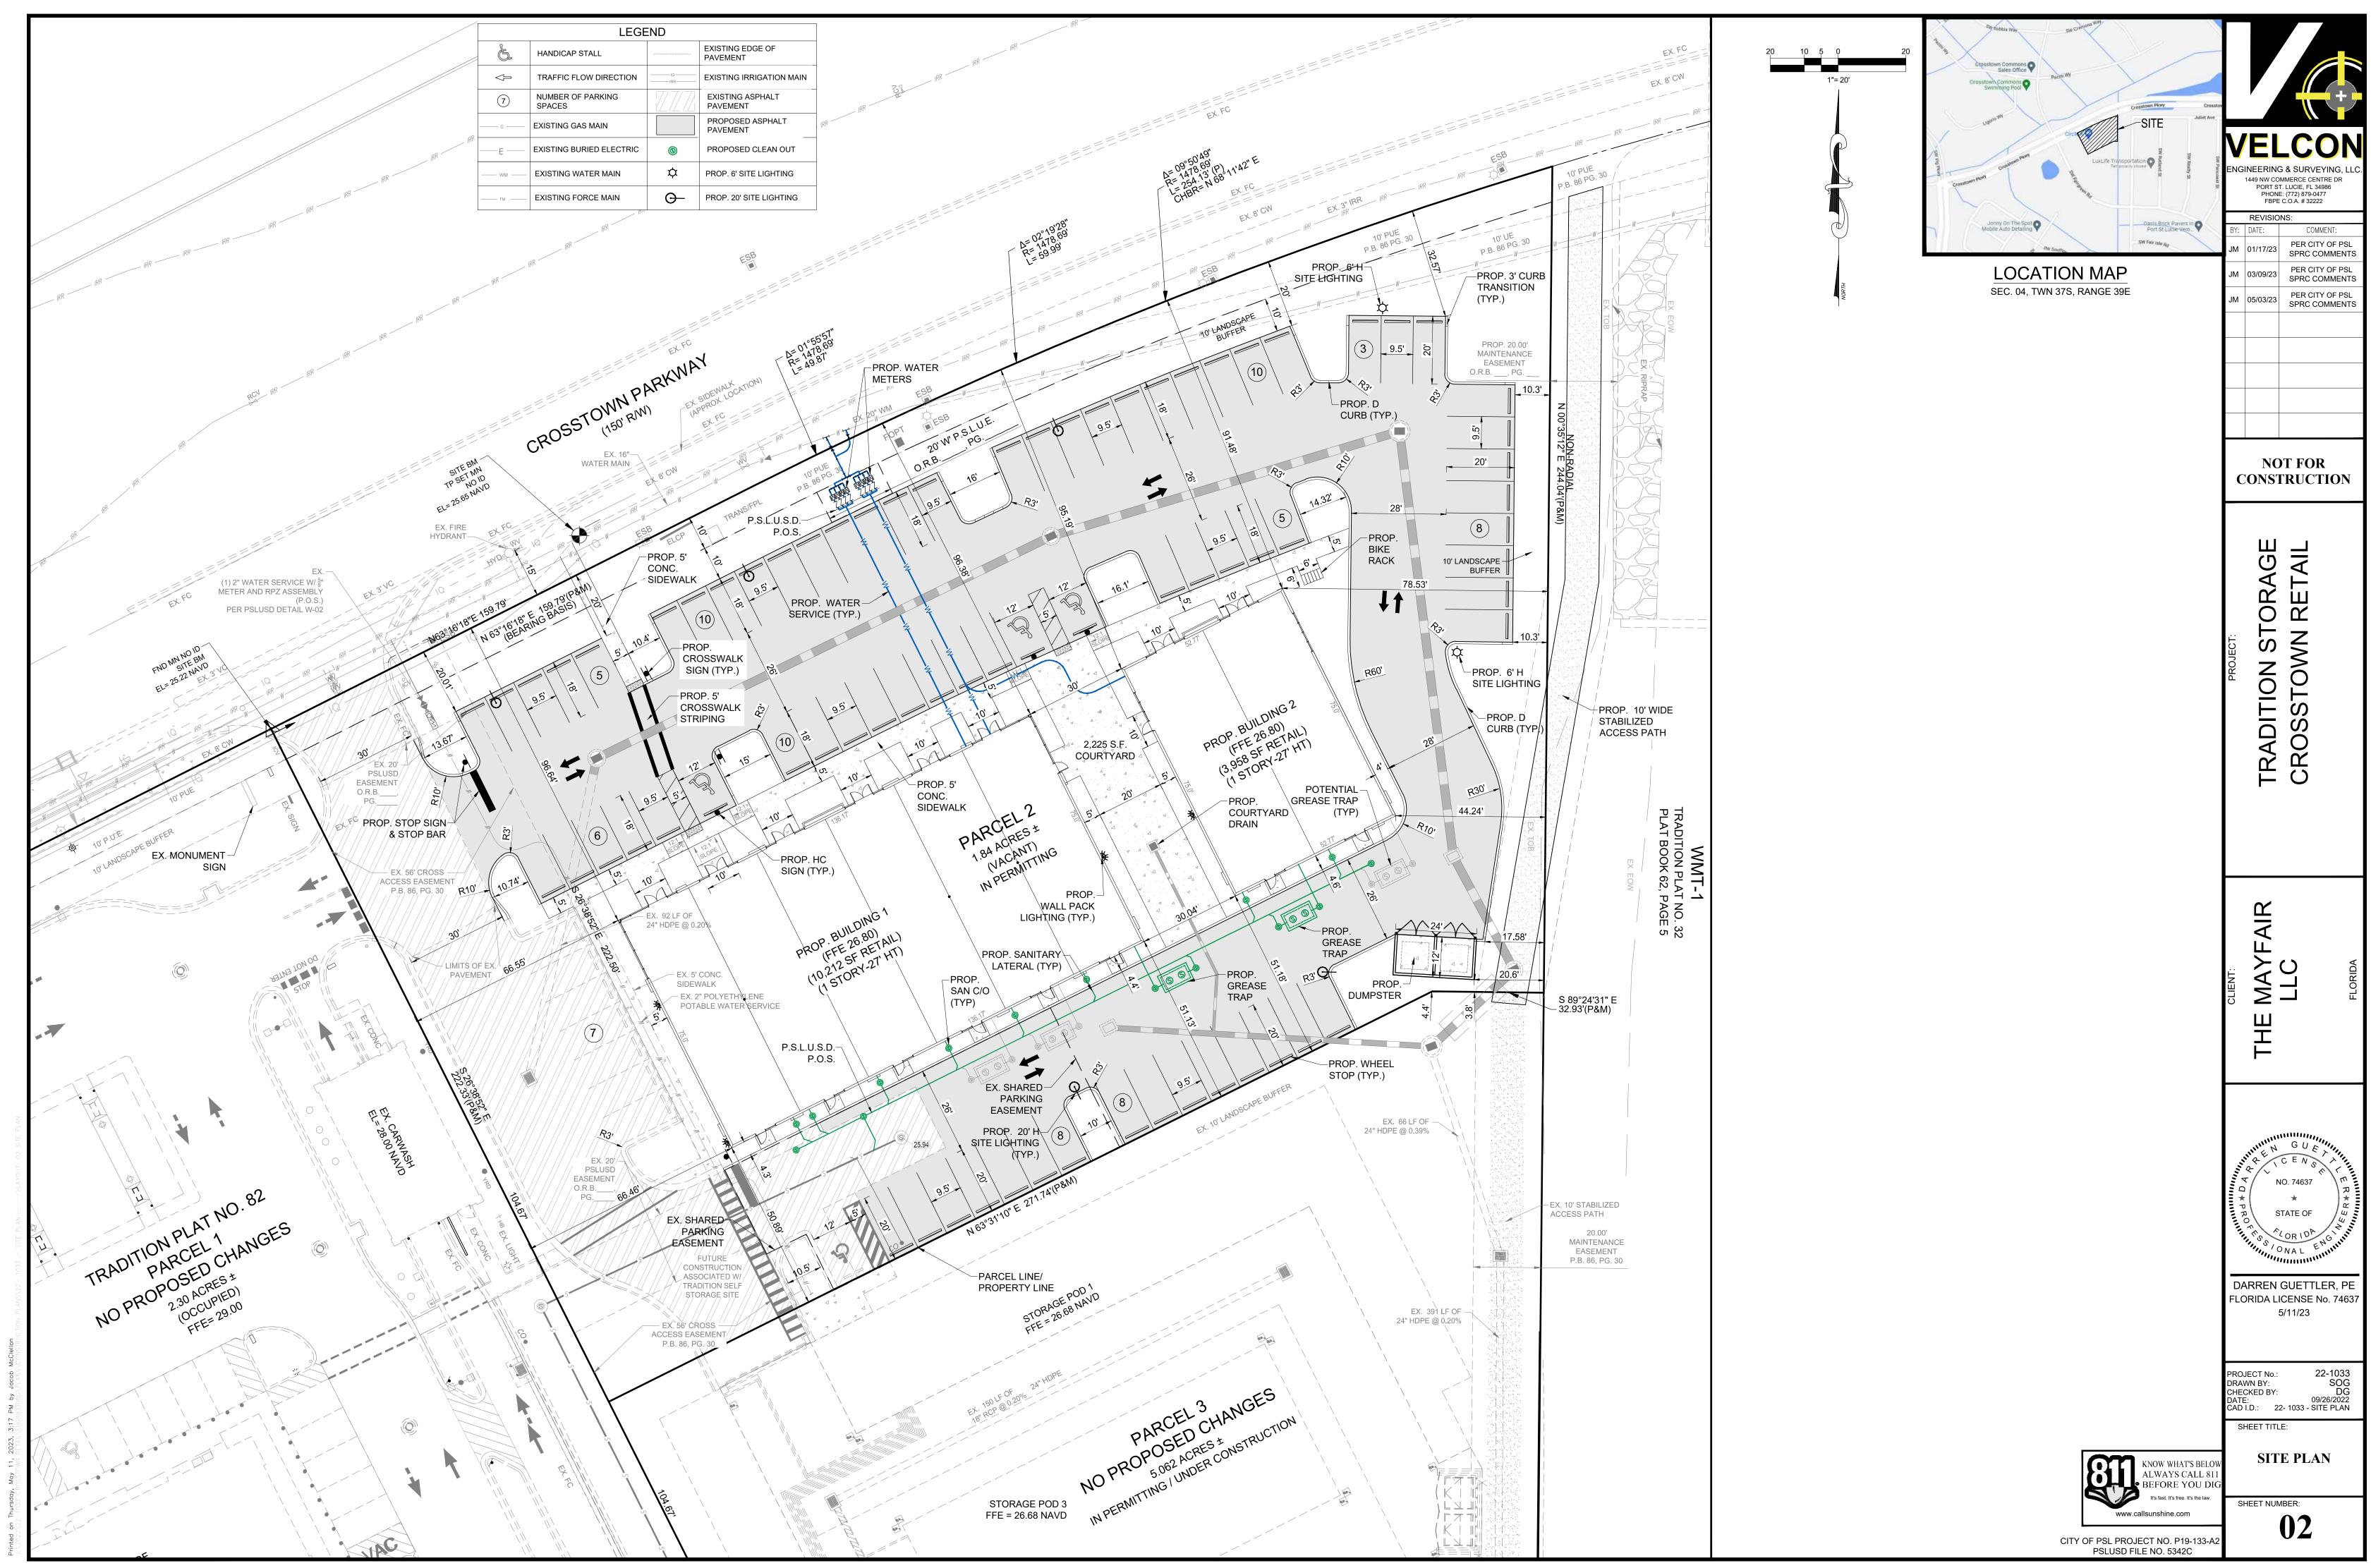

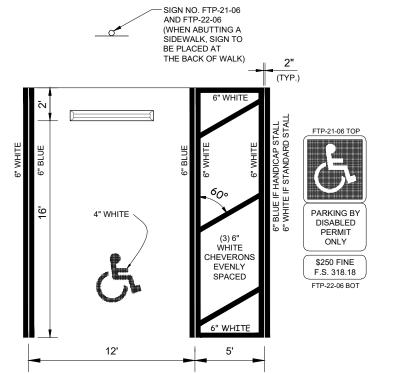



NOTES:

1. HANDICAP STALL IS BASED FROM FDOT STANDARD INDEX

- #17346, SHEET 12 OF 14. 2. DIMENSIONS ARE TO THE CENTERLINE OF MARKINGS.
- 3. BLUE PAVEMENT MARKINGS SHALL BE TINTED TO MATCH SHADE 15180 OF FEDERAL STANDARDS 595a.
- 4. FTP-22-06 PANEL SHALL BE MOUNTED BELOW THE FTP-21-06
- 5. FOR DESIGN OF THE UNIVERSAL SYMBOL OF ACCESSIBILITY, REFERENCE FDOT STANDARD INDEX #17346, SHEET 12 OF 14.
- 6. FOR DESIGN OF THE ASSOCIATED SIGNS, REFERENCE FDOT STANDARD INDEX #17355, SHEET 4 OF 11.
- 7. 2 COATS OF RETRO-REFLECTIVE TRAFFIC PAINT REQUIRED.

HANDICAP SPACE DETAIL N.T.S.

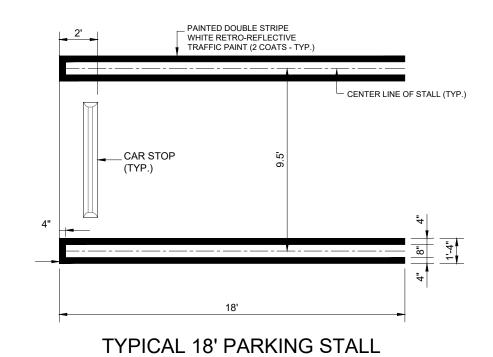

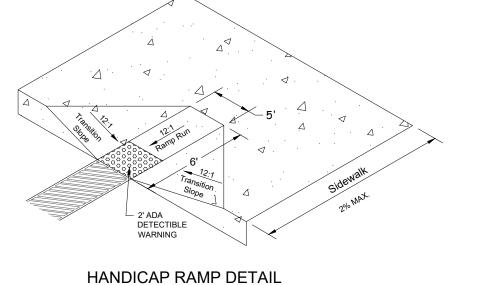

BASE


8" 3,000 P.S.I. CONCRETE

NOTE: SAWCUTS REQUIRED AT 10' CENTERS.

TYPE "D" CURB

─ 3,000 P.S.I.

N.T.S.

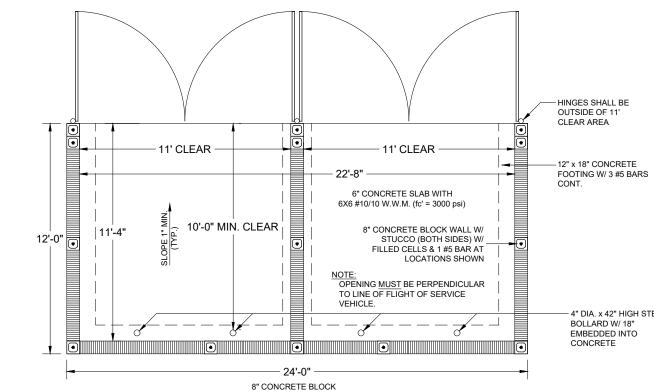


100% OPAQUE GATES (SOLID WOOD OR METAL SHEETING) WITH STEEL FRAMES

8" CONCRETE BLOCK


8" x 8" BOND BEAM

BOLLARD STUCCO

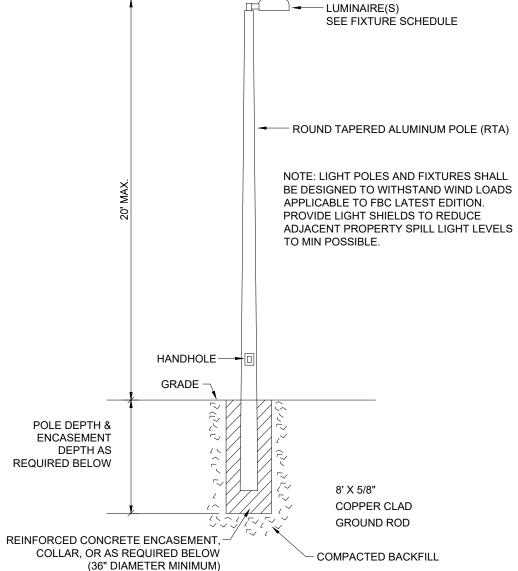

NOTE: PROVIDE SHOP DRAWINGS SIGNED AND SEALED BY A FLORIDA REGISTERED PROFESSIONAL ENGINEER. SHOP DRAWINGS SHALL INCLUDE THE POLE, LUMINAIR, AND REINFORCED CONCRETE ENCASEMENT CALCULATIONS, IF REQUIRED, TO SHOW COMPLIANCE WITH FLORIDA BUILDING CODE FOR WIND LOADING. SHOP DRAWINGS MAY BE FOR WORSE CASE SOIL CONDITIONS OR MAY BE BASED ON ACTUAL SITE SOIL BORINGS AND ANALYSIS FOR EACH POLE LOCATION AS VERIFIED BY THE FLORIDA REGISTERED PROFESSIONAL ENGINEER AND DOCUMENTED IN THE SHOP DRAWINGS. ALL ASSOCIATED COSTS FOR THE TOTAL INSTALLATION INCLUDING SHOP DRAWINGS, SOIL TESTING AND DESIGN FEES SHALL BE INCLUDED IN THE CONTRACT.

20' POLE MOUNTING DETAIL

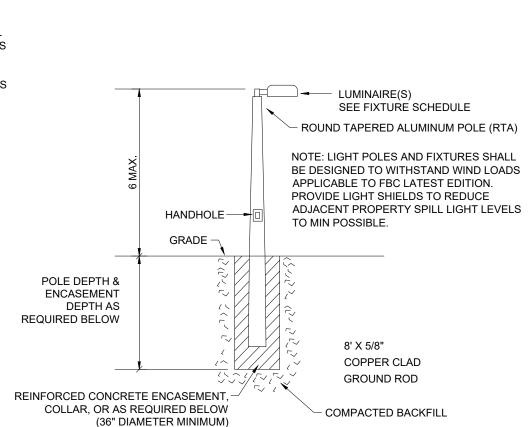

1449 NW COMMERCE CENTRE DR PORT ST. LUCIE, FL 34986 PHONE: (772) 879-0477 FBPE C.O.A. # 32222

JM 01/17/23 SPRC COMMENTS

**NOT FOR** 

CONSTRUCTION

COMMENT:

PER CITY OF PSI


PER CITY OF PSL SPRC COMMENTS

PER CITY OF PSL

SPRC COMMENTS

REVISIONS:

JM 03/09/23

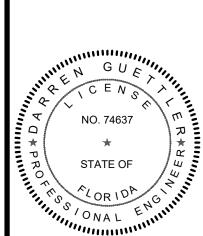


DARREN GUETTLER, PE FLORIDA LICENSE No. 74637

DRAWN BY:

SITE PLAN **DETAILS** 


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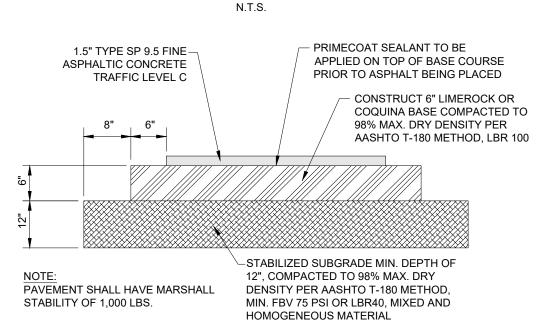


24' x 12' DUMPSTER DETAIL

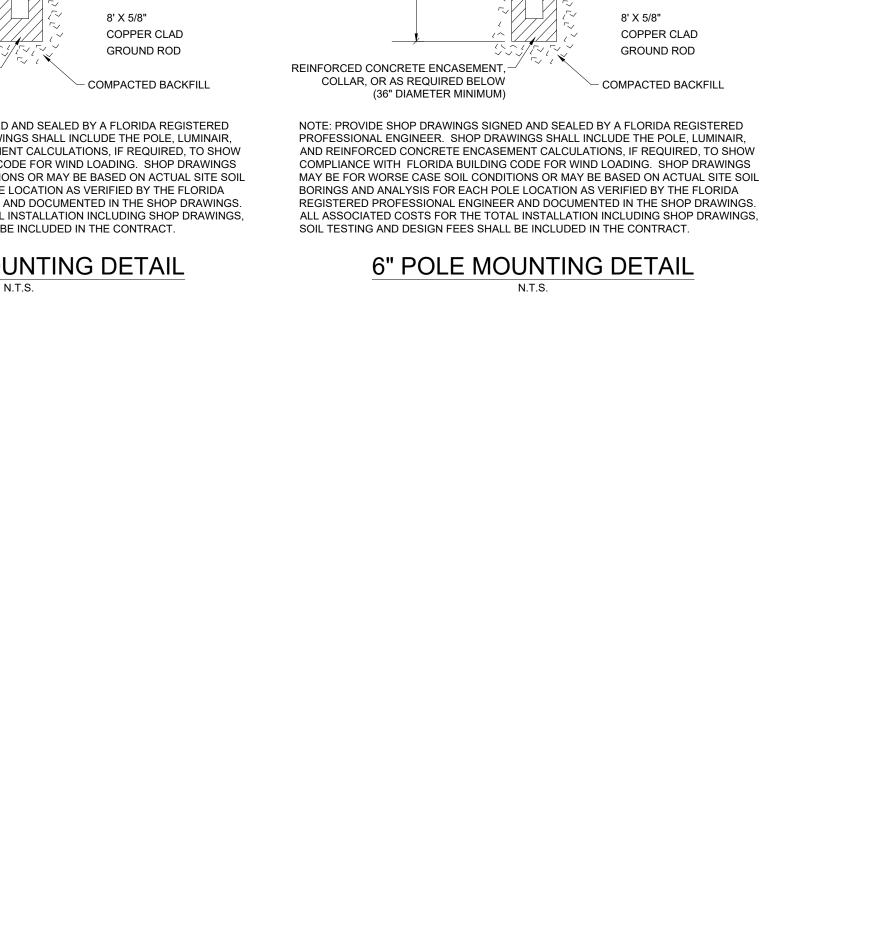CITY OF PSL PROJECT NO. P19-133-A2 PSLUSD FILE NO. 5342C



### ASPHALT PAVEMENT SAWCUT & BUTTJOINT DETAIL

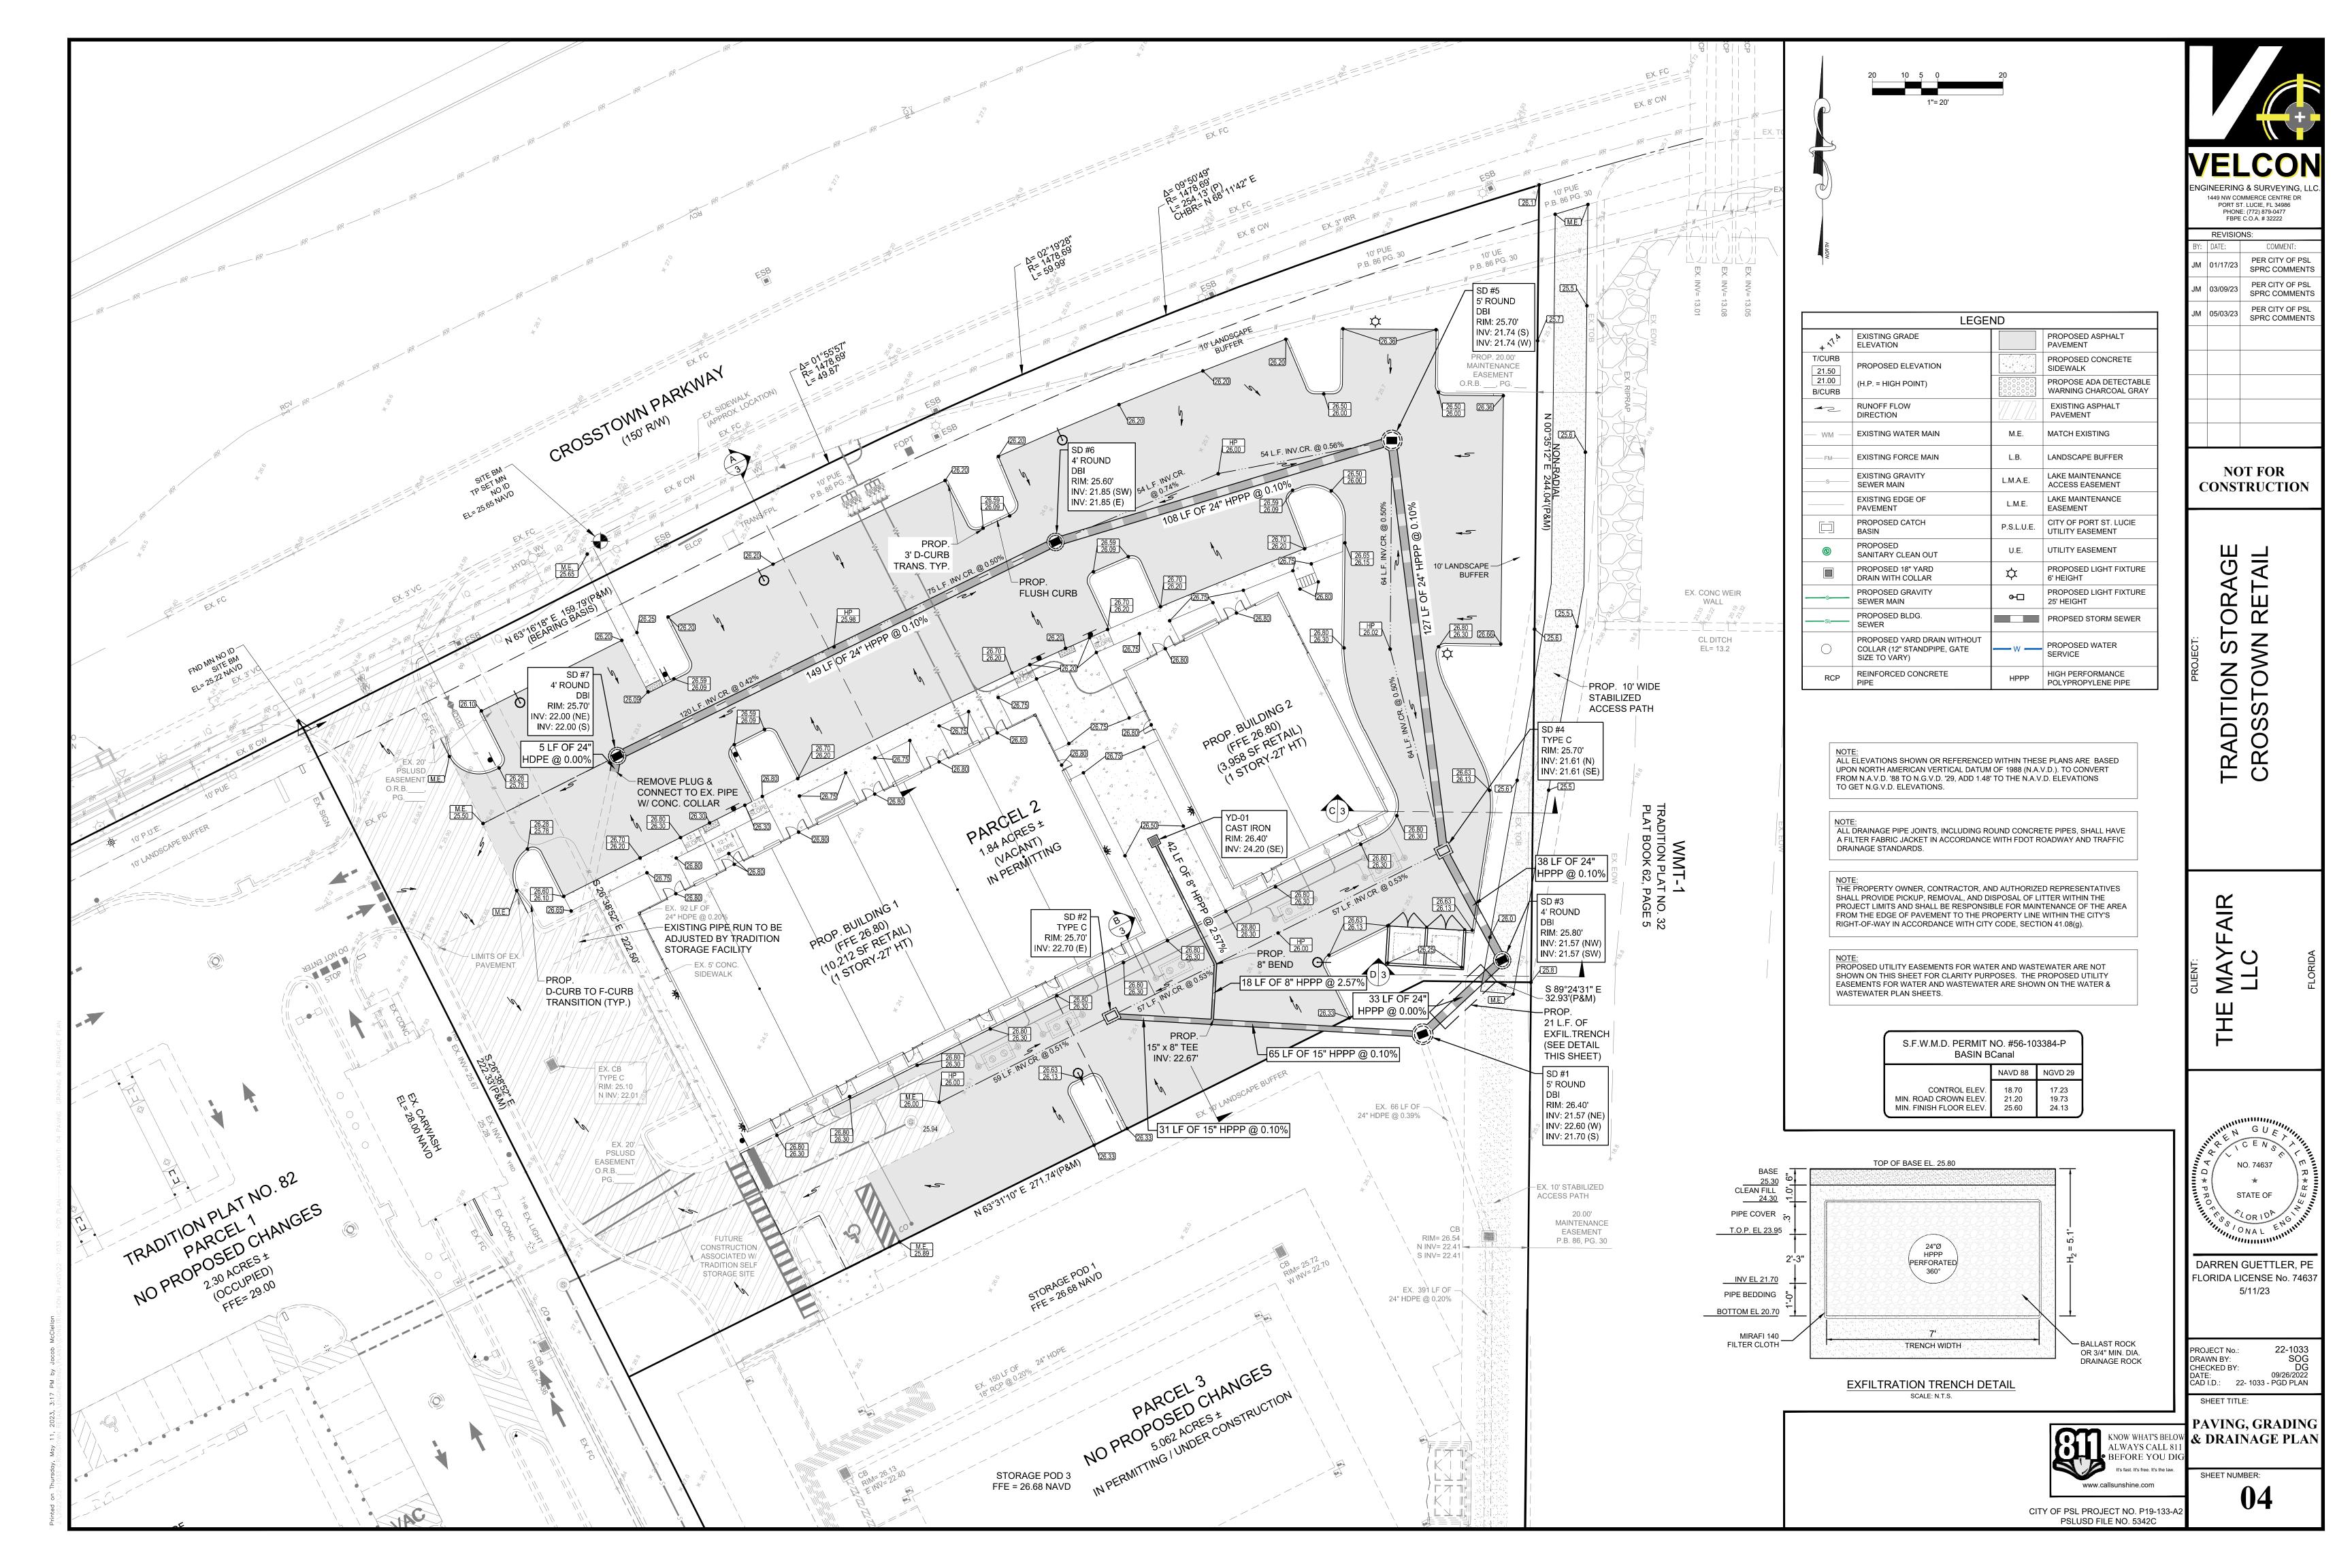

TYPICAL ONSITE ASPHALT PAVEMENT DETAILS

# - 7" PORT. CEMENT CONCRETE PAVEMENT (4,000 PSI)

STABILIZED SUBGRADE MIN. DEPTH OF 12", COMPACTED TO 98% MAX. DRY DENSITY MOD. PROCTOR PER AASHTO T-180 METHOD, MIN. LBR40.

1. CONCRETE PAVEMENT, AT A MINIMUM, MUST BE CONSTRUCTED OF FDOT APPROVED CLASS II CONCRETE. SUBGRADE MATERIAL SHALL BE A MINIMUM THICKNESS OF TWELVE INCHES WITH A MINIMUM LIMEROCK BEARING RATIO OF 40


2. CONCRETE SHALL BE REINFORCED WITH FIBER MESH ADDITIVE OR WITH 6x6 #10/#10 W.W.M.

3. SAW-CUT JOINTS @ 15' O.C. EXPANSION JOINTS @ 40' O.C.


### TYPICAL ONSITE CONCRETE PAVEMENT DETAILS

N.T.S.

	PAVING / SIDEWALK SPECIFICATIONS							
TYPE	WEARING SURFACE	WEARING SURFACE		BASE SUBO			STRUCTURAL NUMBER (SN) (PARKING LOT SN = 2.18 MIN.)	
VEHICULAR PARKING AREA PAVEMENT SECTION AND DRIVEWAY	1-1/2" THICK, TYPE TYPE SP-9.5 TYPE C ASPHALTIC CONCRETE INSTALLED IN TWO LIFTS (FIRST LIFT TO BE 3/4" & SECOND LIFT TO BE 3/4"). TACK COAT REQUIRED WITH MULTIPLE LIFTS.	STRUCTURAL COEFFICIENT PER INCH = 0.44	6" THICK, LIMEROCK (LBR 100) COMPACTED IN ONE LIFT TO 98% MAXIMUM DRY DENSITY, A.A.S.H.T.O. T-180	STRUCTURAL COEFFICIENT PER INCH = 0.18	12" THICK, STABILIZED SUBGRADE, COMPACTED TO 98% MAXIMUM DRY DENSITY A.S.H.T.O. T-180 AND STABILIZED TO EITHER L.B.R. = 40 OR F.B.V. = 75	COEFFICIENT		0.66 1.08 0.96 <b>2.70</b> > <b>2.18</b>
SIDEWALKS *	4" THICK 3,000 PSI CONCRETE OR 6" THICK 3,000 PSI CONCRETE WITH W1.4 X W1.4, 6" X 6" REINFORCING MESH AT ALL DRIVEWAYS & L.M.A.E.'S	N/A	4" THICK, CLEAN SAND COMPACTED TO 98% PER A.A.S.H.T.O. T-180	N/A	N/A	N/A	N/A	

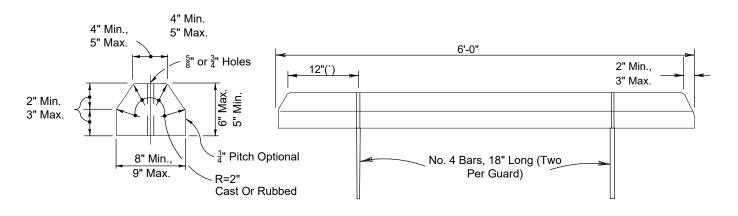


### CONCRETE BUMPER GUARD DETAIL N.T.S.

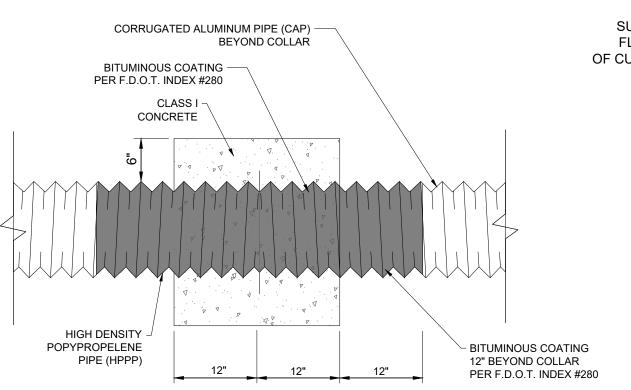


THE CAP SECTION GOES INTO THE LAKE

CONCRETE COLLAR DETAIL


ALL ELEVATIONS SHOWN OR REFERENCED WITHIN THESE PLANS ARE BASED UPON NORTH AMERICAN VERTICAL DATUM OF 1988 (N.A.V.D.). TO CONVERT FROM N.A.V.D. '88 TO N.G.V.D. '29, ADD 1.48' TO THE N.A.V.D. ELEVATIONS TO GET N.G.V.D. ELEVATIONS.

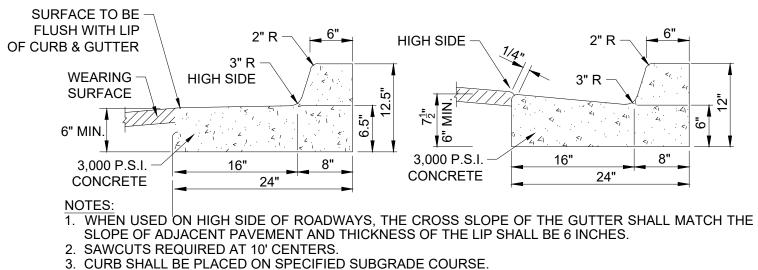

# TYPE "F" CURB & GUTTER

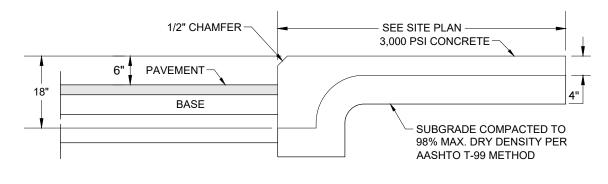

SIDEWALK/PAVEMENT DETAIL N.T.S.

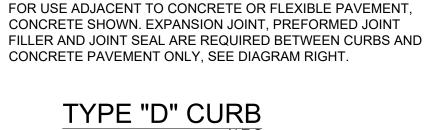

−1/2" EXP. JOINT AND

PREFORMED JOINT FILLER

# CONSTRUCTION FIELD OBSERVATIONS

I. DRAINAGE A. LAYING OF PIPE (BEFORE BACKFILL) B. ALL DRAINAGE STRUCTURES AND PIPE LAYING COMPLETE. C. CONSTRUCTION AND STABILIZATION OF RETENTION AREAS AND

D. SEEDING, MULCH AND SODDING IN AREAS WHERE EROSION IS EVIDENT.

### II. UTILITIES (PERMITS)

SPACING OR REQUIRED ROADWAY / PARKING AREA TESTS

300 10,000

300 10,000

L.B.R.

LIN.FT. SQ.FT.

F.B.V.

10,000

NOTE: ALL TESTING SHALL BE TAKEN IN A STAGGERED SAMPLING PATTERN FROM A POINT 12"

INSIDE THE LEFT EDGE OF THE ITEM TESTED, TO THE CENTER, TO A POINT 12" INSIDE

ITEMS TO BE TESTED

STABILIZED SUBGRADE

OF THE RIGHT EDGE.

COMPACTED OR

LIMEROCK BASE

SHELLROCK BASE

**ASPHALT** 

A. PIPE LAYING IN RIGHTS-OF-WAYS .

B. JACK AND BORING / DIRECTIONAL BORING. C. WET TAPS. D. ABOVE GROUND MANHOLE INSPECTIONS AND INSTALLATIONS.

III. CONCRETE A. CONSTRUCTION OF CURBING, SIDEWALK, NON-BUILDING SLABS, AND RETAINING WALLS BEFORE PLACEMENT OF CONCRETE.

### IV. PAVEMENT

A. LINE AND GRADE (CERTIFICATION). B. SUBBASE (PRIOR TO ADDING BASE MATERIAL) C BASE (PRIOR TO PRIMING AND SAND SEAL) D. BASE (AFTER PRIMING, SAND SEAL AND BEFORE PLACING OF

E. ASPHALT OR CONCRETE (WHILE PAVING IS IN PROCESS). F. TURN OUT CONSTRUCTION ONTO CITY, COUNTY, OR STATE ROAD (ABOVE INSPECTIONS APPLY). G. TEST RESULTS ON SUBBASE, BASE AND ASPHALT. H. FINAL PROJECT OBSERVATION.

### PROJECT CERTIFICATION REQUIREMENTS

I. PAVEMENT TESTING A. FLORIDA BEARING VALUE (FBV) OR LIMEROCK BEARING RATIO (LBR) TEST RESULTS B. COMPACTION TEST RESULTS.

C. BASE MATERIAL TEST RESULTS. D. ASPHALT TEST RESULTS.

### II. WATER AND SEWER

A. DEPARTMENT OF ENVIRONMENTAL PROTECTION CERTIFICATION FOR BOTH WATER AND SEWER (OPERATION AND MAINTENANCE),

IF APPLICABLE. B. HEALTH DEPARTMENT CERTIFICATION, IF APPLICABLE. C. BACTERIOLOGICAL AND PRESSURE TESTING FOR WATER MAINS. D. VIDEO AND EXFILTRATION TESTING FOR GRAVITY SEWER MAINS, IF APPLICABLE.

E. PRESSURE TESTING FOR FORCE MAINS. IF APPLICABLE. F. UTILITY ACCEPTANCE FOR OPERATION AND MAINTENANCE, IF APPLICABLE.

III. CERTIFICATION AND RECORD DRAWINGS A. SEALED CERTIFICATION BY THE ENGINEER OF RECORD FOR COMPLIANCE WITH APPROVED PLANS AND SPECIFICATIONS ALONG WITH RECORD DRAWINGS FOR THE PROJECT.

THE CONTRACTOR SHALL BE RESPONSIBLE FOR INSPECTING THE SITE PRIOR TO BIDDING WORK AND SHALL TAKE INTO CONSIDERATION ANY OMISSIONS, UNDERGROUND UTILITIES, OR OTHER ITEMS AFFECTING THE INSTALLATION OF PAVING, DRAINAGE, AND UTILITIES. SHOULD UNCHARTED OR INCORRECTLY CHARTED UTILITIES OR OTHER ITEMS BE ENCOUNTERED DURING CONSTRUCTION, CONSULT ENGINEER OF RECORD IMMEDIATELY FOR DIRECTIONS. REPAIR DAMAGED UTILITIES OR OTHER ITEMS TO SATISFACTION OF UTILITY OWNER AND ENGINEER OF RECORD.

GENERAL CONSTRUCTION NOTES:

- 2. ALL MATERIALS AND WORKMANSHIP SHALL BE IN ACCORDANCE WITH ALL APPLICABLE CITY, COUNTY, STATE, AND FEDERAL REGULATIONS, CODES, AND ORDINANCES, INCLUDING OSHA AND FDOT SPECIFICAIONS, LASTEST EDITION UNLESS OTHERWISE AUTHORIZED BY THE ENGINEER IN WRITING.
- 3. LOCATION AND SIZES OF ALL EX. UTILITIES ARE APPROXIMATE ONLY, CONTRACTOR IS RESPONSIBLE FOR EXACT FIELD LOCATION AND SIZES PRIOR TO COMMENCEMENT OF ANY CONSTRUCTION TO ALLOW FOR PIPE RECONFIGURATION IF NEEDED. THE CONTRACTOR SHALL CONTACT ALL AFFECTED UTILITIES AT LEAST 48 HOURS IN ADVANCE OF CONSTRUCTION OPERATIONS
- 4. ANY DISCREPANCIES ON THE DRAWINGS SHALL BE BROUGHT TO THE ATTENTION OF THE ENGINEER PRIOR TO COMMENCING WORK.
- 5. NO FIELD CHANGES OR DEVIATIONS FROM DESIGN SHALL BE MADE WITHOUT PRIOR WRITTEN APPROVAL OF THE ENGINEER OF RECORD.
- 6. CONTRACTOR SHALL OBTAIN ALL REQUIRED PERMITS / LICENSES PRIOR TO COMMENCING
- 7. THE CONTRACTOR SHALL KEEP COPIES OF ALL PERMITS, PLANS, AND SPECIFICATIONS ON SITE DURING CONSTRUCTION.
- 8. THE CONTRACTOR SHALL BE RESPONSIBLE FOR ALL REQUIRED TESTING TO BE PERFORMED BY AN INDEPENDENT TESTING LABORATORY APPROVED BY THE ENGINEER OF RECORD. THE CONTRACTOR SHALL SUPPLY DENSITY TESTS TO ENGINEER OF RECORD ON ALL SUB GRADE AND BASE. TESTS SHALL BE PREPARED IN ACCORDANCE WITH AASHTO T-180 METHOD AT ALL AREAS OF DISTURBED ASPHALT & PIPE TRENCHING.
- 9. THE CONTRACTOR SHALL BE RESPONSIBLE FOR CORRECTING ANY DAMAGE RESULTING FROM HIS OPERATIONS, TO EXISTING PAVEMENT, SWALES, ETC.
- 10. THE CONTRACTOR SHALL GUARANTEE ALL WORK AND MATERIALS FOR A PERIOD OF ONE YEAR FROM THE DATE THAT PROJECT HAS BEEN ACCEPTED. ALL FAULTY CONSTRUCTION AND/OR MATERIALS THAT OCCUR DURING AFORESAID PERIOD SHALL BE CORRECTED AT THE CONTRACTORS'S EXPENSE AND IN A TIMELY MANNER.
- 11. THE CONTRACTOR SHALL COMPLY WITH ALL RULES AND REGULATIONS OF THE STATE, COUNTY AND CITY AUTHORITIES REGARDING CLOSING OR RESTRICTING THE USE OF PUBLIC STREETS OR HIGHWAYS.
- 12. THE CONTRACTOR SHALL GIVE ADEQUATE NOTIFICATION TO ALL AFFECTED UTILITY OWNERS FOR REMOVAL, RELOCATION AND ALTERATION OF THEIR EXISTING FACILITIES.
- 13. THE CONTRACTOR SHALL NOTIFY THE ENGINEER AT LEAST 48 HOURS PRIOR TO ANY REQUIRED INSPECTIONS AND SHALL SUPPLY ALL EQUIPMENT NECESSARY FOR INSPECTIONS AND/OR TESTING.
- 14. THE CONTRACTOR SHALL PROVIDE THE ENGINEER AS-BUILT SURVEYS CERTIFIED BY A LICENSED SURVEYOR UPON COMPLETION OF CONSTRUCTION AND SCHEDULE A FINAL INSPECTION WITH THE ENGINEER OF RECORD.
- 15. ANY PUBLIC LAND CORNER WITHIN THE LIMITS OF CONSTRUCTION SHALL BE PROTECTED. IF A CORNER MONUMENT IS IN DANGER OF BEING DESTROYED AND HAS NOT BEEN PROPERLY REFERENCED, THE CONTRACTOR SHOULD NOTIFY THE COUNTY SURVEYOR WITHOUT DELAY BY TELEPHONE.
- 16. IF HARDPAN IS ENCOUNTERED WITHIN RETENTION AREA OR SWALES, IT SHALL BE REMOVED AND REPLACED WITH A GRANULAR MATERIAL.
- 17. IF MUCK OR ANY OTHER UNSUITABLE MATERIAL IS ENCOUNTERED, THE MATERIAL SHALL BE COMPLETELY REMOVED AND BACK FILLED WITH A GRANULAR MATERIAL AND COMPACTED TO DENSITIES SUFFICIENT TO ACCOMMODATE THE INTENDED USE.
- 18. LOCATION OF STRUCTURES SHALL GOVERN AND PIPE LENGTHS MAY HAVE TO BE ADJUSTED TO ACCOMPLISH CONSTRUCTION AS SHOWN ON THESE PLANS.
- 19. RCP INDICATES REINFORCED CONCRETE PIPE. CMP INDICATES GALVANIZED CORRUGATED METAL PIPE, BCCMP INDICATES BITUMINOUS COATED CORRUGATED METAL PIPE. CAP INDICATES CORRUGATED ALUMINUM PIPE. CPP INDICATES CORRUGATED POLYETHYLENE PIPE (N12) MANUFACTURED BY ADVANCED DRAINAGE SYSTEMS, INC. (ADS). HPPP INDICATES HIGH-PERFORMANCE POLYPROLENE PIPE.
- 20. MITERED END SECTIONS SPECIFIED ON THE PLANS SHALL BE IN ACCORDANCE WITH FDOT STANDARD INDEX NO. 430-021.
- 21. COMPACTION REQUIREMENTS FOR PIPE BEDS SHALL BE 90% OF MAXIMUM DRY DENSITY.
- 22. TEMPORARY DRAINAGE SHALL BE PROVIDED DURING CONSTRUCTION TO ELIMINATE ANY FLOODING OF PRIVATE PROPERTY.
- AND ERODED MATERIALS DURING THE FINAL STAGES OF CONSTRUCTION. 24. ANY DRAINAGE PROBLEMS CREATED BY CONSTRUCTION, OR EXISTING BEFORE CONSTRUCTION AND NOT ALLEVIATED AS PART OF THE PROPOSED IMPROVEMENTS.

23. ALL STORM SEWER LINES AND DRAINAGE STRUCTURES SHALL BE CLEANED OF DEBRIS

- SHOULD BE BROUGHT TO THE ATTENTION OF THE GOVERNING AUTHORITY AND THE ENGINEER OF RECORD. 25. THE CONTRACTOR SHALL TAKE PRECAUTIONS TO PROTECT EXISTING TREES SHOWN TO
- REMAIN IF ANY TREES MARKED TO BE REMOVED CAN BE SAVED. THE CONTRACTOR SHALL SAVE SAID TREES. SHOULD ADDITIONAL TREES NEED TO BE REMOVED, THE CONTRACTOR SHALL NOTIFY THE OWNER AND THE ENGINEER OF RECORD FOR APPROVAL PRIOR TO REMOVING SAID TREES.
- 26. IF EXCAVATED FILL MATERIAL IS REUSABLE, STOCKPILE EXCESS FOR USE IN LANDSCAPED AREAS.
- 27. UNUSABLE CLEARED MATERIAL SHALL BE REMOVED FROM SITE AND HAULED TO AN APPROVED DISPOSAL SITE. AS AN ALTERNATIVE, BURNING ON SITE WILL BE ALLOWED WITH PROPER PERMITS. LOCATION OF BURN SITE SHALL BE APPROVED BY OWNER.
- 28. ALL AREAS DISTURBED BY CONSTRUCTION SHALL BE RESTORED TO PRE-CONSTRUCTION CONDITIONS OR BETTER. ALL EXISTING SIGNAGE, PAVEMENT MARKINGS, ABOVE GROUND APPURTENANCES, ETC. SHALL BE RESTORED IN KIND.
- 29. WHEN PAVEMENT IS SHOWN NEXT TO A CURB OR SIDEWALK, THE ELEVATION OF THE TOP OF CURB OR SIDEWALK IS 6" ABOVE THE PAVEMENT, UNLESS INDICATED AS FLUSH. IN SOME CASES, BOTH ELEVATIONS ARE SHOWN FOR ADDITIONAL CLARITY.
- 30. ALL CONCRETE SHALL DEVELOP A 28-DAY COMPRESSIVE STRENGTH OF 3,000 PSI UNLESS OTHERWISE NOTED.
- 31. ALL REINFORCING STEEL SHALL CONFORM TO ASTM A-615 AND HAVE A TENSILE STRENGTH OF 60,000 PSI UNLESS OTHERWISE NOTED. 32. ALL WATER FLUSHED FROM MAINS SHALL BE DIRECTED AS APPROVED BY THE ENGINEER

OF RECORD.

- 33. NO WATER OR SEWER SERVICE IS TO BE SUPPLIED, UNTIL A LETTER OF CLEARANCE IS RECEIVED FROM FDEP, IF APPLICABLE.
- 34. MAINTENANCE OF TRAFFIC SHALL BE IN ACCORDANCE WITH THE "MANUAL ON UNIFORM TRAFFIC CONTROL DEVICES FOR STREETS AND HIGHWAYS", AND THE FDOT "ROADWAY AND TRAFFIC DESIGN STANDARDS INDEX #600", LATEST EDITIONS.
- 35. EROSION AND SEDIMENT CONTROL CONTRACTOR IS RESPONSIBLE FOR PROVIDING EROSION AND SEDIMENT CONTROL USING THE LATEST F.D.O.T. STANDARDS. BALED HAY, STRAW, AND SILTATION BARRIERS WILL BE INSTALLED WHERE NEEDED TO PREVENT SILTATION OF ADJACENT PROPERTY, PUBLIC RIGHT-OF-WAY, WETLANDS AND WATERWAYS. THESE WILL REMAIN IN PLACE UNTIL GRASSING OR SODDING HAS BEEN COMPLETED OR UNTIL SILTATION AND EROSION ARE NO LONGER A THREAT TO ADJACENT PROPERTY AND WATERWAYS.
- 36. ALL BERMS AND GRASSED AREAS SHALL BE SEEDED AND MULCHED IN ACCORDANCE WITH THE APPROPRIATE SECTIONS OF THE ABOVE REFERENCED SPECIFICATIONS UNLESS OTHERWISE AUTHORIZED BY THE ENGINEER OF RECORD.
- 37. TOPOGRAPHIC INFORMATION PREPARED BY VELCON ENGINEERING & SURVEYING, LLC. ALL ELEVATIONS PER BENCHMARKS REFERENCED ON SURVEY N.A.V.D.



CITY OF PSL PROJECT NO. P19-133-A PSLUSD FILE NO. 5342C




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**REVISIONS:** 

COMMENT: PER CITY OF PSI JM 01/17/23 SPRC COMMENTS PER CITY OF PSI JM 03/09/23 SPRC COMMENTS PER CITY OF PSL SPRC COMMENTS

NOT FOR CONSTRUCTION

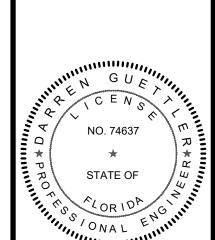


DARREN GUETTLER, PE FLORIDA LICENSE No. 74637 5/11/23

22-1033 RAWN BY:

CAD I.D.: 22- 1033 - PGD DETAILS PAVING, GRADING & DRAINAGE **DETAILS AND SPECIFICATIONS** 

CHECKED BY:

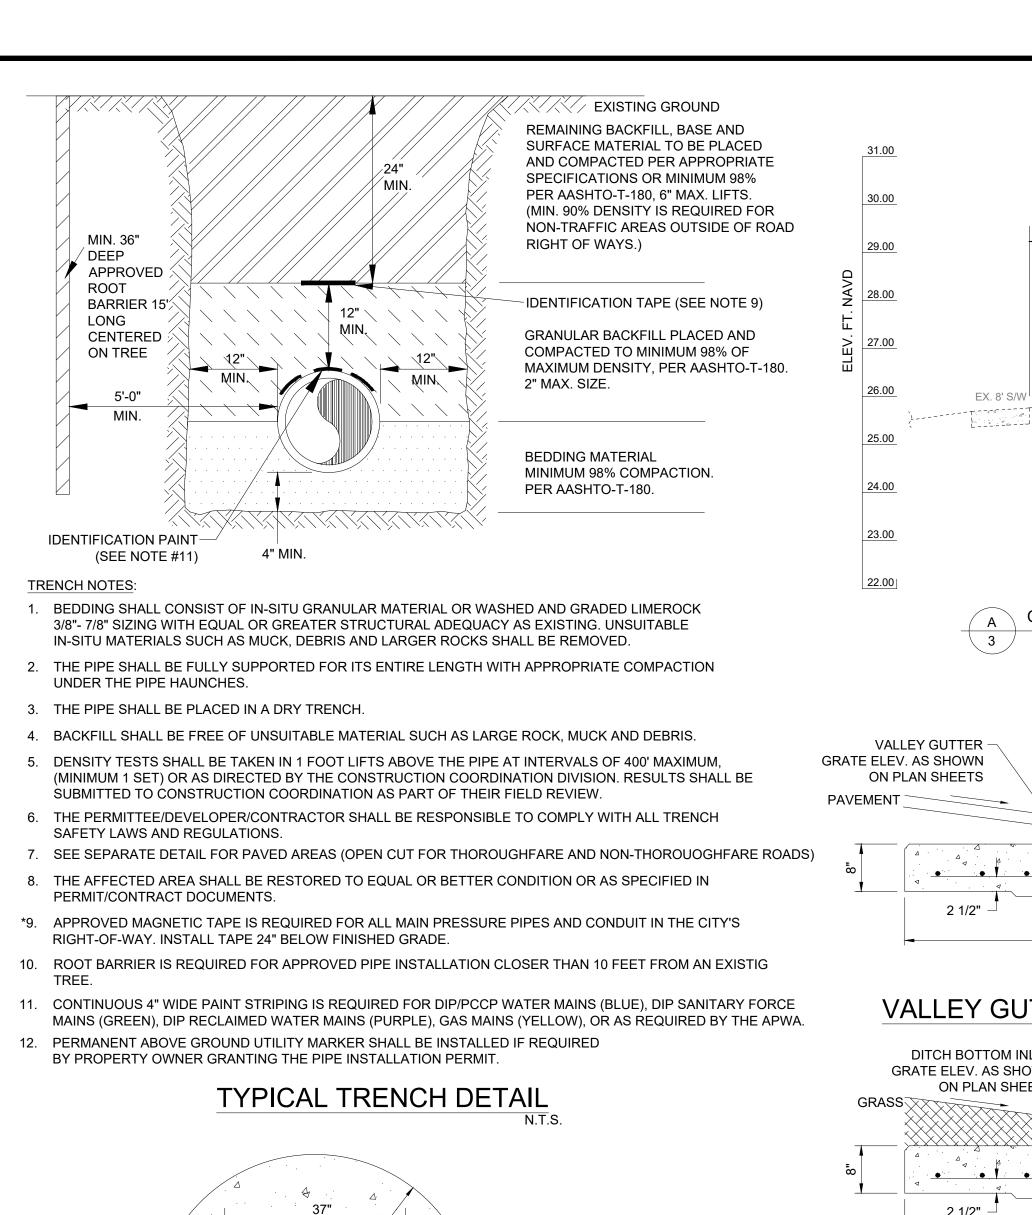

REFER TO PLANS FOR RIM ELEVATION, FRAME AND GRATE SPECIFICATIONS

BRICK MASONRY

- ADJUST TO GRADE (IF REQUIRED)

#5 @ 6" O.C.E.W.

- #4 @ 12" O.C.E.W.

- GROUT JOINTS INSIDE/OUTSIDE

ALL AROUND

BE IN CENTER  $\frac{1}{3}$  OF WALL

- PRECAST CONCRETE

- A-LOK COMPRESSION

CONNECTOR CAST IN

PLACE WHEN POSSIBLE

С

2'-0" 3'-1"

3'-0" 4'-6"

STANDARD TYPE "C"&"E" INLET DETAIL

BASE, CLASS "A"

3,000# CONCRETE

▶ REINFORCING SHALL

√\_ #4 @ 9" О.С.Е.W.

2 COURSES MIN. - 5 COURSES MAX.

PLAN (4', 5' OR 6' MH)

2" CLEAR + OPENING

EYEBOLT -

 $\frac{1}{2}$ " MORTAR PAD

FOR PRECAST SLAB

DIA. VARIES (SEE PLAN)

4 -#4 (TYP.)

AT HOLES

1. ALL REINFORCEMENT TO MEET CURRENT F.D.O.T.

2. THIS STRUCTURE MAY BE SUBSTITUTED WITH OTHER STRUCTURES ONLY IF THE STANDARDS HAVE BEEN MET. STORM MANHOLE DETAIL

SPECIFICATIONS.

LOCKING CHAIN


<sup>3</sup>/<sub>4</sub>" CHAMFER

VARIES

**VARIES** 

2' MIN.

#4 @ 12" O.C.E.W.

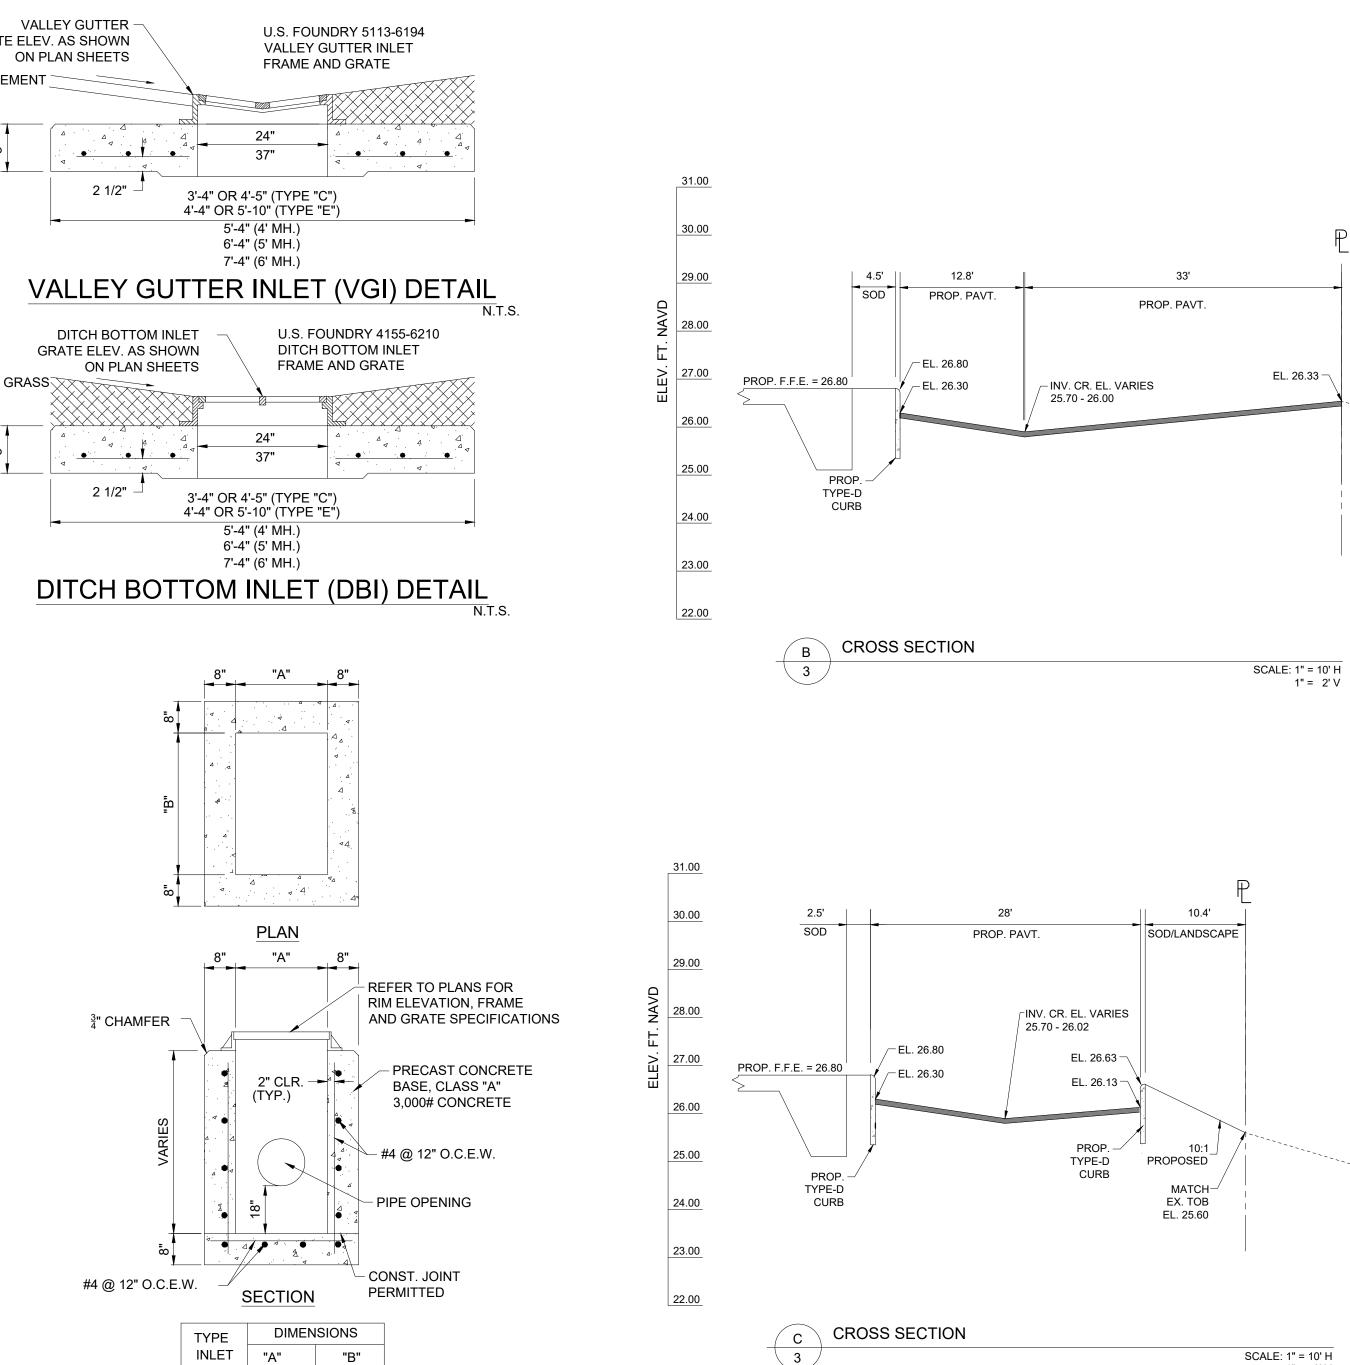

SOD/LANDSCAPE

EOP EL. 26.20 -

EX. LANDSCAPE

CROSSTOWN

R-O-W

**CROSS SECTION** 

PROP. PAVT.

SCALE: 1" = 10' H

INV. CR. EL. VARIES -

25.98 - 25.60

5' 10'
CONC. SOD/LANDSCAPE

PROP. F.F.E. = 26.80


PROP. PAVT

PROP. 24" HPPP

INV. EL. 21.70

EL. 26.70 -

EL. 26.20 -

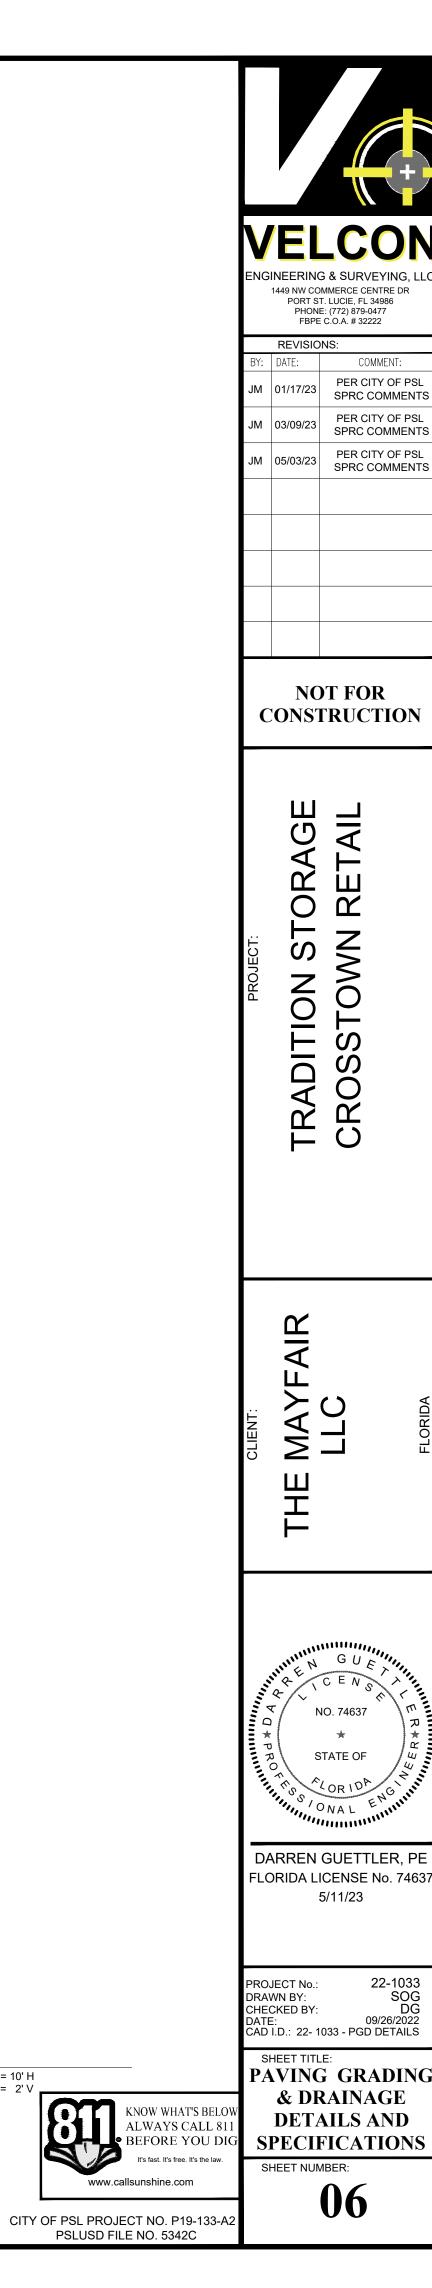

MAINTENANCE EASEMENT WITH 10' STABILIZED PATH

MATCH-/

EX. TOB

EL. 25.80


STABALZIED-

**CROSS SECTION** 

DUMPSTER ENCLOSURE

SLAB EL. = 26.25

3

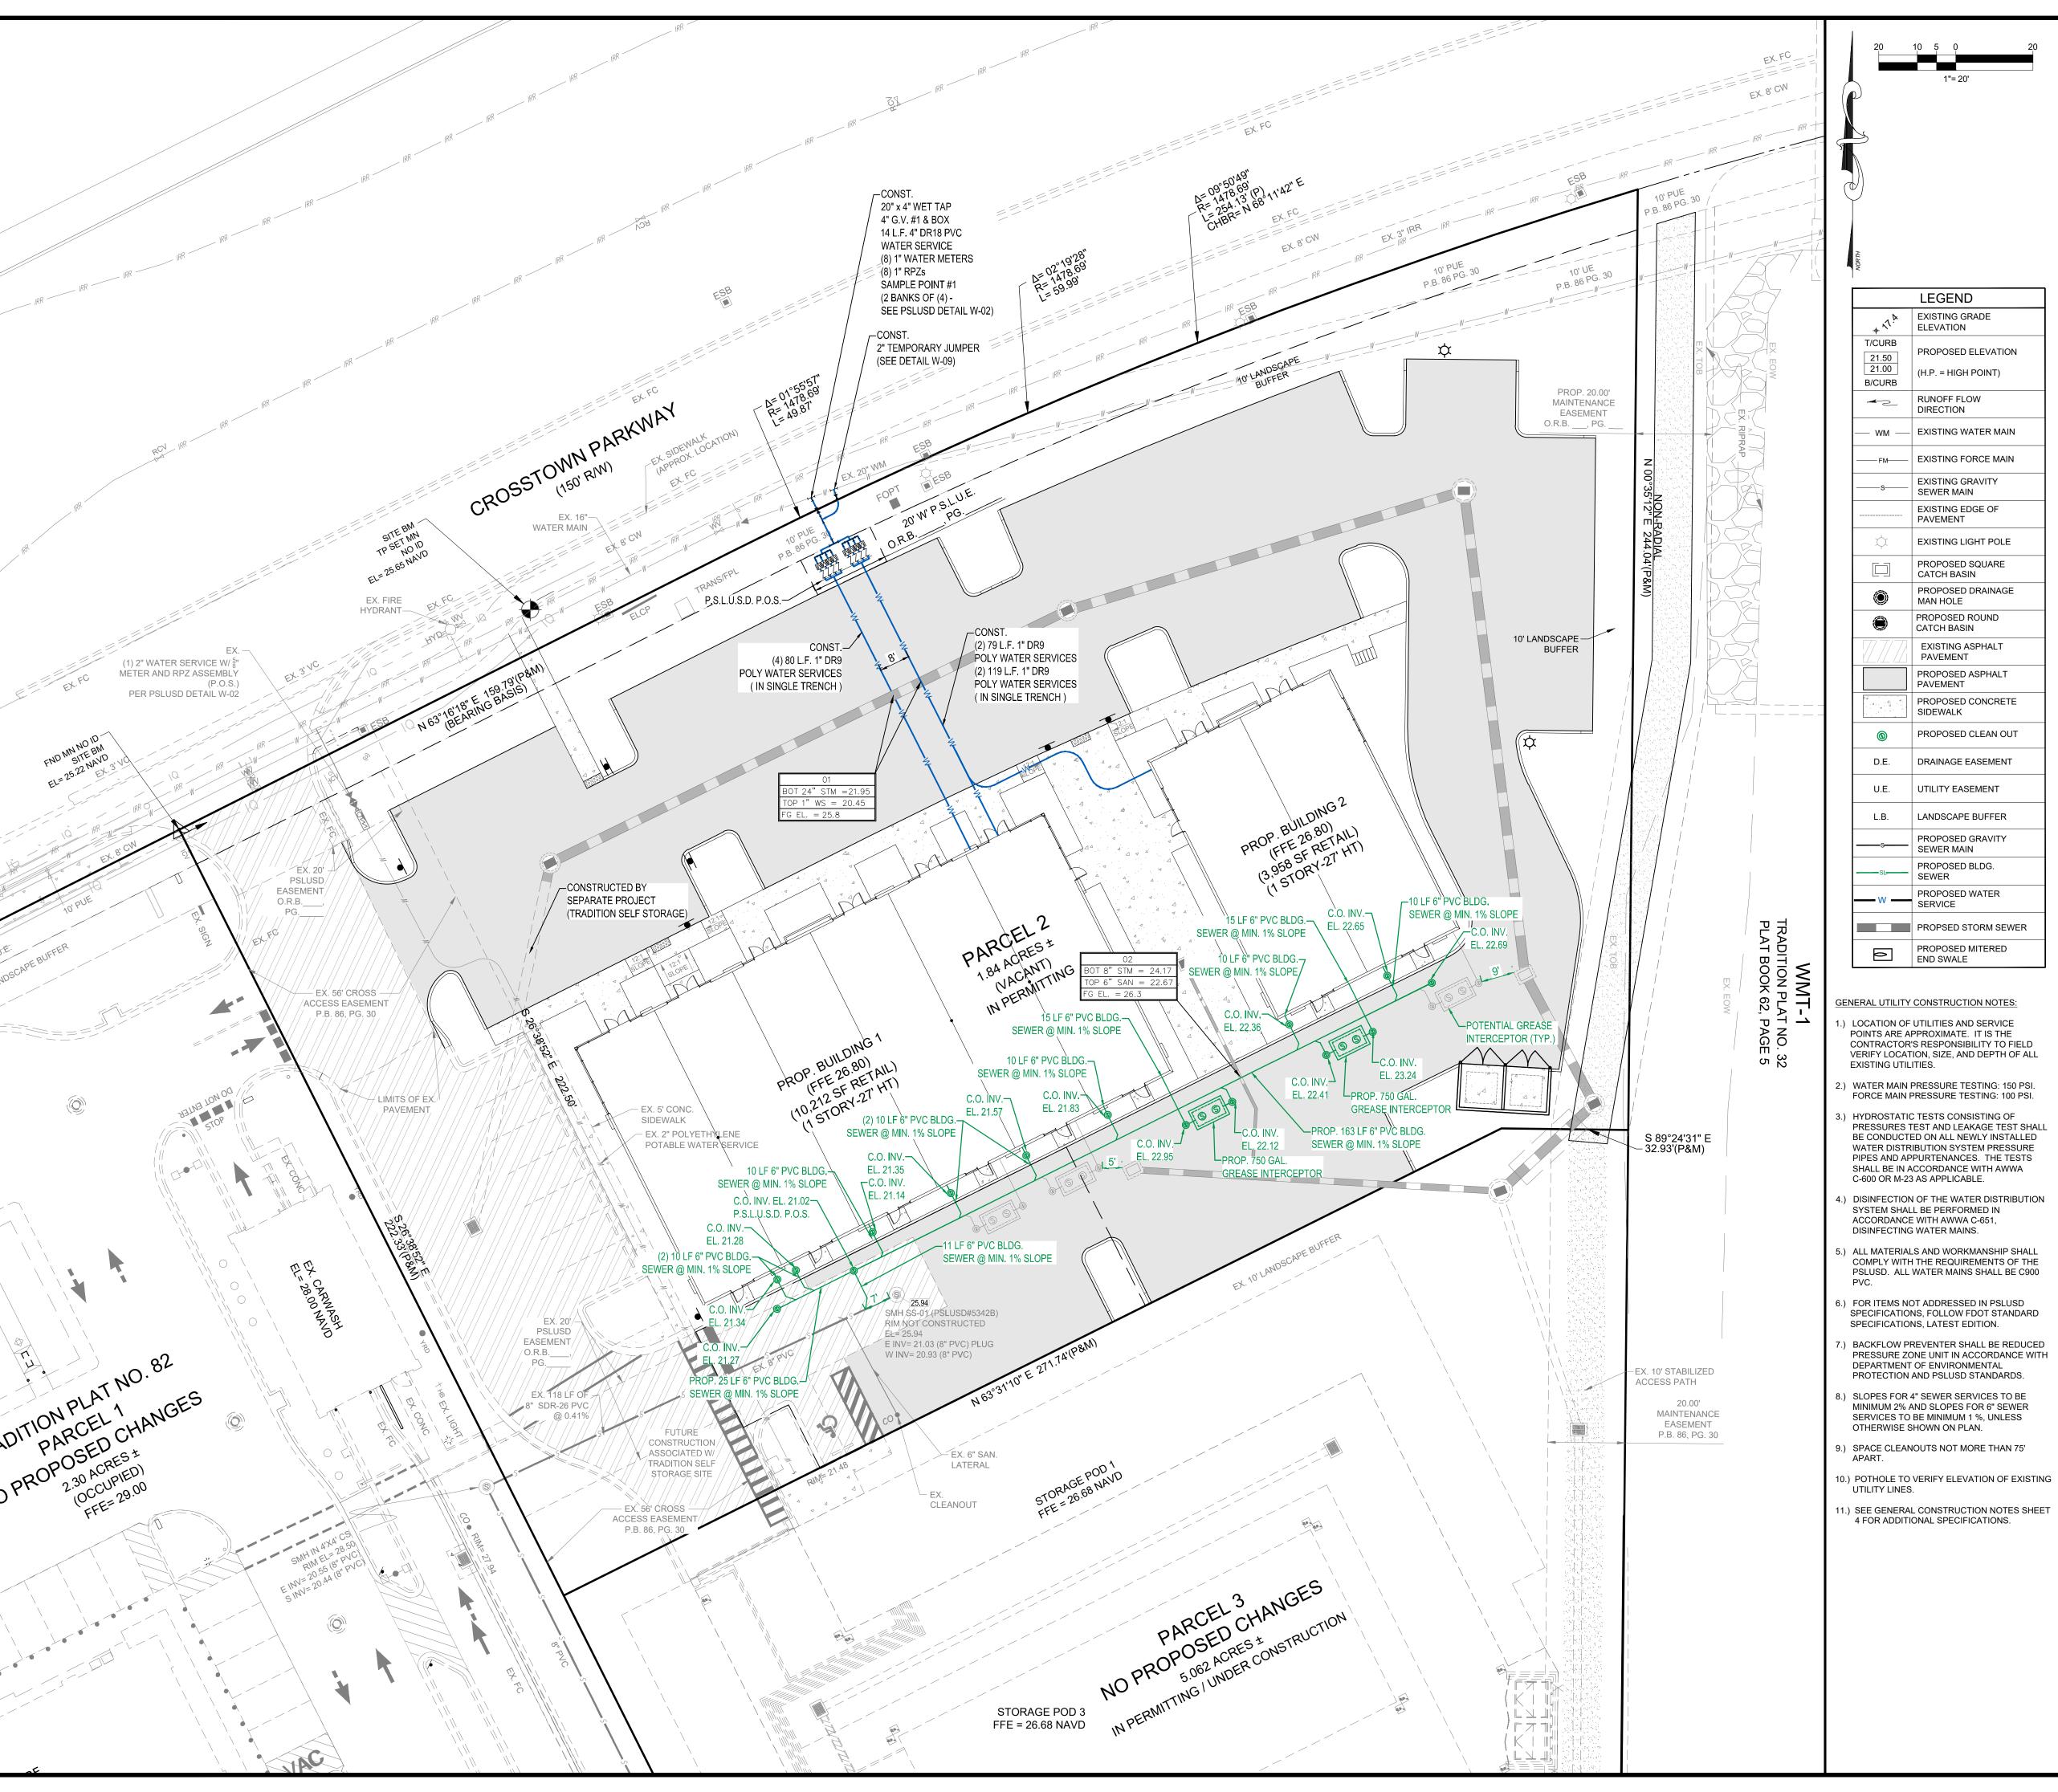

- ALL CONSTRUCTION MATERIAL, INSTALLATION AND TESTING SHALL CONFORM TO THE STANDARD SPECIFICATIONS OF THE PSLUSD.
  - 2. WATER MAIN WHERE SPECIFIED AS POLYVINYL CHLORIDE (PVC), SHALL CONFORM TO AWWA C-900 OR C-905, PRESSURE CLASS 150, DR (18). WATER MAIN WHERE SPECIFIED AS POLYETHYLENE (PE), SHALL CONFORM TO AWWA C-901 OR C-906, STANDARD CODE DESIGNATION PE3408, PIPE CLASS 200, DIMENSION RATIO,
  - 3. POLYVINYL CHLORIDE WATER MAIN SHALL BE BLUE IN COLOR.
  - 4. FITTINGS SHALL BE CAST OR DUCTILE IRON, CONFORMING TO AWWA C-110 AND ANSI A21.11, CLASS 250 MINIMUM, CEMENT LINED, AND SEAL COATED.
  - 5. GATE VALVES SHALL BE RESILIENT SEAT TYPE BY AN APPROVED MANUFACTURER AS DETERMINED BY THE PSLUSD. VALVES SHALL CONFORM TO AWWA C-509.
  - 6. WATER LINES SHALL BE BACKFILLED AND COMPACTED IN ACCORDANCE WITH PSLUSD DESIGN AND CONSTRUCTION STANDARDS. THE CONTRACTOR SHALL SUBMIT CERTIFIED DENSITY TESTS AS REQUIRED BY THE PSLUSD, AS APPLICABLE. IN CASES WHERE PAVED AREAS FALL WITHIN THE JURISDICTION OF LOCAL OR STATE AGENCIES. THE COMPACTION REQUIREMENTS SHALL NOT BE LESS THAN THE MINIMUM REQUIRED BY THE APPROPRIATE RESPONSIBLE AGENCY.
  - . NO FIELD CHANGES OR DEVIATIONS FROM THE DESIGN SHALL BE MADE WITHOUT PRIOR APPROVAL OF THE PSLUSD AND THE ENGINEER OF RECORD.
  - 8. THE CONTRACTOR SHALL NOTIFY THE PSLUSD AND CITY ENGINEERING 48 HOURS PRIOR TO COMMENCING CONSTRUCTION AND PRIOR TO ALL INSPECTIONS.
  - 9. A PRE-CONSTRUCTION CONFERENCE BETWEEN THE ENGINEER, THE CONTRACTOR, AND PSLUSD REPRESENTATIVES SHALL BE MANDATORY PRIOR TO COMMENCEMENT
  - 10. MINIMUM COVER SHALL BE 36 INCHES EXCEPT AS APPROVED BY THE UTILITIES ENGINEER AND PSLUSD.
  - 1. DISTURBED AREAS SHALL BE RESTORED IN CONFORMANCE WITH THE APPLICABLE GOVERNING AGENCY REQUIREMENTS
  - 12. EXISTING UTILITIES AND DRAINAGE SHALL BE FIELD VERIFIED PRIOR TO
  - CONSTRUCTION AND PROTECTED BY THE CONTRACTOR.
  - 13. WATER MAINS SHALL BE TESTED AND DISINFECTED IN ACCORDANCE WITH THE APPLICABLE FLORIDA DEPARTMENT OF ENVIRONMENTAL PROTECTION AND AWWA C-651 FOR DISINFECTION.

  - 14. THE CONTRACTOR SHALL BE RESPONSIBLE FOR MAINTAINING EXISTING
  - UTILITIES AND DRAINAGE.
  - 15. THE CONTRACTOR SHALL FURNISH RECORD DRAWING INFORMATION TO THE ENGINEER INCLUDING LOCATIONS OF VALVES, FITTINGS, SERVICE CONNECTIONS, BLOWOFFS, AIR RELEASE VALVES, AND ANY OTHER PERTINENT INFORMATION NECESSARY TO LOCATE ITEMS CONSTRUCTED UNDER THIS PROJECT, AS REQUIRED BY THE ENGINEER AND PSLUSD STANDARDS.
  - PSLUSD ONLY AFTER TESTING AND DISINFECTION HAS BEEN COMPLETED AND APPROVED ON THE TAPPING VALVE AND SLEEVE.

16. THE CONTRACTOR SHALL TAP EXISTING LINES UNDER THE SUPERVISION OF THE

- 7. WATER MAIN SHALL BE MARKED BY THE USE OF CONTINUOUS 14 GAUGE INSULATED SOLID COPPER WIRE (BLUE IN COLOR) AND IDENTIFICATION TAPE WITH "WATER" MARKED ON TAPE, PERMANENTLY ATTACHED TO THE TOP OF THE
- 18. MECHANICAL RESTRAINTS TO BE USED ON ALL FITTINGS AND PLACED IN ACCORDANCE WITH MANUFACTURER'S RECOMMENDATIONS AND PSLUSD
- 19. ALL WATER MAINS SHALL BE TESTED AT A MINIMUM OF 150 PSI. TESTING METHODS SHALL CONFORM TO AWWA C-600. - 2 HR MINIMUM TEST

WATER MAIN IN ACCORDANCE WITH THE PSLUSD SPECIFICATIONS.

- LINE SIZE SWAB PASSED THRU THE ENTIRE LENGTH OF THE LINE. NOTE: SWAB SHOULD BE PLACED IN 1ST JOINT OF NEW LINE. END OF MAIN SHOULD BE "TURNED UP" AT 45% AND EXTENDED SO THAT SWABBING AND A FULL BORE FLUSH CAN BE ACCOMPLISHED. BLOW-OFF ASSEMBLY CAN THEN BE PLACED. WHERE LINES BRANCH, SWABS WILL BE PLACED IN BRANCH LINES AND SEQUENTIALLY SWABBED AND FLUSHED.
- 21. CONTRACTOR SHALL COMPLY WITH FLORIDA TRENCH SAFETY ACT REQUIREMENTS.

1. SANITARY SEWERS (INCLUDING LATERALS), FORCE MAINS, GAS MAINS ,AND STORM SEWERS SHOULD CROSS UNDER WATER MAINS. SANITARY SEWERS, FORCE MAINS, GAS MAINS, AND STORM SEWERS CROSSING WATER MAINS SHALL BE LAID TO PROVIDE A MINIMUM VERTICAL DISTANCE OF 18 INCHES BETWEEN THE INVERT OF THE UPPER PIPE AND THE CROWN OF THE

ALL CROSSINGS SHALL BE ARRANGED SO THAT THE SEWER PIPE JOINTS AND THE WATER MAIN PIPE JOINTS ARE EQUIDISTANT FROM THE POINT OF CROSSING (PIPES CENTERED ON THE

2. A MINIMUM 10 FOOT HORIZONTAL SEPARATION SHALL BE MAINTAINED BETWEEN ANY TYPE OF SEWER AND WATER MAIN IN PARALLEL INSTALLATIONS.

3. MAXIMUM OBTAINABLE SEPARATION OF RECLAIMED WATER LINES AND DOMESTIC WATER LINES SHALL BE PRACTICED. A MINIMUM HORIZONTAL SEPARATION OF FIVE FEET (CENTER TO CENTER) OR THREE FEET (OUTSIDE TO OUTSIDE), SHALL BE MAINTAINED BETWEEN RECLAIMED WATER LINES AND EITHER POTABLE WATER MAINS OR SEWAGE COLLECTION LINES. A MINIMUM VERTICAL CLEARANCE OF 18 INCHES MUST BE MAINTAINED BETWEEN RECLAIMED WATER LINES AND POTABLE WATER MAINS OR SEWAGE COLLECTION LINES. AT CROSSINGS, PROVISIONS OF FAC RULE 62- 604 AND "RECOMMENDED STANDARDS FOR WASTEWATER FACILITIES" (10 STATES STANDARDS) LATEST EDITION SHALL APPLY.

4. HORIZONTAL SEPARATION OF 15 FEET TO BUILDING, TOP OF BANKS OF LAKES AND CANALS AND OTHER STRUCTURES SHALL BE MAINTAINED, IF POSSIBLE, AN ABSOLUTE MINIMUM OF 10 FEET MAY BE ALLOWED ONLY WHEN UNADVOIDABLE.

5. ALL UTILITY SEPARATIONS & CLEARANCES SHALL BE IN ACCORDANCE WITH PSLUSD STANDARD TECHNICAL SPECIFICATIONS, LASTEST EDITION.

### HYDROSTATIC AND LEAKAGE TESTING

- A. THE CONTRACTOR SHALL PROVIDE ALL NECESSARY EQUIPMENT SUCH AS PUMPS, GAUGES AND WATER MEASURING TANKS AND SHALL PERFORM ALL WORK REQUIRED FOR PIPE PRESSURE AND LEAKAGE TEST. HYDROSTATIC AND LEAKAGE TESTS SHALL BE MADE BETWEEN VALVES AND/OR CONNECTORS FOR EACH SECTION TESTED USING THE PROCEDURE OUTLINE IN
- B. HYDROSTATIC TESTING SHALL BE PERFORMED AT 150 AND 100 POUNDS PER SQUARE INCH PRESSURE, FOR A PERIOD OF NOT LESS THAN TWO HOURS FOR WATER/FORCE MAINS AND LOW PRESSURE MAINS RESPECTIVELY. THE ALLOWABLE RATE OF LEAKAGE SHALL BE LESS THAN THI NUMBER OF GALLONS PER HOUR DETERMINED BY THE FOLLOWING FORMULA:

- L = ALLOWABLE LEAKAGE IN GALLONS PER HOUR. S = LENGTH OF PIPE TESTED, FEET.
- D = NOMINAL DIAMETER OF THE PIPE IN INCHES. P = AVERAGE TEST PRESSURE MAINTAINED DURING THE LEAKAGE TEST IN POUNDS PER SQUARE INCH GAUGE.
- : THE TESTING PROCEDURE SHALL INCLUDE THE CONTINUED APPLICATION OF THE SPECIFIED PRESSURE TO THE TEST SYSTEM FOR THE TWO-HOUR PERIOD BY WAY OF A PUMP TAKING SUPPLY FROM A CONTAINER SUITABLE FOR MEASURING WATER LOSS. THE AMOUNT OF LOSS SHALL BE DETERMINED BY MEASURING THE VOLUME DISPLACED FROM SAID CONTAINER. ANY EXPOSED PIPE, FITTINGS, VALVES, HYDRANTS, AND JOINTS SHALL BE EXAMINED DURING THE TEST. ANY DAMAGED OR DEFECTIVE PIPE FITTINGS, VALVES, OR HYDRANTS THAT ARE DISCOVERED FOLLOWING THE PRESSURE TEST SHALL BE REPAIRED OR REPLACED WITH SOUND MATERIAL, AND ALL TESTS SHALL BE REPEATED.

D. THE PRESSURE SHALL NOT VARY BY MORE THAN ±5 PSI FROM THE REQUIRED PRESSURE FOR THE DURATION OF THE TEST. IF AT ANY POINT DURING THE TEST THE PRESSURE LOSS EXCEEDS 5 PSI. THE TEST IS CONSIDERED FAILED. SHOULD THE TEST FAIL, NECESSARY REPAIRS SHALL BE ACCOMPLISHED BY THE CONTRACTOR AND THE TEST REPEATED UNTIL WITHIN THE ESTABLISHED LIMITS.



CITY OF PSL PROJECT NO. P19-133-A PSLUSD FILE NO. 5342C

PHONE: (772) 879-0477

FBPE C.O.A. # 32222

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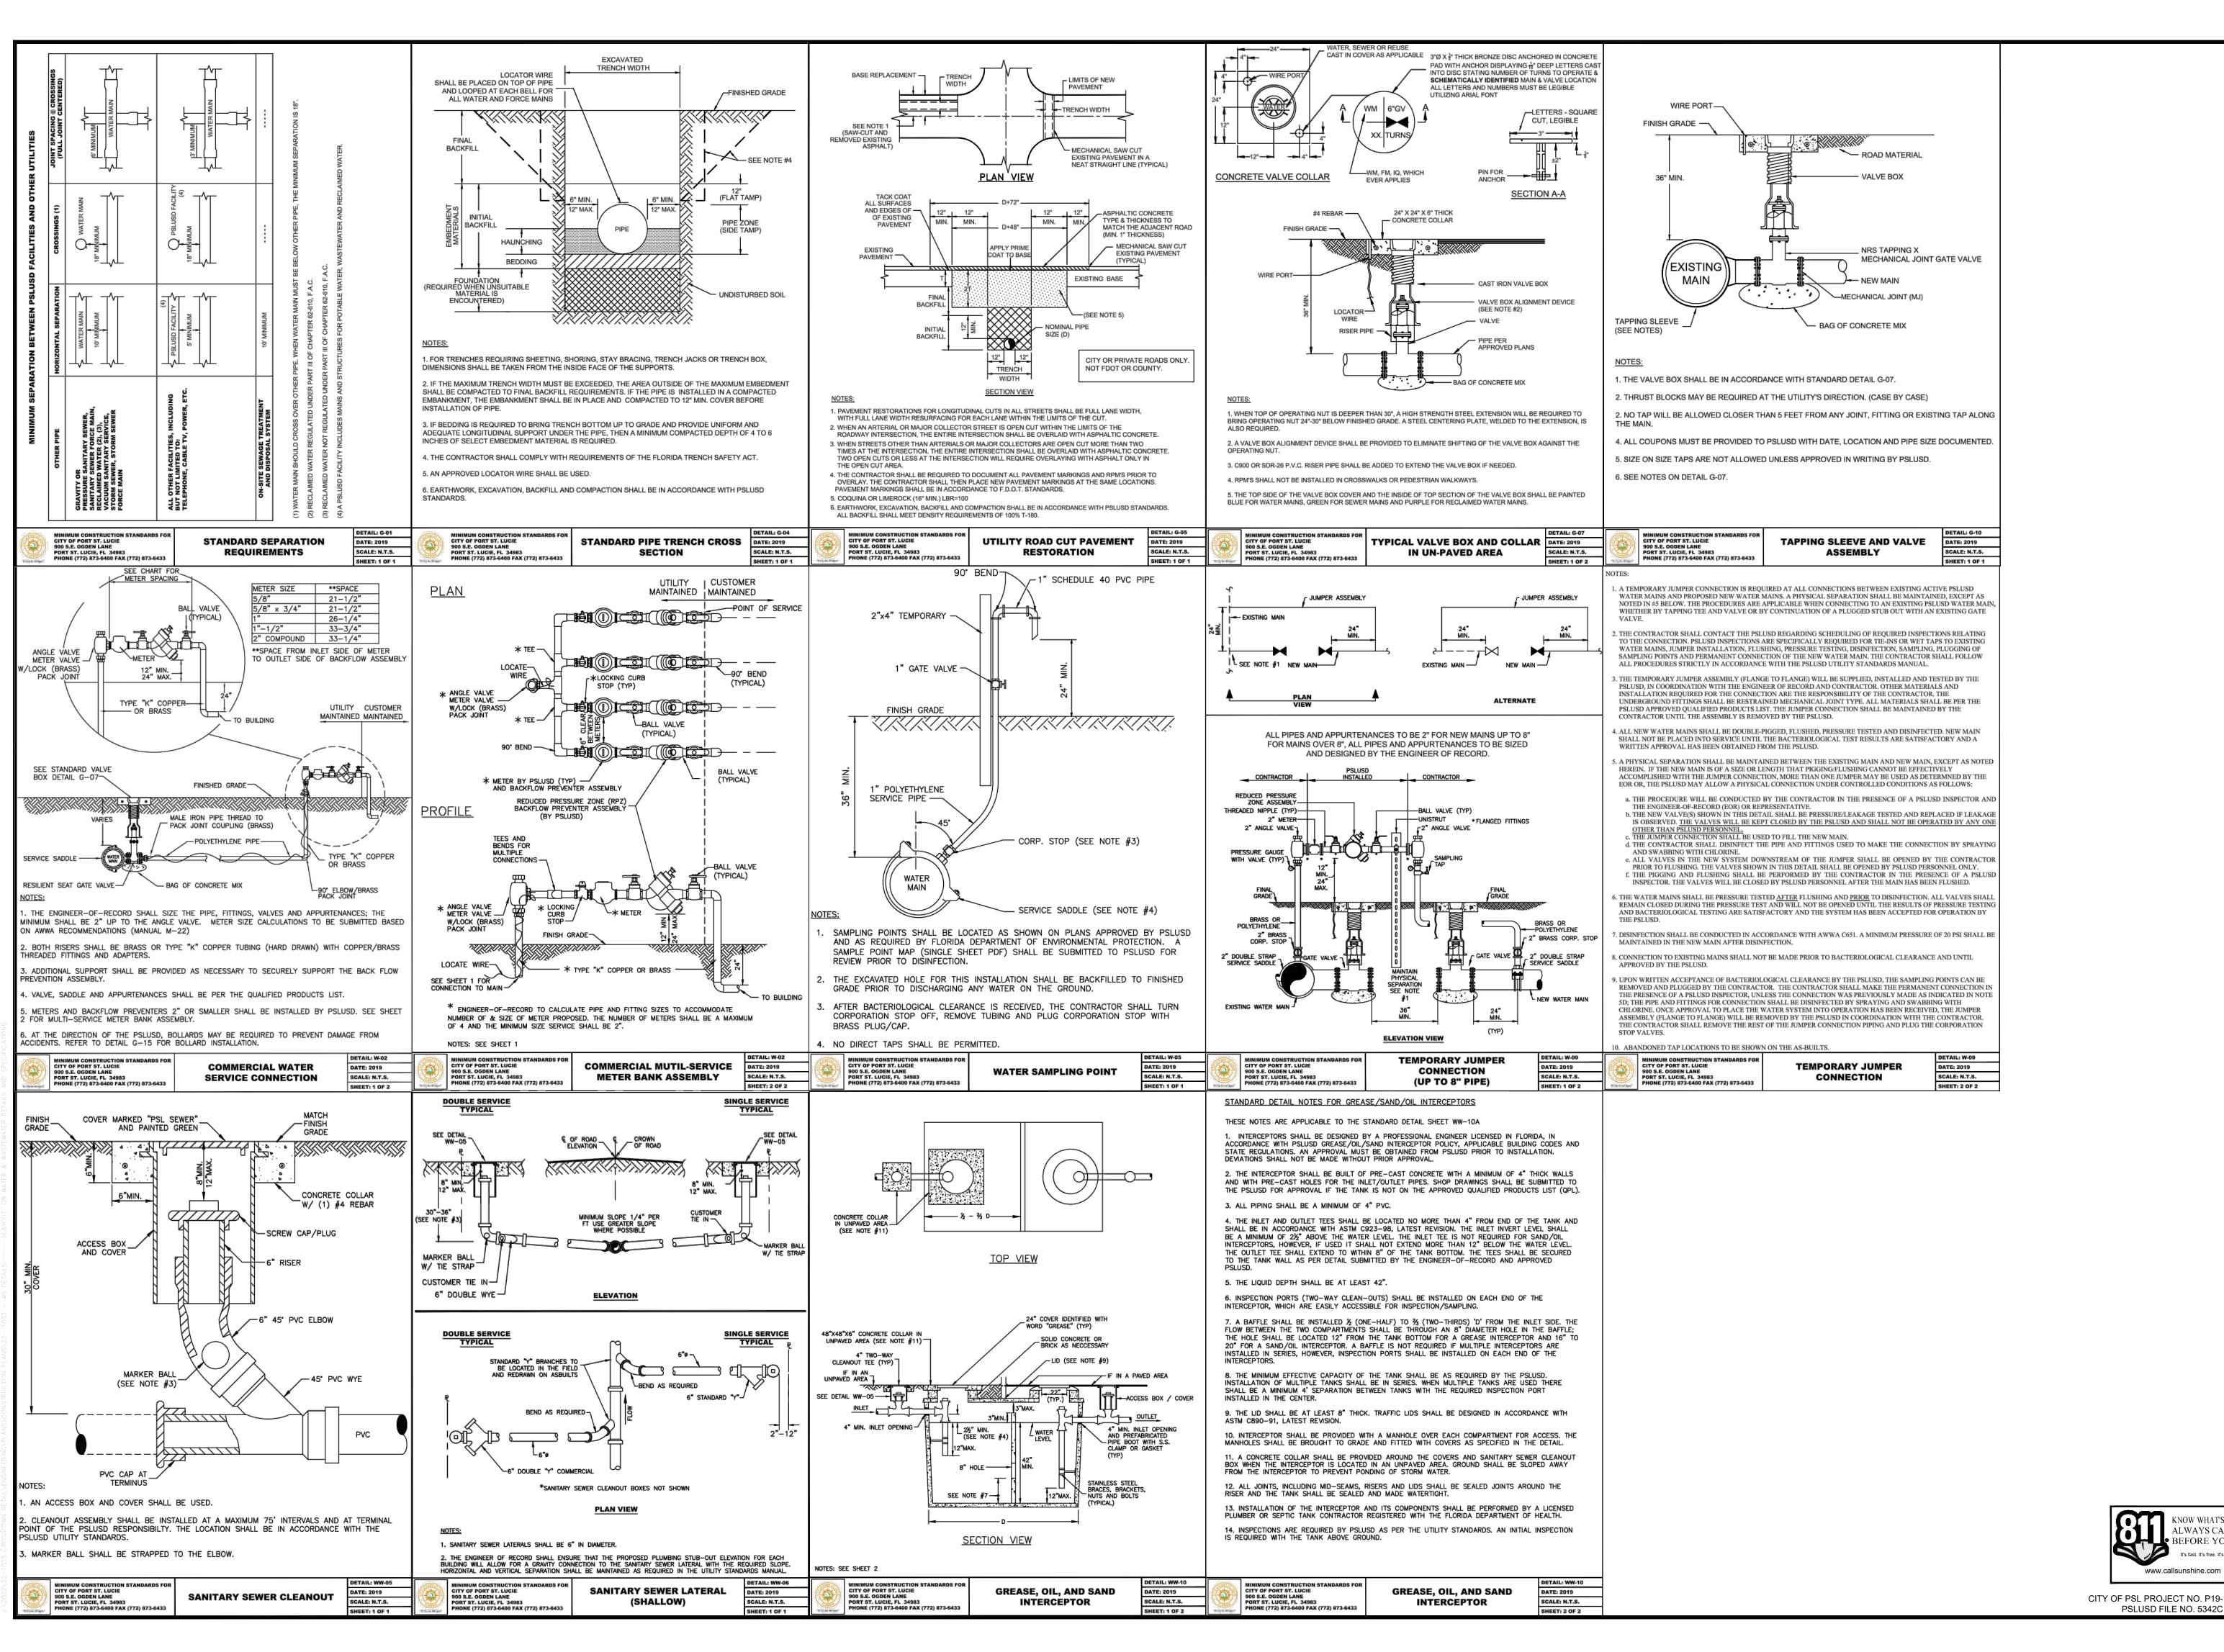
REVISIONS:		
BY:	DATE:	COMMENT:
JM	01/17/23	PER CITY OF PSL SPRC COMMENTS
JM	03/09/23	PER CITY OF PSL SPRC COMMENTS
JM	05/03/23	PER CITY OF PSL SPRC COMMENTS

**NOT FOR** CONSTRUCTION

DARREN GUETTLER, PI FLORIDA LICENSE No. 74637

RAWN BY: CHECKED BY: 22- 1033 - WS PLAN


> WATER & WASTEWATER **PLAN**



1449 NW COMMERCE CENTRE DR PORT ST. LUCIE, FL 34986 PHONE: (772) 879-0477 FBPE C.O.A. # 32222

**REVISIONS** COMMENT: PER CITY OF PSI JM 01/17/23 SPRC COMMENTS PER CITY OF PSI JM 03/09/23 SPRC COMMENTS PER CITY OF PSI SPRC COMMENTS

NOT FOR CONSTRUCTION

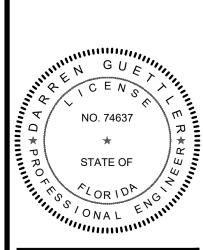

DARREN GUETTLER, P FLORIDA LICENSE No. 74637 5/11/23

RAWN BY: CHECKED BY: CAD I.D.: 22- 1033 - WS DETAILS

SHEET TITLE WATER &


WASTEWATER **DETAILS AND SPECIFICATIONS** 

www.callsunshine.com CITY OF PSL PROJECT NO. P19-133-A

KNOW WHAT'S BEL

ALWAYS CALL 8

BEFORE YOU DI

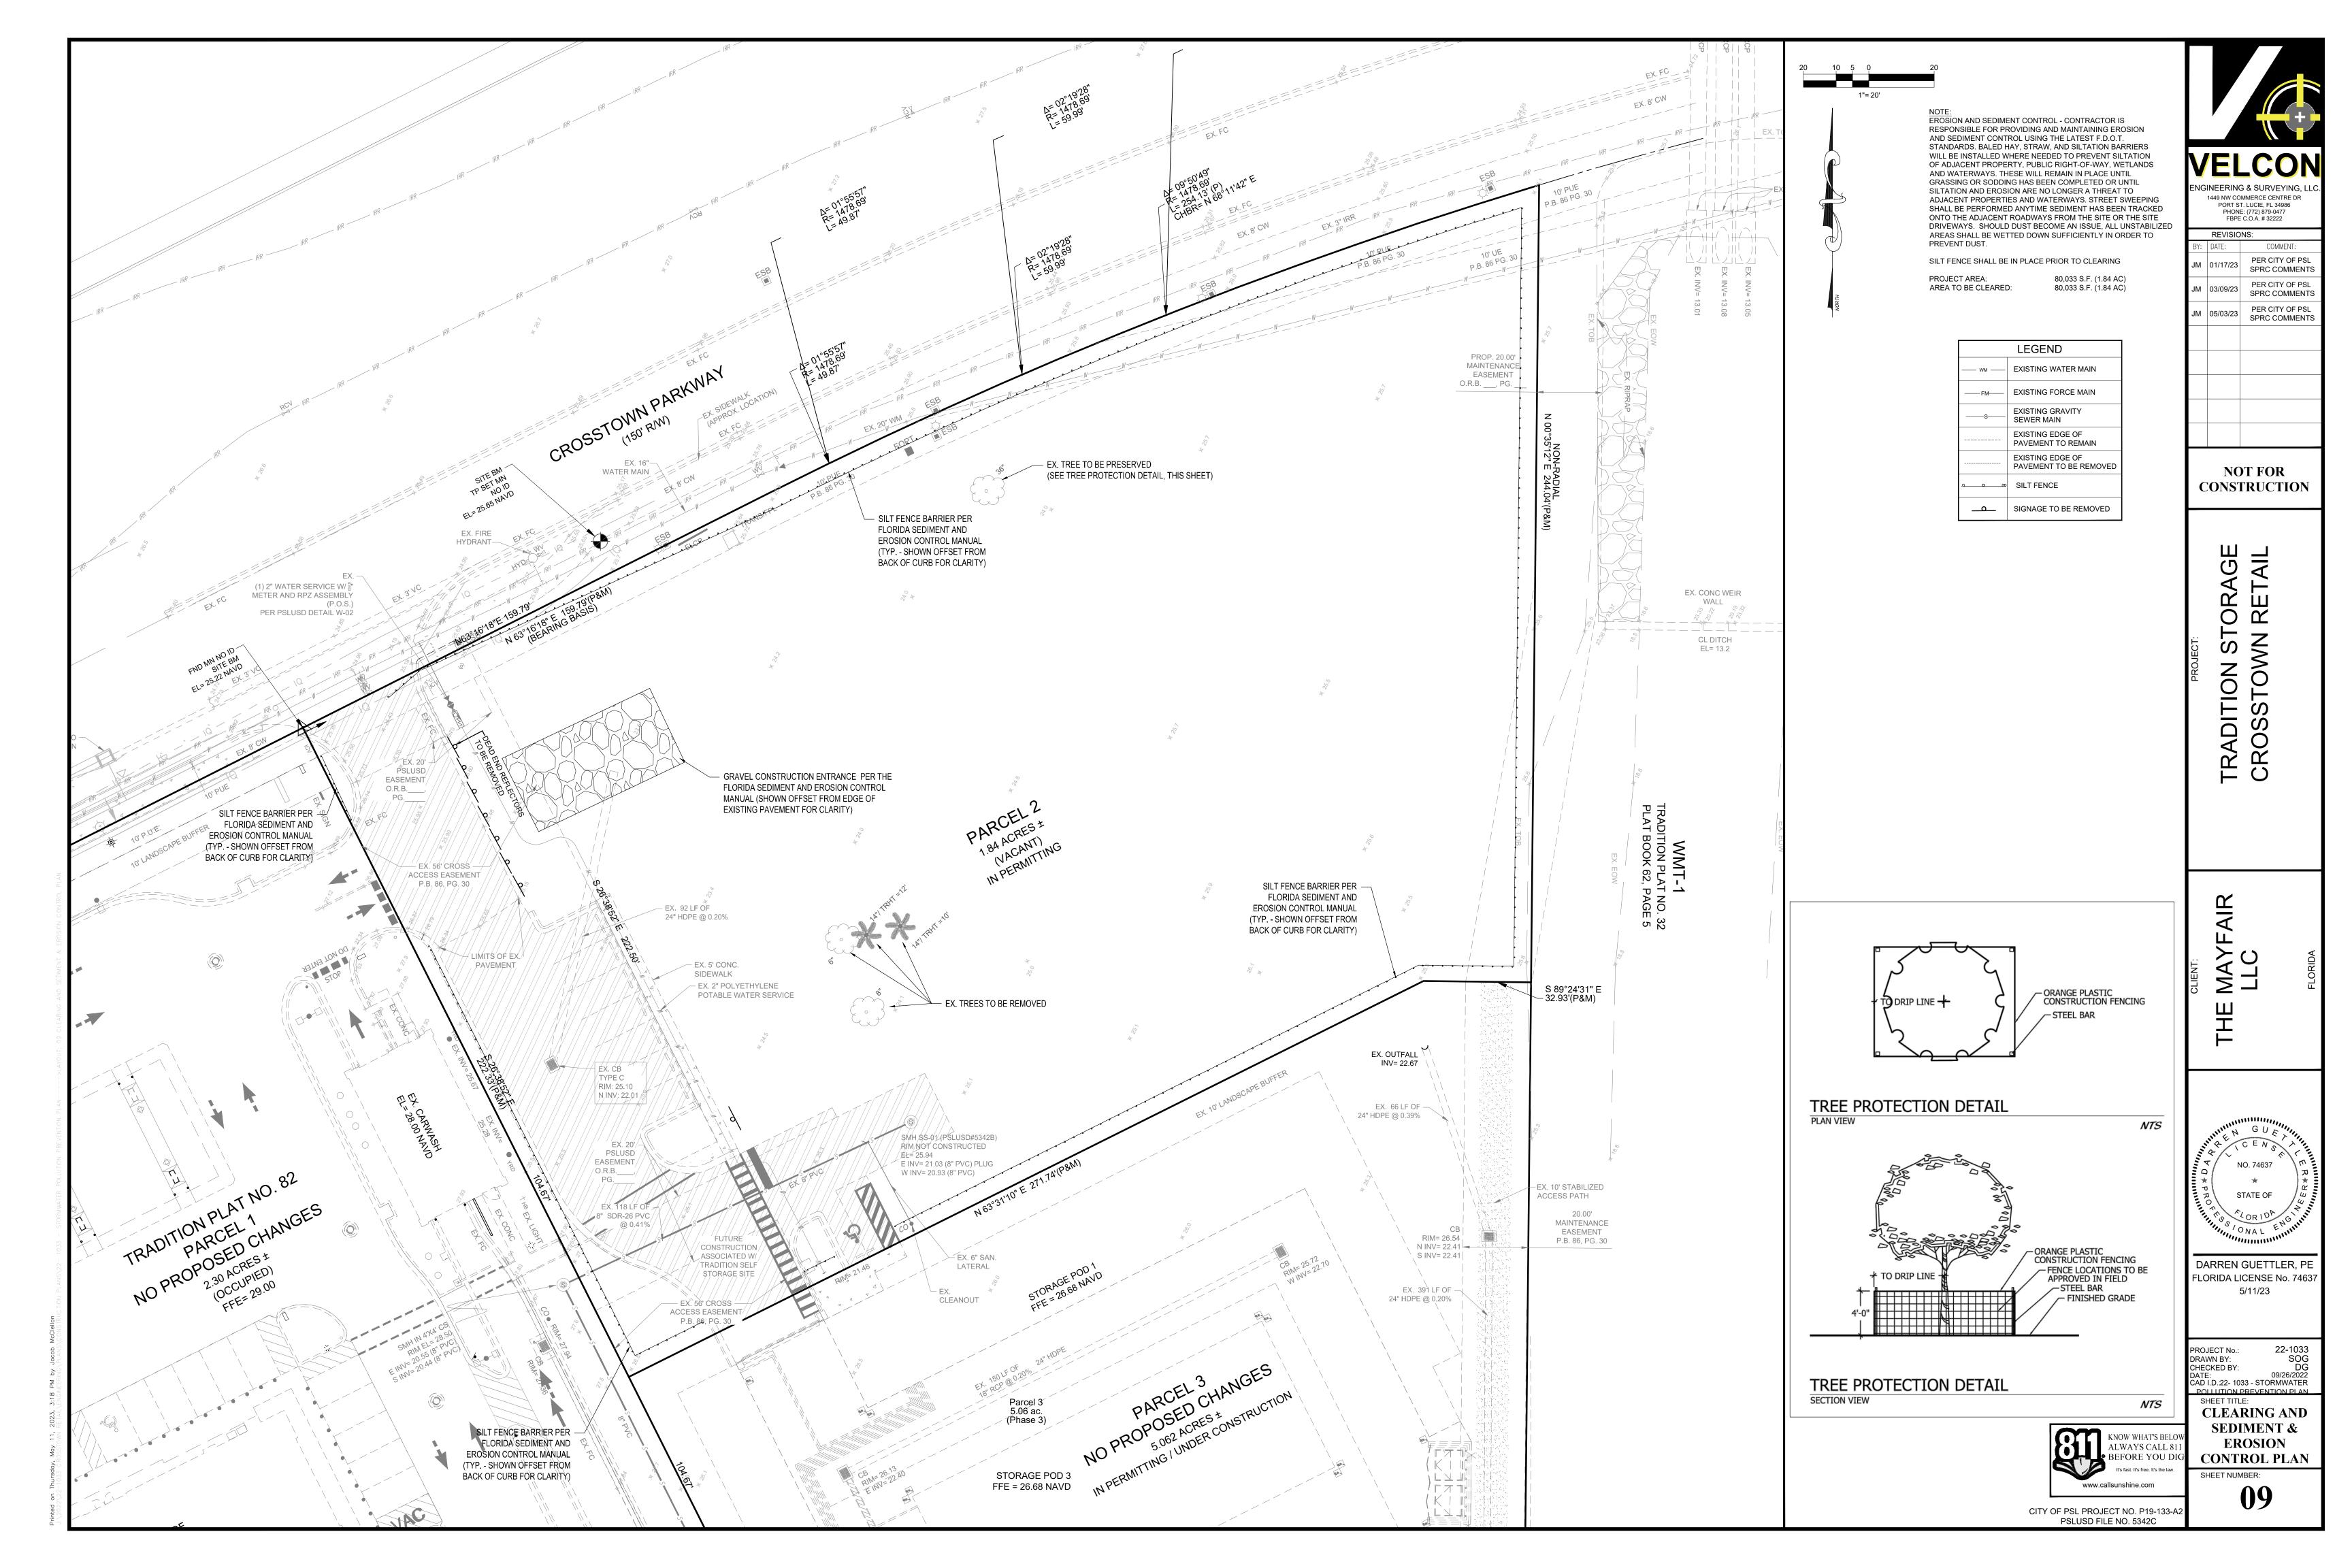

Port-o-lets will be placed away from storm sewer systems, storm inlet(s), surface waters and wetlands. No vehicle

maintenance shall be conducted on-site. A washdown

area shall be designated at all times and will not be located in any area that will allow for the discharge of


polluted runoff.

		,	
Section 3	Describe the intended sequence of major soil disturbing activities: The following sequence of major activities shall be followed unless the contractor can propose an alternative that is equal or exceeds the erosion and sediment control practices described in this document, and is approved by the Engineer. The detailed sequence for the entire project can vary significantly from contractor to contractor. The contractor is responsible for providing a detailed sequence of construction for all construction activities.		Secti
Section 4	Tatal and anata and affaita.	1.94 cores	
Section 4 Section 5	Total area onsite and offsite:  Total area onsite and offsite to be disturbed:	1.84 acres	
Section 6			
Section 7	Estimate the drainage area size for each discharge point:	1.84 acres	Secti
Section 8	Latitude and longitude of each discharge point and identify the receiving water or MS4 for each discharge point:	There is one (1) discharge point for the project. Lat. 27° 17' 29.81" N , Long. 80° 25' 57.64" W to the MS4 is the City of Port St. Lucie - FLR04E001	
Section 9	activities section. Provide time frames in which the con NOTE: All controls shall be consistent with performanc and stormwater treatment set forth in s. 62-40.432, F.A.	lentified in the intended sequence of major soil disturbing trols will be implemented. e standards for erosion and sediment control a.C., the applicable Stormwater or Environmental Resource Management District, and the guidelines contained in the	Sect
		ce of construction and the use of stabilization and structural nenting this portion of the SWPPP. The construction of this	
	Install stabilized construction entrances at all common a exiting the construction site. The driveways shall be confidential.	areas where construction vehicles will be entering and nstructed per the Florida Sediment and Erosion Control	
	Install silt fences, Type III, around all ditch bottom inlets the grates on catch basins may be used in lieu of a silt	s on the project, and the project perimeter. Filter cloth under fence.	
		ated in the Paving and Drainage Plan (discharge points).	
Section 10		actices. Stabilization practices include temporary seeding, ation, vegetative buffer strips, protection of trees, vegetative	
	Temporary: Seed and mulch, and sod in accordance with Specificat	tion Section 104.	
	have temporarily or permanently ceased, but in no case	racticable in portions of the site where construction activities more than 7 days after the construction  d. The contractor is also responsible for documenting this	
Section 11	silt fences, earth dikes, diversions, swales, sediment tr level spreaders, storm drain inlet protection, rock outlet	ny other way limit stormwater runoff. These controls include aps, check dams, subsurface drains, pipe slope drains,	Secti
	Temporary: Silt fence in accordance with the Florida Sediment and Staked turbidity barrier in accordance with the Florida Soil tracking prevention device in accordance with the A stabilized construction entrance to be constructed per All sediment controls shall be in place prior to any soil of the stabilized controls shall be in place prior to any soil of the stabilized construction entrance.	Sediment and Erosion Control Manual. Florida Sediment and Erosion Control Manual. er the Florida Sediment and Erosion Control Manual.	
Section 12		eas that will disturb 10 or more acres at one time. The be able to provide 3,600 cubic feet of storage for each acre alternative) are recommended for drainage areas under 10	
	N/A - less than 10 acres		
Section 13	Describe all permanent stormwater management contraystems or vegetated swales that will be installed during		
	All stormwater will be conveyed to the detention area s and pipes.	south of the project on Parcel 3 through drainage structures	Section 23
Section 14	Waste disposal, this may include construction debris, chemicals, litter, and sanitary wastes:  All construction materials and debris will be placed in a dumpster and hauled off site to a landfill or other proper disposal site. No materials will be buried on site.		
Section 15	Offsite vehicle tracking from construction entrances/exits:	Off site vehicle tracking of sediments and dust generation will be minimized via a rock construction entrance, street sweeping and the use of water to keep dust down.	
Section 16	The proper application rates of all fertilizers, herbicides and pesticides used at the construction site:	Florida-friendly fertilizers and pesticides will be used at a minimum and in accordance with the manufacturer's suggested application rates.	
Section 17	The storage, application, generation and migration of all toxic substances:	All paints and other chemicals will be stored in a locked covered shed.	


Section 19	Provide a detailed description of the maintenance plan for all structural and non-structural controls to assure that they remain in good and effective operating condition.
	Contractor shall provide routine maintenance of permanent and temporary sediment and erosion control features in accordance with the technical specifications or as follows, whichever is more stringent:
	<ul> <li>Silt fence shall be inspected at least weekly. Any required repairs shall be made immediately. Sediment deposits shall be removed when they reach approximately one-half the height of the barrier.</li> <li>Maintenance shall be performed on the rock entrance when any void spaces are full of sediment.</li> <li>Inlet(s)/outfalls shall be inspected immediately after each rain event and any required repairs to the filter inlets, silt fence, or filter fabric shall be performed immediately.</li> <li>Bare areas of the site that were previously seeded shall be reseeded per manufactures' instructions.</li> <li>Mulch and sod that has been washed out shall be replaced immediately.</li> <li>Maintain all other areas of the site with proper controls as necessary.</li> </ul>
Section 20	Inspections: Describe the inspection and inspection documentation procedures, as required by the FDEP NPDES Generic Permit for Stormwater Discharge from Large and Small Construction Activities.
	Qualified personnel will inspect all points of discharges, all disturbed areas of construction that have not been stabilized, constructed areas and locations where vehicles enter and exit the site, and all BMPs at least once every 7 calendar days and within 24 hours of the end of a rainfall event that is 0.5 inches or greater. Where sites have been finally stabilized, said inspections shall be conducted at least once every month until the Notice of Termination is filed.
Section 21	Identify and describe all sources of non-stormwater discharges as allowed by the FDEP NPDES Generic Permit for Stormwater Discharge from Large and Small Construction Activities.
	The contractor is required to submit a dewatering plan to SFWMD for approval prior to commencement of any construction activities that require dewatering. This plan shall include any stockpile areas and excavation area The contractor is responsible for documenting this portion of the SWPPP. If contaminated soil or groundwater is encountered, contact the District Hazardous Materials Coordinator
Section 22	Site Map
	The construction plans will substitute as site maps. Locations of the required information are described below
	Drainage Patterns:  The drainage flow directions are shown on the Paving and Drainage Plan.
	Approximate Slopes:  The slopes of the site can be seen on the Grading and Drainage plan and cross sections.
	Areas of Soil Disturbance:  The areas to be disturbed are indicated on the plan. Any areas where permanent features are shown to be constructed above or below ground will be disturbed.
	Areas not to be disturbed:  Those areas shown outside of the limits of the silt fence will not be disturbed.
	Locations of Controls:  The erosion control devices and locations are shown on the Sediment & Erosion Control Plan.
	Areas to be stabilized:  Temporary stabilization practices are also shown on the plans, if applicable. Areas of permanent stabilization are shown on the Paving and Drainage Plan.
	Surface Water: Surface water runoff will be collected by inlets and culverts and direct stormwater south to Parcel 3. Flows are then directed into the Tradition Master Stormwater Management System for Basin BCana
	Receiving Waters  The master stormwater management system outfalls to the existing canal to the east. Flows are then directed north to the C-24 Canal via various existing canals. Ultimate outfall is the north fork of the St. Lucie River.
Section 23	All contractor(s) and subcontractor(s) identified in the SWPPP must sign the following certification:
	"I certify under penalty of law that I understand, and shall comply with, the terms and conditions of the State of Florida Generic Permit for Stormwater Discharge from Large and Small Construction Activities and this Stormwater Pollution Prevention Plan prepared thereunder. This document and all attachments were prepared under my direction or supervision in accordance with a system designed to assure that qualified personnel properly gathered and evaluated the information submitted. Based on my inquiry of the person or persons who manage the system, or those persons directly responsible for gathering the information, the information submitted is, to the best of my knowledge and belief, true, accurate, and complete. I am aware that there are significant penalties for submitting false information, including the possibility of fine and imprisonment for knowing violations."

Name	Title	Company Name, Address and Phone Number	Responsible Items	Date


Name (Operator and/or Responsible Authority)

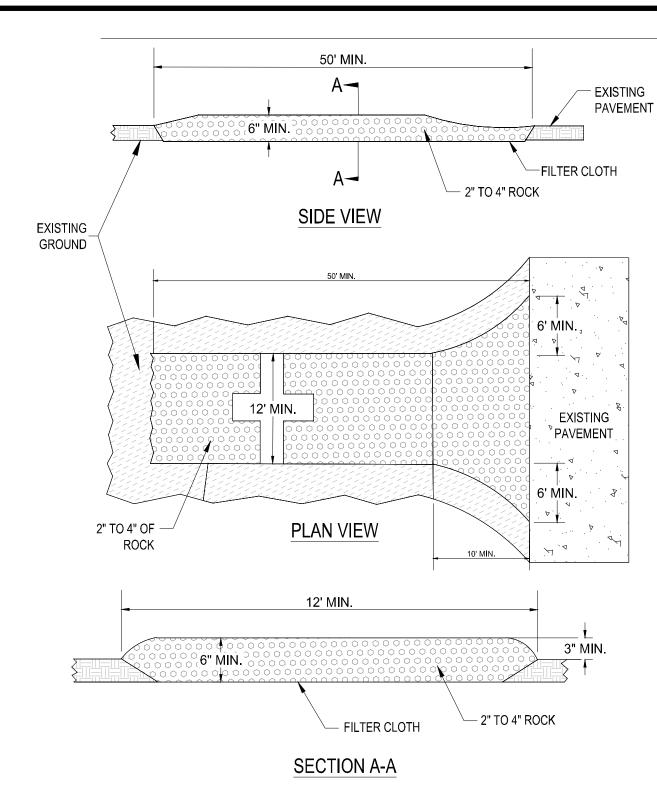

# SOIL TRACKING PREVENTION DEVICE

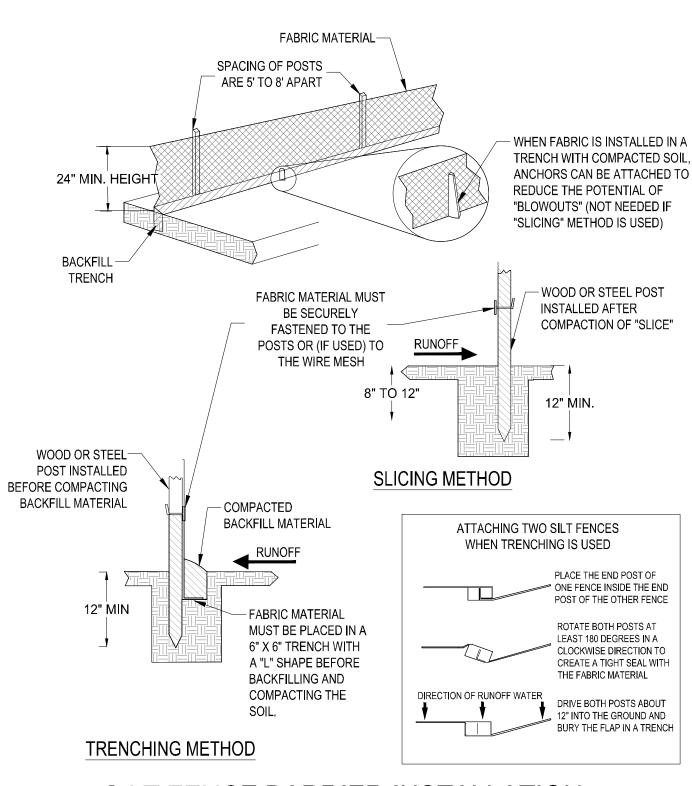

# SILT FENCE BARRIER INSTALLATION

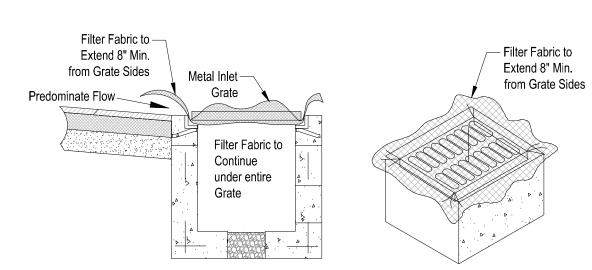


PICTORIAL VIEW

**GENERAL NOTES:** 

1. THIS INLET IS DESIGNED WITH FILTER FABRIC PROTRUDING 8" FROM SIDES FOR GRIPPING WHEN SEDIMENT NEEDS TO BE CLEARED AFTER FINAL CONSTRUCTION. 2. FILTER FABRIC TO BE INSTALLED AND TRIMMED BEFORE GRATE IS INSET.

FILTER FABRIC DETAIL

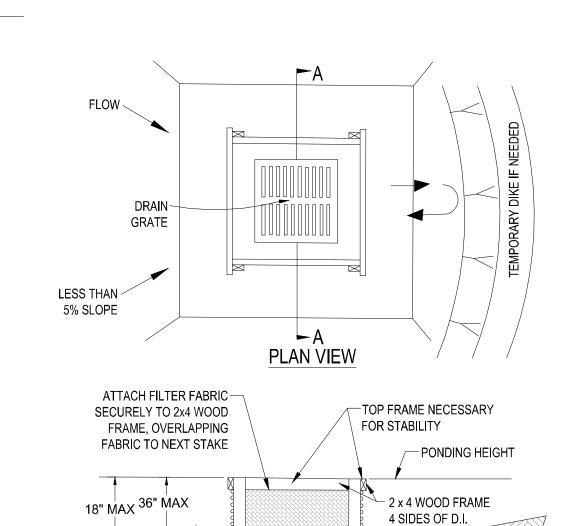

### **SECTION A-A**

1. DROP INLET SEDIMENT BARRIERS ARE TO BE USED FOR SMALL, NEARLY LEVEL DRAINAGE AREAS. (LESS

2. USE 2 x 4 WOOD OR EQUIVALENT METAL STAKES, (3' MIN. LENGTH)


12" MIN

3. INSTALL 2 x 4 WOOD TOP FRAME TO INSURE STABILITY. 4. THE TOP OF THE FRAME (PONDING HEIGHT) MUST BE WELL BELOW THE GROUND ELEVATION DOWNSLOPE

TO PREVENT RUNOFF FROM BYPASSING THE INLET. A TEMPORARY DIKE MAY BE NECESSARY ON THE DOWNSLOPE OF THE STRUCTURE.


DROP

# SILT FENCE DROP INLET SEDIMENT BARRIER

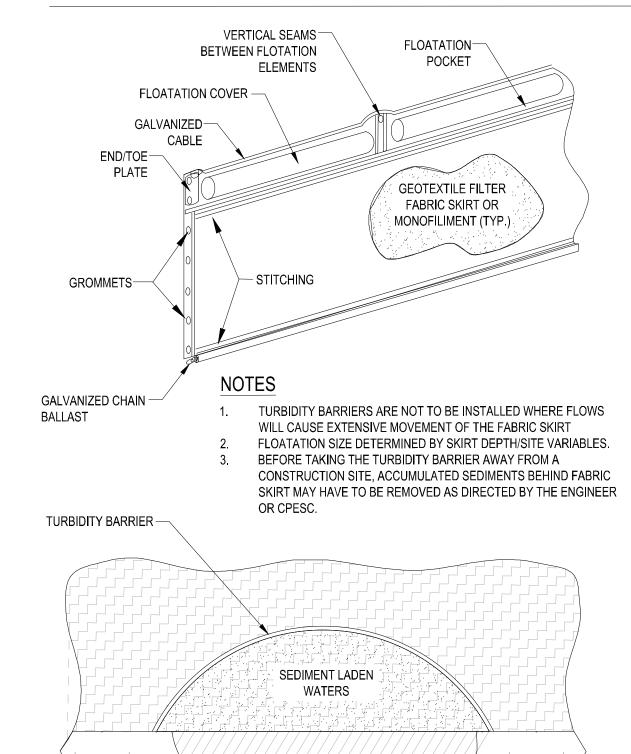

TURBIDITY BARRIER

CONSTRUCTION

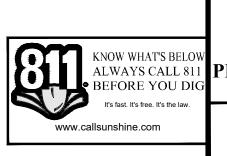

CITY OF PSL PROJECT NO. P19-133-A PSLUSD FILE NO. 5342C

Section 18 Other:

DRAWN BY: CHECKED BY: DATE: 09/26/2022 CAD I.D.:22- 1033 - STORMWATER

DARREN GUETTLER, PE FLORIDA LICENSE No. 74637

5/11/23

1449 NW COMMERCE CENTRE DR

PORT ST. LUCIE, FL 34986

NOT FOR

**CONSTRUCTION** 

COMMENT:

PER CITY OF PSI

SPRC COMMENTS

PER CITY OF PSL

SPRC COMMENTS PER CITY OF PSL

SPRC COMMENTS

PHONE: (772) 879-047 FBPE C.O.A. # 32222

JM 01/17/23

SHEET TITLE: **STORMWATER POLLUTION** 

PREVENTION PLAN SHEET NUMBER: