
CORPORATE AIR, INC. VERO AIRCRAFT HANGAR #1

PERMIT SET

2614 AIRPORT NORTH DRIVE, VERO BEACH FL

01/17/2023

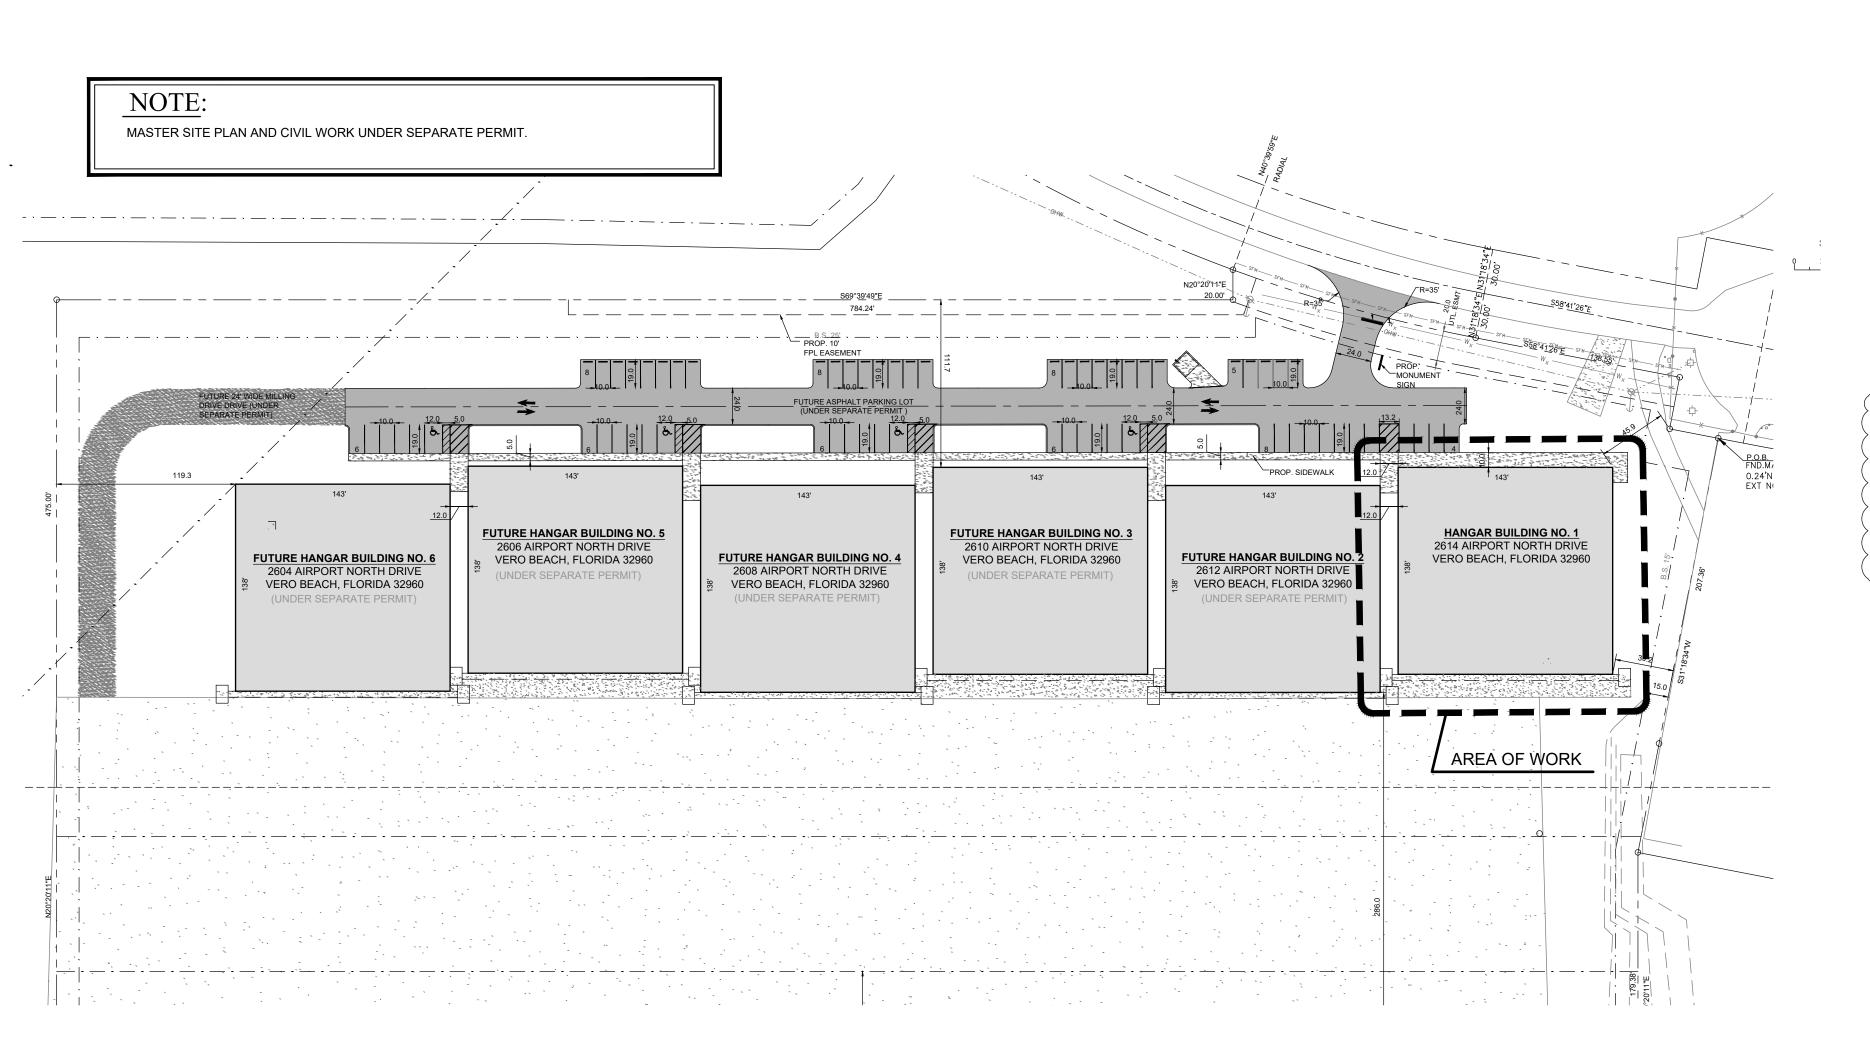

PROJECT LOCATION PLAN

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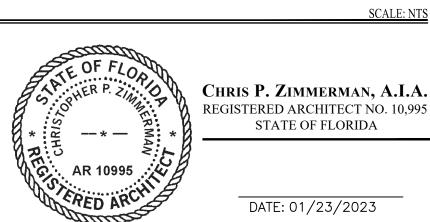
MECHANICAL NOTES

MECHANICAL PLAN

>	STRU	JCTURAL .		
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ROOF PLAN

PROJECT NO. 2247

GENERAL NOTES:	<u>CONSTRUCTION NOTES</u> :	REFLECTED CEILING NOTES:	POWER & COMMUNICATION NOTES:	<u>FINISH NOTES</u> :	
ALL WORK SHALL COMPLY WITH APPLICABLE LOCAL 1. A AND MUNICIPAL BUILDING CODES, AS WELL AS	ALL LOCKSETS SHALL BE MASTER KEYED AS REQUIRED BY THE OWNER. SEE DOOR SCHEDULE & HARDWARE SCHEDULE FOR INFORMATION.	1. SEE ENGINEER'S DRAWINGS FOR ADDITIONAL NOTES AND GENERAL INFORMATION. 2. SEE ENGINEER'S DRAWINGS FOR ALL LIGHT FUTURE CREDITING, EMERGENCE AND ENTER LAND ENGINEER CONTRACTOR IS TO VERIFY ALL LIGHT FIXTURE WITHOUT AND BELATED WORK. CONTRACTOR IS TO VERIFY ALL LIGHT FIXTURE WATTING (MM.) AND PROVIDE PROPER MIMSER OF SWITCHES AT THAT LOCATION TO SERVICE INDICATED LIGHT FUTURES. 3. SEE ENGINEER'S DRAWINGS FOR ALL CELLING OFFISCES, DUCTIVING LAND SEA THAT SEE PLOYING STREETS DUCTIVING LAND SEA THAT LOCATION ONLY. WHERE DISCREPANCIES OCCUR ESTWEEN ENGINEERS INDICATED INFORMATION ONLY. WHERE DISCREPANCIES OCCUR ESTWEEN ENGINEERS AND OLDERN. 4. SENSTRAL CONTRACTOR SHALL PROVIDE A LOCATION ONLY. WHERE DISCREPANCIES OCCUR ESTWEEN ENGINEERS AND OLDERN. 5. HOLD CONTRACTOR SHALL PROVIDE A LOCATION ONLY. WHERE DISCREPANCIES OF THE LOCATION ONLY. WHERE DISCREPANCIES OCCUR ESTWEEN ENGINEERS AND OLDERN. 5. HOLD CONTRACTOR SHALL PROVIDE A LOCATION ONLY. WHERE DISCREPANCIES OCCUR ESTWEEN ONLY. WHEN IN THE LOCATION OF SUBJECT CHAIN OF SHALL PROVIDE AND INSTALL AND INSTALL AND INSTALL AND INSTALL SHALLOW OF A THAT SHALL OTHER TEXT. 5. CENTRAL CONTRACTOR SHALL PROVIDE AT 3"-2" A.F.F. TO CENTER LINE OF SWITCH JOHN RE. MULTIPLE SWITCHES AND INSTALL APPROPRIATE DURING FOR EMAILED, AND PROVIDED WITH SINGLE GAME FLUIFS. 6. ALL SWITCHES/DIMMERS TO BE MOUNTED AT 3"-2" A.F.F. TO CENTER LINE OF SWITCH JOHN RE. MULTIPLE SWITCHES AND INSTALL APPROPRIATE DURING SA REQURRED BY SWITCH SWITCH SUBJECT SHALLOW DEPTH FINTURES AS FELD CONDITIONS NECESSIA'S WITH SWITCH GAME FLUIFS. 8. GENERAL CONTRACTOR TO PROVIDE WITH SWITCH CAMP FOR A RESIDENCY OF A SALLOW DEPTH FINTURES AS FELD CONDITIONS NECESSIA'S WITH SWITCH GAME FLUIFS. 8. GENERAL CONTRACTOR TO FABRICATION OF ANY WORK. 11. SERRIWLEER SUBCONTRACTOR TO SUBMIT A LAYOUT SHOP DRAWING TO ARCHITECTS OFFICE FOR A THE DAY ON A PROVIDE OF ALL SERVICLE HEADS AND A PROVIDE OF ALL SERVICLES HEADS AND A PROVIDE OF A LAYOUT CANDER TO THE PROVIDE AND A PROVIDE OF A LAYOUT CANDER TO THE PROVIDE AND	1. SEE ENGINEER'S DRAWING FOR ALL CIRCUITING AND RELATED WORK. 2. GENERAL CONTRACTOR SHALL VERIFY THE AVAILABLE ELECTRIC SERVICE AND ADVISE THE ARCHITECT OF THEIR FINDINGS PRIOR TO SUBMITTING A BID. 3. ELECTRICAL CONTRACTOR SHALL DISCONNECT, CONNECT, AND PROVIDE NECESSARY ELECTRIC RUNS IN ORDER TO CONFORM WITH NEW PLAN. 4. SWITCHES, DUPLEX OUTLETS, COVER PLATES AND FLOOR MOUNTED OUTLETS SHALL BE INSTALLED BY COMPETENT MECHANICS IN A FIRST CLASS MANNER. 5. THE ELECTRICAL CONTRACTOR SHALL INCLUDE AND COORDINATE ELECTRICAL REQUIREMENTS FOR ALL HVAC EQUIPMENT, EXHAUST FANS, WATER HEATERS, AND SPECIAL EQUIPMENT, ETC. 6. EXCEPT AS NOTED, ALL ELECTRICAL AND TELEPHONE WALL OUTLETS ARE TO BE MOUNTED AT 15" AFF TO CENTER LINE.	1. SAMPLES OF ALL FINISHES SPECIFIED SHALL BE SUBMITTED TO ARCHITECT TOA PROVAIL, IN TRIPLICATE, PRIOR TO COMMENCEMENT OF THE WORK, WALLCOVERING SAMPLES TO BE A MIN. 12" X 12". PAINT SAMPLES FOR GYP. BD. SURFACES TO BE PROVIDED ON 12" X 12" PRECES OF GYP. BD. 2. ALL WALLS (NEW AND EXISTING) SHALL BE PROPERTY PREPARED (SPACKLE), SANDED, ETC.) FOR PAINTING AND MANUFACTURER'S SPECIFICATIONS. 3. ALL PAINTS SHALL BE APPLIED IN ACCORDANCE WITH MANUFACTURER'S SPECIFICATIONS FOR THE PARTICULAR SURFACE. 4. ALL SURFACES WHICH ARE TO BE PAINTED SHALL RECEIVE (I) COAT OF PRINER AND (2) COATS OF FINISH PAINT. (3) COATS TOTAL. 5. ALL DOORS AND FRAMES TO BE PAINTED THE SAME COLOR AND TYPE OF PAINT ON BOTH SIDES, UNLESS OTHERWISE NOTED.	

PERMIT SET 01/17/23

NO. REVISION DATE


VERO AIRCRAFT HANGAR #1



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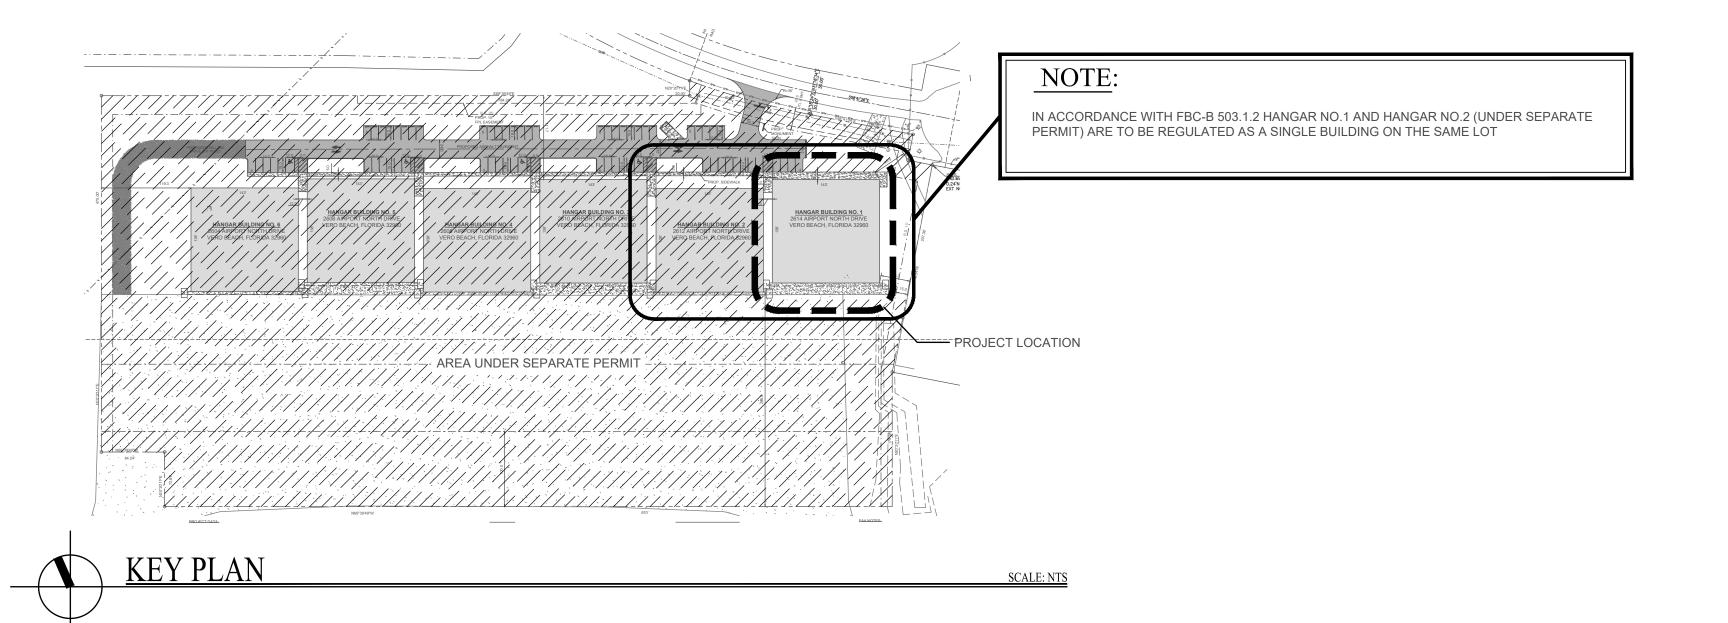
GENERAL NOTES


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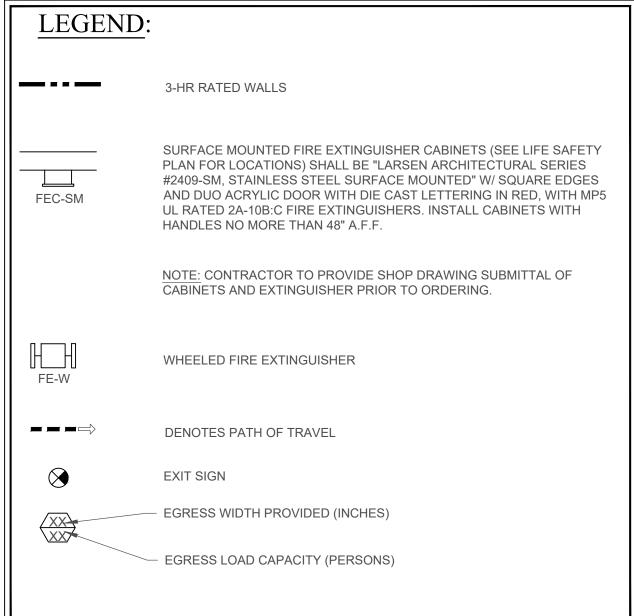
CHRIS P. ZIMMERMAN, A.I.A.
REGISTERED ARCHITECT NO. 10,995
STATE OF FLORIDA

DATE: 01/23/2023

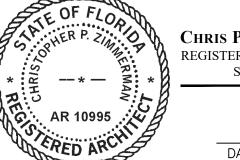



LIFE SAFETY PLAN

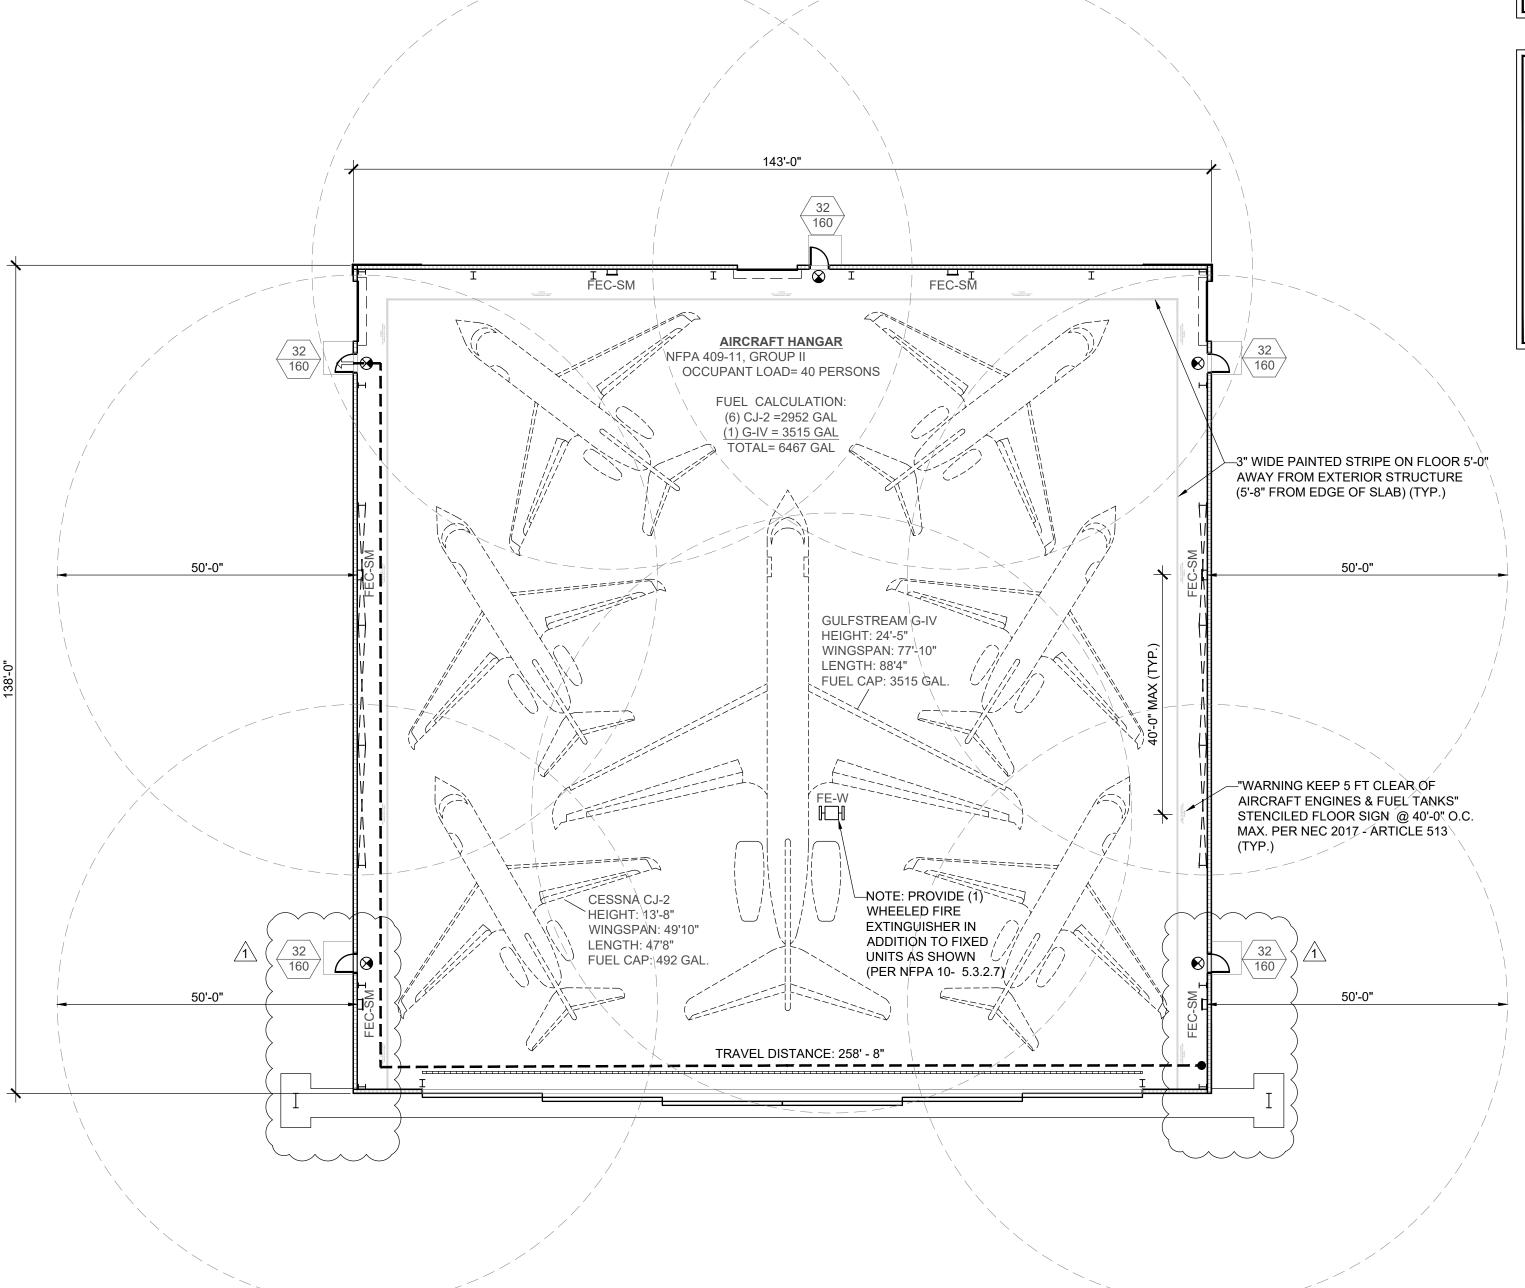

HAZARDOUS OPERATIONS NOT ALLOWED:

1. FUEL TRANSFER 2. WELDING

2. WELDING 3. TORCH CUTTING

4. TORCH SOLDERING 5. DOPING

6. HOT WORK (I.E. WELDING, CUTTING, BRAZING, GRINDING)
7. SPRAY PAINTING


8. OXYGEN SERVICE

9. COMPOSITE REPAIRS 10. FUEL SYSTEM OR FUEL TANK MAINTENANCE

11. AIRCRAFT CABLING

12. WIRING CHANGES

13. INITIAL ELECTRICAL SYSTEM TESTING

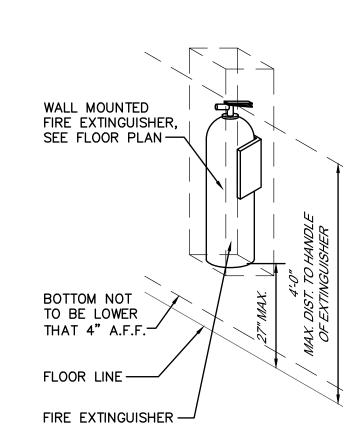

2 FIRE EXTINGUISHER
LS-100 N.T.S.

BUILDING CODE INFORMATION

GOVERNING CODE: FLORIDA BUILDING CODE 7th EDITION (2020) - BUILDING

FLORIDA FIRE PREVENTION CODE 2020, 7th EDITION (NFPA 1 2018 ED. & NFPA 101 2018 ED.)
NFPA 409 STANDARD ON AIRCRAFT HANGARS

(PER FLORIDA BUILDING CODE 7th EDITION 2020- BUILDING)

PROPERTY ADDRESS: 2600 AIRPORT NORTH DRIVE VERO BEACH, FLORIDA 32960

DESCRIPTION OF WORK: NEW AIRCRAFT HANGAR METAL BUILDING

CLASSIFICATION OF WORK: NEW CONSTRUCTION

	PER 7th EDITION FBC	PER 7th EDITION FFPC
USE AND CLASSIFICATION	S-1 STORAGE (AIRCRAFT HANGAR) (FBC-B 311.2)	STORAGE (ORDINARY HAZARD) (AIRCRAFT HANGAR) (FFPC 6.1.13)
		GROUP II AIRCRAFT HANGAR (NFPA 409 CHAPTER 10)
WALLS & CEILINGS (MIN. INTERIOR FINISH)	(FBC-B 803.11) EXIT ENCLOSURES AND PASSAGEWAYS - CLASS "C" CORRIDORS - CLASS "C" ROOMS & ENCLOSED SPACES - CLASS "C"	(FFPC 42.3.3.2) EXIT ENCLOSURES AND PASSAGEWAYS - A OR B OTHERS - A,B, OR C
FLOORING (MIN. INTERIOR FINISH)	(FBC-B 804.4.2) EXIT ENCLOSURES AND PASSAGEWAYS - CLASS II CORRIDORS - CLASS II ROOMS & ENCLOSED SPACES - CLASS II	(FFPC 42.3.3.3.1) EXIT ENCLOSURES AND PASSAGEWAYS - I OR II OTHERS - NOT REQ

CONSTRUCTION TYPE: II-B SPRINKLERED (FBC-B) II-000 [GROUP II] (NFPA 409 TABLE 6.1.2)

CONSTRUCTION: PRE-MANUFACTURED METAL BUILDING, CMU BASE, STEEL ROOF STRUCTURE

FIRE RESISTANCE RATINGS (FBC-B TABLE 601):

BUILDING ELEMENT	TYPE II B
STRUCTURAL FRAME	0
BEARING WALLS	
EXTERIOR	0
INTERIOR	0
NON BEARING- EXTERIOR	0
NON-BEARING INTERIOR WALLS & PARTITIONS	0
FLOOR CONSTRUCTION	0
ROOF CONSTRUCTION	0
FIRE SPRINKLERS	PROVIDED

HIGH-VELOCITY HURRICANE ZONES FIRE CLASSIFICATION SECTION FBC-B 1516 "CLASS B" ROOF ASSEMBLIES AND ROOF COVERINGS REQUIRED TO BE LISTED BY THIS SECTION SHALL BE TESTED IN ACCORDANCE WITH ASTM E108 OR UL790. IN ADDITION, FIRE RETARDANT TREATED WOOD ROOF COVERINGS SHALL BE TESTED IN ACCORDANCE WITH ASTM D2898.

CLASSIFICATION OF OCCUPANCY HA (NFPA 10 SECTION 5.4)	AZARD	EXTRA HAZARD
BUILDING HEIGHT & AREA LIMITATIO	NS (FBC-B TABLE 504.3a & 504.4):	
MAX. # OF STORIES PERMITTED:	3 STORIES (FBC-B TABLE 504.4)	
MAX. # OF STORIES PROVIDED:	1 STORY	

MAX. HEIGHT PERMITTED: 75'-0" (FBC-B TABLE 504.3a)

MAX. HEIGHT PROVIDED: 38'-1"

MAX. AREA PERMITTED (PER FLOOR): 70,000 SF (FBC-B TABLE 506.2) 12,001-40,000 SF (NFPA 409 6.1.3)

MAX. AREA PROVIDED (PER FLOOR):

19,974 SF (GROSS AREA HANGAR #1)
19,974 SF (GROSS AREA HANGAR #2) *UNDER SEPARATE PERMIT 19,521 SF (NET FIRE AREA HANGAR #2) *UNDER SEPARATE PERMIT 19,521 SF

39,948 SF (TOTAL GROSS AREA) 39,042 SF (TOTAL NET FIRE AREA)

OCCUPANT LOAD (CHAPTER 10):

 (PER FBC TABLE 1004.1.2)
 (PER FFPC TABLE 14.8.1.2)

 AIRCRAFT HANGARS - 500 SF/PERSON
 STORAGE OTHER THAN MERCANTILE - 500 SF/PERSON

 19,734 SF/500 = 40
 19,734 SF/500 = 40

 EGRESS:
 PER 7th EDITION FBC
 PER 7th EDITION FFPC

 MAX.TRAVEL DISTANCE PERMITTED
 \$1 (TABLE 1017.2)- 400FT
 \$TORAGE (TABLE 42.2.6)-400FT

MAX. TRAVEL DISTANCE PROVIDED: 258'-8"

MAX. SPACING BETWEEN EXITS: 150'-0" PROPOSED:108'-2"

COMMON PATH OF EGRESS TRAVEL \$1 (1006.3.3(2)) - 75' 0" STORAGE (TABLE 42.2.5)-100FT

COMMON PATH OF EGRESS TRAVEL PF	OVIDED LESS THAN 75'				
(PER FBC TABLE 1005.3.2): TOTAL EGRESS WIDTH REQUIRED	40 OCCUPANTS x 0.2 =8" (PER FBC)	40 OCCUPANTS x 0.2 = 8" (PER FFPC)			
TOTAL EGRESS WIDTH PROVIDED	160 IN PROVIDED (5) SINGLE DOORS @ 32"	160 IN PROVIDED -(5) SINGLE DOORS @ 32"			
MINIMUM CLEAR OPENING REQUIRED	(TABLE 1010 1 1) - 32"	(TABLE 7 2 1 2 4) - 32"			

MINIMUM CLEAR OPENING REQUIRED (TABLE 1010.1.1) - 32" (TABLE 7.2.1.2.4)

EXITS REQUIRED (TABLES 1015.1, 1021, 1021.2) MORE THAN 2

EXITS PROVIDED: 5

FIRE PROTECTION:

MAXIMUM TRAVEL DISTANCE TO FIRE EXTINGUISHER REQUIRED (NFPA 10 TABLE 6.3.1.1): 50'-0" (80-B RATING)

MAXIMUM TRAVEL DISTANCE TO FIRE LESS THAN 50'-0"


EXTINGUISHERS PROVIDED:

NUMBER OF FIRE EXTINGUISHERS PROVIDED

(6) FIXED + (1) WHE

NUMBER OF FIRE EXTINGUISHERS PROVIDED (6) FIXED + (1) WHEELED = (7) TOTAL EXTINGUISHERS

TYPE OF FIRE EXTINGUISHERS PROVIDED: MP5 UL RATING 2A-10B:C (TYPICAL)

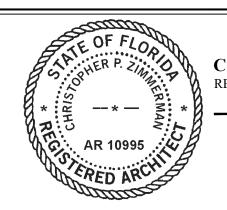

CHRIS P. ZIMMERMAN, A.I.A.
REGISTERED ARCHITECT NO. 10,995
STATE OF FLORIDA

DATE: 01/23/2023

LS-10

SCALE:1/16" = 1'-0"

CPZ ARCHITEC

VERO

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REVISION #1 02/03/23

4316 WEST BROWARD B PLANTATION, FLORIDA PHONE: (954) 792-8525 A A #2600685 WWW CF


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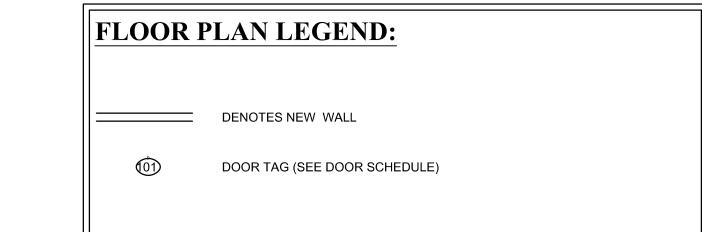
LIFE SAFETY PLAN


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PROJECT NO. 2247

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EXIT DOOR DETAIL SCALE: 1/2" = 1'-0"


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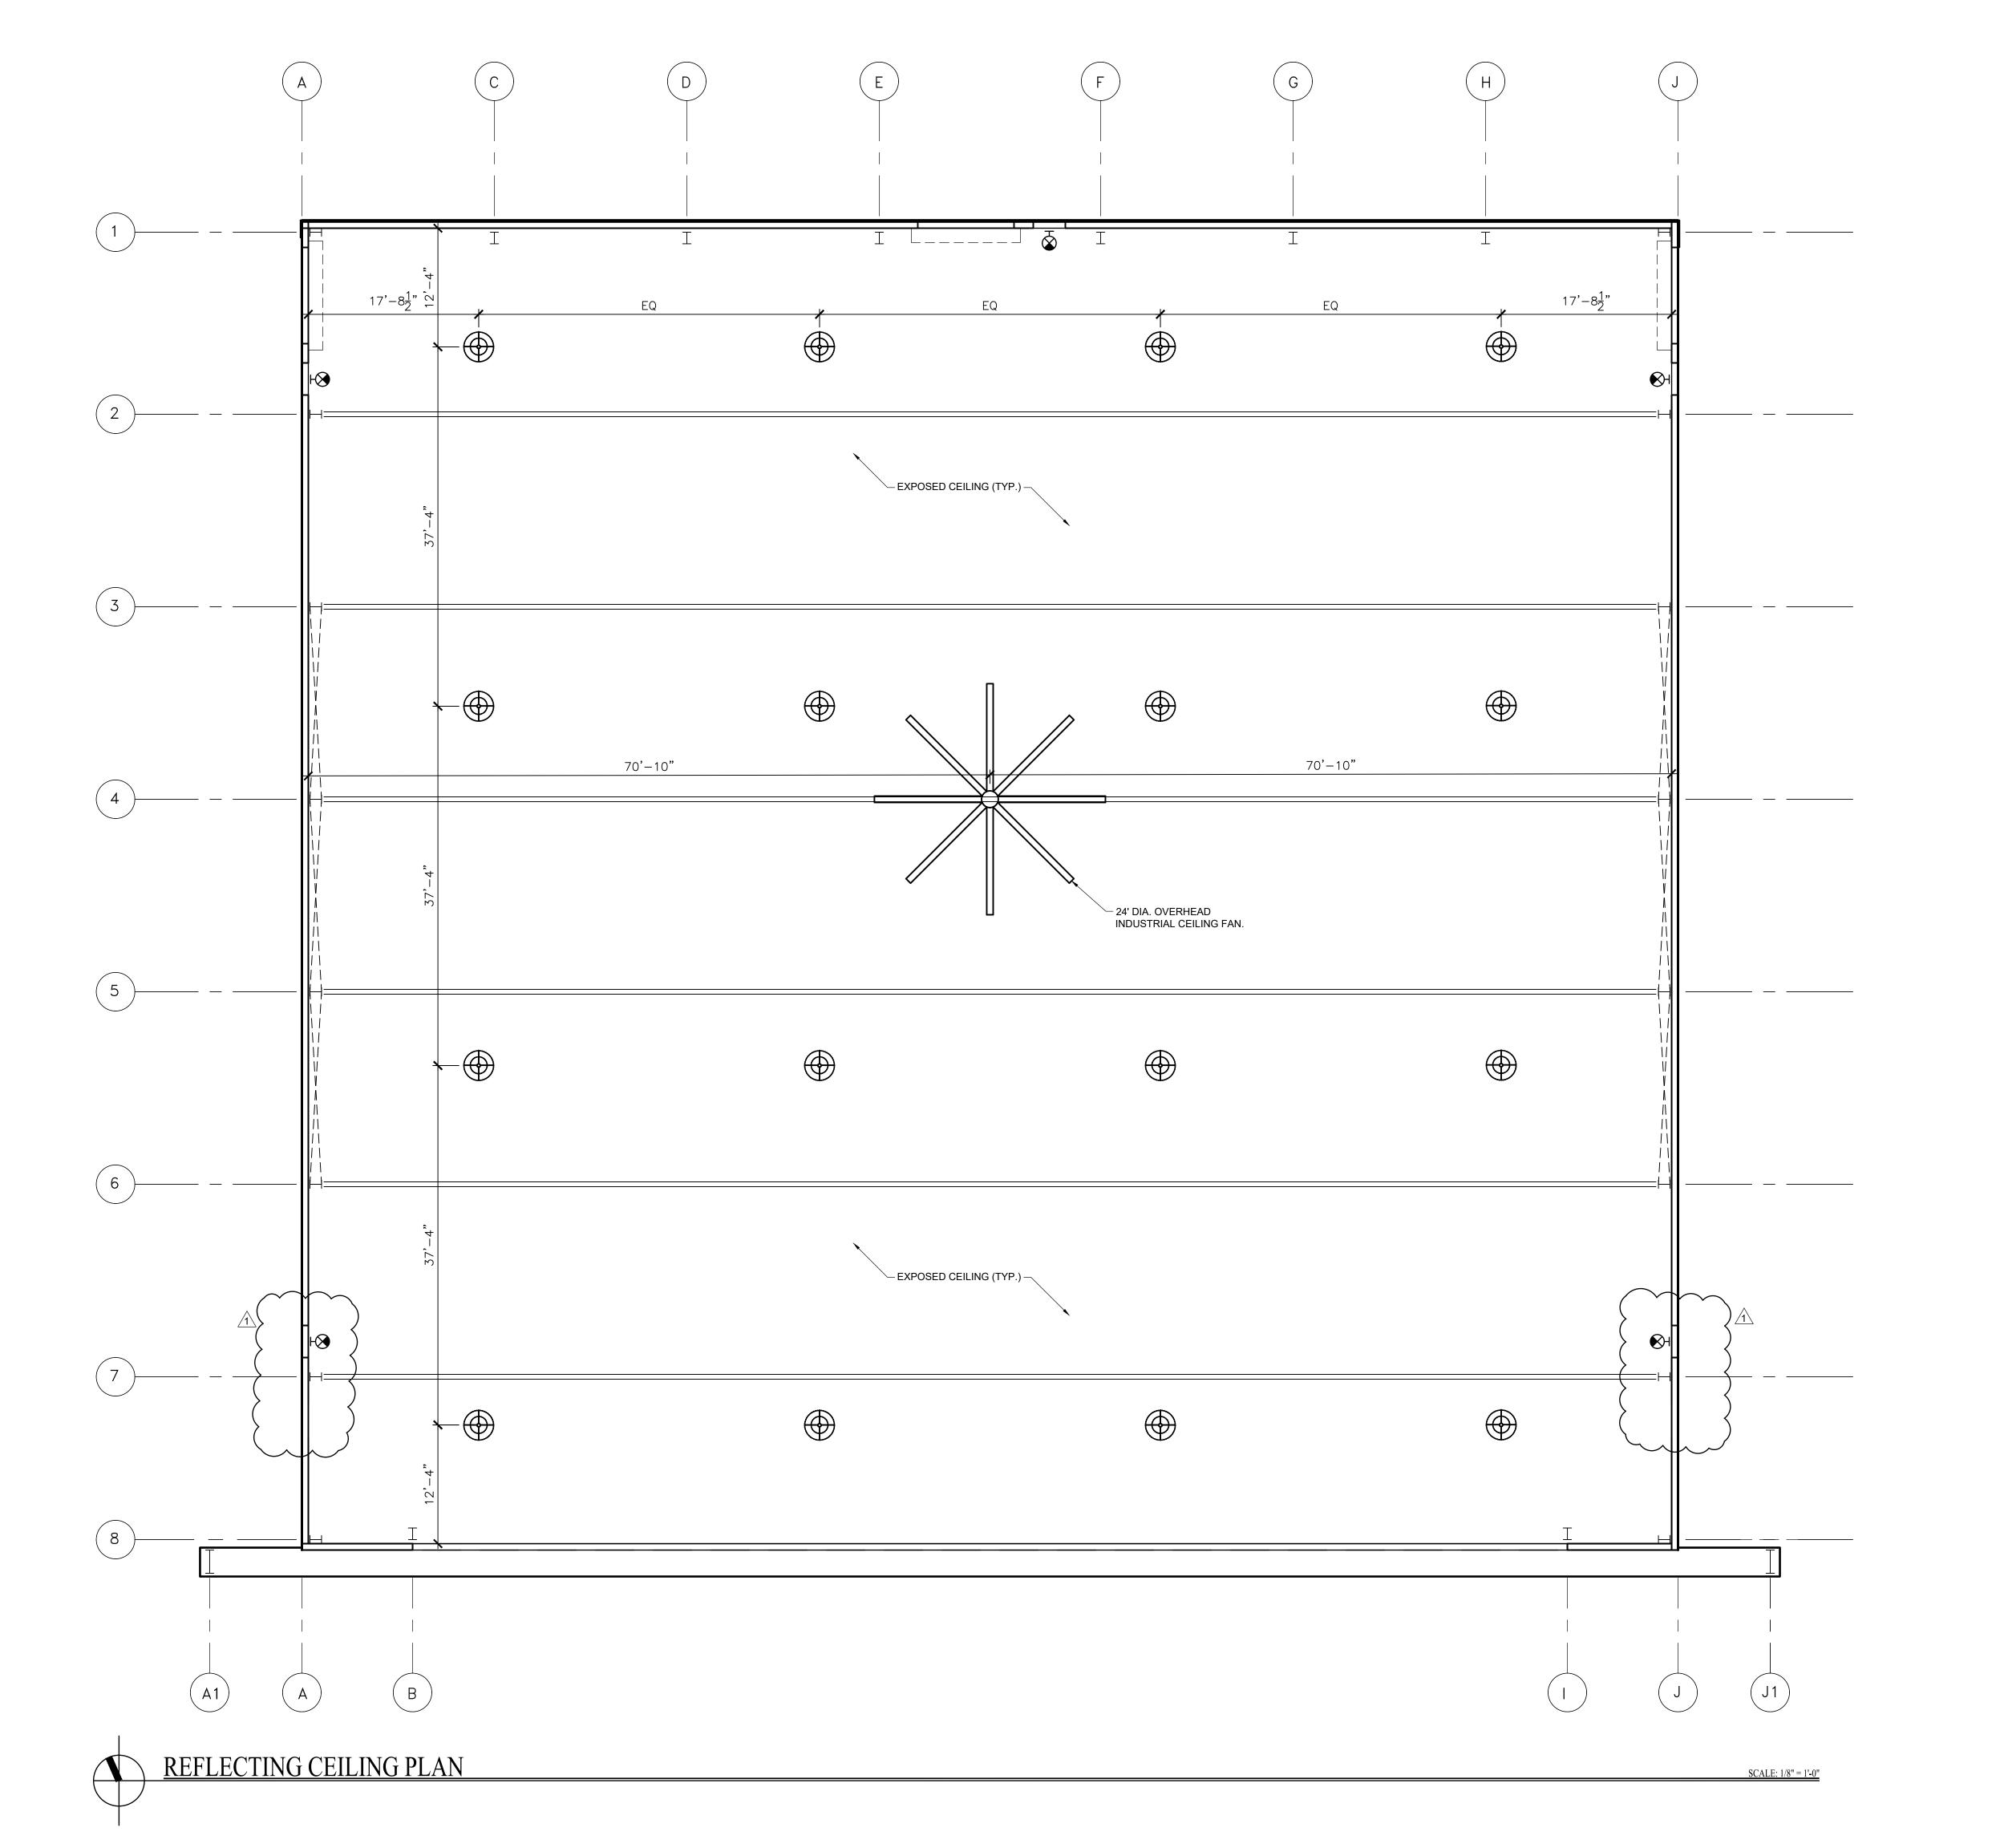
CONSULTANT:

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FIRST FLOOR PLAN

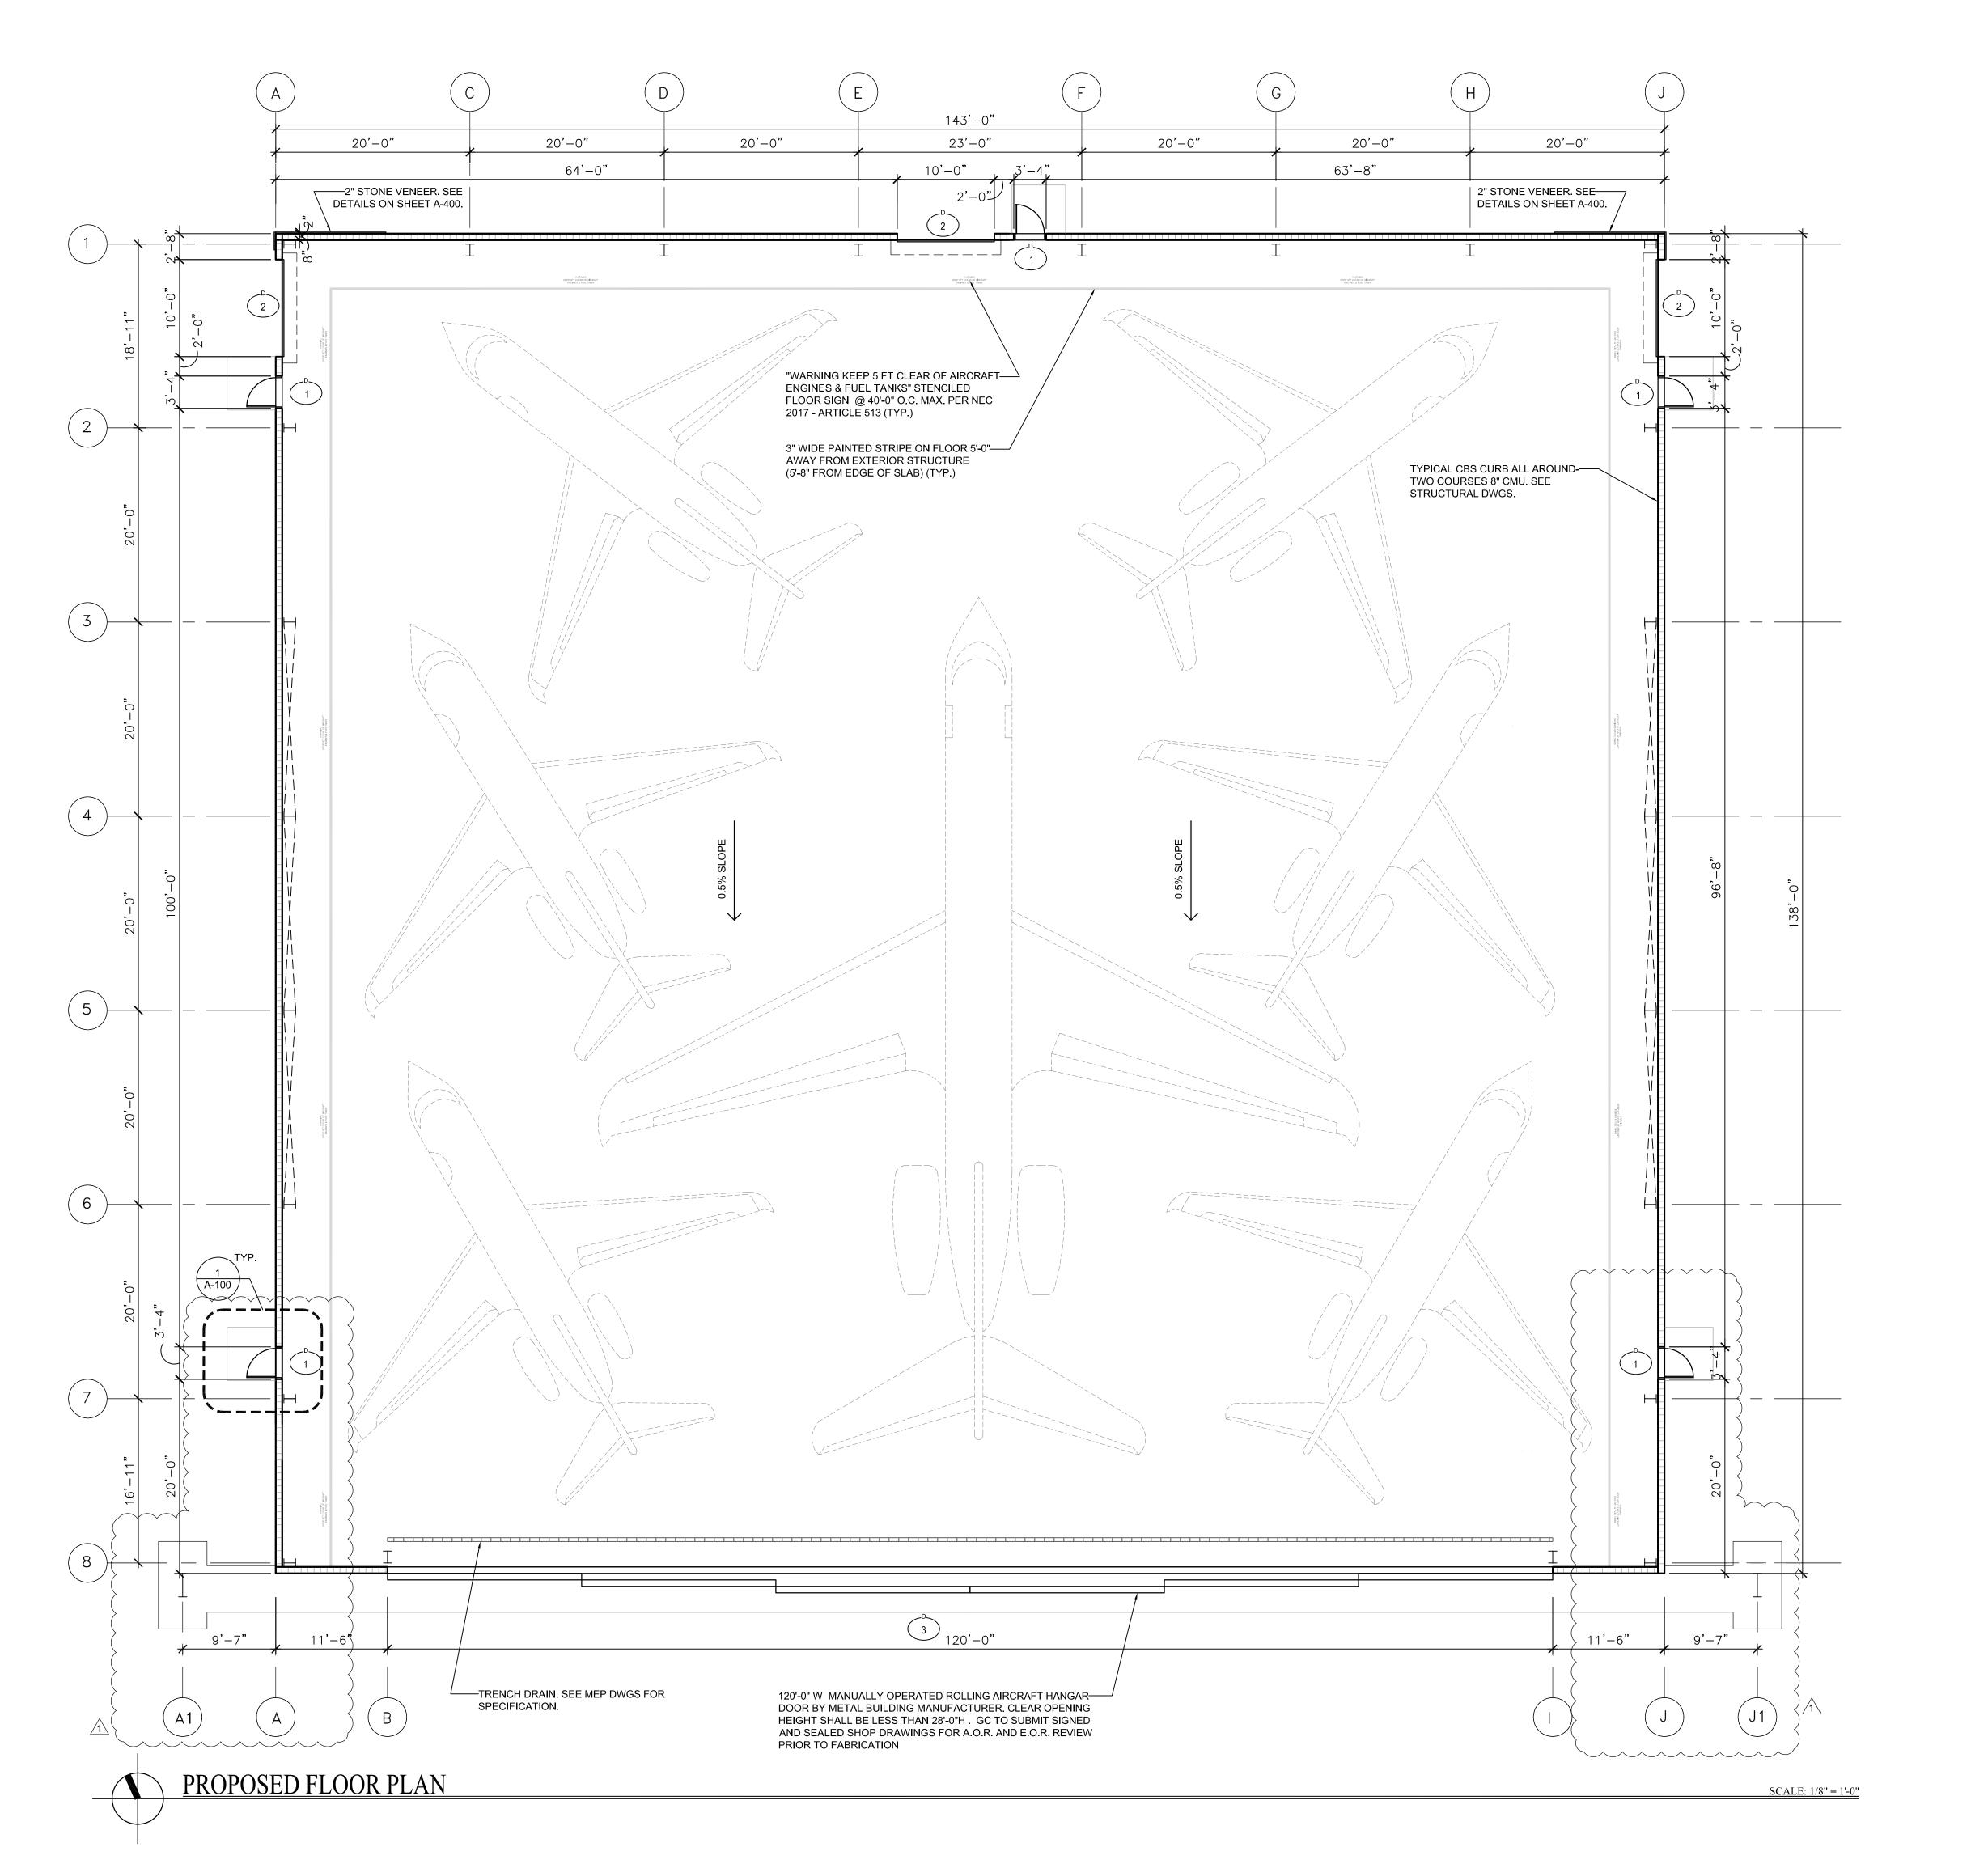SCALE AS NOTED PROJECT NO. 2247

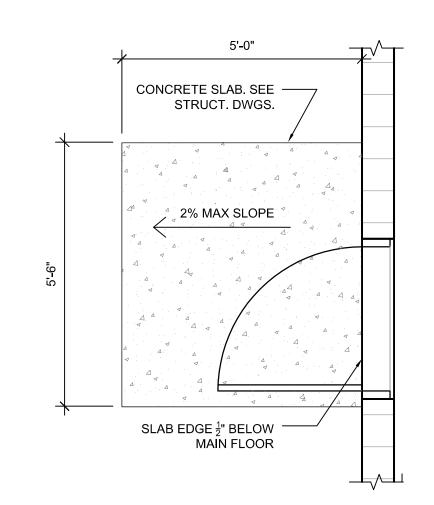



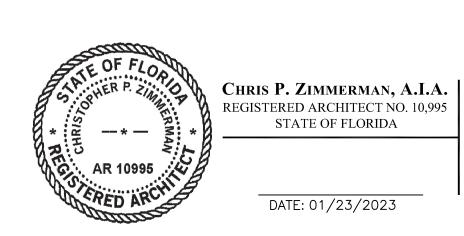

LED PENDANT MOUNT BAY LIGHT FIXTURE






EXPOSED ROOF STRUCTURE



1'-0" A.F.F. CEILING HEIGHT

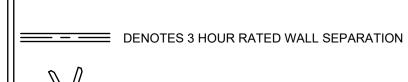



OVERHEAD INDUSTRIAL CEILING FAN

NOTES:

SEE LIGHTING PLAN FOR MANUFACTURER MODEL OF ALL LIGHT FIXTURES.

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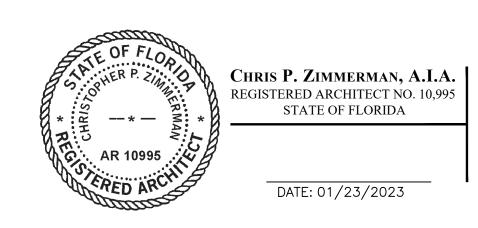
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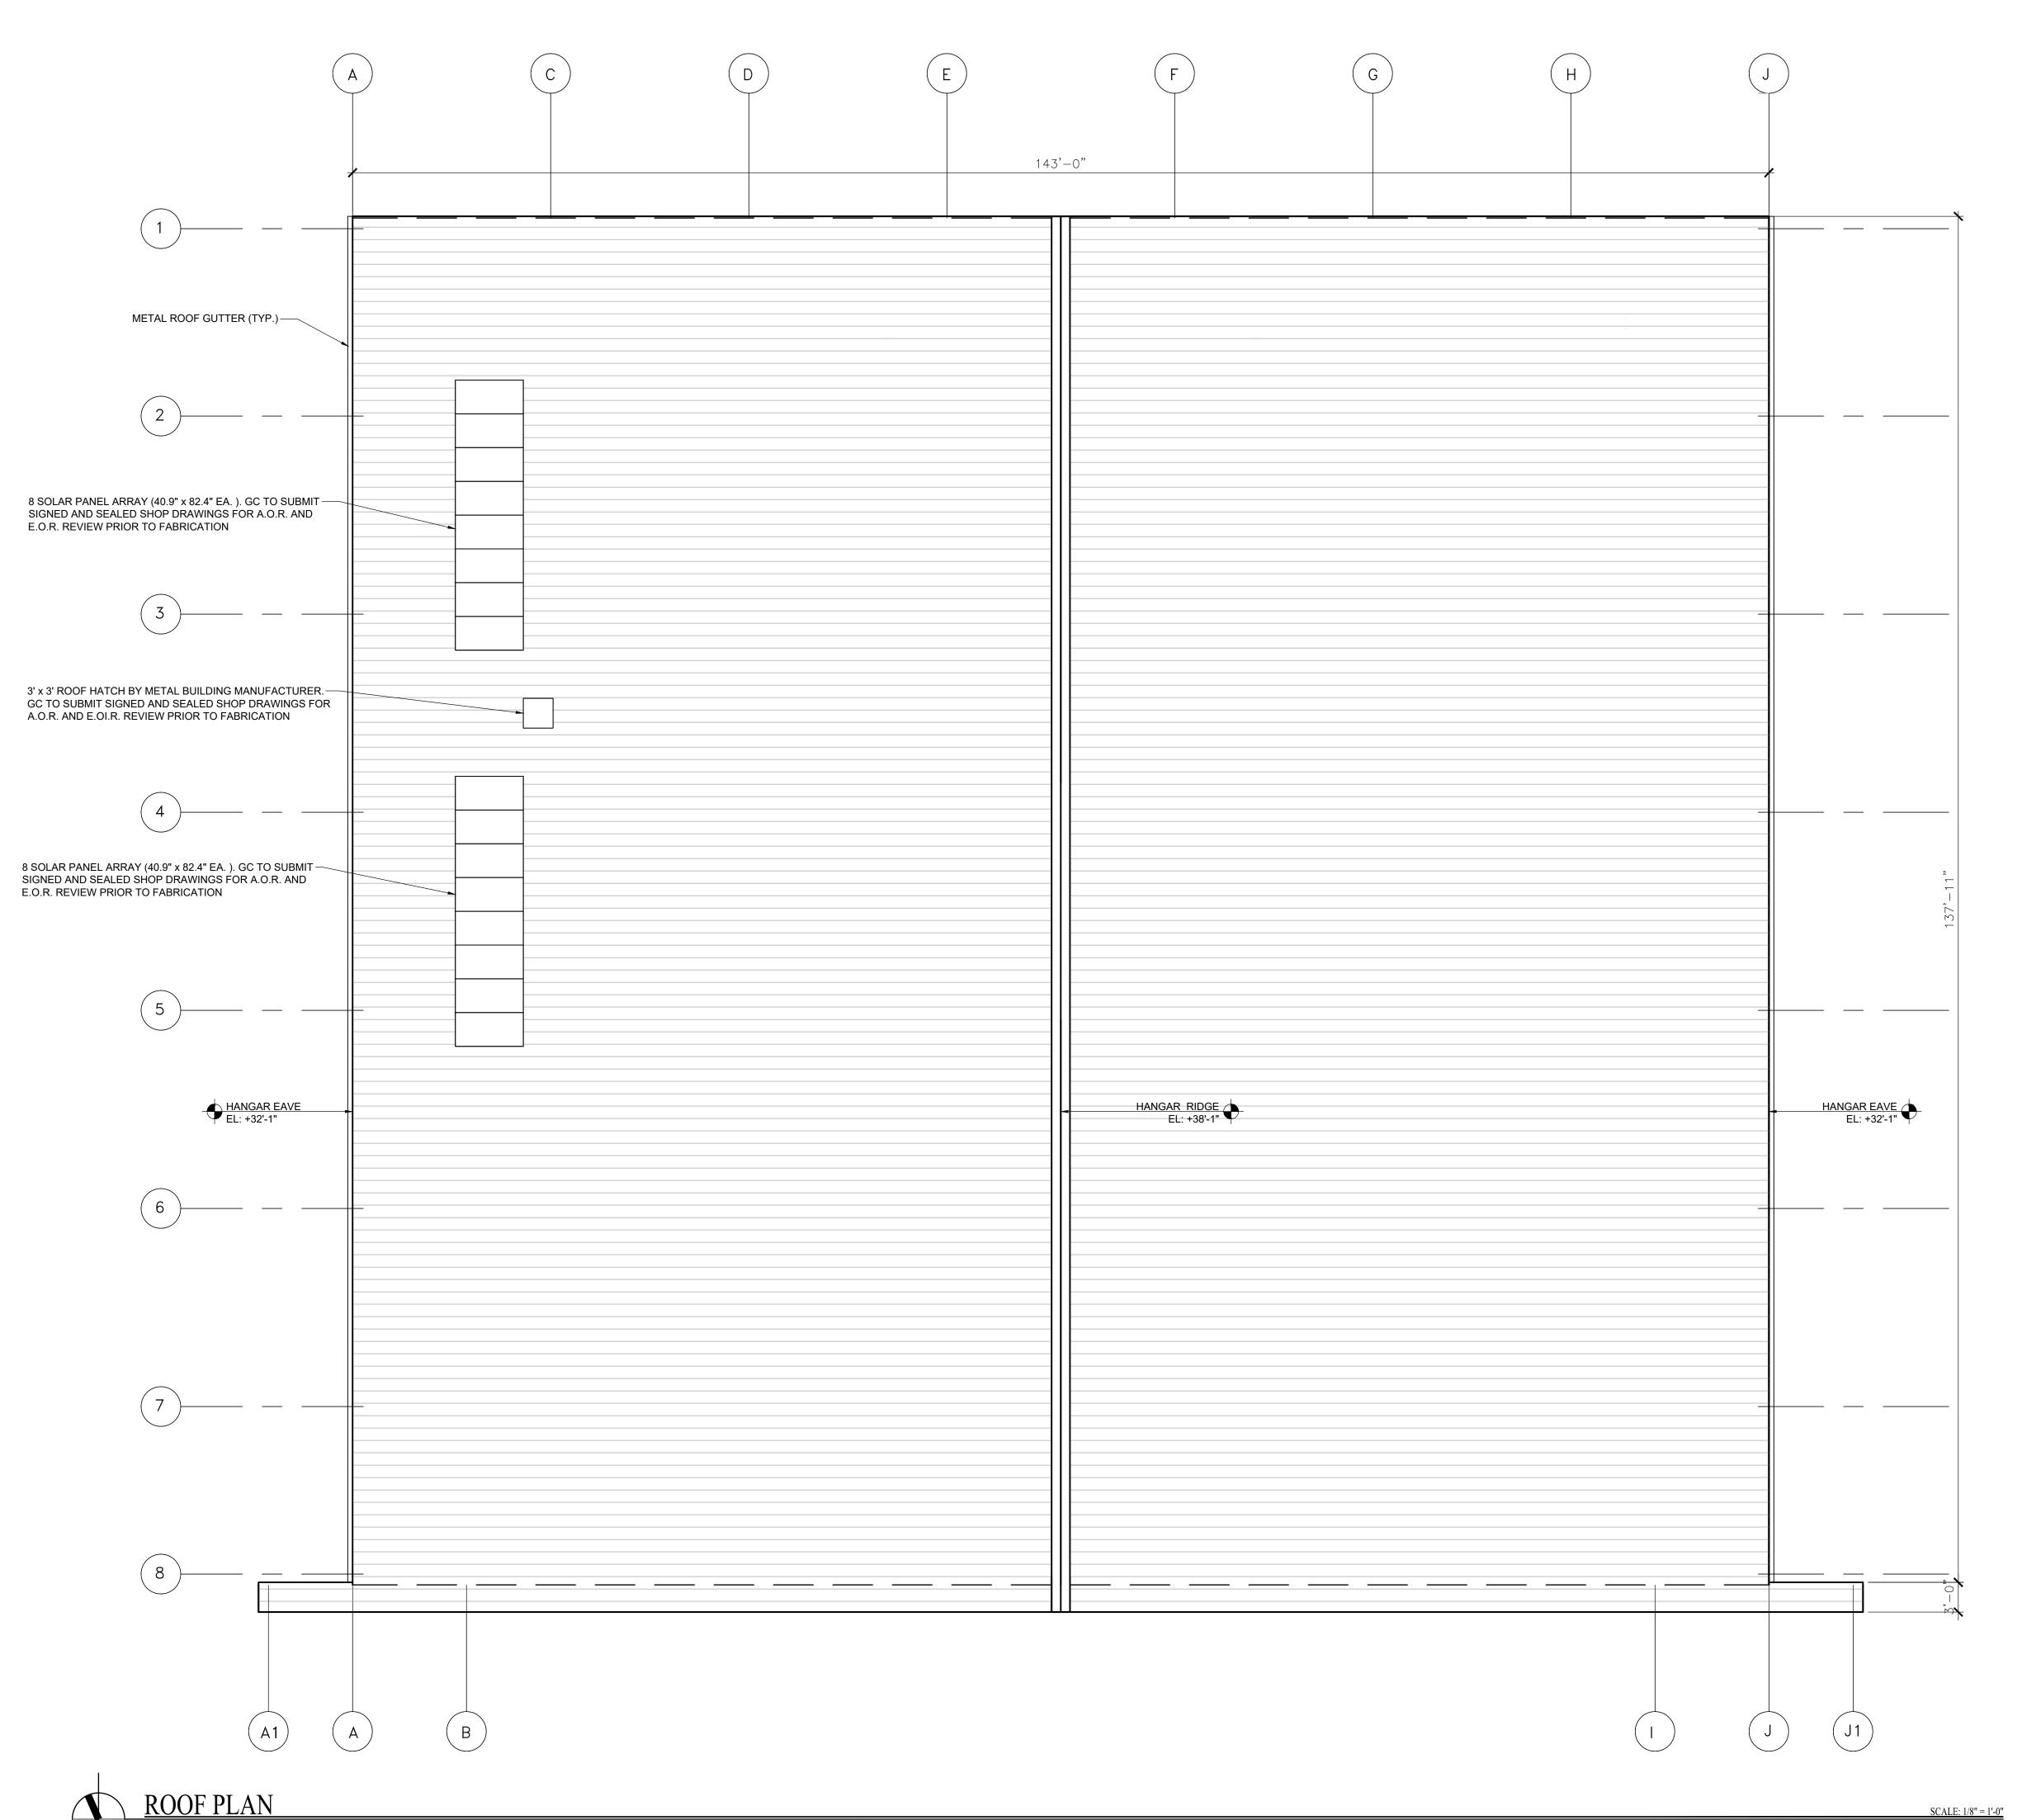
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FIRST FLOOR REFLECTED CEILING PLAN

CHECKED 01.17.23 SCALE AS NOTED
PROJECT NO. 2247
SHEET:

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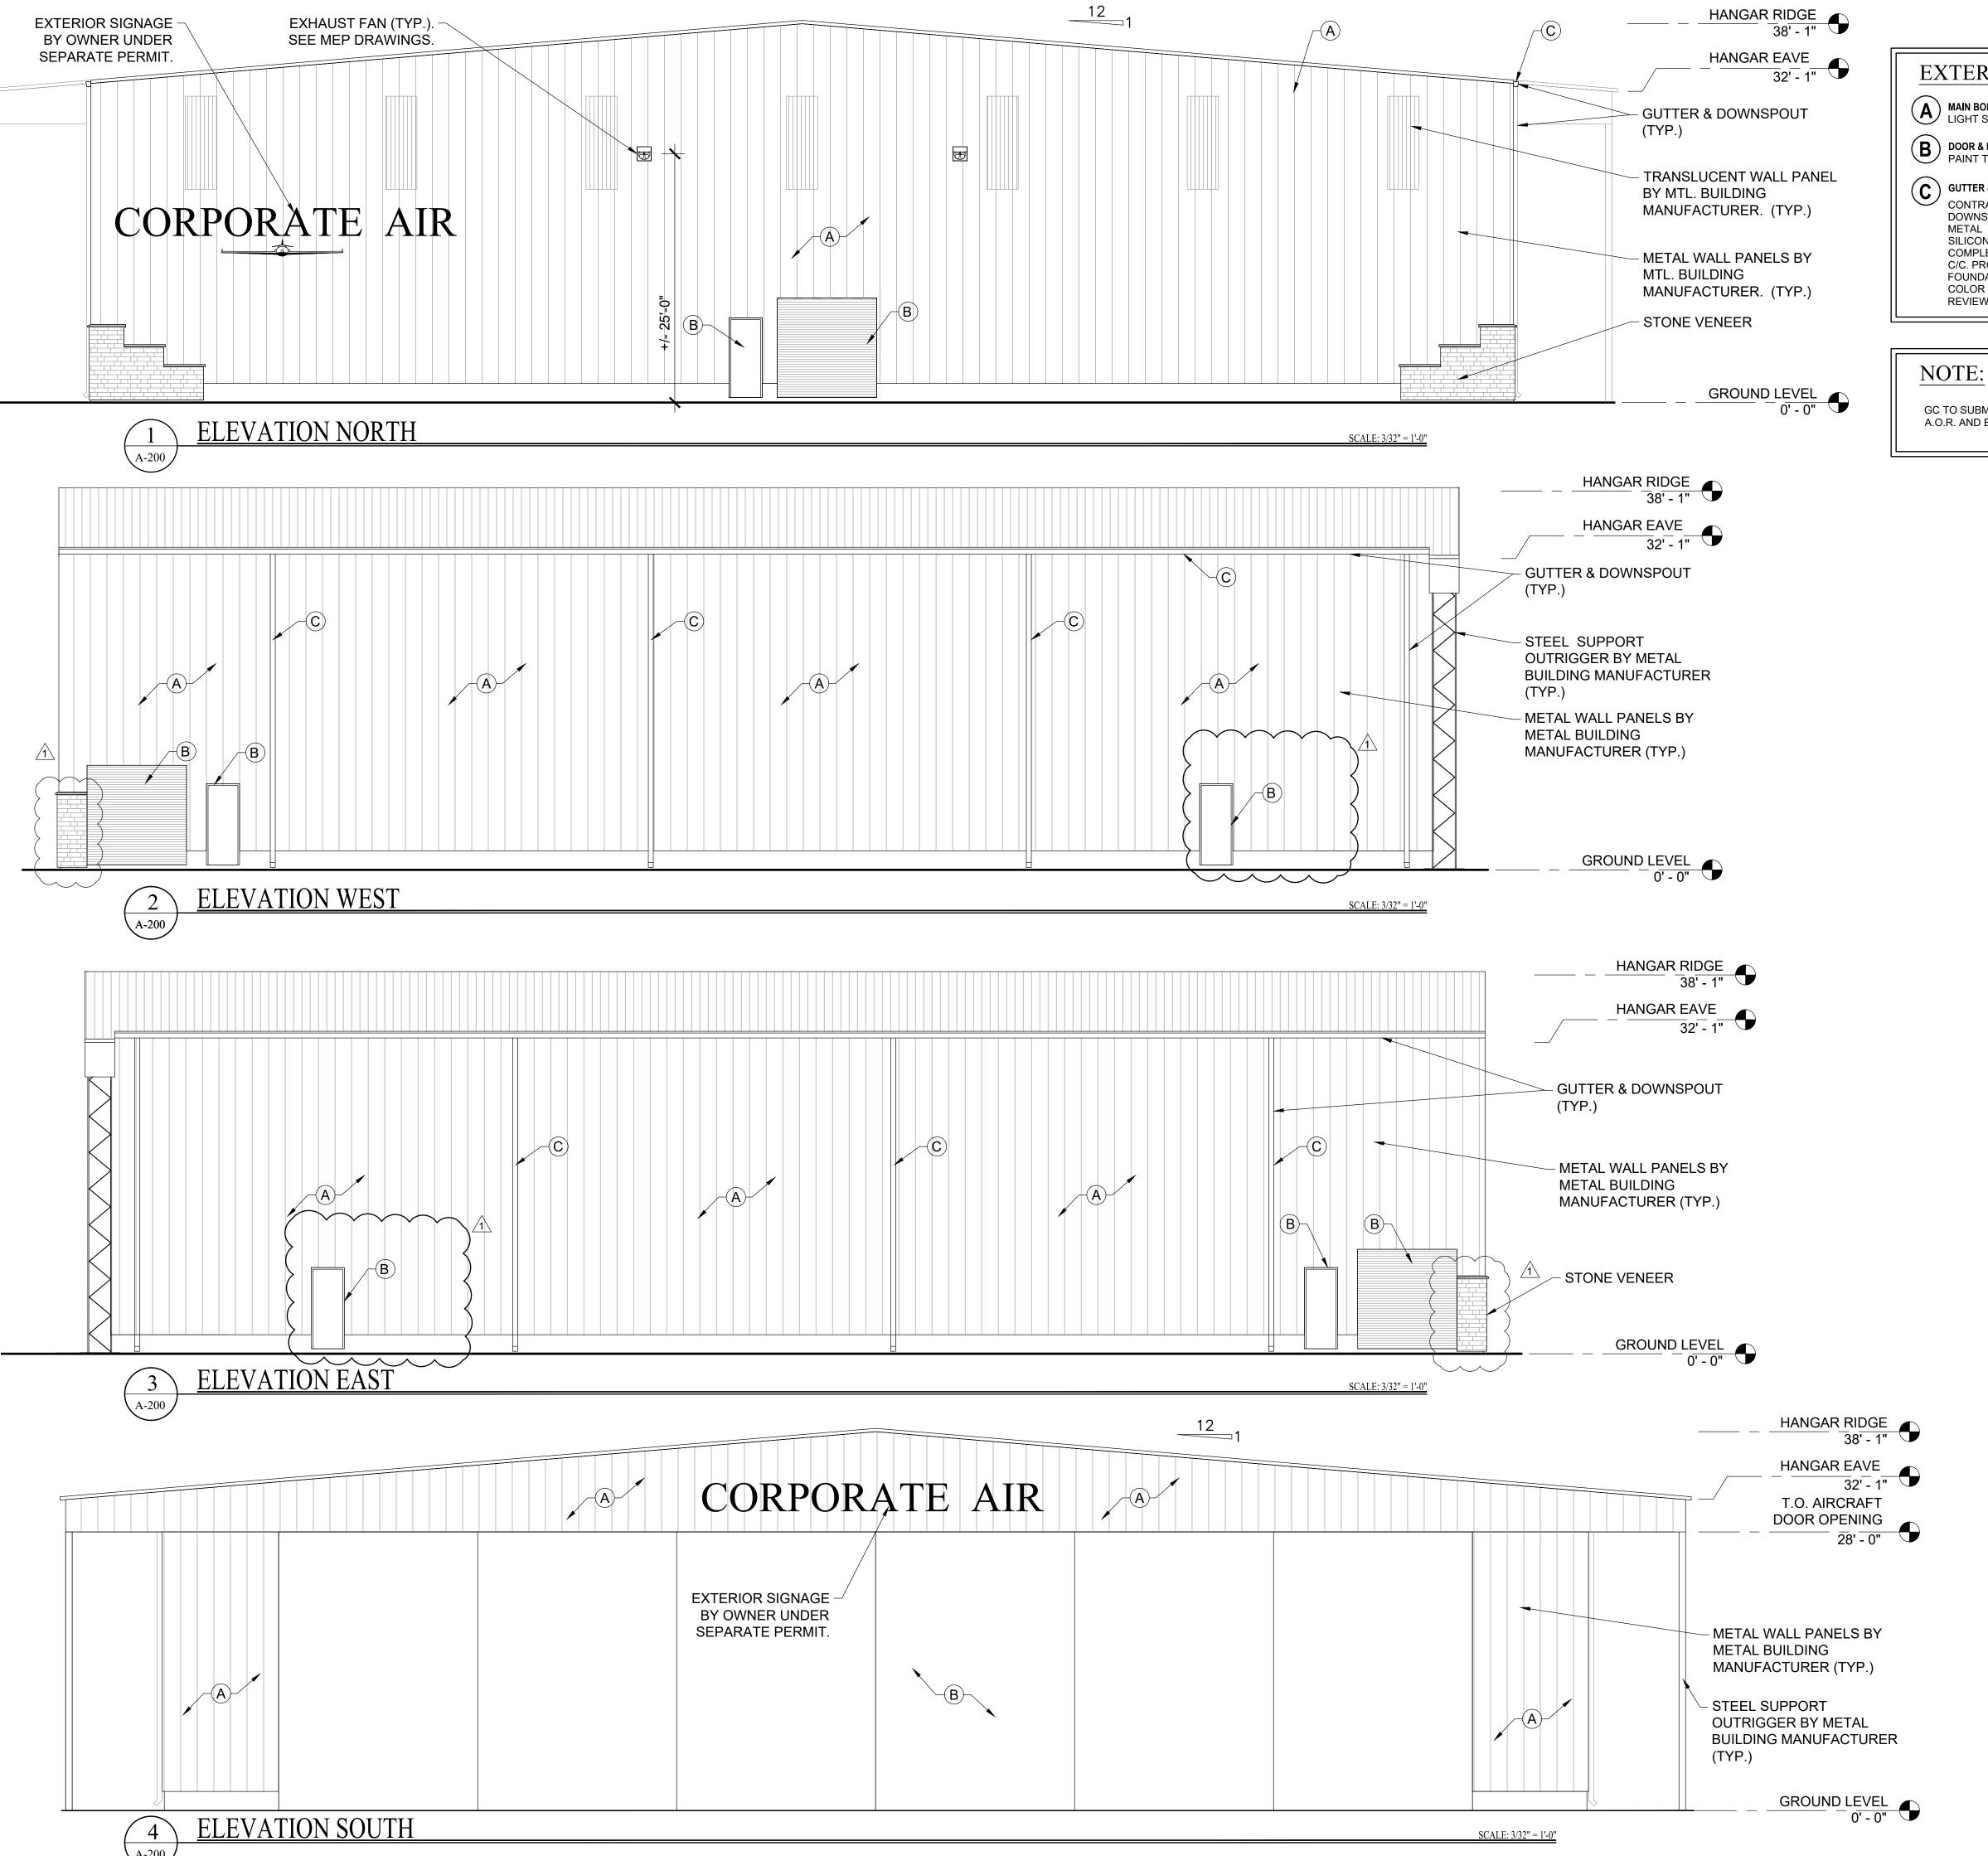
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ROOF PLAN

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CHRIS P. ZIMMERMAN, A.I.A.
REGISTERED ARCHITECT NO. 10,995
STATE OF FLORIDA

DATE: 01/23/2023



EXTERIOR BUILDING COLORS AND DECORATIVE ELEMENTS:

MAIN BODY COLOR LIGHT STONE

B DOOR & FRAME FINISH
PAINT TO MATCH ADJACENT WALL

GUTTER & DOWNSPOUT CONTRACTOR TO PROVIDE SEAMLESS GALV. METAL GUTTER AND DOWNSPOUT. SEE METAL BUILDING DRAWINGS FOR SIZING. (COLOR: SAHARA TAN) METAL GUTTER & DOWNSPOUT SHALL BE STAINLESS STEEL

SILICONE SEAL EXTERIOR OF ALL DOWNSPOUT JOINTS TO PROVIDE COMPLETE WATER TIGHT SEAL. INSTALL SUPPORT STRAPS NO MORE THAN 3'-0" C/C. PROVIDE CONCRETE SPLASH BLOCKS ORIENTED AWAY FROM THE FOUNDATION OF THE BUILDING. CONTRACTOR TO PROVIDE SHOP DRAWING & COLOR SAMPLE OF POWDER COATING PRIOR TO FABRICATION FOR ARCHITECT'S REVIEW AND APPROVAL

GC TO SUBMIT SIGNED AND SELAED ENGINEERED METAL BUILDING DRAWINGS FOR A.O.R. AND E.O.R REVIEW PRIOR TO FABRICATION

AIRCRAFT HANGAR

VERO

CONSULTANT:

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REVISION #1 02/03/23

SHERWIN WILLIAMS OR APPROVED **EQUAL PAINT SPECIFICATION:**

1.1 EXTERIOR PAINT SYSTEMS A. CONCRETE (CEMENTITIOUS SIDING, FLEXBOARD, TRANSITE BOARD, SHINGLES (NON-ROOF), COMMON

MASONRY PRIMER SEALER, LX02W50 (5.3-8.0 MILS WET, 2.1-3.2 MILS DRY). 2) 2ND COAT: S-W DURATION EXTERIOR

LATEX SATIN, K33 SERIES. 3) 3RD COAT:S-W DURATION EXTERIOR LATEX SATIN, K33 SERIES (5.3-6.4 MILS WET, 2.1-2.6

B. WOOD: SIDING, TRIM, SHUTTERS, SASHES, HARDBOARD-BARE/PRIMED.

(4.0 MILS WET, 1.4 MILS DRY). 2) 2ND COAT: S-W PRO INDUSTRIAL ACRYLIC SEMI-GLOSS,

3) 3RD COAT: S-W PRO INDUSTRIAL ACRYLIC SEMI-GLOSS,

C. METAL: ALUMINUM, GALVANIZED.

1. ALKYD SYSTEMS (WATER BASED):

PRO-CRYL UNIVERSAL PRIMER, B66-1310 SERIES (5.0 MILS WET, 2.0

2) 2ND COAT: S-W PRO INDUSTRIAL ACRYLIC SEMI-GLOSS,

B66-650 (2.0-4.0 MILS DRY PER

BRICK, STUCCO, TILT-UP, PRECAST, AND POURED-IN-PLACE CEMENT).

1. LATEX SYSTEMS: A. FLAT FINISH:

1) 1ST COAT: S-W LOXON CONCRETE AND

MILS DRY PER COAT).


1. LATEX SYSTEMS: A. SEMI-GLOSS FINISH: 1) 1ST COAT: S-W EXTERIOR LATEX WOOD PRIMER, B42W8041

B66-650 (2.0-4.0 MILS DRY PER COAT).

> A. SEMI-GLOSS FINISH:
>
> 1) 1ST COAT: S-W PRO INDUSTRIAL MILS DRY).

> > 3) 3RD COAT: S-W PRO INDUSTRIAL ACRYLIC SEMI-GLOSS,

CONTACT: GLENN REMLER ARCHITECTURAL ACCOUNT EXECUTIVE SHERWIN WILLIAMS PHONE:954-547-1217

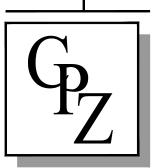

ARCHITECTS

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EXTERIOR ELEVATIONS


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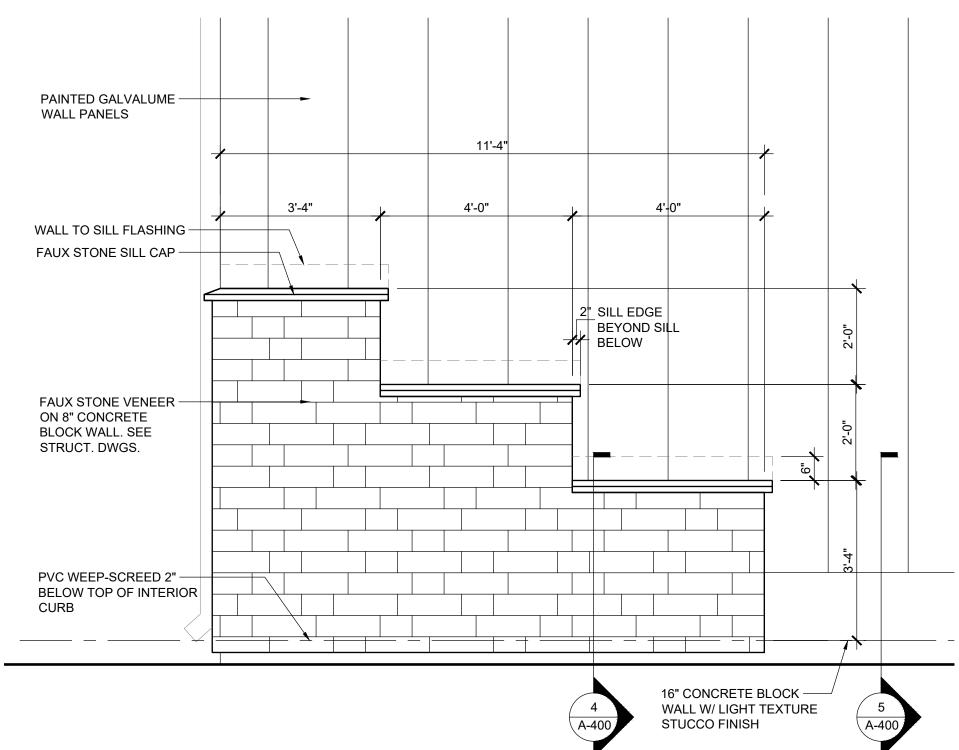
CHRIS P. ZIMMERMAN, A.I.A. REGISTERED ARCHITECT NO. 10,995 STATE OF FLORIDA

A-200


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SCALE: 1" = 1'-0"

STONE VENEER SECTION DETAIL

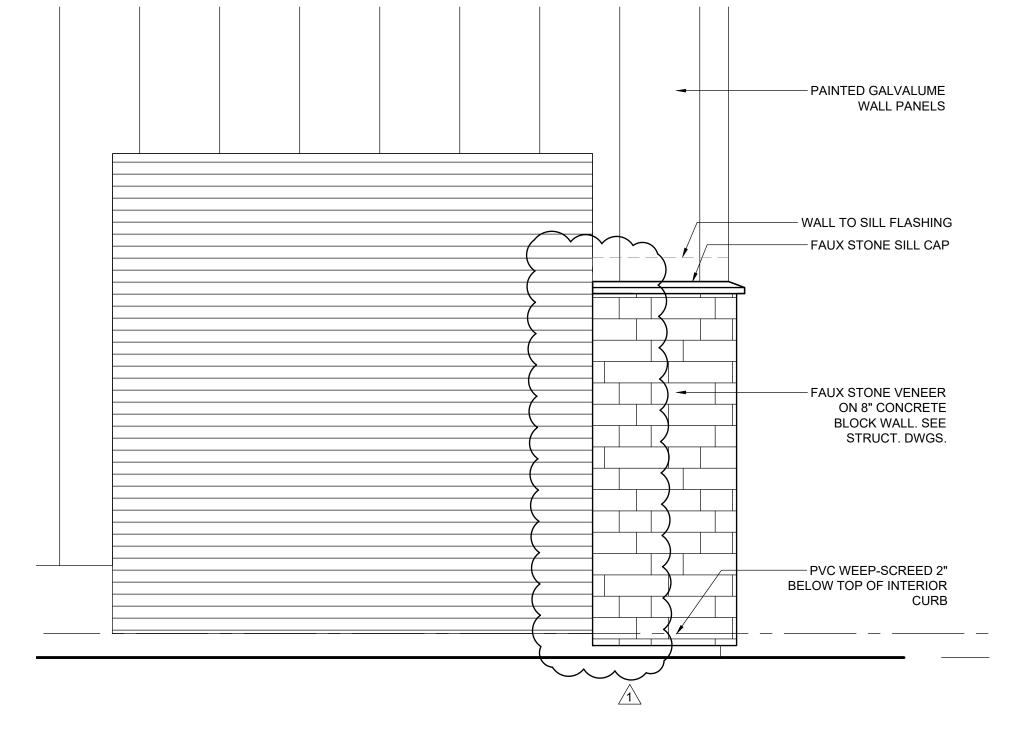

PAINTED GALVALUME WALL PANELS BY METAL BUILDING MANUFACTURER STEEL ANGLE. SEE STRUCTURAL DWGS. CONTINUOUS PROFILE MOLDED PANEL CLOSURE 24 GUAGE PAINTED GALVALUME FLASHING (COLOR TO MATCH METAL PANELS) LIGHT TEXTURE STUCCO ON 8" CONCRETE BLOCK. CONCRETE SLAB. SEE EL.: 0'-0" T.O. CURB STRUCTURAL DWGS. PVC WEEP SCREED @ 3" EL.: VARIES BELOW TOP OF CURB \triangleleft^{Δ} \triangle \triangle SEE STRUCTURAL DWGS. FOR REINFORCING. VAPOR BARRIER

STONE VENEER ELEVATION DETAIL

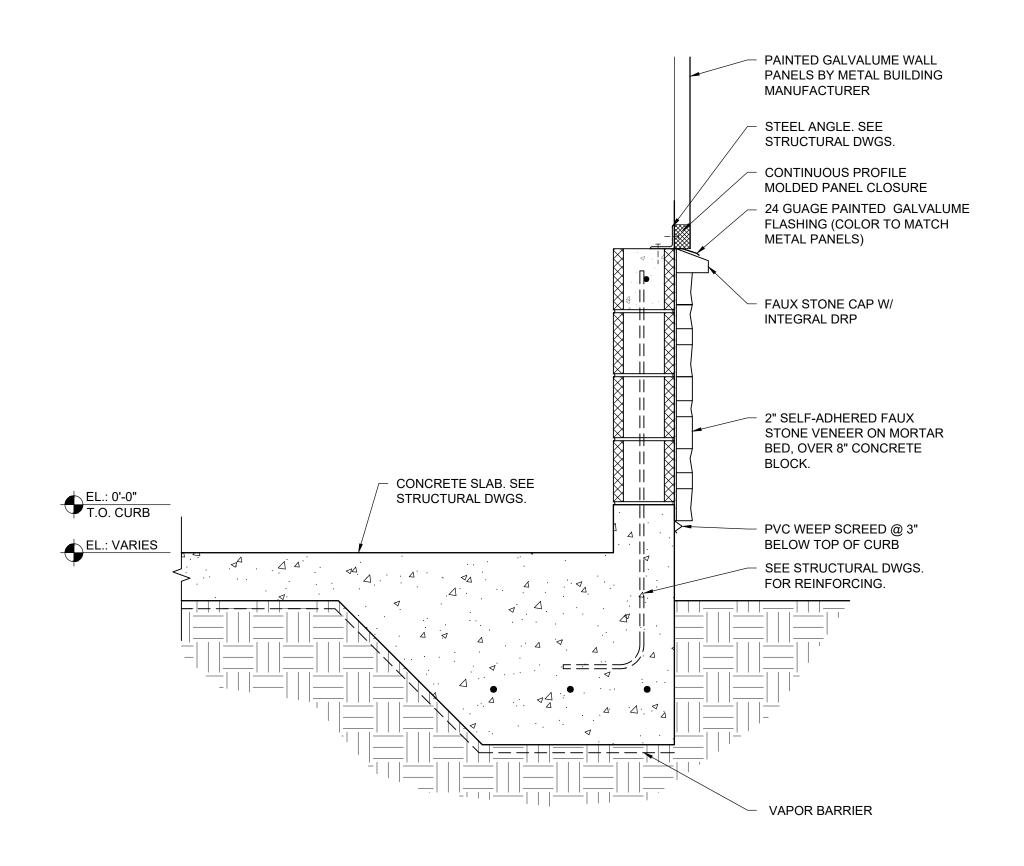STONE VENEER ELEVATION DETAIL

ARCHITECTS

NO. REVISION DATE

PERMIT SET 01/17/23

REVISION #1 02/03/23

CONSULTANT:

AIRCRAFT HANGAR

VERO

DRAWING TITLE:

DETAILS

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SHEET:		

DATE: 01/23/2023

CHRIS P. ZIMMERMAN, A.I.A. REGISTERED ARCHITECT NO. 10,995 STATE OF FLORIDA

	DOOR SCHEDULE												
NUMBER	LOCATION	TYPE	MATERIAL	W	SIZE H	THICKNESS	FINISH	UNDER CUT	RATING	HARDWARE	FRAME MATERIAL	FRAME FINISH	REMARKS
1	HANGAR	FF	НМ	3'-0"	8'-0"	1-3/4"	PAINTED			HW-1	НМ	PAINTED	IMPACT RATED. FL# 22211.3
2	HANGAR	ROLL-UP	ALUM	10'-0"	10'-0"	1-3/4"	ANODIZED			HW-2	ALUM	ANODIZED	IMPACT RATED. FL# 21450.5
3	HANGAR	ROLLING AIRCRAFT DOOR	STEEL	120'-0"	28'-0" CLEAR	10"	PAINTED			PER MTL. BLDG SHOP DRAWING	STEEL	PAINTED	MULTI-PANEL ENGINEERED AIRCRAFT DOOR BY METAL BUILDING MANUFACTURER. CLEAR OPENING HEIGHT SHALL NOT EXCEED 28'-0"

HARDWARE SCHEDULE


HW-1 - EXIT DOOR
PER FL# BUTT HINGE
1 EA LOCKSET
1 EA RIM PANIC 9500 SERIES
1 EA WEATHERSTRIPPING
1 EA THRESHOLD

HW-2 - OVERHEAD DOOR
1 EA SLIDING BOLTS
1 EA THRESHOLD
1 EA WEATHERSTRIPPING


HARDWARE NOTES

CONTRACTOR SHALL COORDINATE ALL HARDWARE REQUIREMENTS WITH THE OWNER PRIOR TO ORDERING.
 ALL HINGES SHALL BE STAINLESS STEEL IN ACCORDANCE WITH PRODUCT NOA OR FL#

DOOR	ABBREVIATIONS		
ALUM STL UC LV HG MTL PT SCW-PT C.W. T.C. NG FG FL HSCD	ALUMINUM STEEL UNDERCUT LOUVER HALF GLASS METAL PAINTED SOLID CORE WOOD, PAINTED CLEAR WIRE TEMPERED, CLEAR NARROW GLASS FULL GLASS FULLY LOUVERED HIGH SPEED COILING DOOR IMPACT GLASS	VP w/ TYP FF WD-PH WDP SF SF/LT HM LT WD SG OHD SRD WDS	VIEW PANEL WITH TYPICAL FULL FLUSH WOOD PREHUNG WOOD, PAINTED STORE FRONT STORE-FRONT/SIDE-LITE HOLLOW METAL SIDE-LITE WOOD-FACTORY FINISH SLIDING GLASS DOOR OVERHEAD DOOR STEEL ROLLING DOOR WOOD STAINED FINISH

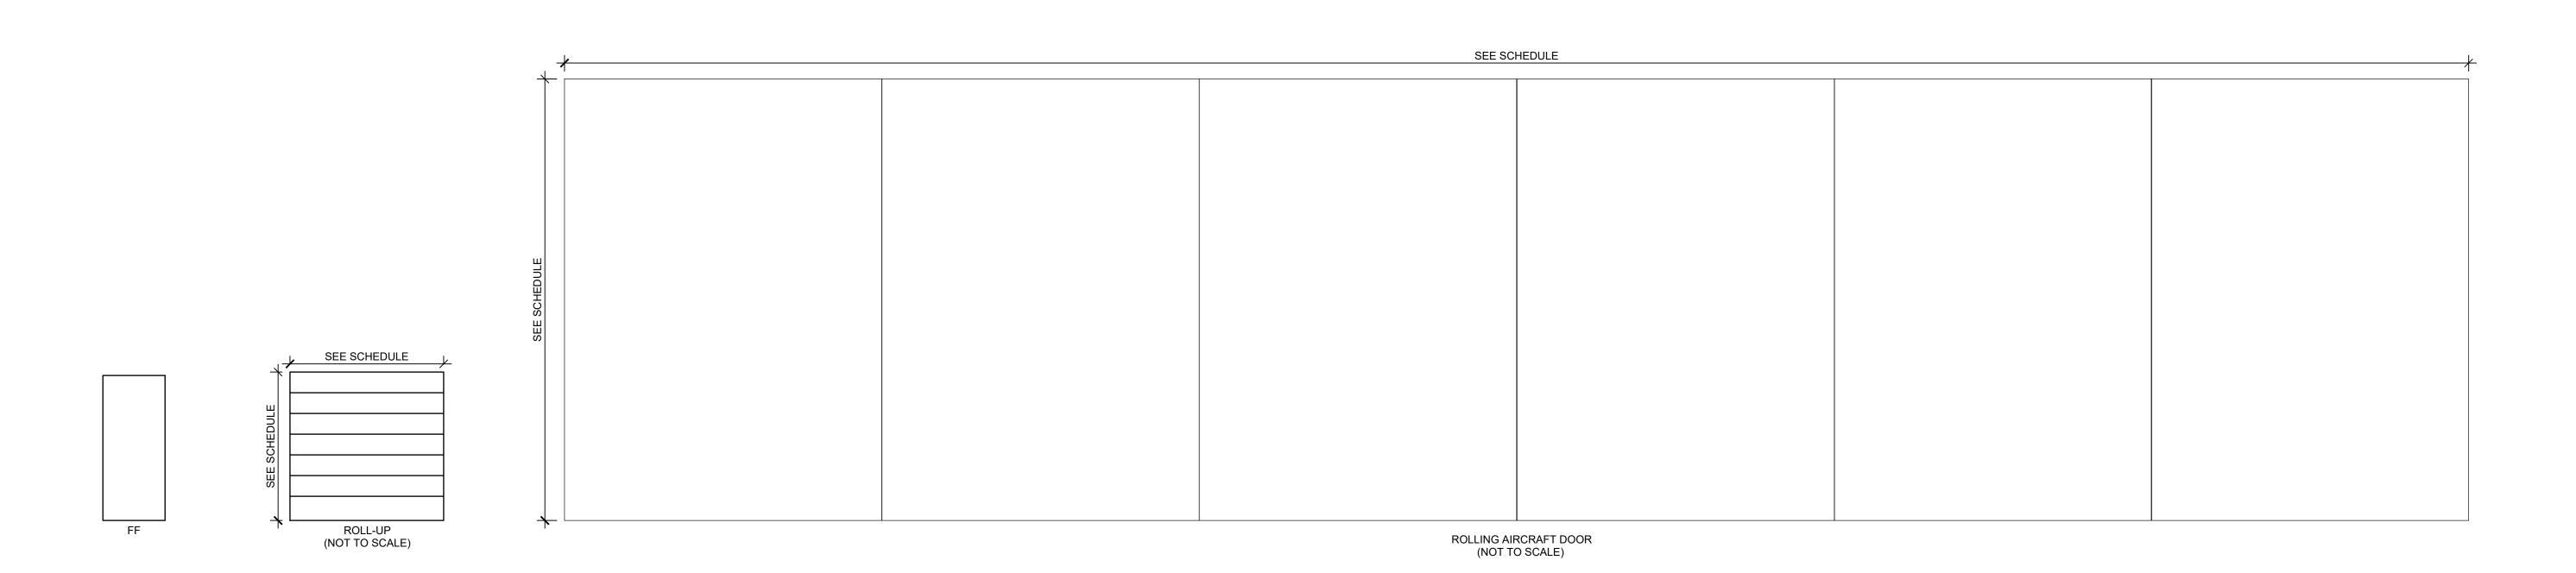

DOOR TYPES

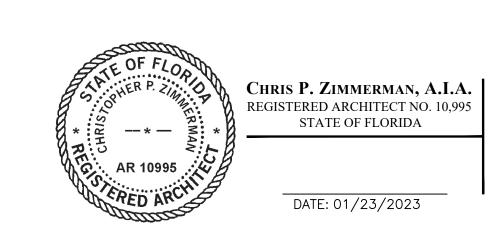

PERMIT SET 01/17/23

NO. REVISION DATE



DRAWING TITLE:

DOOR SCHEDULE

CHECKED 01.17.23 SCALE AS NOTED
PROJECT NO. 2247
SHEET: