COMMERCIAL PROJECT DATA SUMMARY

BRIEF PROJECT DESCRIPTION:
NEW TWO-STORY CLINIC FOR BREVARD HEALTH ALLIANCE.

APPLICABLE CODES

7TH EDITION FLORIDA BUILDING CODE (2020) PLUMBING 7TH EDITION FLORIDA BUILDING CODE (2020) FUEL GAS 7TH EDITION FLORIDA BUILDING CODE (2020) ENERGY CONSERVATION 7TH EDITION FLORIDA BUILDING CODE (2020) MECHANICAL 7TH EDITION FLORIDA BUILDING CODE (2020) EXISTING BUILDING 7TH EDITION FLORIDA FIRE PREVENTION CODE (2020) 2017 NFP 70, NATIONAL ELECTRIC CODE

BUILDING TYPE

FLORIDA STATUES.

CONSTRUCTION TYPE PER FBC 503: V-B SPRINKLERED

BREVARD HEALTH ALLIANCE

OCCUPANCY GROUP: GROUP "B" BUSINESS (FBC SECTION 304.1; FFPC CHAPTER 38)

CLASSIFICATION OF HAZARD (FFPC 101: 6.2.2) LOW HAZARD CONTENT (FFPC 101:6.2.2.2)

BUILDING SQUARE FOOTAGE FIRST FLOOR: 4,538 SQ. FT. SECOND FLOOR: 4,538 SQ. FT.

STORIES: 2-STORY

HEIGHT: 35'-6" (AVERAGE ROOF HEIGHT)

BUILDING OCCUPANCY CLASSIFICATION MIX USE - NONSEPARATED (FBC 508.3)		AREA ALLOWED PER FLOOR	AREA PROVIDED PER FLOOR	ALLOWABLE BUILDING HEIGHT (FBC TABLE 504.3)	BUILDING HEIGHT	ALLOWABLE STORIES (FBC TABLE 504.4)	PROVIDE STORIES
B BUSINESS		9,000 SF		40'-0"	35'-6"	2	2
	FIRST FLOOR		4,538 SF				

4,538 SF

OCCUPANCY LOAD DATA

PER 2020 FLORIDA BUILDING CODE CHAPTER IO TABLE 1004.1.1; FFPC 101 TABLE 7.3.1.2.

SECOND FLOOR

USE OF SPACE BUSINESS 7227.85 SQ. FT. I50 GROSS 48.19 STORAGE 767.14 SQ. FT. 300 GROSS 2.56 682.96 SQ. FT. 45.53 WAITING AREA **I5 GROSS**

TOTAL OCCUPANTS: 96.28 = 97 OCCUPANTS

MEANS OF EGRESS DATA

PER 7TH EDITION 2020 FLORIDA BUILDING CODE CHAPTER 10 TABLE 1006.2.1 / TABLE 1006.3.2 / 1020.4 / TABLE 1017.2 AND 7TH EDITION 2020 FLORIDA FIRE PREVENTION CODE- LIFE SAFETY 101-CHAPTER 12 AND CHAPTER 36, 38 AND 42.

TWO EXITS REQUIRED: 3 EXITS PROVIDED # OF EXITS:

50' (SPRINKLERED) DEAD END CORRIDOR (MAX.): **COMMON PATH OF TRAVEL:** 100' (UNSPRINKLERED) MAXIMUM TRAVEL DISTANCE: 300' (SPRINKLERED) CORRIDOR WIDTH (97 OCCUPANTS @0.2= 19.4": 44" MINIMUM

STAIR WIDTH (47 OCCUPANTS ON THE SECOND FLOOR;

24 PER STAIR @ 0.3 = 7.2"): 36" MINIMUM

FIRE PROTECTION

FBC-B TABLE 601 FIRE-RESISTANCE RATING REQUIREMENTS FOR BUILDING ELEMENTS: **BUILDING ELEMENTS** TYPE V-B

PRIMARY STRUCTURAL FRAME 0-RATING BEARING WALL-EXTERIOR 0-RATING BEARING WALL-INTERIOR 0-RATING SEE TABLE 602 NON-BEARING WALLS & PARTITIONS-EXTERIOR NON-BEARING WALLS & PARTITIONS-INTERIOR FLOOR CONSTRUCTION & ASSOCIATED SECONDARY MEMBERS 0-RATING ROOF CONSTRICTION & ASSOCIATED SECONDARY MEMBERS 0-RATING

FBC-B TABLE 602 FIRE-RESISTANCE RATING FOR EXTERIOR WALLS BASED ON FIRE SEPARATION DISTANCE:

FIRE SEPARATION DISTANCE CONSTRUCTION TYPE OCCUPANCY B, M, & S-I

X<u>></u>30 ALL TYPES 0-RATING

INTERIOR EXIT STAIRWAY (FBC-B:1023.1):

FIRE RESISTANCE RATING (FBC-B: 1023.2): I-HOUR RATING WHEN CONNECTING LESS THAN FOUR-STORIES.

ENCLOSURES MUST BE CONSTRUCTED AS A FIRE BARRIER PER FBC-B, SECTION 707.

ELEVATOR, DUMBWAITER AND OTHER HOISTWAY ENCLOSURES (FBC-B: 3002.1): FIRE RESISTANCE RATING (FBC-B: 713.4): I-HOUR RATING WHEN CONNECTING LESS THAN FOUR-STORIES. ENCLOSURES MUST BE CONSTRUCTED AS A FIRE BARRIER PER FBC-B, SECTION 707.

FLOOR AND ROOF ASSEMBLIES (FBC-B 711):

NONFIRE-RESISTANCE-RATED FLOOR AND ROOF ASSEMBLIES SHALL COMPLY WITH SECTION 711.3 MATERIALS (FBC-B 711.3.1): ASSEMBLIES SHALL BE OF MATERIALS PERMITTED BY THE BUILDING TYPE OF CONSTRUCTION.

BREVARD HEALTH ALLIANCE

SILVER PALMS CLINIC

17 SILVER PALM AVE, MELBOURNE, FL 32901



ARCHITECT:



STRUCTURAL ENGINEER:

MK STRUCTURAL ENGINEERING 587 WEST EAU GALLIE BLVD SUITE 201 P: 321.600.0672 OR 321.574.2702 www.mkstructural.com

ELECTRICAL ENGINEER:



540 HIBISCUS BOULEVARD MERRITT ISLAND, FL 32952 MP-PILOENG@CFL.RR.COM 321 427 3644

MECHANICAL / PLUMBING ENGINEER:



Engineering LLC. 460 Rio Lane Indialantic, FL 32903 George@CreativeMEP.com 321-986-7586

PLUMBING FIXTURE CALS

MINIMUM PLUMBING FACILITIES PER 7TH EDITION 2020 FBC PLUMBING TABLE 403.1 DRINKING FOUNTAINS PER 7TH EDITION 2020 FBC PLUMBING SECTION 410 URINALS PER 7TH EDITION 2020 FBC PLUMBING SECTION 419

REQUIREMENTS

BUSINESS - OCCUPANTS = 97 TOILETS = I PER 25 FOR THE FIRST 50 AND I PER 50 FOR THE REMAINDER URINAL = NO MORE THAN 50% OF THE REQUIRED WATER CLOSETS LAVATORIES = I PER 40 FOR THE FIRST 80 AND I PER 80 FOR THE REMAINDEF WATER FOUNTAINS = I PER 100 (HI/LO) SERVICE SINK = I

	REQUIRED			PROVIDED			
	М	F	TOTAL	М	F	U	TO
WATER CLOSET:							
	2	2		2	2		
TOTAL WATER CLOSETS:			4				5
LAVATORIES:	2	2		2	2		
TOTAL LAVATORIES:		_	4		_		5
WATER FOUNTAINS:							
TOTAL WATER FOUNTAINS:							I
SERVICE SINKS:							
TOTAL SERVICE SINKS:							I

NOTE: REQUIRED PUBLIC FACILITIES SHALL BE PROVIDED WITH SIGNS THAT DESIGNATE THE SEX AS REQUIRED BY SECTION 2902.2. SIGNS SHALL BE READILY VISIBLE AND LOCATED NEAR THE ENTRANCE TO EACH TOILET FACILITY. SIGNS FOR ACCESSIBLE TOILET FACILITY SHALL COMPLY WITH SECTION III (2020 FLORIDA BUILDING CODE, BUILDING, 7TH EDITION

SYMBOLS

SECTION CUT	DRAWING ID X/X.X SHEET ID	REVISION NUMBER	\bigwedge
	#	INTERIOR CALL OUT	X
REFERENCE PLAN	SHT	WALL TYPE	─ W-#
NORTH ARROW		WINDOW	#
ELEVATION INDICATOR	+ LOCATION ELEVATION	EXTERIOR DOOR	#
SHEET KEYED NOTES	S-*	INTERIOR DOOR	#
NOTES	NOTES	AREA IDENTIFICATION	ROOM NAME
ENLARGED DETAIL			CEILING HEIGHT
LINLAINGLU DE FAIL		INTERIOR FIXTURE	▼ F-*
	*ELEVATION LETTER		
INTERIOR ELEVATION INDICATOR	* * ELEVATION NUMBER		

SCHEDULE OF DRAWINGS

SHEET

DESCRIPTION

ARCHITECTURE

REVISION

G0.00	COVER SHEET / PROJECT CODE AND SUMMARY
G0.01	ARCHITECTURAL NOTES & SPECIFICATIONS
G0.02	ADA DETAILS
G1.00	DEMOLITION PLAN
G2.00	ARCHITECTURAL SITE PLAN
G3.01	FIRST FLOOR LIFE SAFETY PLAN
G3.02	SECOND FLOOR LIFE SAFETY PLAN
G3.02	FIRST & SECOND FLOOR OCCUPANCY PLAN
AI.0I	WALL DETAILS
AI.II	FIRST FLOOR PLAN
AI.12	SECOND FLOOR PLAN
AI.2I	FIRST FLOOR REFLECTED CEILING PLAN
AI.22	SECOND FLOOR REFLECTED CEILING PLAN
AI.30	ROOF PLAN
A2.I	EXTERIOR ELEVATIONS
A2.2	EXTERIOR ELEVATIONS
A2.3	ELEVATION DETAILS
A3.0	CROSS SECTION
A3.1	CROSS SECTION
A3.2	SECTION DETAILS
А3.3	SECTION DETAILS
A4.0	STAIR SECTION
Α4.Ι	STAIR/ELEVATOR SECTION
A4.2	ELEVATOR SECTION
A5.I	WINDOW & DOOR SCHEDULES & ELEVATIONS
A5.2	WINDOW & DOOR DETAILS
A6.0I	INTERIOR FINISH SCHEDULE
	G0.01 G0.02 G1.00 G2.00 G3.01 G3.02 G3.02 A1.01 A1.11 A1.12 A1.21 A1.22 A1.30 A2.1 A2.2 A2.3 A3.0 A3.1 A3.2 A3.3 A4.0 A4.1 A4.2 A5.1 A5.2

A6.II FIRST FLOOR FINISH PLAN

A6.21 INTERIOR ELEVATIONS

A6.22 INTERIOR ELEVATIONS

A6.23 INTERIOR ELEVATIONS

A6.24 INTERIOR ELEVATIONS

A6.12 SECOND FLOOR FINISH PLAN

	2	3	SHEET	DESCRIPTION	REVISION	Ι
			A6.25	NTERIOR ELEVATIONS		
			A6.3I	CABINET SECTIONS		
			A6.32	CABINET SECTIONS		
			SI.0	STRUCTURAL NOTES		
			S2.0	FOUNDATION PLAN		
			S3.0	SECOND FLOOR FRAMING PLAN		
			S4.0	ROOF FRAMING PLAN		
			S4.I	UPPER ROOF FRAMING PLAN		
			S5.0	STRUCTURAL DETAILS		
			\$6.0	STRUCTURAL DETAILS		
			\$7.0	STRUCTURAL DETAILS		
			\$8.0	STRUCTURAL DETAILS		
			MI.I	MECHANICAL NOTES AND SCHEDULES		
			MI.2	MECHANICAL FIRST FLOOR PLAN		
			MI.3	MECHANICAL SECOND FLOOR PLAN		
			MI.4	MECHANICAL ROOF PLAN		
			EI.0	ELECTRICAL SPECIFICATIONS		
			EI.I	ELECTRICAL LEGEND & LIGHTING SCHEDULES		
			E2.0	ELECTRICAL SITE PLAN		
			E3.0	PHOTOMETRY PLAN		
			E4.0	FIRST FLOOR ELECTRICAL PLAN		
			E4.I	SECOND FLOOR ELECTRICAL PLAN		
			E4.2	ENLARGED ELECTRICAL PLANS		
			E5.0	DENTAL AREA ELECTRICAL DETAIL PLAN		
			E6.0	RISER DIAGRAM		
			E7.0	PANEL SCHEDULE		
			E8.0	ELECTRICAL PENETRATION DETAILS		
			PI.0	PLUMBING SPECIFICATION AND NOTES		
			PI.I	PLUMBING SANITARY FIRST FLOOR PLAN		
		·	PI.2	PLUMBING SANITARY SECOND FLOOR PLAN		

PI.3 PLUMBING WATER FIRST FLOOR PI.4 PLUMBING WATER SECOND FLOOR

PI.5 PLUMBING WATER PLAN

PI.6 DENTISTRY PLAN

LIST OF ABBREVIATIONS

	I UF ADDRE	VIA							
A/C ACT AFF AHU ALT	AIR CONDITIONER ACOUSTICAL CEILING TILE ABOVE FINISHED FLOOR (SLAB) AIR HANDLER UNIT ALTERNATE	E EA EIFS EJ EL ELEC ELEC	' ELEVATION		IN INCL INSUL INT JB JT	INCH INCLUDING INSULATION INTERIOR JUNCTION BOX JOINT	R	R RD RECP REF REINF REQ'D REV	RADIUS ROOF DRAIN RECEPTACLE REFRIGERATOR REFINORCEMENT REQUIRED REVISION
ALUM ANOD APPROX ARCH AUTO	ALUMINUM ANODIZED APPROXIMATE ARCHITECT AUTOMATIC	EMEI EQ EQUI EWC	EQUAL	L	L LAM LAV	LENGTH LAMINATE LAVATORY	S	RM RO RTU SCHED	ROOM ROUGH OPENING ROOF TOP UNIT SCHEDULE
D LDG M RG TM	BOARD BUILDING BEAM BEARING BOTTOM	EXIS EXP EXT F FD FDN	T EXISTING EXPANSION EXTERIOR FLOOR DRAIN FOUNDATION	М	MAS MAX MECH MFR MIC MIN	MASONRY MAXIMUM MECHANICAL MANURFACTURE MICROWAVE MINIMUM		SECT SF SIM SPEC SQ SS	SECTION SQUARE FEET SIMILAR SPECIFCATION SQUARE STAINLESS STEEL
EL ELG ELO ELR	CONTROL JOINT CENTER LINE CEILING CLOSET CLEAR	FE FIN FLR FR FRT	FIRE EXTINGUISHER FINISHED FLOOR FIRE RESISTAND FIRE RETARDANT TREATED		MISC MLDG MO MTD MTL MUL	MISCELLANEOUS MOULDING MASONRY OPENING MOUNTED METAL MULLION	Т	T T&G TBL	STANDARD STORAGE STRUCTURAL TREAD TONGUE & GROOVE TABLE
EMU EO EONC	CONCRETE MASONRY UNIT CLEAN OUT COLUMN CONCRETE	FRZF FT FTG FURF FUT	FEET, FOOT FOOTING	N	N/A NIC NOM NTS	NOT APPLICABLE NOT IN CONTRACT NOMINAL NOT TO SCALE	U	TEMP THK TYP U.C.	TEMPERED THICK TYPICAL UNDER COUNTER
ONST ONT ONTR ORR	CONSTRUCTION CONTINUOUS CONTRACTOR CORRIDOR CERAMIC TILE	G GA GAL' GC GWB	GAUGE / GALVANIZED GENERAL CONTRACTOR GYPSUM WALL BOARD	0	OC OD OPP	ON CENTER OUTSIDE DIAMETER OPPOSITE	V	UON UTIL VB	UNLESS OTHERWISE NOTED UTILITY VINYL BASE
TR U F DIA DIM DISP	CENTER CONDENSING UNIT DRINKING FOUNTAIN DIAMETER DIMENSIONS DISPENSER	H H HB HC HDW	HEIGHT HOSE BIB HOLLOW CORE HARDWARE HOLLOW METAL	Р	P P-LAM PAF PLAS PLBG PLWD	PAINT PLASTIC LAMINATE POWDER ACTUATED FASTENER PLASTER PLUMBING PLYWOOD	·	VCT VERT VEST VIF VTR VWC	VINYL COMPOSITE TILE VERTICAL VESTIBULE VERIFY IN FIELD VENT THRU ROOF VINYL WALL COVERING
N N S W WG	DOWN DOWNSPOUT DISHWASHER DRAWING	HORI HR HT HTG HVA	Z HORIZONTAL HOUR HEIGHT HEATING		PNL	PANEL PREFABRICATED PRESSURE TREATED POLY VINYL CHLORIDE	W	W W/ W/O WC WD WH WP	WIDTH WITH WITHOUT WATER CLOSET WOOD WATER HEATER WATERPROOF

SHEET

H AL < ≥

ARCHITECTURE

1 5 4 2 G U A V A A V E MELBOURNE, FL 32935 3 2 1 4 2 8 3 8 6 9

DRAWN: JKA

CHECKED: JKA

REVISIONS:

C-2022-032

2023-09-25

SEAL

BID SET ONLY

> DATE: 2023-09-25 SHEET TITLE

COVER SHEET PROJECT CODE **AND SUMMARY**

SHEET NUMBER

WATER RESISTANT

WELDED WIRE FABRIC

WELDED WIRE METAL

WEIGHT

ARCHITECTURAL NOTES AND SPECIFICATIONS

GENERAL NOTES:

- OWNER/CLIENT RESPONSIBILITIES: REFERENCE IS MADE THROUGHOUT THESE GENERAL NOTES TO RESPONSIBILITIES AND STANDARDS OF CASE TO BE FULFILLED BY THOSE PROVIDING SERVICES IN THE DEVELOPMENT AND CONSTRUCTION OF THIS PROJECT. OWNER/CLIENT SHALL BE RESPONSIBLE FOR ADHERENCE TO THOSE REQUIREMENTS BY THE BUILDER, GENERAL CONTRACTOR, SUBCONTRACTORS AND OTHER PROFESSIONAL CONSULTANTS NOT RETAINED BY THE ARCHITECT.
- PERMIT ARCHITECTURAL DRAWINGS: THIS SET IS SUFFICIENT TO BE PART OF THE PERMIT SET TO OBTAIN A BUILDING PERMIT. THIS SET MAY NOT INCLUDE THE REQUIRED SHOP DRAWINGS/ NOA REQUIRED FOR PERMITTING. THE CONTRACTOR SHOULD CHECK WITH THE OWNER TO DETERMINE THE SCOPE OF WORK OF THE ARCHITECT. THE GENERAL CONTRACTOR IS RESPONSIBLE FOR OBTAINING THE BUILDING PERMIT.
- 3. BUILDING MAINTENANCE: THE EXPOSED MATERIAL USED IN THE CONSTRUCTION OF THIS PROJECT WILL DETERIORATE AS THE COMPLETED PROJECT AGES UNLESS PROPERLY AND ROUTINELY MAINTAINTED. OWNER/CLIENT SHALL WORK WITH THE CONTRACTOR TO DEVELOP A PLAN TO KEEP THESE EXPOSED MATERIALS PROTECTED AND MAINTAINED.
- 4. ALL CONSTRUCTION SHALL COMPLY WITH THE MOST STRINGENT REQUIREMENTS OF ALL CURRENT APPLICABLE CITY, COUNTY, STATE AND FEDERAL LAWS, RULES, CODES, ORDINANCES AND REGULATIONS. IF THE GENERAL CONTRACTOR OR ANY SUBCONTRACTOR PERFORMS ANY WORK IN CONFLICT WITH THE ABOVE MENTIONED LAWS, RULES, CODES, ORDINANCES AND REGULATIONS, THEN THE CONTRACTOR IS IN VIOLATION AND SHALL BEAR ALL COST OF REPAIR ARISING OUT OF THE NON-CONFORMING WORK.
- THE GENERAL CONTRACTOR MUST THOROUGHLY EXAMINE THE JOB SITE AND FINAL CONSTRUCTION DRAWINGS PRIOR TO STARTING CONSTRUCTION. IF ANY CONFLICTS ARISE, THE GENERAL CONTRACTOR MUST NOTIFY THE ARCHITECT AND ALLOW FOR SUFFICIENT TIME FOR RESOLUTION WITHOUT DELAYING
- SUBSTITUTIONS/ CHANGES: NO SUBSTITUTIONS/CHANGES CAN BE MADE WITHOUT WRITTEN AUTHORIZATION BY THE OWNER/CLIENT. THE ARCHITECT DOES NOT TAKE ANY LIABILITY FOR ANY SUBSTITUTIONS/ CHANGES WITHOUT THE ARCHITECT'S WRITTEN AUTHORIZATION. ANY APPROVAL REQUIRED BY THE BUILDING OFFICIAL FOR SUBSTITUTIONS/CHANGES SHALL BE THE RESPONSIBILITY OF THE GENERAL CONTRACTOR.
- 7. ALL CONSTRUCTION MATERIALS AND WORKMANSHIP SHALL BE OF "BEST" QUALITY AND INSTALLATION, AND SHALL BE INSTALLED (WHEN APPLICABLE) IN COMPLETE ACCORDANCE WITH THE MANUFACTURER'S
- 8. SUB-CONTRACTORS SHALL VISIT THE SITE TO PROPERLY ASSESS WORKING CONDITIONS PRIOR TO SUBMITTAL OF BIDS.
- 9. THE CONTRACTOR MUST MAKE A CAREFUL EXAMINATION OF THE PLANS, SPECIFICATIONS AND OTHER CONTRACT DOCUMENTS, AND FULLY INFORM THEMSELF AS TO THE QUALITY OF MATERIALS AND CHARACTER OF WORKMANSHIP REQUIRED. THE CONTRACTOR MUST ALSO MAKE A CAREFUL EXAMINATION OF THE SITE OF THE PROPOSED WORK AND THOROUGHLY FAMILIARIZE THEMSELF WITH THE LOCAL CONDITIONS AFFECTING THE SAME.
- 10. THE CONTRACTOR SHALL VERIFY TO THEIR OWN SATISFACTION THE LOCATION AND ELEVATION OF ALL UTILITIES, PIPE WORK, AND THE LIKE. IT IS THE RESPONSIBILITY OF THE CONTRACTOR TO OBTAIN ALL NECESSARY RELATED INFORMATION FROM THE APPLICABLE GOVERNING AUTHORITIES. THE CONTRACTOR IS RESPONSIBLE FOR MAKING THEIR OWN INVESTIGATION.
- II. THE CONTRACTOR SHALL CAREFULLY EXAMINE ALL CONTRACT DOCUMENTS AND THOROUGHLY FAMILIARIZE THEMSELF WITH THE DETAILED REQUIREMENTS CONTAINED THEREIN. IF THE CONTRACTOR FINDS DISCREPANCIES OR AMBIGUITIES IN OR OMISSIONS FROM THE DOCUMENTS, OR SHOULD THEY BE IN DOUBT AS TO THEIR MEANING, THE CONTRACTOR MUST CONTACT THE ARCHITECT IMMEDIATELY.
- SHOULD THERE BE ANY DISCREPANCIES BETWEEN THE DRAWINGS, THE CONTRACTOR SHALL NOTIFY THE ARCHITECT AND REQUEST CLARIFICATION IMMEDIATELY.
- 13. FAILURE TO REPORT A CONFLICT IN THE CONTRACT DOCUMENTS SHALL BE DEEMED EVIDENCE THAT THE CONTRACTOR HAS ELECTED TO PROCEED AT THE CONTRACTOR'S OWN RISK.
- 14. ALL MATERIALS, MILLWORK, FIXTURES, FINISHES OR OTHERWISE, CALLED OUT IN THE SPECIFICATIONS OR DRAWINGS, SHALL BE PROVIDED, INSTALLED AND/OR COMPLETED BY THE CONTRACTOR IN A "TURN KEY" STATE, UNLESS OTHERWISE STATED.
- 15. SUBMITTAL OF SHOP DRAWINGS, PRODUCT DATA, AND SAMPLES SHALL BE SUBMITTED TO THE OWNER FOR REVIEW. THE OWNER MAY PROVIDE TO THE ARCHITECT ONLY IF REVIEW OF SHOP DRAWINGS, PRODUCT DATA AND SAMPLES ARE PART OF THE CONTRACT BETWEEN THE OWNER AND ARCHITECT.
- 16. WHEN SHOP DRAWINGS, PRODUCT DATA AND SAMPLES ARE SUBMITTED TO THE ARCHITECT, OWNER/CONTRACTOR SHALL ALLOW A MINIMUM OF TEN BUSINESS DAYS FOR REVIEW. PLEASE NOTE SOME ITEMS MAY REQUIRE MORE TIME, WHICH WILL BE DETERMINED BY THE ARCHITECT.
- 17. GENERAL CONTRACTOR IS RESPONSIBLE FOR CONFIRMING AND COORDINATING ALL FIELD DIMENSIONS.
- ANY MATERIAL, ARTICLE OR PIECE OF EQUIPMENT OF OTHER MANUFACTURERS OR VENDORS WHICH SHALL PERFORM ADEQUATELY THE DUTIES IMPOSED BY THE GENERAL DESIGN SHALL BE CONSIDERED EQUALLY ACCEPTABLE PROVIDED THE MATERIAL, ARTICLE, OR PIECE OF EQUIPMENT SO PROPOSED IS, IN THE OPINION OF THE ARCHITECTS, OF EQUAL SUBSTANCE, APPEARANCE AND FUNCTION. IT SHALL NOT BE PURCHASED OR INSTALLED BY THE CONTRACTOR WITHOUT THE ARCHITECT'S PRIOR WRITTEN APPROVAL. ALL ELECTRICAL FIXTURES, APPLIANCES, EQUIPMENT AND MECHANICAL EQUIPMENT ARE TO BE UL LISTED AND MARKED.
- 19. GENERAL CONTRACTOR AND SUPERINTENDENT SHALL BE RESPONSIBLE FOR COORDINATION OF ALL SUBCONTRACTORS, MATERIAL SUPPLIERS, AND OWNER'S SUBCONTRACTORS.
- 20. CONTRACTOR SHALL ASSUME FULL RESPONSIBILITY FOR PROTECTION OF OWNER'S PROPERTY. CONTRACTOR WILL REPAIR OR REPLACE ALL DAMAGED ITEMS WITHOUT COST TO THE OWNER.
- 21. THE CONTRACTOR SHALL MAINTAIN A CLEAN JOB SITE THROUGHOUT THE BUILDING PERIOD.

PLAN NOTES

- MELD STUDIO ARCHITECTURE IS THE SOLE OWNER OF THE DESIGN, DRAWINGS AND SPECIFICATIONS. THE DRAWINGS SHALL NOT BE DUPLICATED OR REPRODUCED IN ANY PORTION WITHOUT PRIOR WRITTEN CONSENT BY MELD STUDIO ARCHITECTURE.
- ALL RULES AND REGULATIONS OF THE 6TH EDITION OF THE 2017 FLORIDA BUILDING CODE ARE TO BE FOLLOWED ON ALL ASPECTS OF THIS PROJECT.
- 3. Do not scale drawings for any reason. If you need a dimension, please ask the ARCHITECT.
- DIMENSION STRINGS ARE TO ONE SIDE OF THE WALL FOR INTERIOR FRAME WALLS. ALL INTERIOR WALLS ARE 4" WALLS UNLESS OTHERWISE NOTED.
- PER FLORIDA FIRE PREVENTION CODE, 6TH EDITION, NFPA 101-7.2.1.5.3, LOCKS, IF PROVIDED, SHALL NOT REQUIRE THE USE OF A KEY, TOOL OR SPECIAL KNOWLEDGE OR EFFORT TO UNLOCK FROM THE EGRESS SIDE OF THE BUILDING.
- 6. ANY FASTENING DEVICE ON THE DOOR TO HAVE ONLY ONE KNOB, HANDLE, PANIC BAR OR OTHER SIMPLE TYPE OF RELEASING DEVICE (PER FLORIDA FIRE PREVENTION CODE, 6TH EDITION, NFPA 101.7.2.1.5).

- 7. PER FLORIDA FIRE PREVENTION CODE, 6TH EDITION, NFPA 101.7.2.1.3.2, THE ELEVATION OF FLOOR SURFACES SHALL BE MAINTAINED ON BOTH SIDES OF THE DOOR OPENINGS FOR A DISTANCE NOT LESS THAN THE WIDTH OF THE WIDEST LEAF.
- 8. FIRE EXTINGUISHERS TO BE PROVIDED WITH A MINIMUM RATING OF 2A:10-BC FOR EVERY 3,000 SF OF FLOOR AREA. VERIFY THAT THE TRAVEL DISTANCE TO A FIRE EXTINGUISHER SHALL NOT EXCEED 75

GRADING / FILL

- I. THE CONTRACTOR SHALL SLOPE THE GRADE AWAY FROM STRUCTURE SO TO PROVIDE POSITIVE DRAINAGE WITHOUT PONDING.
- 2. THE CONTRACTOR SHALL REFER TO LOCAL ZONING REGULATIONS AND CODES IN REGARDS TO GRADING
- 3. FILL MATERIAL SHALL MEET THE REQUIREMENTS OF THE STRUCTURAL DRAWINGS AND BUILDING CODE REQUIREMENTS.

TERMITE TREATMENT

1. Soil under new foundation areas shall be treated for termites according to the INFORMATION PROVIDED ON THE STRUCTURAL AND ARCHITECTURAL DRAWINGS.

EXTERIOR STUCCO

- I. PORTLAND CEMENT: ASTM C 150, TYPE I.
- 2. COLOR FOR JOB-MIXED FINISH-COATS: COLOR FOR FINISH COAT TO BE SELECTED FROM AN APPROVED MINERAL PIGMENT MANUFACTURER'S FULL RANGE OF COLORS. FINISH STUCCO COLOR TO MATCH SAMPLE PROVIDED TO AND APPROVED BY THE OWNER.
- 3. LIME: ASTM C 206, TYPE S; OR ASTM C 207, TYPE S.
- 4. SAND AGGREGATE: ASTM C897. USE SAME SAND AS PROVIDED WITH APPROVED SAMPLE.

HANDRAIL STRUCTURAL PERFORMANCE:

PROVIDE RAILINGS CAPABLE OF WITHSTANDING THE EFFECTS OF GRAVITY LOADS AND THE FOLLOWING LOADS AND STRESSES WITHIN LIMITS AND UNDER CONDITIONS INDICATED BELOW:

- HANDRAILS:
- A. UNIFORM LOAD OF 50 LBF/ FT. APPLIED IN ANY DIRECTION.
- CONCENTRATED LOAD OF 200 LBF APPLIED IN ANY DIRECTION.
- UNIFORM AND CONCENTRATED LOADS NEED NOT BE ASSUMED TO ACT
- CONCURRENTLY. TOP RAILS OF GUARDS:
- UNIFORM LOAD OF 50 LBF/ FT. APPLIED IN ANY DIRECTION.
- CONCENTRATED LOAD OF 200 LBF APPLIED IN ANY DIRECTION.
- UNIFORM AND CONCENTRATED LOADS NEED NOT BE ASSUMED TO ACT
- CONCURRENTLY.
- INFILL GUARD RAILS:
- CONCENTRATED LOAD OF 50 LBF APPLIED HORIZONTALLY ON AN AREA OF I SQ.FT.
- UNIFORM LOAD OF 25 LBF/SQ. F T. APPLIED HORIZONTALLY.
- INFILL LOAD AND OTHER LOADS NEED NOT BE ASSUMED TO ACT

INSECT CONTROL

- I. SPRAY ALL FRAMING WITH A LIQUID BORAX SOLUTION PRIOR TO INSULATION AND DRYWALL.
- 2. ALL SOIL IN CONSTRUCTION TO BE TERMITE TREATED.

RELATIVE HUMIDITY/ MOISTURE CONTENT REQ:

- I. 9% OPTIMUM MOISTURE CONTENT FOR STRUCTURAL LUMBER
- 2. 5%-10% OPTIMUM MOISTURE CONTENT FOR INTERIOR WOOD
- 9%-15% OPTIMUM MOISTURE CONTENT FOR EXTERIOR WOOD 4. 25%-55% INDOOR RELATIVE HUMIDITY REQUIRED TO HOLD OPTIMUM MOISTURE CONTENT
- USE PRESSURE TREATED WOOD MATERIALS WHERE INDICATED BELOW:
- WOOD MEMBERS IN CONNECTION WITH ROOFING, FLASHING, VAPOR BARRIERS AND WATERPROOFING.
- MEMBERS IN CONTACT WITH MASONRY OR CONCRETE.
- 3. Framing members less than 18" above grade.
- 4. WOOD FLOOR PLATES INSTALLED OVER CONCRETE SLABS DIRECTLY IN CONTACT WITH EARTH.

<u>MILLWORK</u>

- I. THE CONTRACTOR TO REFER TO THE ARCHITECTURE OR INTERIOR DESIGN DRAWINGS FOR INSTRUCTIONS REGARDING MILLWORK.
- 2. WHEN REQUIRED THE CONTRACTOR SHALL SUBMIT COMPLETE SHOP DRAWINGS FOR ALL MILLWORK TO THE OWNER FOR REVIEW PRIOR TO ORDERING MATERIALS AND FABRICATION.

FINISH CARPENTRY

- I. THE CONTRACTOR TO REFER TO THE ARCHITECTURE OR INTERIOR DESIGN DRAWINGS FOR
- INSTRUCTIONS REGARDING FINISH CARPENTRY. 2. ALL FINISH CARPENTRY TO MET THE STANDARDS OF THE ARCHITECTURAL WOODWORK INSTITUTE (AWI)

CABINET & UTILITY HARDWARE

THE CONTRACTOR TO PROVIDE SHOP DRAWINGS TO THE OWNER FOR APPROVAL (ONLY WHEN REQUIRED BY THE

WATERPROOFING GENERAL

THE CONTRACTOR SHALL CAREFULLY EXAMINE ALL SURFACES UPON, OR AGAINST WHICH, WATERPROOFING IS TO BE APPLIED, AND CORRECT ANY DEFECTS OR DISCREPANCIES THAT ARE DISCOVERED. APPLICATION OF WATERPROOFING WILL IMPLY THAT THE SURFACES HAVE BEEN PROPERLY INSTALLED, THAT ALL DEFECTS HAVE BEEN CORRECTED, AND THAT ALL SUCH SURFACES ARE IN THE REQUIRED CONDITION TO RECEIVE THE WORK OF THIS SECTION. THEREAFTER, RESPONSIBILITY FOR SATISFACTORY WORK RESTS WITH THE WATERPROOFING CONTRACTOR. WATERPROOFING CONTRACTOR SHALL BE RESPONSIBLE FOR THE WATER-TIGHTNESS OF HIS WORK.

CONCRETE BALCONY

ALL ELEVATED, EXTERIOR CONCRETE BALCONY SLABS SHALL BE WATERPROOFED WITH AN APPLIED EPOXY BASED WATERPROOFING MEMBRANE (CARLYSLE COATINGS).

ROOF INSULATION

I. SEE THE ARCHITECTURAL DRAWINGS FOR INSULATION REQUIREMENTS. 2. INSULATION SHALL BE CHEMICALLY TREATED FOR FLAME RESISTANCE AND SHALL PROVIDE NO FOOD SOURCE FOR BACTERIA OR FUNGI.

WALL INSULATION

- I. SEE THE ARCHITECTURAL DRAWINGS FOR INSULATION REQUIREMENTS.
- 2. INSULATION SHALL BE CHEMICALLY TREATED FOR FLAME RESISTANCE AND SHALL PROVIDE NO FOOD SOURCE FOR BACTERIA OR FUNGI.

ROOFING

- SEE ROOF PLAN FOR ROOF MATERIAL AND INSTALLATION INFORMATION.
- THE CONTRACTOR IS TO ONLY USE A KNOWLEDGEABLE QUALIFIED ROOFING
- SUBCONTRACTOR.
- VENT STACK ROOF PENETRATIONS WILL HAVE LEAD COUNTER-FLASHING. WHERE PRACTICAL, ALL STACKS AND VENTS ARE TO BE HIDDEN FROM THE FRONT ELEVATION.
- 4. USE ROOF/WALL DIVERTER (KICKOUT) FLASHING WHERE THE ROOFING MEETS ANY VERTICAL PLANES AND PROVIDE COUNTER FLASHED AND LIQUID MASTIC APPLIED UP THE RAKE.

GENERAL FLASHING NOTES

- I. ALL METAL FLASHINGS, COUNTER-FLASHINGS, DRIPS, MECHANICAL ROOF CAPS, AND ALL
- MISCELLANEOUS SHEET METAL WORK TO BE SHEET COPPER WITH FULLY SOLDERED FLAT-LOCK SEAMS 2. PROVIDE METAL DRIP EDGE CONTINUOUS ALONG ALL EAVES AND RAKES. ALL METAL JOINTS TO BE
- FULLY SOLDERED, NOT CAULKED. REVIEW ALL DETAILS CAREFULLY FOR SPECIAL FLASHING REQUIREMENTS. CONTRACTOR SHALL BE RESPONSIBLE FOR IDENTIFYING ALL FLASHING CONDITIONS AND/OR THE PROPER INSTALLATION OF

CAULKING AND SEALANTS

- THE CONTRACTOR SHALL PROVIDE A SKILLED AND EXPERIENCED PERSON FOR CAULKING AND SEALING
- PRIOR TO CAULKING AND SEALING, ALL JOINTS SHALL BE CLEANED AND FREE OF MATERIAL.
- 3. ALL JOINTS SHALL BE FINISHED SMOOTHLY AND SLIGHTLY CONCAVE BY THE USE OF HAND CAULKING
- TOOLS. 4. APPLICATION LOCATION:
 - CAULKING: APPLY AT ALL INTERIOR "DRY" LOCATIONS.
 - SEALANT: APPLY AT ALL EXTERIOR LOCATIONS AND ALL INTERIOR "WET" LOCATIONS.

EXTERIOR WINDOWS AND DOORS

- I. ALL EXTERIOR DOORS AND WINDOWS TO BE IMPACT RATED GLAZING WITH A LOW-E COATING
- WINDOWS AND DOORS SHALL BE MOUNTED PER MANUFACTURER'S SPECIFICATIONS. SEE WATER PROOFING DETAILS IN THE ARCHITECTURAL DRAWINGS.
- 3. ALL WINDOWS AND DOORS TO BE INSTALLED BY MANUFACTURER OR MANUFACTURER TRAINED AND
- CERTIFIED INSTALLER.
- ALL HARDWARE INCLUDING BUT NOT LIMITED TO HINGES, HANDLES, THRESHOLDS, FASTENERS, ETC. SHALL BE PROVIDED BY THE MANUFACTURER.

INTERIOR DOORS:

1. SEE FINISH SPECIFICATIONS FOR INTERIOR DOOR TYPE, MATERIAL, AND FINISH.

BLOCKING:

CONTRACTOR IS TO PROVIDE BLOCKING AS REQUIRED AT ALL EXTERIOR DOORS, WINDOWS, LOCATION OF CABINETS/BUILT-INS, AND AS SPECIFIED THE ARCHITECTURAL PLANS.

WET INTERIOR AREAS

- I. WATERPROOFING MEMBRANE SHALL BE PROVIDED FOR ALL VERTICAL SURFACES AT ALL TUB AND
- 2. CEMENT BOARD SHALL BE PROVIDED FOR WALLS OF SHOWER ENCLOSURES, TUB LEDGES, TUB
- SURROUNDS, ETC.

GYPSUM BOARD

- 1. DRYWALL CEILINGS AND WALLS SHALL BE 5/8" GYPSUM BOARD INSTALLED OVER I"X3" FURRING AT 16"
- O.C., UNLESS OTHERWISE NOTED.
- USE PLASTIC CORNER BEAD ON ALL DRYWALL CORNERS. USE 1/2" THICK GREEN BOARD BEHIND PLUMBING FIXTURES AND IN ALL WET AREAS AND 1/2" THICK CEMENT BOARD AS UNDERLAYMENT ON ALL TILED WET AREAS. FINISH SAMPLES TO BE APPROVED BY
- MOISTURE RESISTANT GYPSUM BOARD AT ALL SPLASH/WET AREAS IN KITCHEN, LAUNDRY, BATHROOMS, CEILINGS OF SHOWER AREAS, ETC.
- FINISH LEVEL OF GYPSUM WALLS AND CEILINGS AS INDICATED IN THE "FINISH SCHEDULE" SHALL BE BASED ON GYPSUM ASSOCIATION'S "RECOMMENDED LEVELS OF GYPSUM BOARD FINISH."

PAINT SPECIFICATIONS

SEE THE SEPARATE PAINT SPECIFICATION BY LANCO.



1542 GUAVA AVE MELBOURNE, FL 32935 3 2 1 . 4 2 8 . 3 8 6 9

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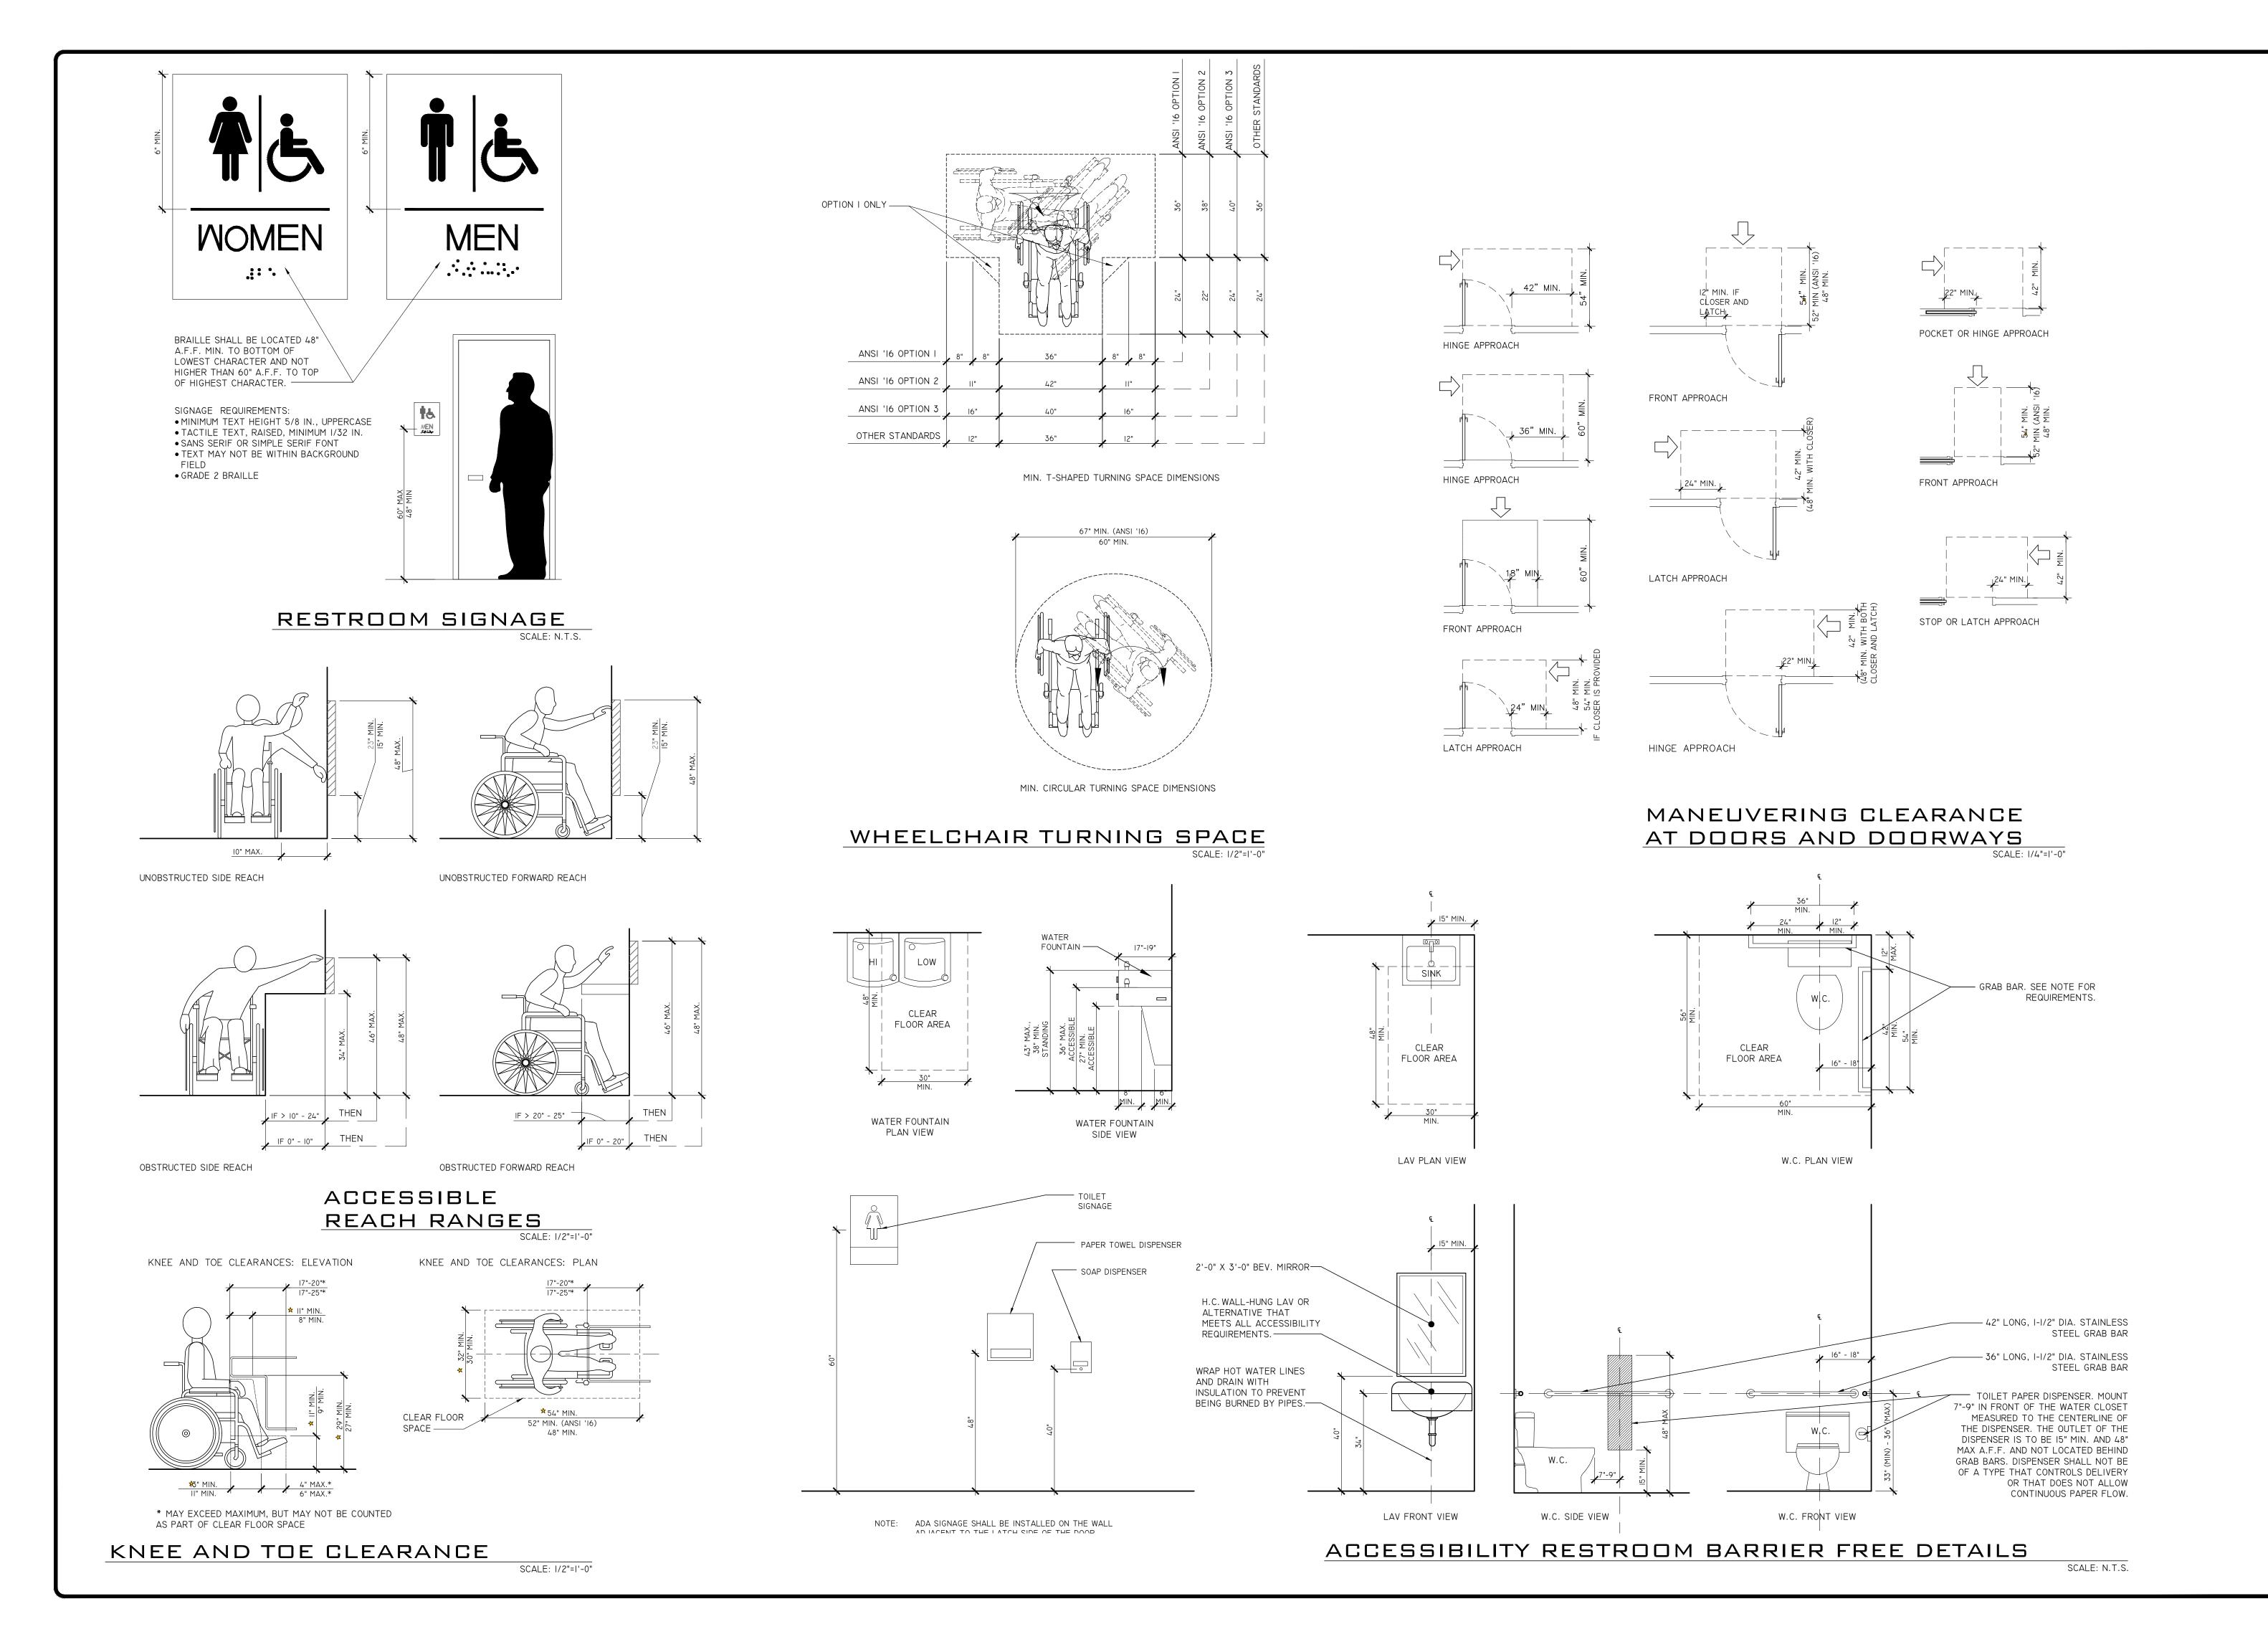
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SHEET TITLE NOTES & **SPECIFICATIONS**



ARCHITECTURE

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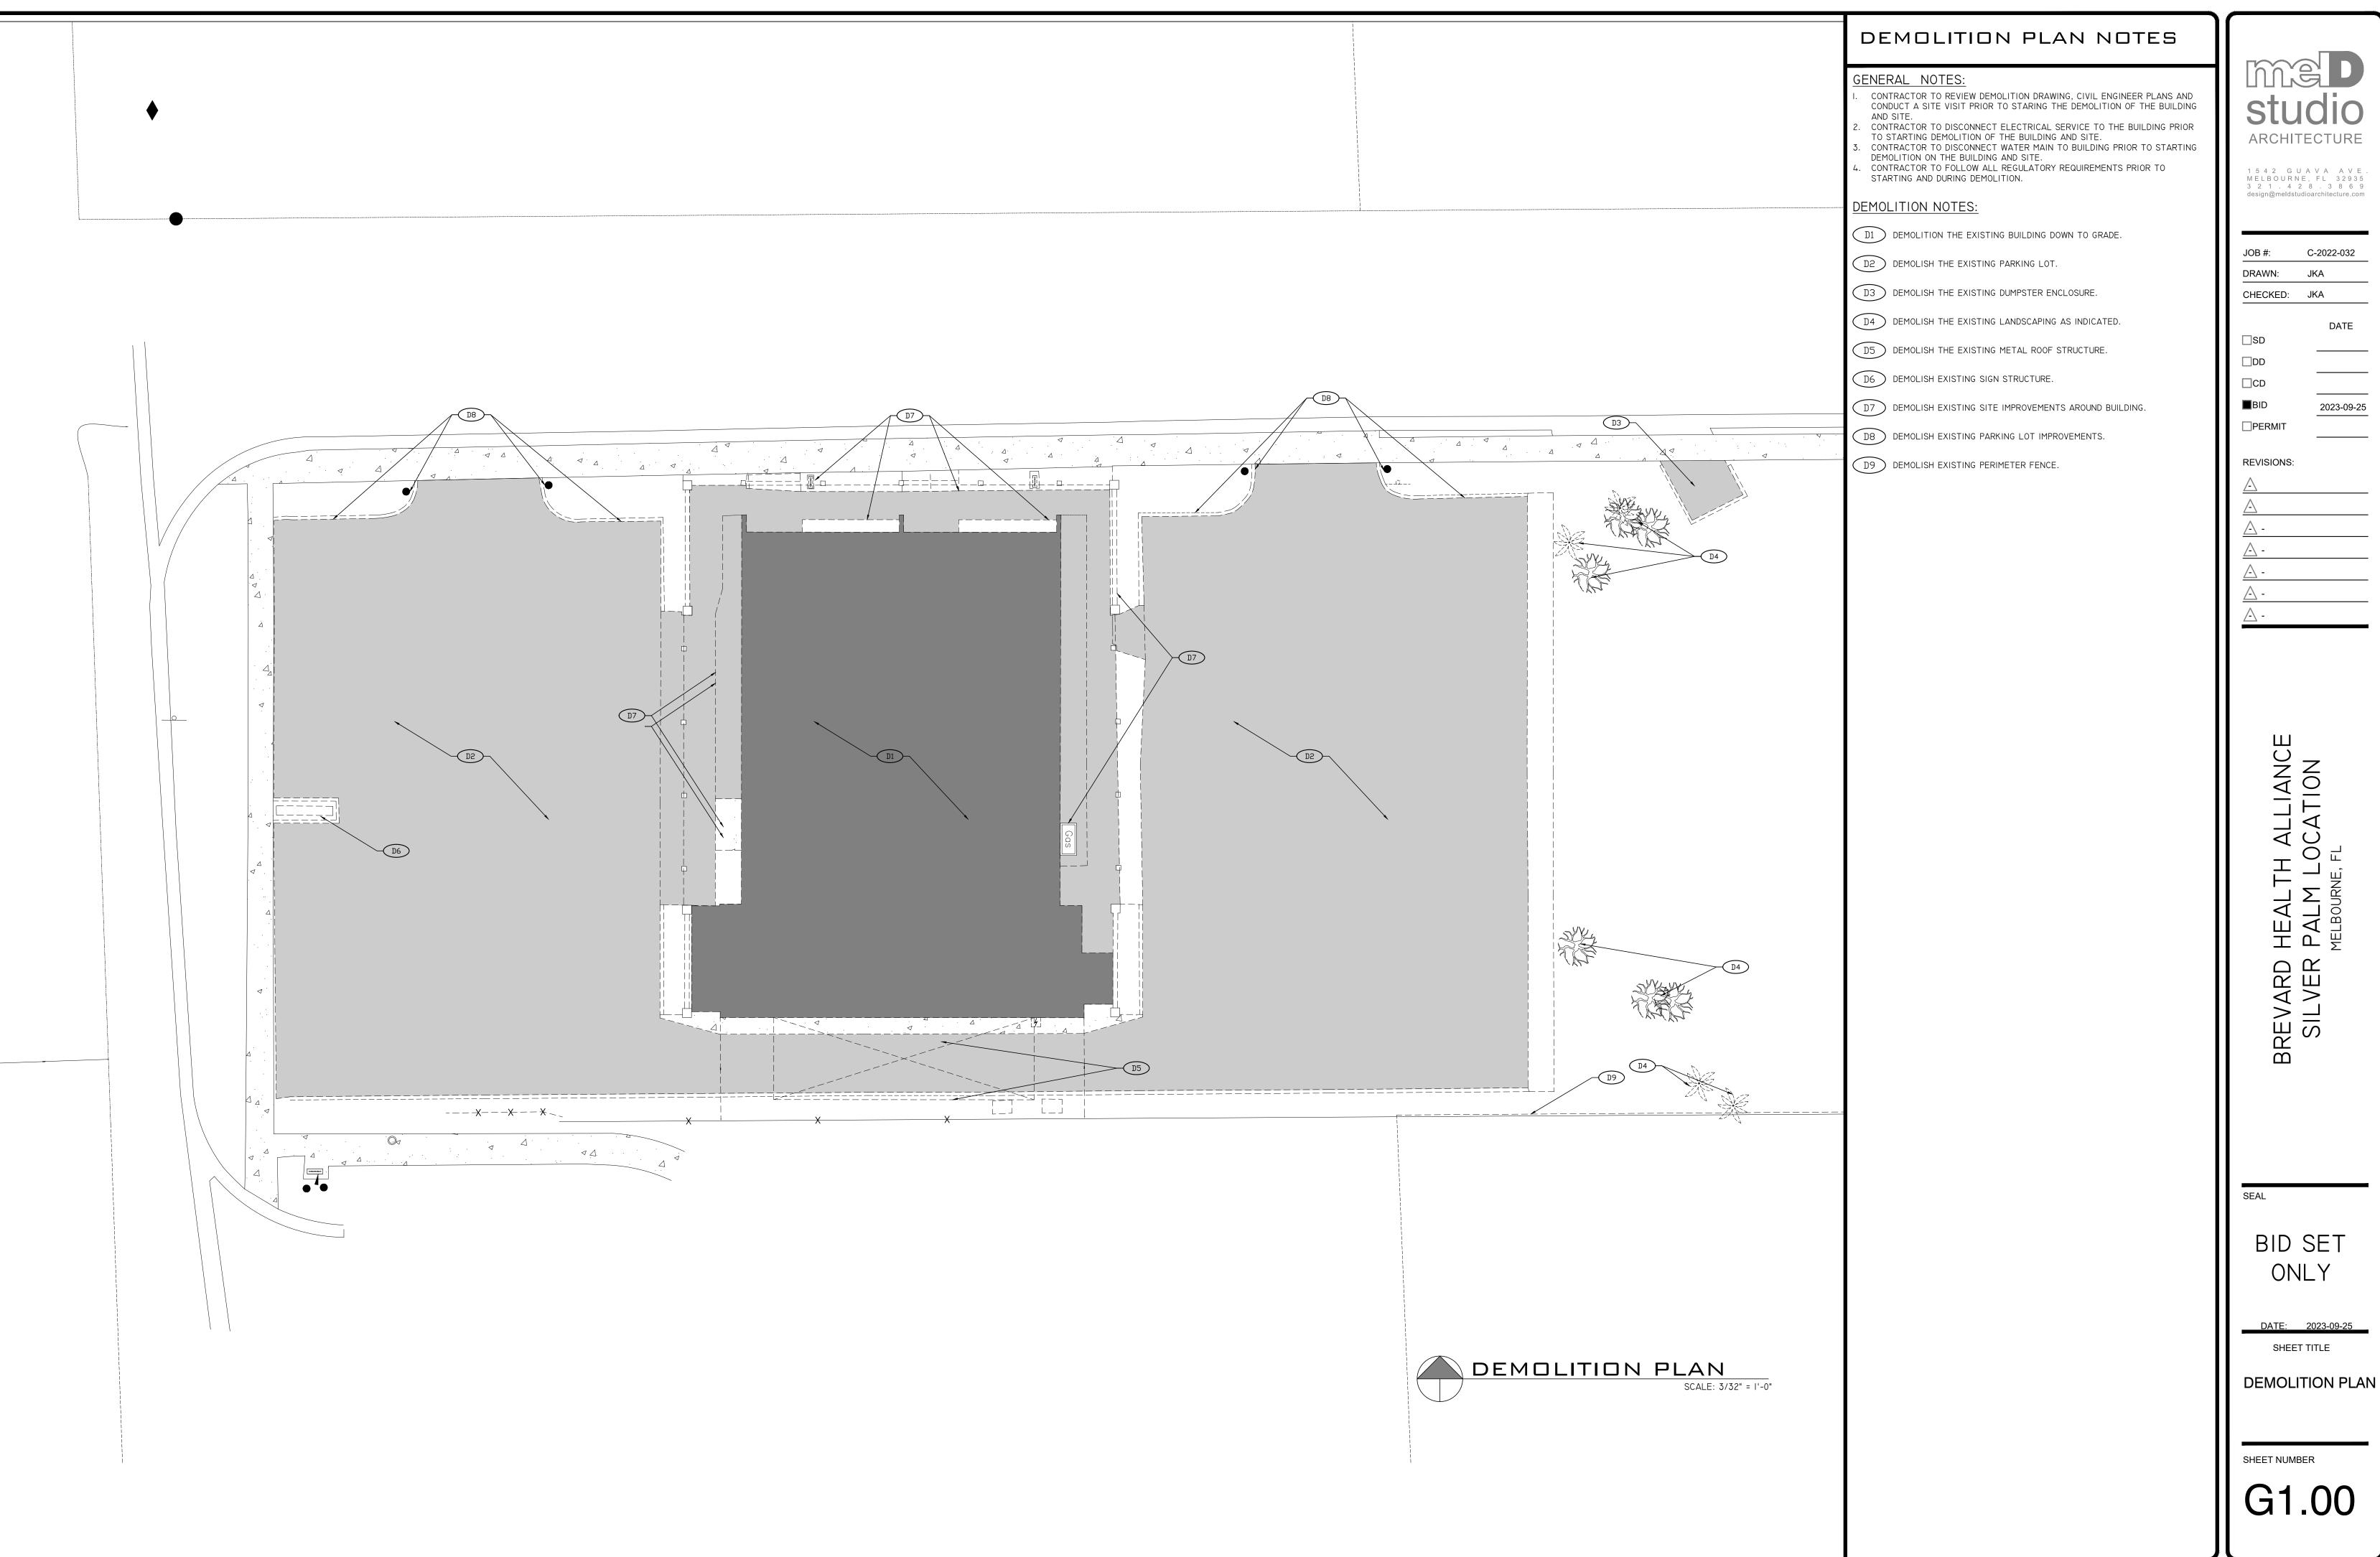
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SHEET TITLE ADA DETAILS



ARCHITECTURE

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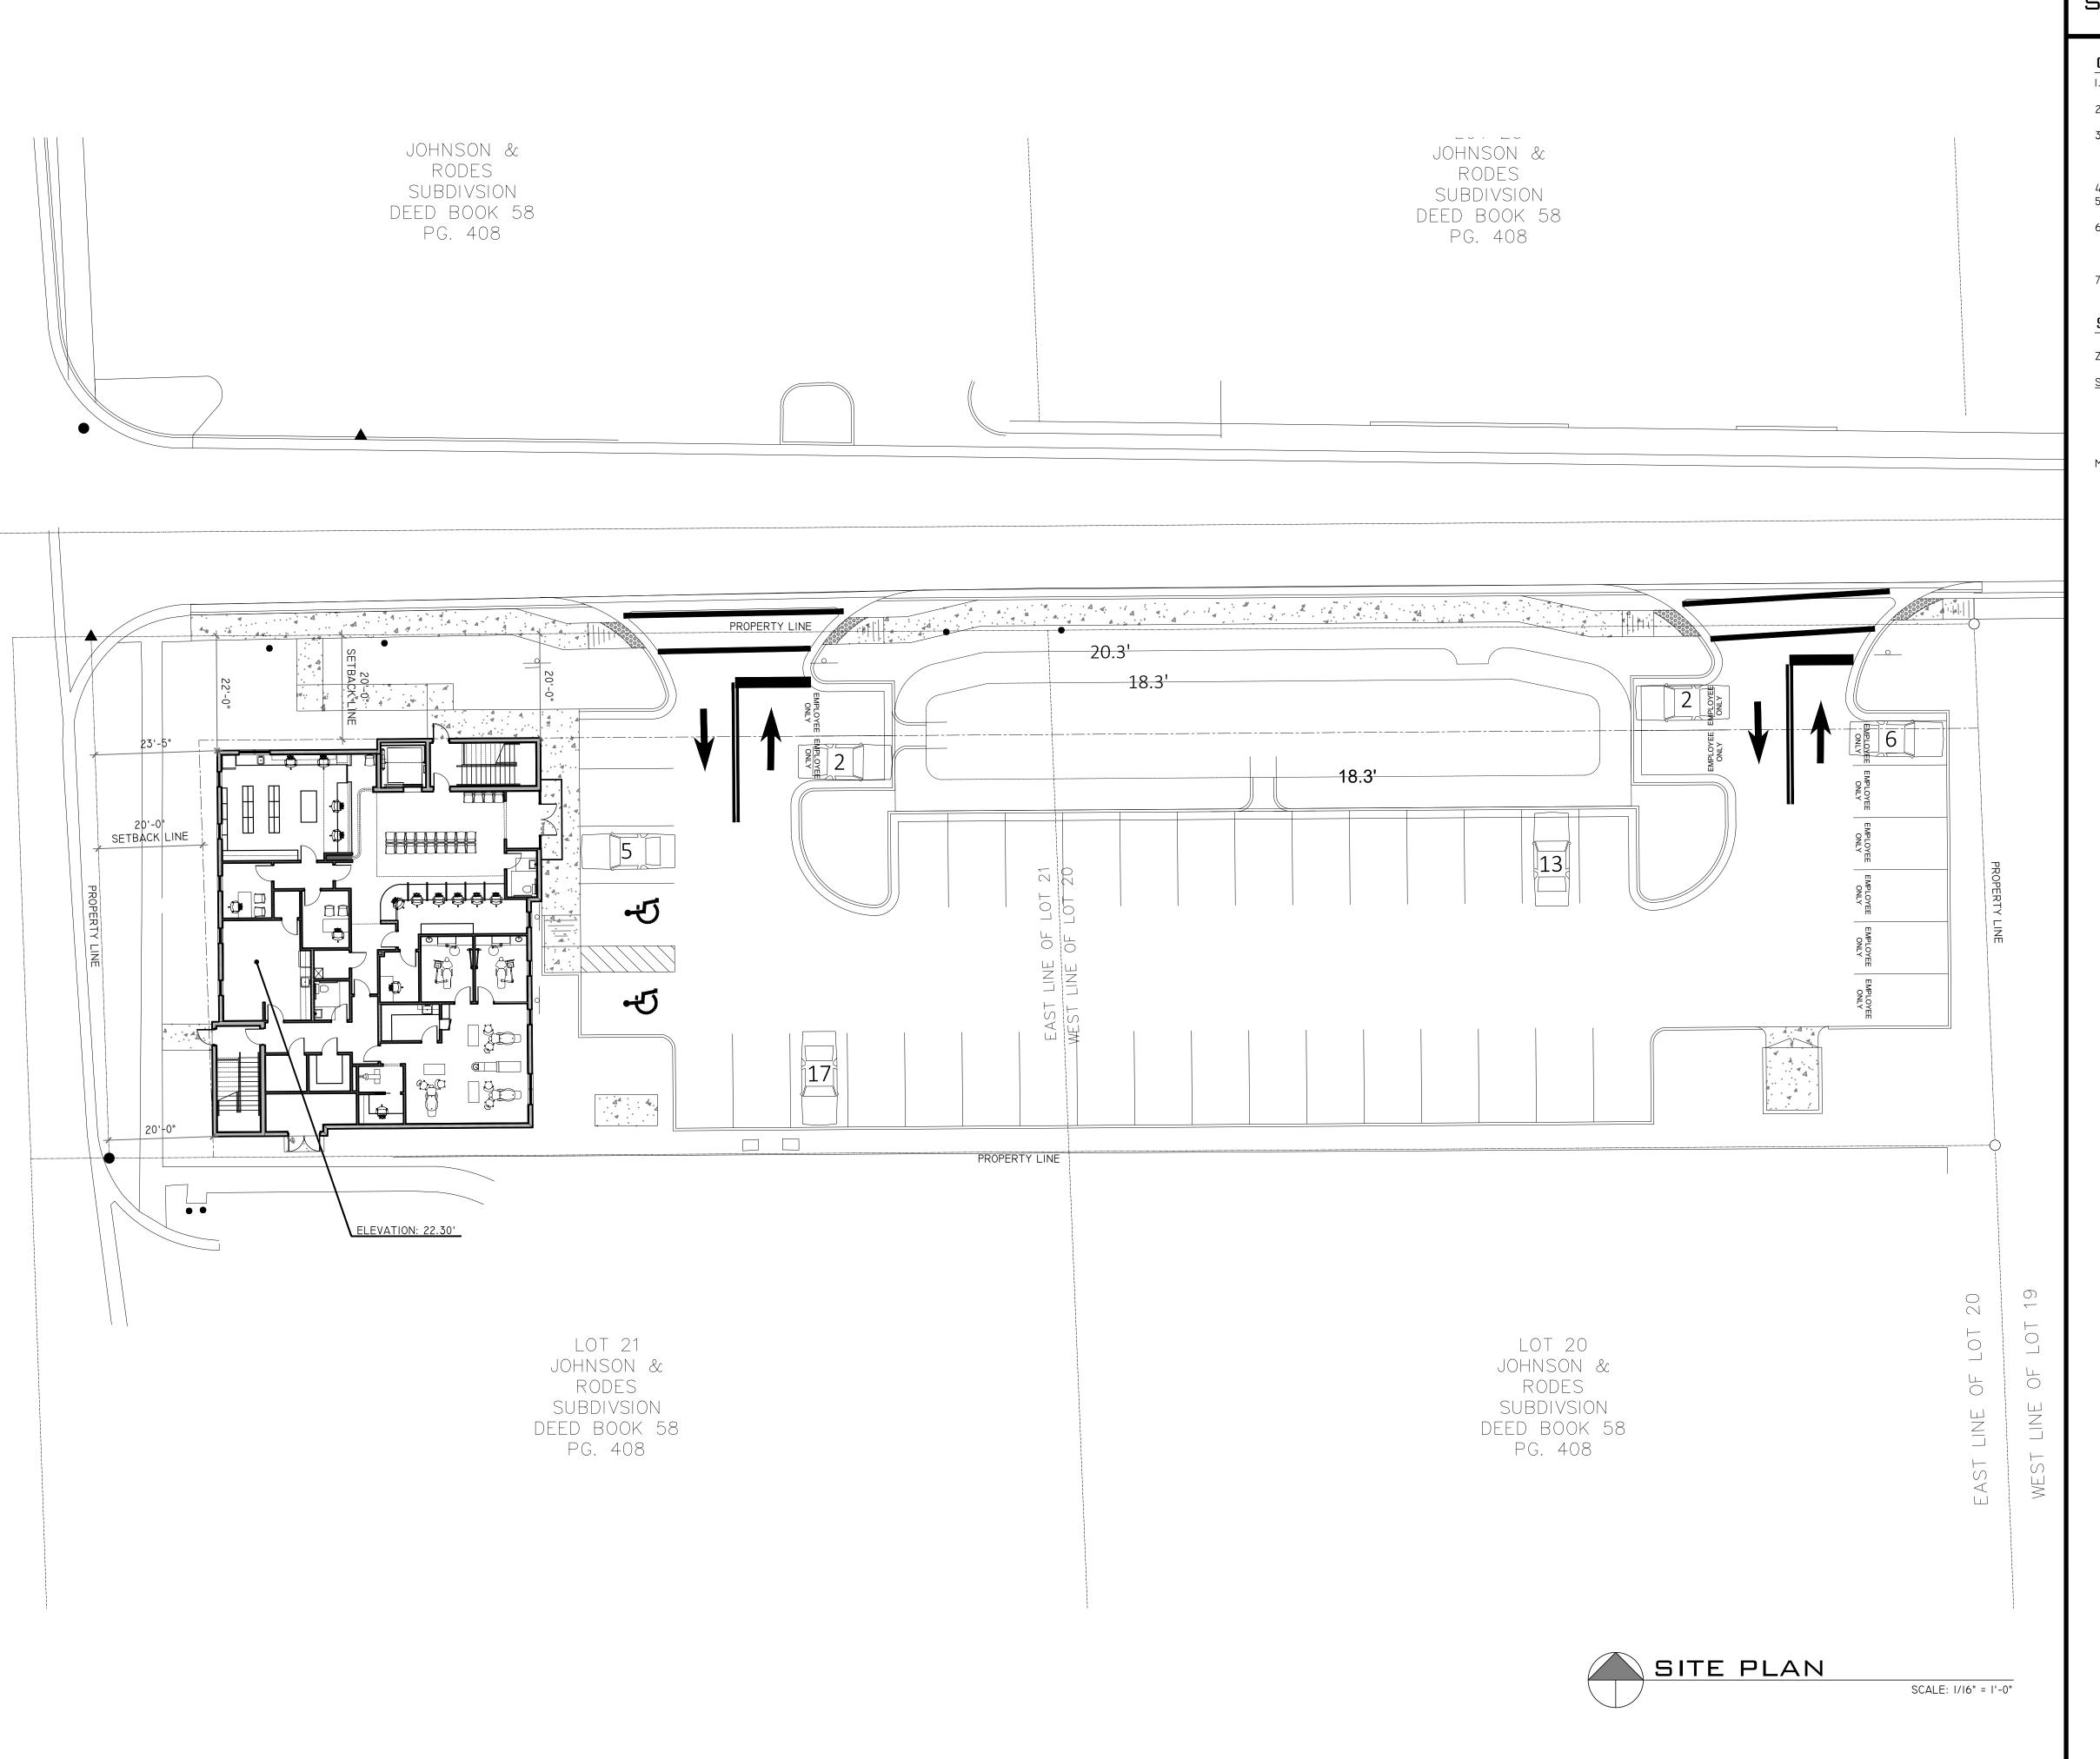
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SHEET TITLE



SITE PLAN NOTES

GENERAL NOTES:

- I. REFERENCE ARCHITECTURAL SPECIFICATION SHEET A0.2 FOR GENERAL
- CONSTRUCTION INFORMATION RELATED TO THE PROJECT. 2. BEARING HEIGHTS DATUM ARE REFERENCED FROM TOP OF SLAB DRAWINGS.
- VERIFY WITH SURVEY OR CIVIL ENGINEERING DRAWINGS. 3. EACH CONTRACTOR SHALL VERIFY ALL DIMENSIONS SHOWN ON THE
- DRAWING AND OBTAIN ALL MEASUREMENTS REQUIRED FOR PROPER EXECUTION OF WORK. DO NOT SCALE PLANS. CONTACT ARCHITECT FOR ANY ADDITIONAL INFORMATION OR DIMENSIONS REQUIRED.
- 4. DIMENSIONS ARE TAKEN FROM STRUCTURAL ELEMENTS ONLY. 5. DETAILED DRAWINGS AND LARGER SCALE DRAWINGS TAKE PRECEDENCE OVER SMALL SCALE DRAWINGS.
- 6. FOR CONSTRUCTION DETAILS NOT SHOWN, USE THE PRODUCT MANUFACTURER'S WRITTEN INSTALLATION INSTRUCTIONS AND STANDARD DETAILS, IN STRICT ACCORDANCE WITH THE PROJECT SPECIFICATIONS REQUIREMENTS AND DESIGN INTENT.
- 7. REFER TO CIVIL ENGINEERING DRAWINGS AND SURVEY FOR FINAL LOCATION AND FIRST LEVEL FINISH FLOOR ELEVATION.

SITE INFORMATION:

ZONING: C-I; NEIGHBORHOOD COMMERCIAL

TBACK LINE:	
SIDE CORNER (WEST):	20'-
FRONT (NORTH):	20'-
SIDE (EAST):	00'-
SIDE (SOUTH):	00'-

MAX BUILDING HEIGHT: 48'-0" ARCHITECTURE

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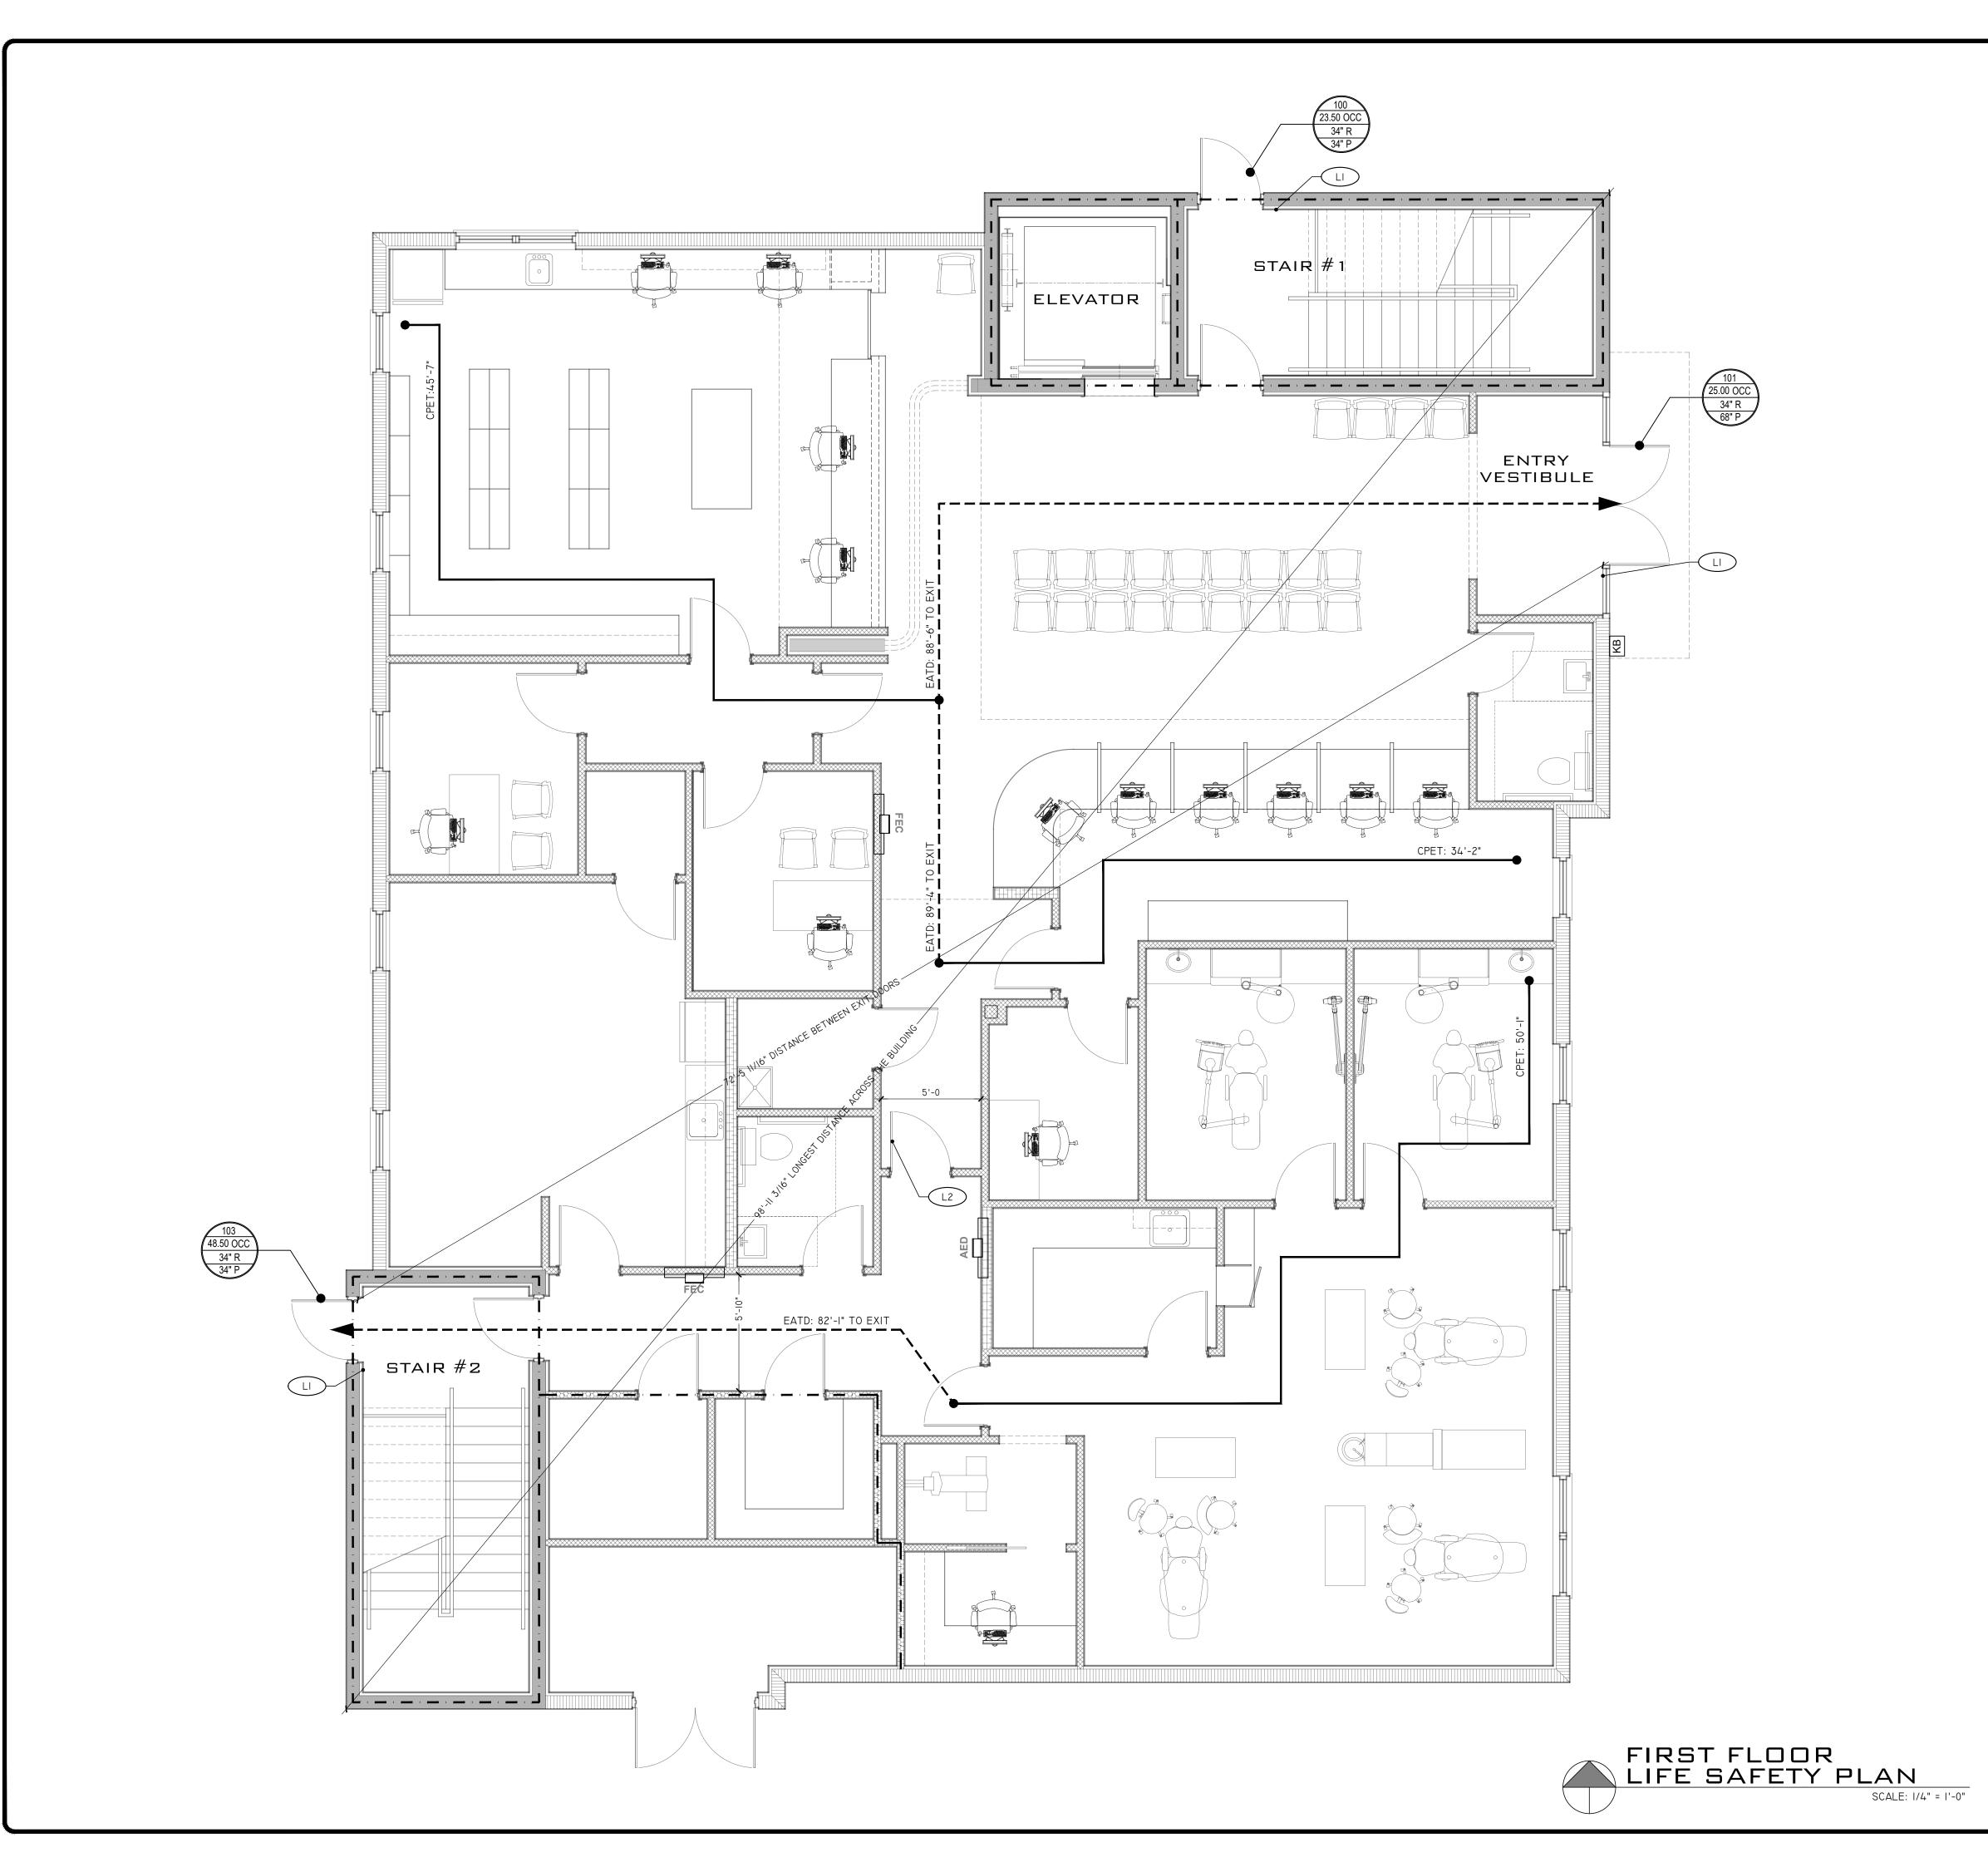
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SHEET TITLE

ARCHITECTURAL SITE PLAN

SHEET NUMBER

G2.00




LIFE SAFETY PLAN NOTES

GENERAL NOTES:


THIS BUILDING HAS (2) TWO EXIT STAIRS FOR (2) TWO MEANS OF EGRESS FROM THE SECOND FLOOR. ON THE FIRST FLOOR, (3) THERE ARE THREE MEANS OF EGRESS.

LIFE SAFETY LEGEND

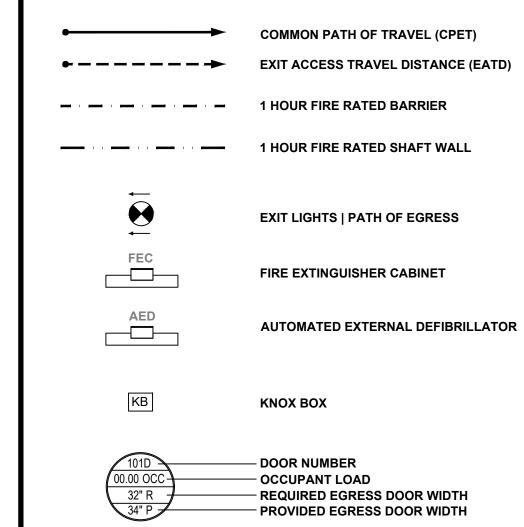

LIFE SAFETY NOTES:

- EXIT DOOR TACTILE SIGNAGE PER THE FFPC 101:7.10.1.3 AND ACCESSIBLE AND USABLE BUILDINGS AND FACILITIES, SECTION 703. SEE DETAIL
- DELAYED EGRESS DOOR PER FBC-B 1010.1.9.8. THE DELAYED EGRESS LOCKING SYSTEM MUST MEET THE REQUIREMENTS OF FBC-B 1010.1.9.8.1

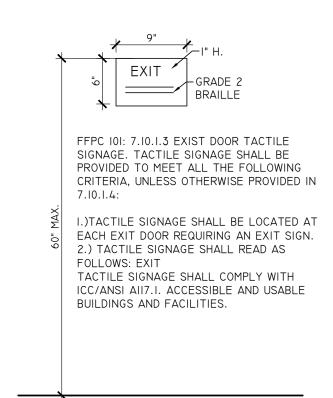

TACTILE EXIT SIGN

SCALE: NOT TO SCALE

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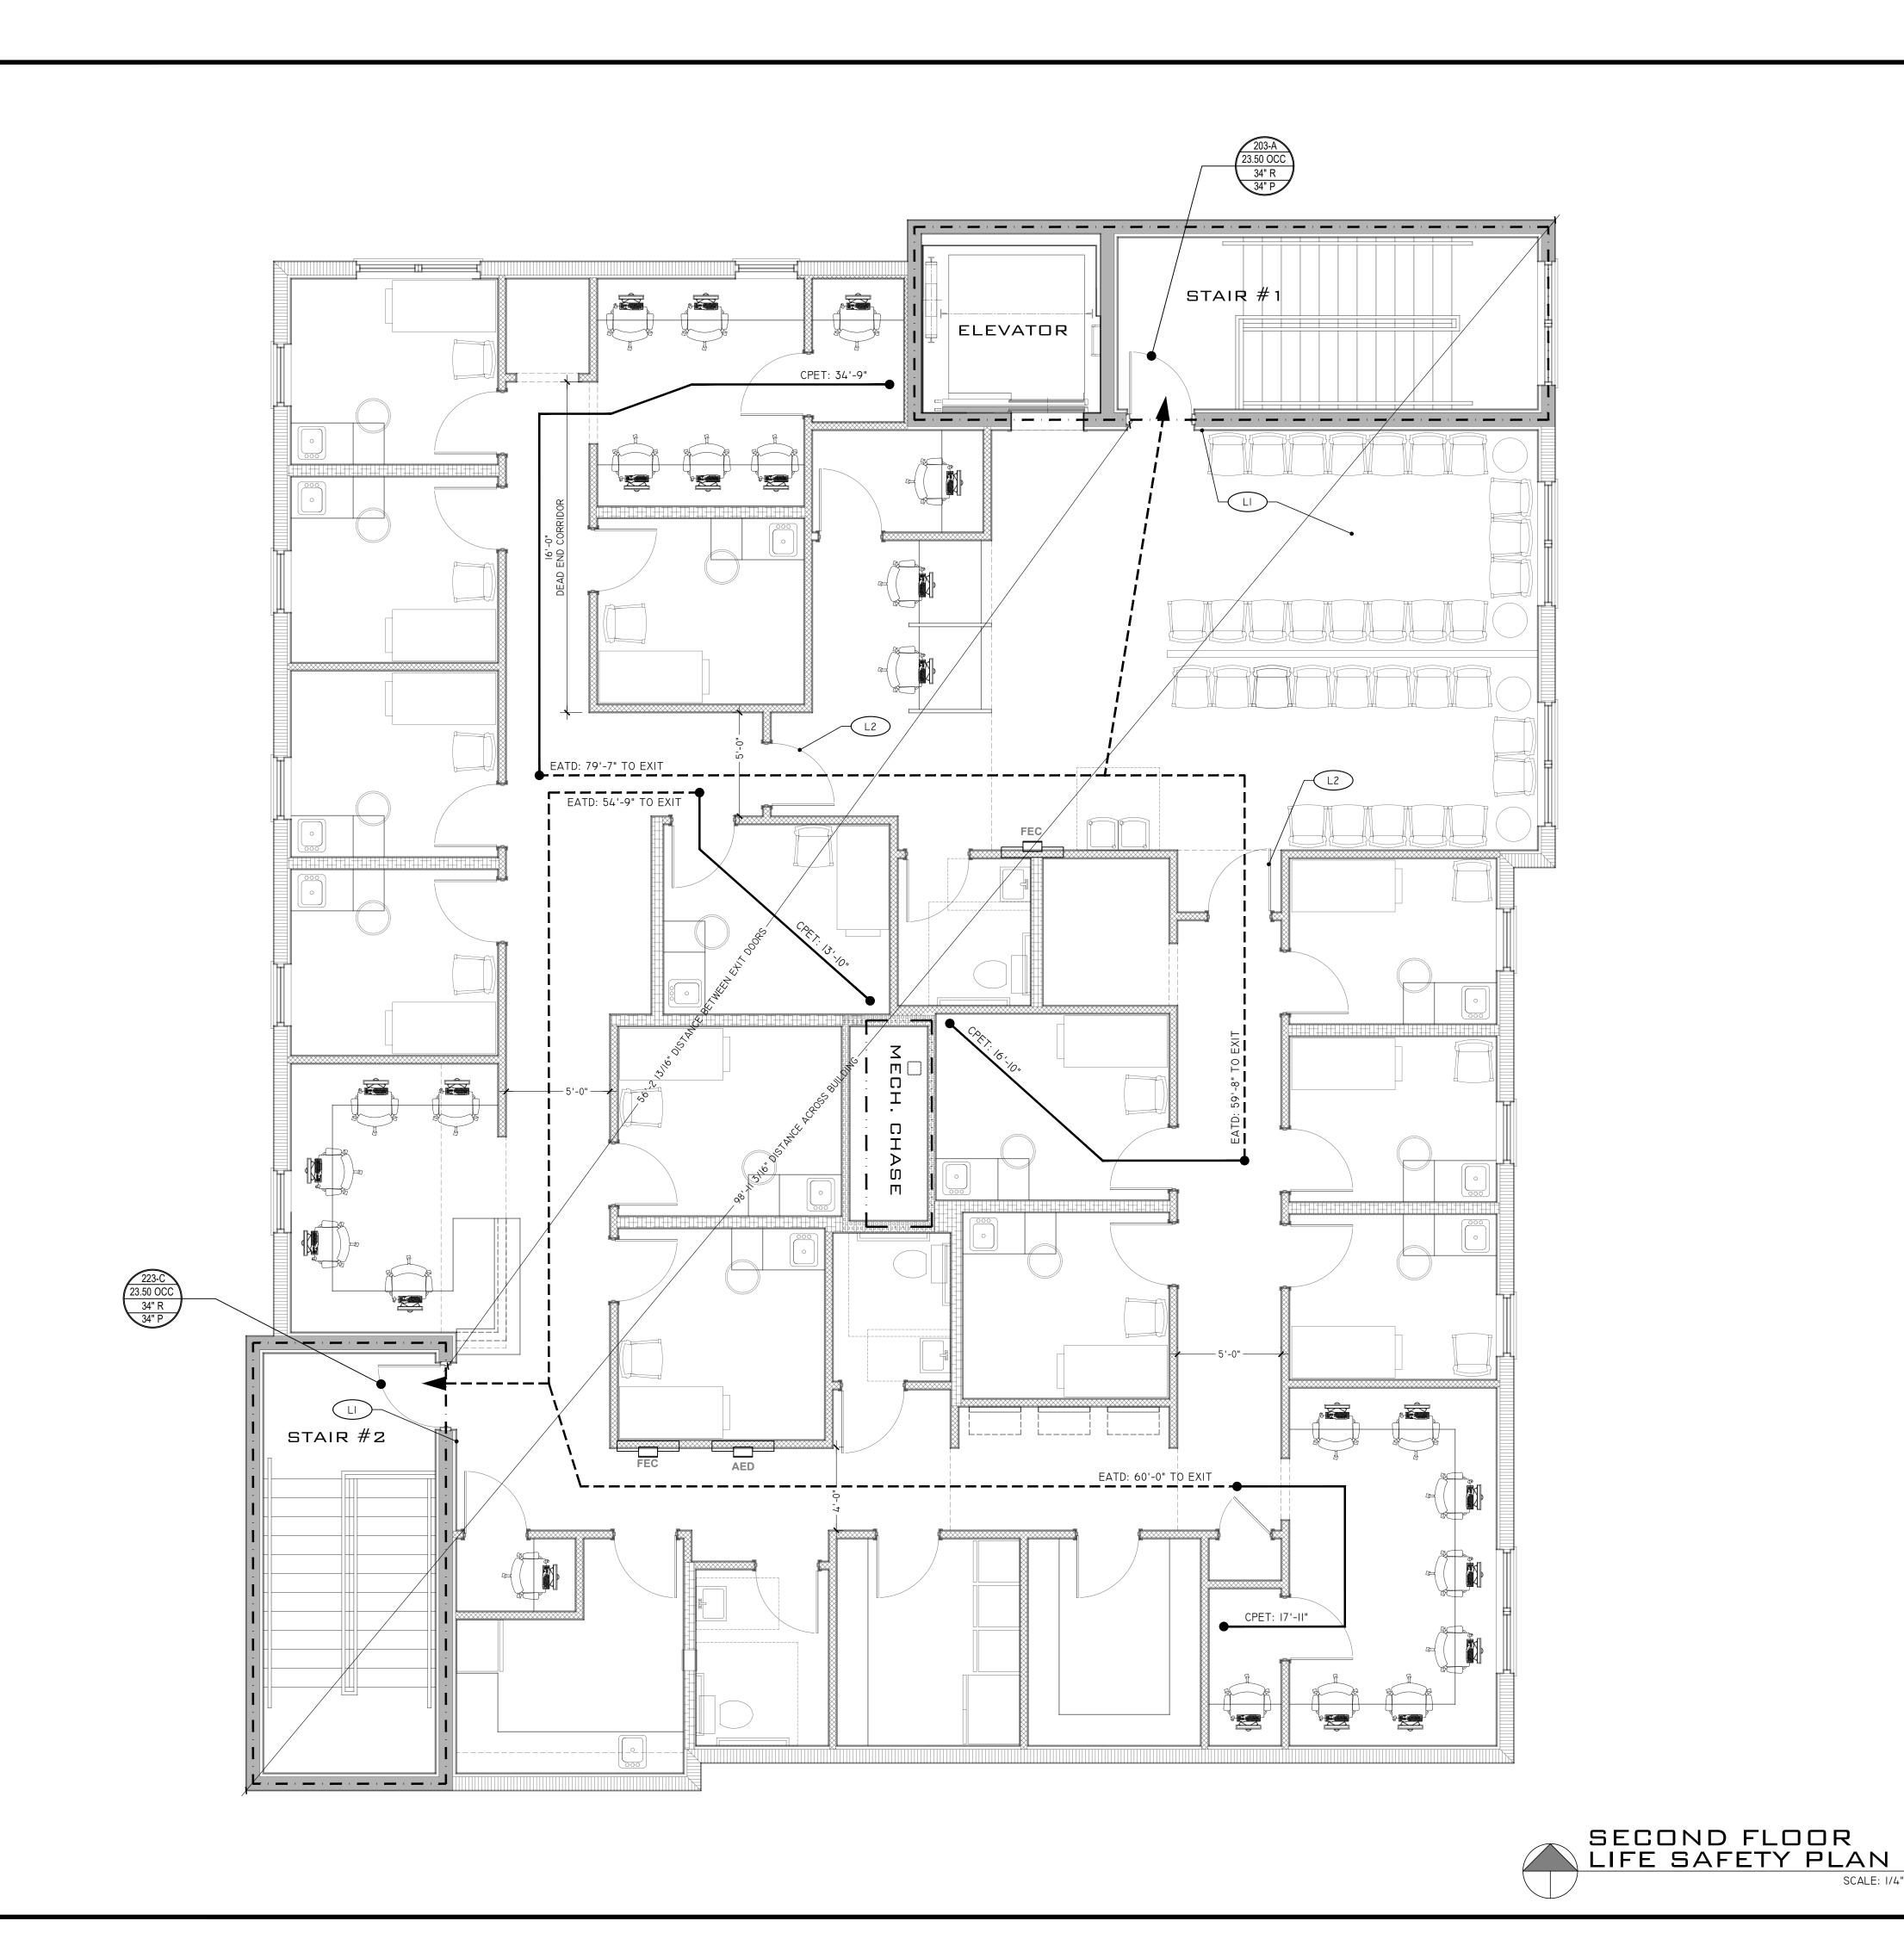
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SHEET TITLE

FIRST FLOOR LIFE SAFETY PLAN

SHEET NUMBER

G3.01




LIFE SAFETY PLAN NOTES

GENERAL NOTES:


THIS BUILDING HAS (2) TWO EXIT STAIRS FOR (2) TWO MEANS OF EGRESS FROM THE SECOND FLOOR. ON THE FIRST FLOOR, (3) THERE ARE THREE MEANS OF EGRESS.

LIFE SAFETY LEGEND

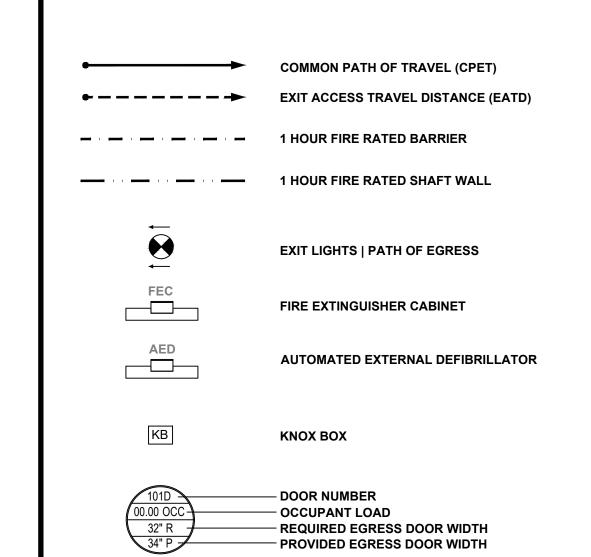

LIFE SAFETY NOTES:

- EXIT DOOR TACTILE SIGNAGE PER THE FFPC 101:7.10.1.3 AND ACCESSIBLE EXIT DOOR TACTILE SIGNAGE PER THE FFPC 101:7.10.1.3 AND ACCESSII AND USABLE BUILDINGS AND FACILITIES, SECTION 703. SEE DETAIL
- DELAYED EGRESS DOOR PER FBC-B 1010.1.9.8. THE DELAYED EGRESS LOCKING SYSTEM MUST MEET THE REQUIREMENTS OF FBC-B 1010.1.9.8.1

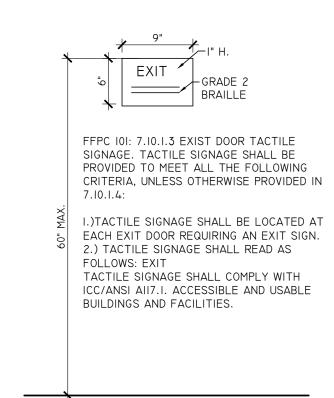

SCALE: 1/4" = 1'-0"

TACTILE EXIT SIGN

SCALE: NOT TO SCALE

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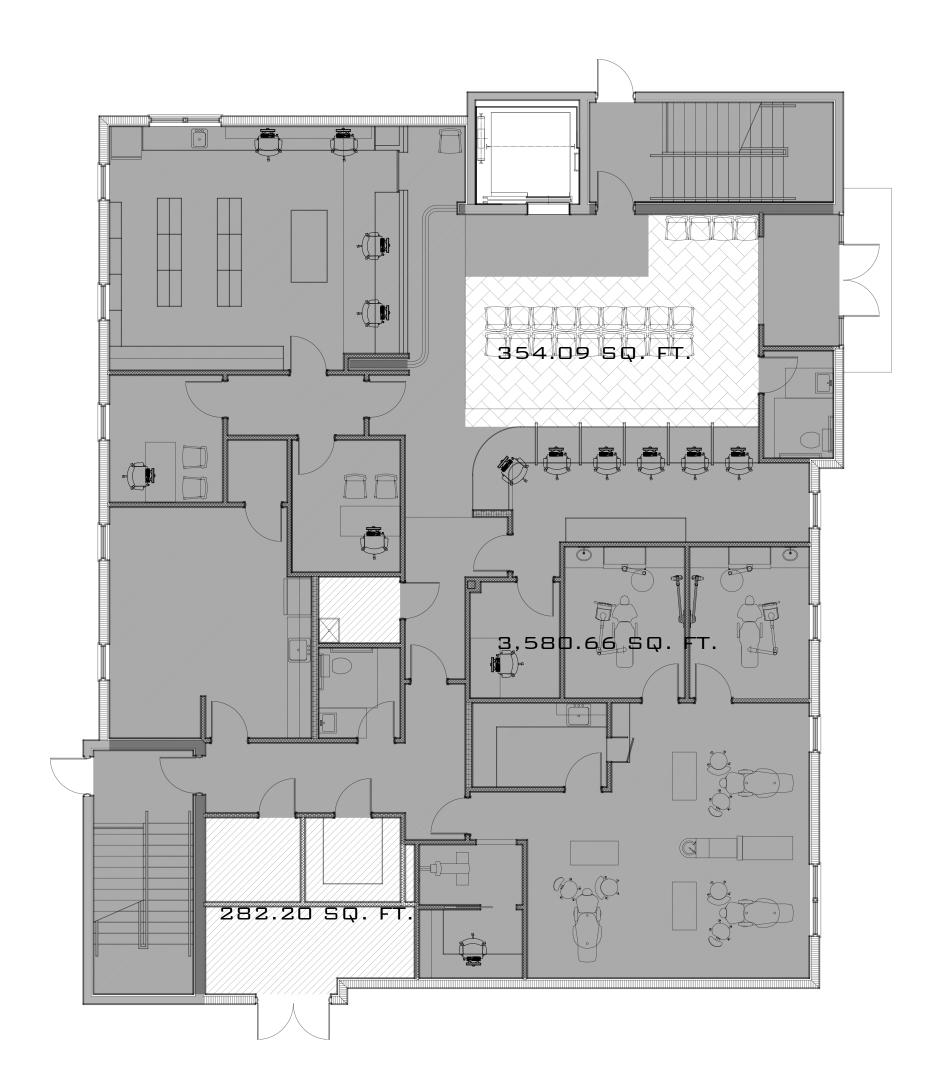
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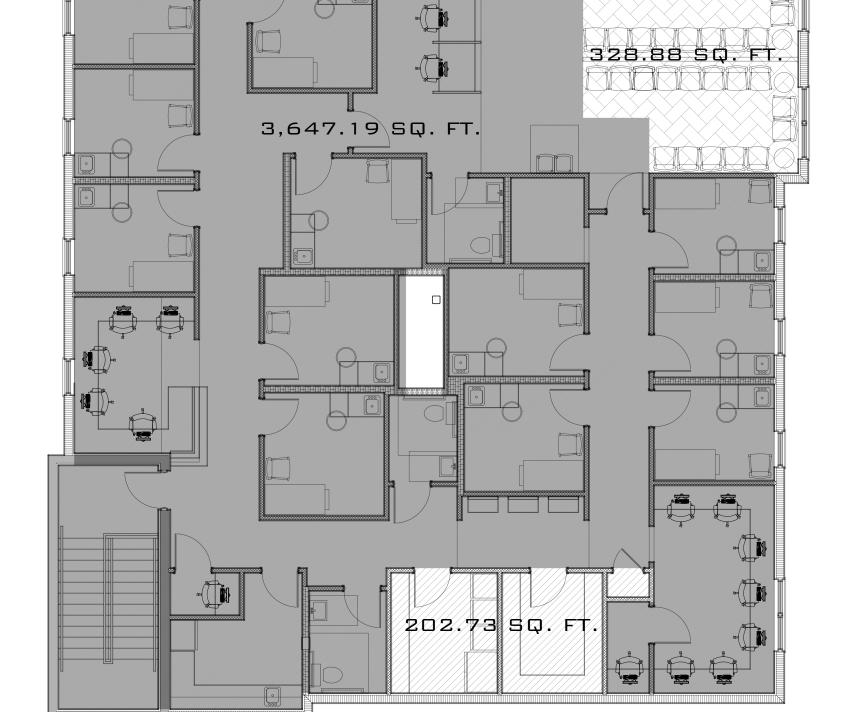
SHEET TITLE

SECOND FLOOR LIFE SAFETY PLAN

SHEET NUMBER

G3.02











LIFE SAFETY PLAN NOTES

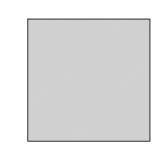

BUSINESS



STORAGE

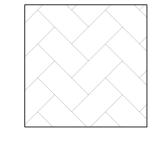

WAITING AREA

Studio ARCHITECTURE

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REVARD HEALTH ALLIANC SILVER PALM LOCATION

SEAL

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SHEET TITLE

FIRST & SECOND


FLOOR

SHEET NUMBER

G3.03

OCCUPANCY PLAN

LAYER OF \(\frac{5}{8} \) GREEN BOARD.

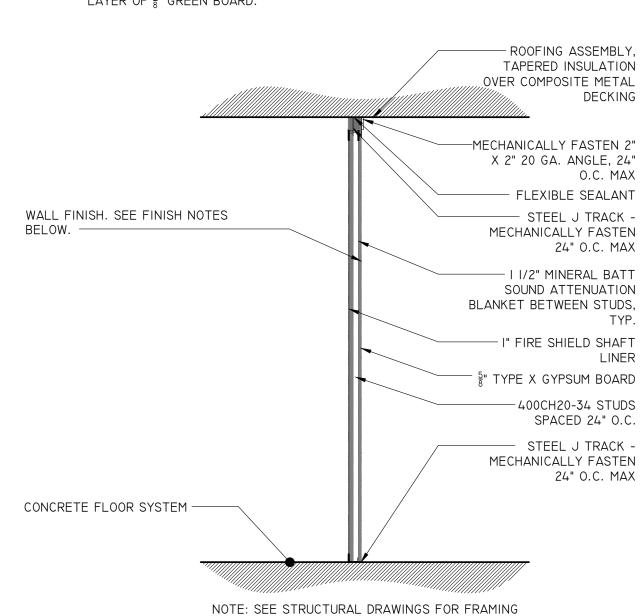


SEE PAINT SPECIFICATIONS FOR MORE INFORMATION.

BATHROOM SIDE: ONE (I) LAYER OF $\frac{5}{8}$ " A.F.F., FINISHED WITH TILE (SEE FINISH SCHEDULE FOR TILE SPECIFICATION). ABOVE TILE FINISH, FINISH WALL WITH ONE (I) LAYER OF $\frac{5}{8}$ " GREEN BOARD, OVER FIRE

REQUIREMENTS FOR WALLS TALLER THAN 10'-0. SYSTEM DESCRIPTION:

-ONE LAYER OF 5/8" TYPE "X" GYP. BD. ON CEMENT BOARD OVER FIRE WALL, UP TO 48" -ONE LAYER OF I" FIRE RATED SHAFT LINER. -MIN. 400CH20-34 STUDS SPACED @ 24" O.C.

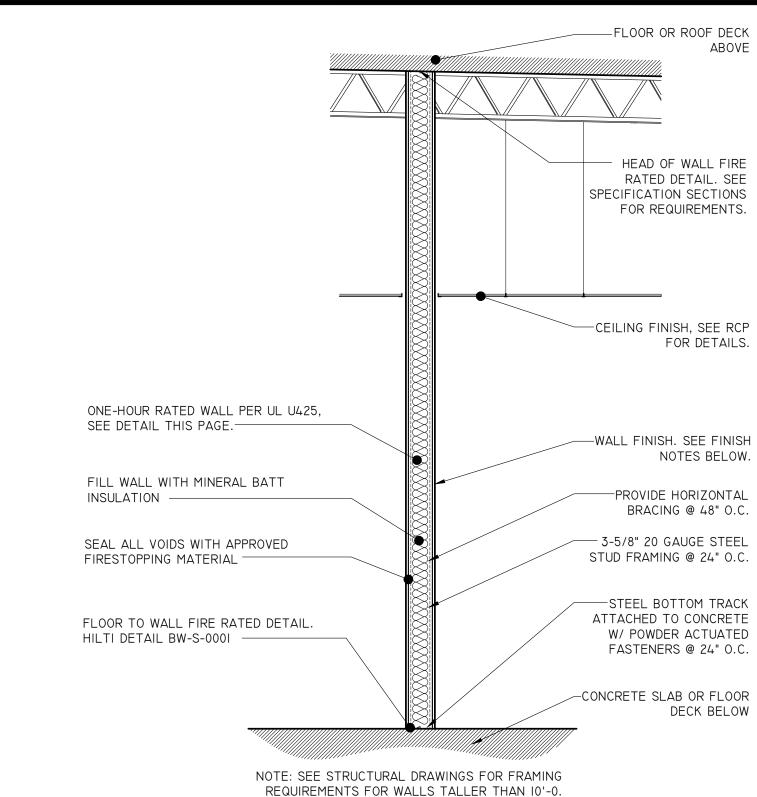


I-HOUR FIRE RATED WALL; UL U425

SYSTEM DESCRIPTION: -ONE LAYERS OF 5/8" TYPE "X" GYP. BD. EACH SIDE. -MIN. 3- $\frac{5}{8}$ " 20 GA. METAL STUDS @ 16" O.C. (SEE STRUCTURAL DRAWINGS FOR MORE INFORMATION. -MINERAL BATT INSULATION.

UL DESIGN No. UL425

SCALE: N.T.S.

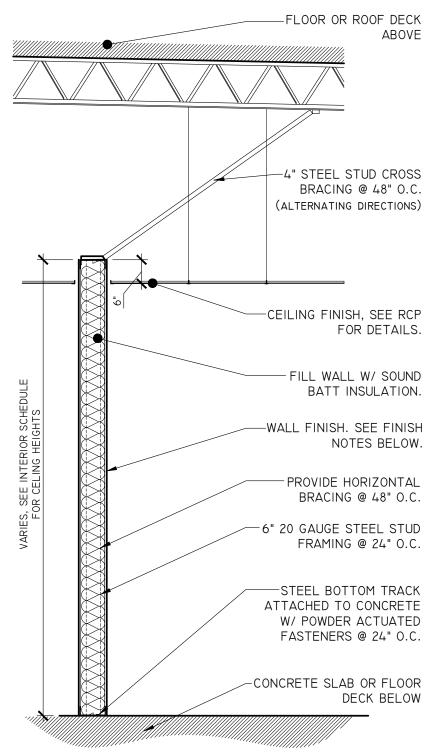

 SEE ADDITIONAL FRAMING DETAILS AND NOTES THIS PAGE. NOTE: SEE STRUCTURAL DRAWINGS FOR FRAMING REQUIREMENTS FOR WALLS TALLER THAN 10'-0.

JANITOR SIDE: FINISH WALL WITH FRP BOARD OVER 5" CEMENT

BREAK ROOM SIDE: FINISH WALL WITH $\frac{5}{8}$ " GYPSUM BOARD. FINISH AREA BETWEEN BASE CABINET AND UPPER CABINET WITH BACKSPLASH TILE. SEE FINISH SCHEDULE FOR TILE SPECIFICATION.

BATHROOM SIDE: ONE (I) LAYER OF $\frac{5}{8}$ " CEMENT BOARD UP TO 48" A.F.F., FINISHED WITH TILE (SEE FINISH SCHEDULE FOR TILE SPECIFICATION). ABOVE TILE FINISH, FINISH WALL WITH ONE (I) LAYER OF \(\frac{5}{8} \)" GREEN BOARD.

BREAK ROOM SIDE: FINISH WALL WITH $\frac{5}{8}$ " GYPSUM BOARD. FINISH AREA BETWEEN BASE CABINET AND UPPER CABINET WITH BACKSPLASH TILE. SEE FINISH SCHEDULE FOR TILE



FINISH BOTH SIDES WITH $\frac{5}{8}$ " GYPSUM BOARD AND PAINT. SEE PAINT SPECIFICATIONS FOR MORE INFORMATION.




FINISH BOTH SIDES WITH $\frac{5}{8}$ GYPSUM BOARD AND PAINT. SEE PAINT SPECIFICATIONS FOR MORE INFORMATION.



SANITARY ROOM SIDE: FINISH WALL BETWEEN BASE CABINET AND UPPER CABINET WITH FRP BOARD. SEE FINISH SCHEDULE FOR FRP

PAINT. SEE PAINT SPECIFICATIONS FOR MORE INFORMATION.


BATHROOM SIDE: ONE (I) LAYER OF $\frac{5}{8}$ " CEMENT BOARD UP TO 48" A.F.F., FINISHED WITH TILE (SEE FINISH SCHEDULE FOR TILE SPECIFICATION). ABOVE TILE FINISH, FINISH WALL WITH ONE (I)

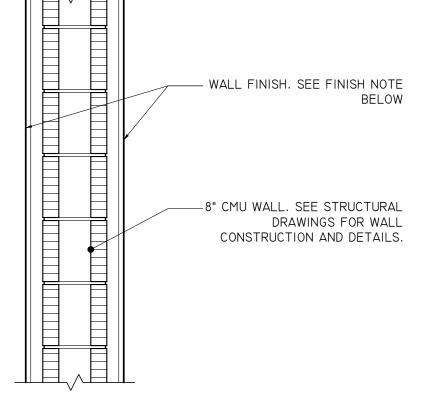

FIRE RESISTANCE CALCULATION OF CALCAREOUS OR SILICEOUS GRAVEL CMU PER FBC 721.1(2)

EQUIVALENT THICKNESS = (0.53)(7.625) = 4.04" REQUIRED THICKNESS FOR 2 HR RATING = 2.8"

FIRE RATING OF 8" HOLLOW BLOCK: 1.75 HR.

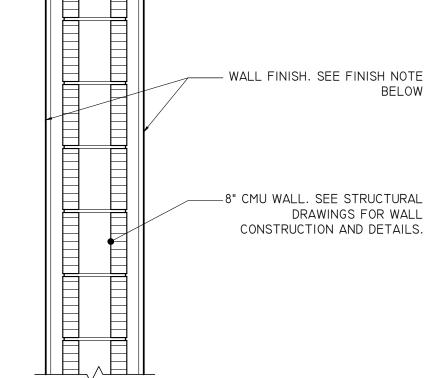

EXTERIOR SIDE: SEE EXTERIOR ELEVATIONS FOR FINISH DETAILS.

INTERIOR SIDE: 5" GYPSUM BOARD, OVER I-I/2" 20 GA. HAT CHANNEL @ 16" O.C., OVER I" RIGID INSULATION.



FINISH BOTH SIDES WITH $\frac{5}{8}$ " GYPSUM BOARD, OVER I-I/2" 20 GA. HAT CHANNEL @ 16" O.C. AND PAINT. SEE PAINT SPECIFICATIONS FOR MORE INFORMATION.

GENERALS NOTES

- I. PARTITION TYPES APPLY TO INTERIOR PARTITIONS ONLY. 2. REFERENCE REFLECTED CEILING PLANS AND LIFE SAFETY PLANS TO DETERMINE
- FIRE RATING REQUIREMENTS. FIRE RATED NOTATION SUPERSEDE HEAD CONDITION
- 3. GENERAL CONTRACTOR IS RESPONSIBLE FOR CONSTRUCTING THE COMPLETE ASSEMBLY OF ALL FIRE RATED PARTITIONS IN FULL ACCORDANCE WITH UL LISTING.
- 4. PARTITIONS SHALL BE COORDINATED WITH SCHEDULED FINISHES FOR PARTITION LAYOUT AND REQUIRED CLEARANCES.
- 5. PROVIDE BLOCKING IN PARTITIONS FOR WALL SUPPORTED ELEMENTS INCLUDING BUT NOT LIMITED TO ARCHITECTURAL WOODWORK, ACCESSORIES, FURNITURE, ART, AV
- 6. CONTRACTOR TO CONFIRM STUD SIZING AND SPACING PER CRITERIA IN SPECIFICATIONS AND MANUFACTURER'S SPECIFICATIONS.

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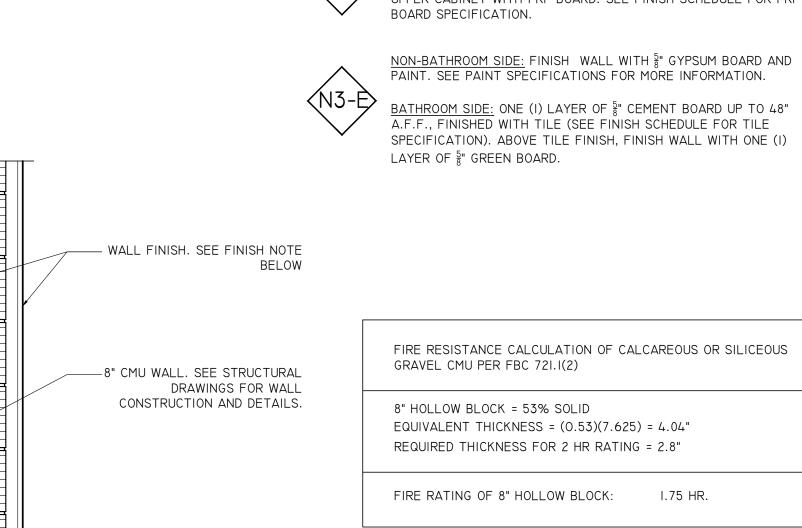
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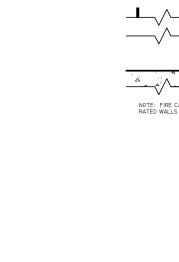
DATE: 2023-09-25


SHEET TITLE

WALL **DETAILS**

SHEET NUMBER






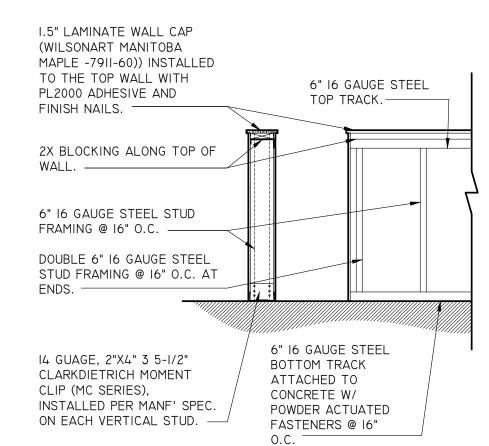

HALF WALL DETAIL

UL DESIGN No. U415

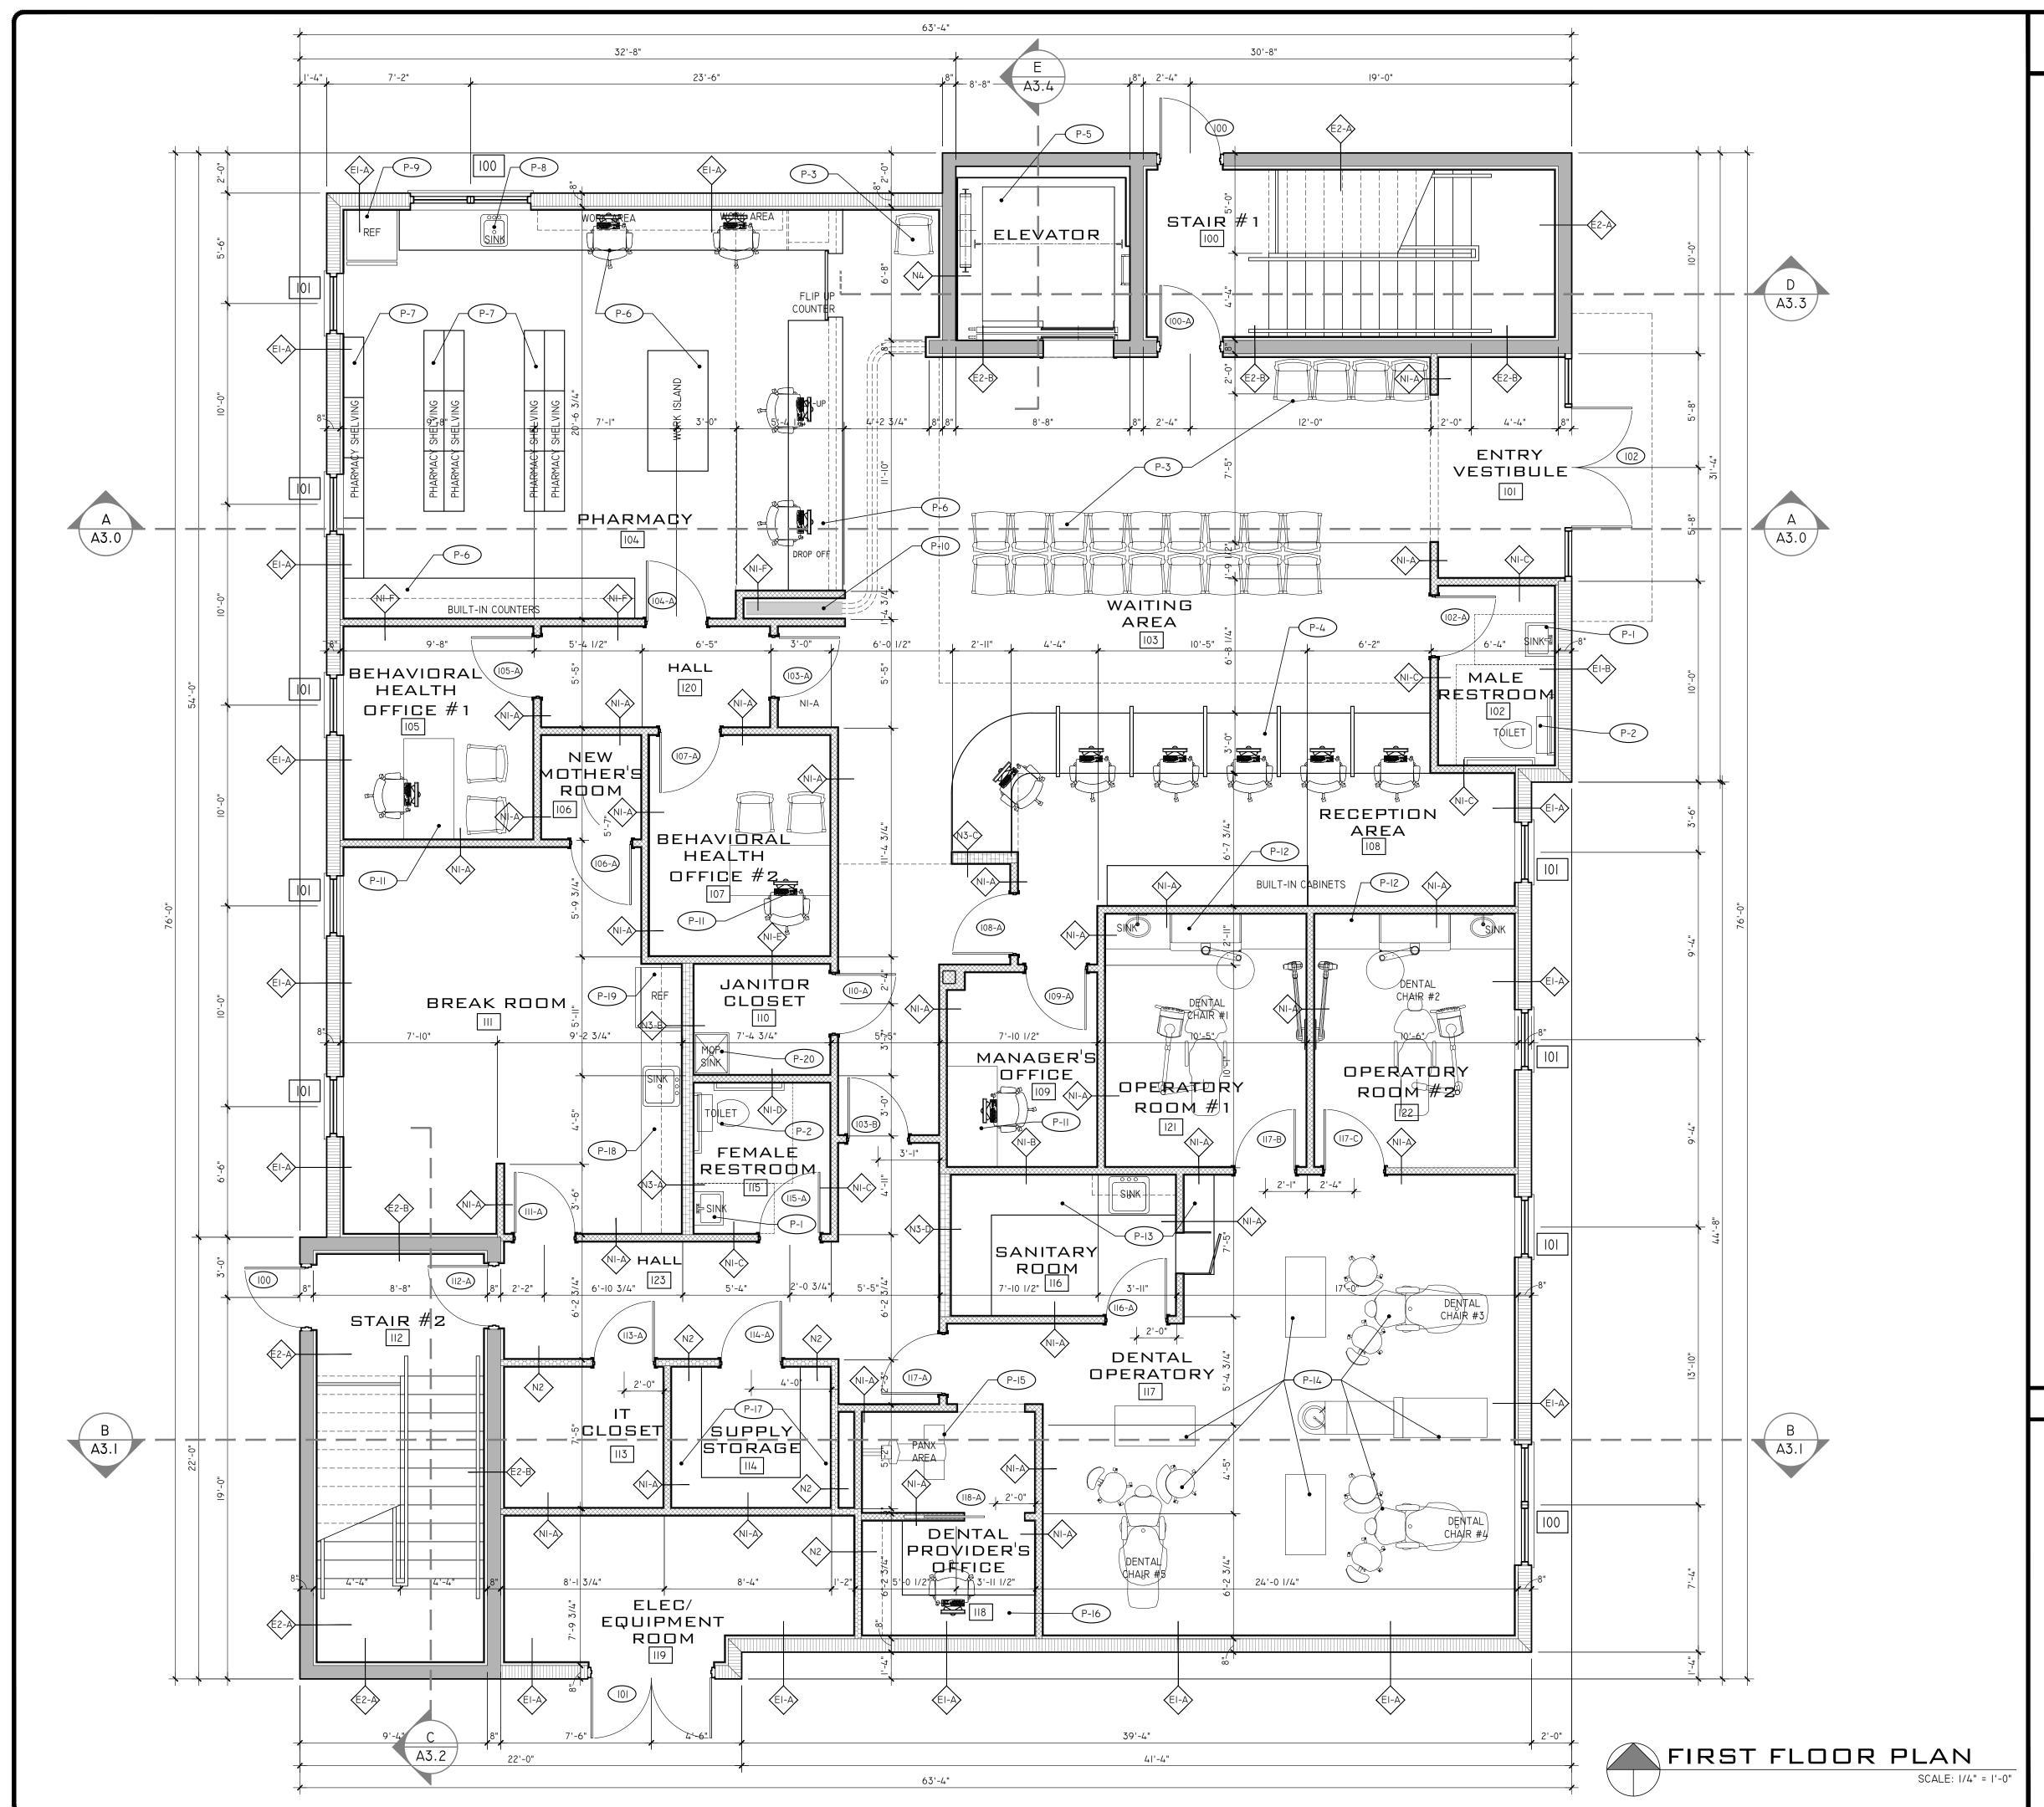

FLOOR PLAN NOTES

GENERAL NOTES:

- REFERENCE ARCHITECTURAL SPECIFICATION SHEET A0.2 FOR GENERAL CONSTRUCTION
- INFORMATION RELATED TO THE PROJECT.
- 2. EACH CONTRACTOR SHALL VERIFY ALL DIMENSIONS SHOWN ON THE DRAWING AND OBTAIN ALL MEASUREMENTS REQUIRED FOR PROPER EXECUTION OF WORK. DO NOT SCALE PLANS. CONTACT ARCHITECT FOR ANY ADDITIONAL INFORMATION OR DIMENSIONS REQUIRED.
- . DIMENSIONS ARE TAKEN FROM STRUCTURAL ELEMENTS ONLY. INTERIOR DIMENSIONS ARE TAKEN FROM ONE SIDE OF THE WALL. REFER TO WALL SCHEDULE FOR WALL THICKNESS AND CONSTRUCTION.
- +. PROVIDE WOOD BLOCKING AS REQUIRE FOR INSTALLATION OF CABINETS, EQUIPMENT, FIXTURES, BATHROOM ACCESSORIES AND AROUND WINDOWS AND DOORS.
- 5. DETAILED DRAWINGS AND LARGER SCALE DRAWINGS TAKE PRECEDENCE OVER SMALL SCALE DRAWINGS.
- 6. FOR CONSTRUCTION DETAILS NOT SHOWN, USE THE PRODUCT MANUFACTURER'S WRITTEN INSTALLATION INSTRUCTIONS AND STANDARD DETAILS, IN STRICT ACCORDANCE WITH THE
- PROJECT SPECIFICATIONS REQUIREMENTS AND DESIGN INTENT GYPSUM BOARD SHALL BE INSTALLED PER ASTM C840-I8 AND AS SPECIFIED PER THE
- MANUFACTURER'S SPECIFICATIONS. UNLESS OTHERWISE NOTE, INTERIOR GYPSUM BOARD WALLS SHALL BE FINISHED TO LEVEL 5.
- CONTRACTOR TO COORDINATE ALL ELECTRICAL AND PLUMBING ELEMENTS WITH CABINET CONTRACTOR PRIOR TO INSTALLING.

. WALL CABINETRY TO BE PROVIDED BY OWNER OR CONTRACTOR SELECTED CABINET CONTRACTOR.

- 9. MILLWORK SHALL BE INSTALLED PER THE ARCHITECTURAL MILLWORK INSTITUTE STANDARDS AND MANUFACTURE'S SPECIFICATIONS.
- 10. ALL APPLIANCES TO BE PROVIDED BY INTERIOR DESIGNER, APPLIANCE CONTRACTOR OR OTHER. COORDINATE ALL CABINET MILLWORK, ELECTRICAL LOCATIONS AND PLUMBING LINES WITH SELECTED APPLIANCES.
- I. SEE STRUCTURAL, MECHANICAL, ELECTRICAL AND PLUMBING PERMIT DRAWINGS FOR ADDITIONAL INFORMATION.

PLAN NOTES:

- SEE MECHANICAL, ELECTRICAL AND PLUMBING ENGINEERING DRAWINGS FOR ADDITIONAL INSTALLATION REQUIREMENTS.
- ACCESSIBLE LAVATORY. SEE PLUMBING DRAWING FOR SPECIFICATION. SEE SHEET A0.3 FOR ADA $^\prime$ INSTALLATION REQUIREMENTS. INSTALL PER MANUFACTURER'S SPECIFICATION.
- ACCESSIBLE TOILET. SEE PLUMBING DRAWING FOR SPECIFICATION. SEE SHEET A0.3 FOR ADA
- P-3 WAITING ROOF CHAIR. ALL FF&E ITEMS TO BE PROVIDED BY BREVARD HEALTH ALLIANCE. NOT PART OF CONTRACTOR'S SCOPE OF WORK.

P-2 INSTALLATION REQUIREMENTS. INSTALL PER MANUFACTURER'S SPECIFICATION.

- P-4 BUILT-IN RECEPTION DESK. SEE INTERIOR CABINET DETAILS SHEET SERIES A6 FOR MORE INFORMATION.
- (P-5) ELEVATOR: SCHINDLER 3100 MRL TRACTION ELEVATOR.
- P-6 BUILT-IN PHARMACY CABINETS. SEE INTERIOR CABINET DETAILS SHEET SERIES A6 FOR MORE INFORMATION.
- P-7 PHARMACY SHELVING. TO BE PROVIDED BY BREVARD HEALTH ALLIANCE. NOT PART OF CONTRACTOR'S SCOPE OF WORK.
- P-8 SINK. SEE PLUMBING DRAWING FOR SPECIFICATION. CONTRACTOR TO COORDINATE WITH CABINET SUBCONTRACTOR FOR SINK INSTALLATION. INSTALL PER MANUFACTURER'S SPECIFICATION.
- P-9 REFRIGERATOR; TO BE PROVIDED BY BREVARD HEALTH ALLIANCE. COORDINATE REFRIGERATOR SIZE WITH CABINET DRAWINGS. (DRAWING SHOWS 30" WIDE REFRIGERATOR).
- PHARMACY SHUTTER: QMI SECURITY SOLUTIONS; SIDE FOLDING GRILL (P-IO) SECURITY SHUTTER; Q-CLASSIC. SEE DETAIL D-18, SHEET A3.3. INSTALL

PER MANUFACTURER'S SPECIFICATIONS.

- P-II DESK AND CHAIRS. ALL FF&E ITEMS TO BE PROVIDED BY BREVARD HEALTH ALLIANCE. NOT PART OF CONTRACTOR'S SCOPE OF WORK.
- P-I2 DENTAL EXAM ROOM CABINET. TO BE PROVIDED BY BREVARD HEALTH ALLIANCE'S DENTAL EQUIPMENT PROVIDED. SEE SEPARATE SET.
- SANITARY ROOM CABINET WITH SINK. SEE INTERIOR CABINET DETAILS SHEET SERIES A6 FOR MORE
- P-13 INFORMATION. SEE PLUMBING DRAWING FOR SINK SPECIFICATION. CONTRACTOR TO COORDINATE WITH CABINET SUBCONTRACTOR FOR SINK INSTALLATION. INSTALL PER MANUFACTURER'S SPECIFICATION.
- DENTAL EQUIPMENT. TO BE PROVIDED BY BREVARD HEALTH ALLIANCE'S DENTAL EQUIPMENT PROVIDED. SEE SEPARATE SET.
- P-I5 PANX MACHINE. TO BE PROVIDED BY BREVARD HEALTH ALLIANCE. NOT PART OF CONTRACTOR'S SCOPE OF WORK.
- P-16 BUILT-IN DESK. SEE INTERIOR CABINET DETAILS SHEET SERIES A6 FOR MORE INFORMATION. INSTALL PER MANUFACTURER'S SPECIFICATION.
- SHELVING: ULINE CHROME WIRE SHELVING UNIT 48 X 18 X 86. MODEL #H-2941-86. P-17 TO BE PROVIDED BY BREVARD HEALTH ALLIANCE. NOT PART OF CONTRACTOR'S SCOPE OF WORK.
- BREAK ROOM CABINETS WITH SINK. SEE INTERIOR CABINET DETAILS SHEET SERIES A6 FOR MORE P-18 INFORMATION. SEE PLUMBING DRAWING FOR SINK SPECIFICATION. CONTRACTOR TO COORDINATE WITH CABINET SUBCONTRACTOR FOR SINK INSTALLATION. INSTALL PER MANUFACTURER'S
- REFRIGERATOR; TO BE PROVIDED BY BREVARD HEALTH ALLIANCE. (P-19) COORDINATE REFRIGERATOR SIZE WITH CABINET DRAWINGS. (DRAWING SHOWS 36" WIDE REFRIGERATOR).
- MOP SINK. SEE PLUMBING DRAWING FOR SPECIFICATION. CONTRACTOR TO COORDINATE WITH (P-20) CABINET SUBCONTRACTOR FOR SINK INSTALLATION. INSTALL PER MANUFACTURER'S SPECIFICATION.

WALL LEGEND

SPECIFICATION.

- 8" CMU WALL BEARING WALL. SEE SECTIONS FOR WALL DETAILS.
- I-HOUR RATED FIRE BARRIER. SEE WALL DETAIL, SHEET ALOI
- 3-5/8" METAL STUD WALL. SEE WALL DETAIL, SHEET AI.01.
- I-HOUR FIRE RATED WALL. SEE WALL DETAIL, SHEET AI.01.

NOTE: THE FOLLOWING ROOMS WILL RECEIVE FRP BOARD AROUND PERIMETER

(N3) 6" METAL STUD WALL. SEE WALL DETAIL, SHEET AI.01.

OF SPACE, UP TO 48" A.F.F. (SEE SPEC IN FINISH SCHEDULE)

- I.) ALL EXAM ROOMS
- 2.) MEDICAL STORAGE (222) 3.) LAB (225)
- 4.) JANITOR'S CLOSET (IIO)
- 5.) PHLEBOTOMY CLOSET (NO NUMBER) 6.) HEIGHT/ WEIGHT ROOM (210)
- 7.) DENTAL OPERATORY (II7)
- 8.) OPERATORY ROOM #1 (121)
- 9.) OPERATORY ROOM #2 (122)

ARCHITECTURE

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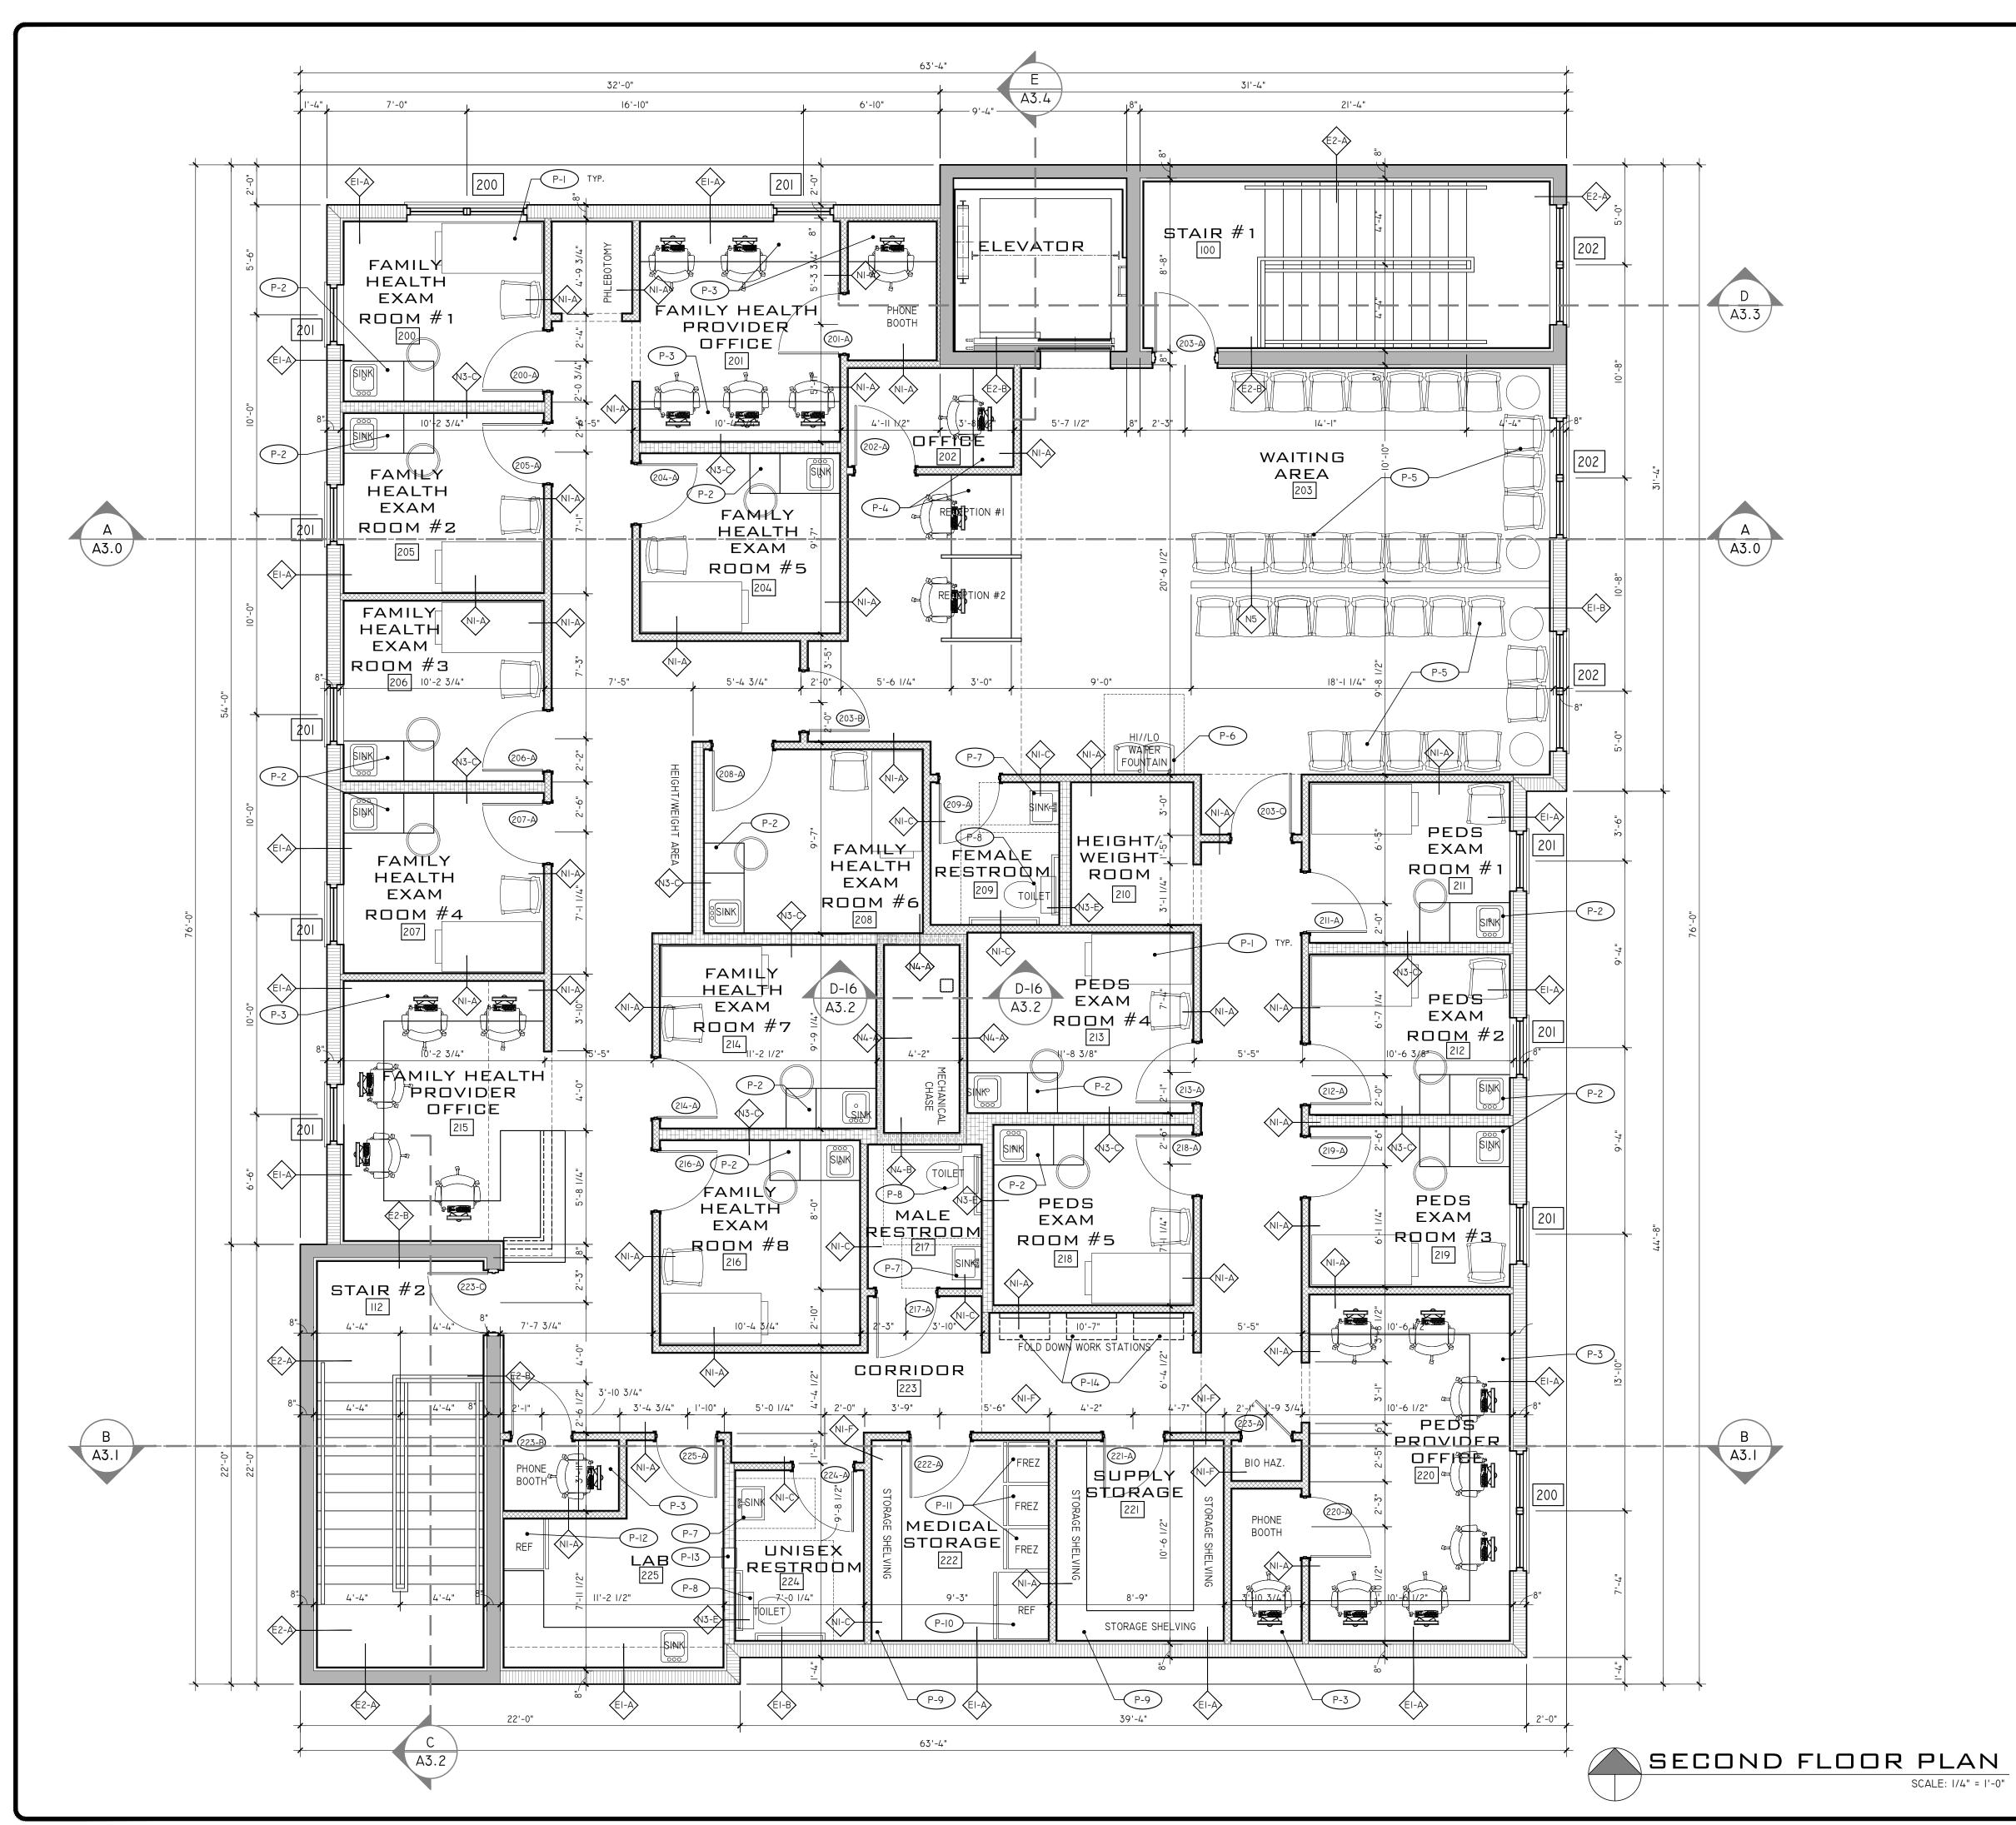
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SHEET TITLE

FIRST FLOOR



FLOOR PLAN NOTES

GENERAL NOTES:

- REFERENCE ARCHITECTURAL SPECIFICATION SHEET A0.2 FOR GENERAL
- CONSTRUCTION INFORMATION RELATED TO THE PROJECT.
- 2. EACH CONTRACTOR SHALL VERIFY ALL DIMENSIONS SHOWN ON THE DRAWING AND OBTAIN ALL MEASUREMENTS REQUIRED FOR PROPER EXECUTION OF WORK. DO NOT SCALE PLANS. CONTACT ARCHITECT FOR ANY ADDITIONAL INFORMATION OR
- DIMENSIONS REQUIRED. . DIMENSIONS ARE TAKEN FROM STRUCTURAL ELEMENTS ONLY. INTERIOR
- DIMENSIONS ARE TAKEN FROM ONE SIDE OF THE WALL. REFER TO WALL SCHEDULE FOR WALL THICKNESS AND CONSTRUCTION.
- 4. PROVIDE WOOD BLOCKING AS REQUIRE FOR INSTALLATION OF CABINETS, EQUIPMENT, FIXTURES, BATHROOM ACCESSORIES AND AROUND WINDOWS AND
- 5. DETAILED DRAWINGS AND LARGER SCALE DRAWINGS TAKE PRECEDENCE OVER
- SMALL SCALE DRAWINGS. 6. FOR CONSTRUCTION DETAILS NOT SHOWN, USE THE PRODUCT MANUFACTURER'S
- WRITTEN INSTALLATION INSTRUCTIONS AND STANDARD DETAILS, IN STRICT ACCORDANCE WITH THE PROJECT SPECIFICATIONS REQUIREMENTS AND DESIGN
- . GYPSUM BOARD SHALL BE INSTALLED PER ASTM C840-18 AND AS SPECIFIED PER THE MANUFACTURER'S SPECIFICATIONS. UNLESS OTHERWISE NOTE, INTERIOR
- GYPSUM BOARD WALLS SHALL BE FINISHED TO LEVEL 5. . WALL CABINETRY TO BE PROVIDED BY OWNER OR CONTRACTOR SELECTED CABINET CONTRACTOR. CONTRACTOR TO COORDINATE ALL ELECTRICAL AND
- PLUMBING ELEMENTS WITH CABINET CONTRACTOR PRIOR TO INSTALLING. 9. MILLWORK SHALL BE INSTALLED PER THE ARCHITECTURAL MILLWORK INSTITUTE
- STANDARDS AND MANUFACTURE'S SPECIFICATIONS. 10. ALL APPLIANCES TO BE PROVIDED BY INTERIOR DESIGNER, APPLIANCE CONTRACTOR OR OTHER. COORDINATE ALL CABINET MILLWORK, ELECTRICAL
- LOCATIONS AND PLUMBING LINES WITH SELECTED APPLIANCES. II. SEE STRUCTURAL, MECHANICAL, ELECTRICAL AND PLUMBING PERMIT DRAWINGS
- FOR ADDITIONAL INFORMATION.

PLAN NOTES:

- SEE MECHANICAL, ELECTRICAL AND PLUMBING ENGINEERING DRAWINGS FOR ADDITIONAL INSTALLATION REQUIREMENTS.
- EXAM ROOM FURNITURE. TYPICAL IN EACH EXAM ROOM. ALL FF&E ITEMS TO BE PROVIDED BY BREVARD HEALTH ALLIANCE. NOT PART OF
- P-I TO BE PROVIDED BY BILLIAM CONTRACTOR'S SCOPE OF WORK.
- BUILT-IN EXAM ROOM CABINETS. SEE INTERIOR CABINET DETAILS SHEET SERIES A6 FOR MORE P-2 INFORMATION.
- P-3 BUILT-IN EXAM DESK AND CABINETRY. SEE INTERIOR CABINET DETAILS SHEET SERIES A6 FOR MORE INFORMATION.
- BUILT-IN EXAM RECEPTION DESK. SEE INTERIOR CABINET DETAILS SHEET SERIES A6 FOR MORE INFORMATION.
- P-5 WAITING ROOF CHAIR. ALL FF&E ITEMS TO BE PROVIDED BY BREVARD HEALTH ALLIANCE. NOT PART OF CONTRACTOR'S SCOPE OF WORK.
- P-6 HI/LO WATER FOUNTAIN. SEE PLUMBING DRAWING FOR SPECIFICATION AND ADA DETAILS, SHEET GO.02 FOR MORE INFORMATION. INSTALL PER MANUFACTURER'S SPECIFICATION.
- P-7 ACCESSIBLE LAVATORY. SEE PLUMBING DRAWING FOR SPECIFICATION. SEE SHEET A0.3 FOR ADA INSTALLATION REQUIREMENTS. INSTALL PER MANUFACTURER'S SPECIFICATION.
- ACCESSIBLE TOILET. SEE PLUMBING DRAWING FOR SPECIFICATION. SEE SHEET A0.3 FOR ADA
- P-8 ACCESSIBLE TUILET. SEE FLUTIDING DIVAVITION ON OF ESTIMATION PROPERTY. INSTALL PER MANUFACTURER'S SPECIFICATION. SHELVING: ULINE CHROME WIRE SHELVING UNIT 48 X 18 X 86. MODEL #H-2941-86.
- (P-9) TO BE PROVIDED BY BREVARD HEALTH ALLIANCE. NOT PART OF CONTRACTOR'S SCOPE OF WORK.
- P-10 REFRIGERATOR; TO REFRIGERATOR). REFRIGERATOR; TO BE PROVIDED BY BREVARD HEALTH ALLIANCE. (DRAWING SHOWS 40" WIDE
- P-II FREEZER; TO BE PROVIDED BY BREVARD HEALTH ALLIANCE. (DRAWING SHOWS 24" WIDE FREZZER).
- P-I2 REFRIGERATOR; TO BE PROVIDED BY BREVARD HEALTH ALLIANCE. COORDINATE REFRIGERATOR SIZE WITH CABINET DRAWINGS. (DRAWING SHOWS 30" WIDE REFRIGERATOR).
- RECESS SPECIMEN PASS-THRU CABINET: BOBRICK RECESSED SPECIMEN PASS-THRU CABINET; MODEL
- P-I3 B-505. INSTALLED PER MANF'S SPECS. INSTALL PER MANUFACTURER'S SPECIFICATION. MOUNTING HEIGHT: 3'-0" A.F.F.
- P-I4 FOLD DOWN DESK, SEE DETAIL K , SHEET A6.2.

WALL LEGEND

(EI) 8" CMU WALL BEARING WALL. SEE SECTIONS FOR WALL D	
/ GITTO WALL BLAKING WALL. SEL SECTIONS FOR WALL B	DETAILS.

I-HOUR RATED FIRE BARRIER. SEE WALL DETAIL, SHEET ALOI

3-5/8" METAL STUD WALL. SEE WALL DETAIL, SHEET AI.01.

I-HOUR FIRE RATED WALL. SEE WALL DETAIL, SHEET AI.01.

6" METAL STUD WALL. SEE WALL DETAIL, SHEET AI.01.

I-HOUR RATED SHAFT WALL. SEE WALL DETAIL, SHEET AI.01.

N5 HALF WALL. SEE WALL DETAIL, SHEET AI.01.

NOTE: THE FOLLOWING ROOMS WILL RECEIVE FRP BOARD AROUND PERIMETER OF SPACE, UP TO 48" A.F.F. (SEE SPEC IN FINISH SCHEDULE)

- I.) ALL EXAM ROOMS
- 2.) MEDICAL STORAGE (222) 3.) LAB (225)
- 4.) JANITOR'S CLOSET (II0)
- 5.) PHLEBOTOMY CLOSET (NO NUMBER)
- 6.) HEIGHT/ WEIGHT ROOM (210) 7.) DENTAL OPERATORY (II7)
- 8.) OPERATORY ROOM #1 (121) 9.) OPERATORY ROOM #2 (122)

ARCHITECTURE

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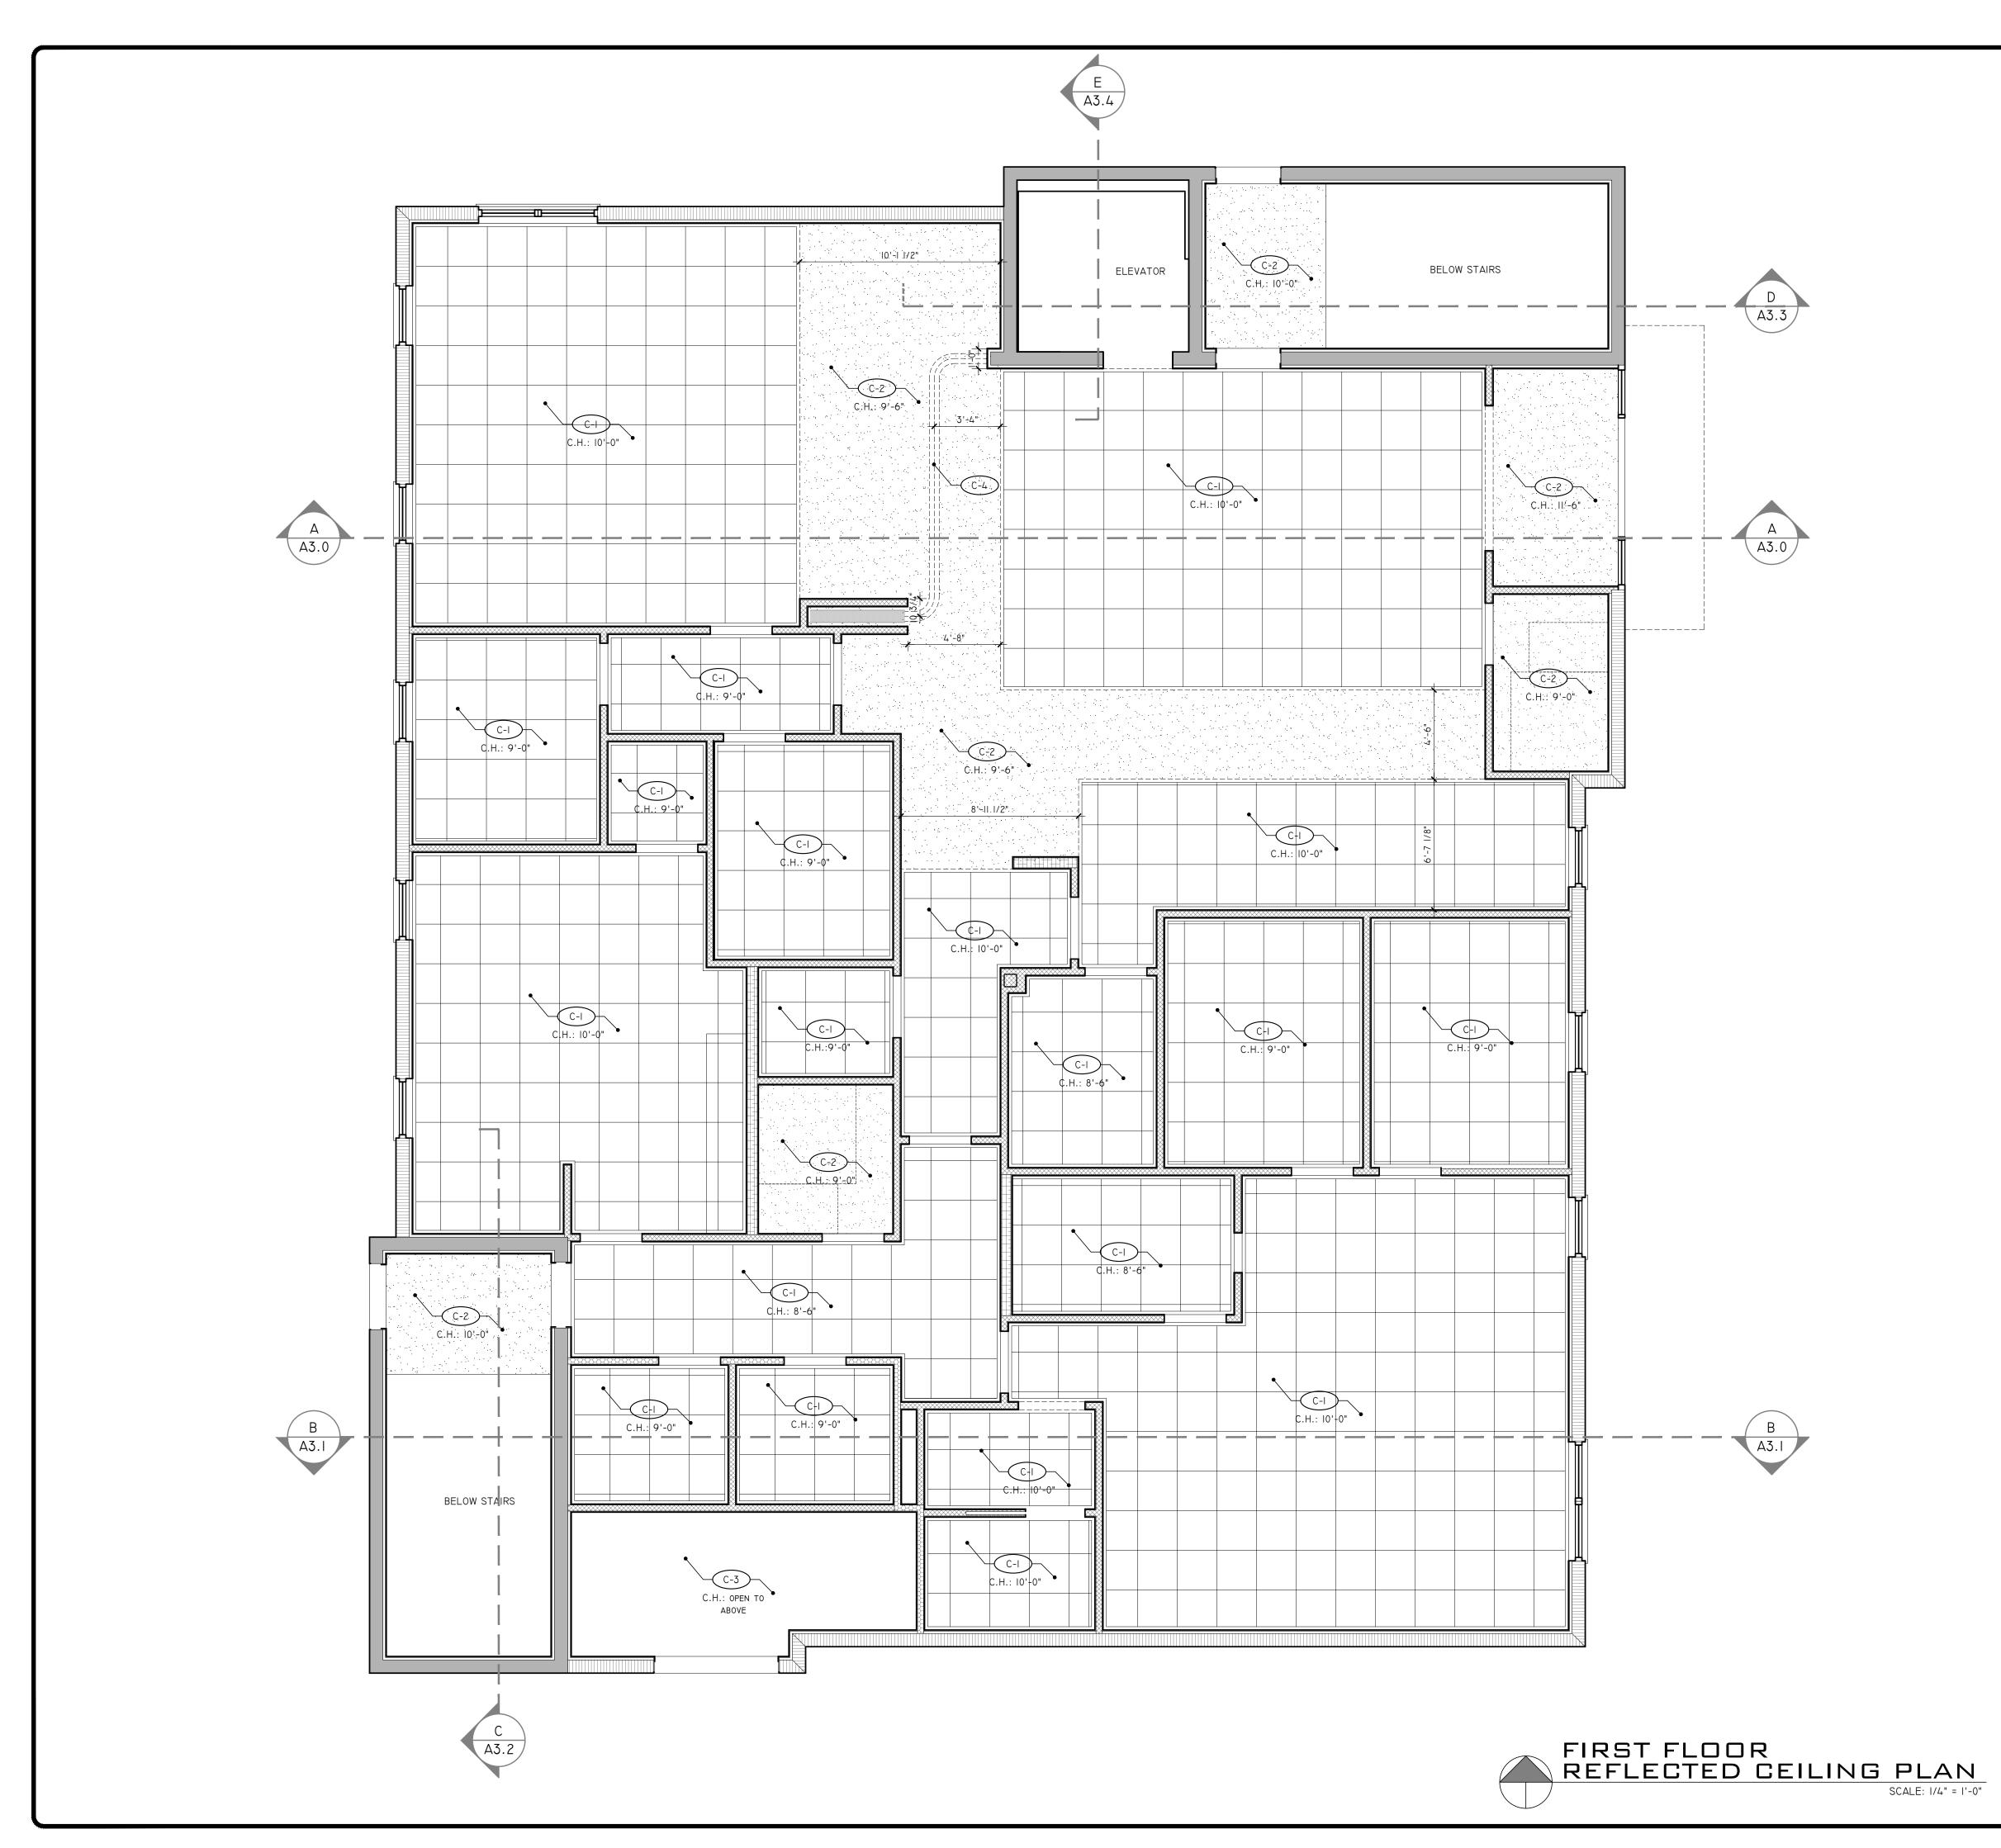
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SHEET TITLE

SECOND FLOOR



REFLECTED CEILING PLAN NOTES

GENERAL NOTES:

- I. REFERENCE ARCHITECTURAL SPECIFICATION SHEET A0.2 FOR GENERAL CONSTRUCTION INFORMATION RELATED TO THE PROJECT
- CONSTRUCTION INFORMATION RELATED TO THE PROJECT.

 2. FINISH FLOOR DATUM REFERENCES TOP OF SLAB DRAWINGS. VERIFY WITH
- SURVEY OR CIVIL ENGINEERING DRAWINGS.

 3. EACH CONTRACTOR SHALL VERIFY ALL DIMENSIONS SHOWN ON THE DRAWING AND OBTAIN ALL MEASUREMENTS REQUIRED FOR PROPER EXECUTION OF WORK. DO NOT SCALE PLANS. CONTACT ARCHITECT FOR ANY ADDITIONAL INFORMATION OR DIMENSIONS REQUIRED.
- 4. DIMENSIONS ARE TAKEN FROM STRUCTURAL ELEMENTS ONLY. INTERIOR DIMENSIONS ARE TAKEN FROM ONE SIDE OF THE WALL. REFER TO WALL
- SCHEDULE FOR WALL THICKNESS AND CONSTRUCTION.

 . DETAILED DRAWINGS AND LARGER SCALE DRAWINGS TAKE PRECEDENCE
- 5. DETAILED DRAWINGS AND LARGER SCALE DRAWINGS TAKE PRECEDENCE OVER SMALL SCALE DRAWINGS.
 6. FOR CONSTRUCTION DETAILS NOT SHOWN, USE THE PRODUCT
- MANUFACTURER'S WRITTEN INSTALLATION INSTRUCTIONS AND STANDARD DETAILS, IN STRICT ACCORDANCE WITH THE PROJECT SPECIFICATIONS REQUIREMENTS AND DESIGN INTENT.

 7. GYPSUM BOARD SHALL BE INSTALLED PER ASTM C840-18 AND AS SPECIFIED
- PER THE MANUFACTURER'S SPECIFICATIONS. UNLESS OTHERWISE NOTE, INTERIOR GYPSUM BOARD WALLS SHALL BE FINISHED TO LEVEL 5.

 8. SEE STRUCTURAL, MECHANICAL, ELECTRICAL AND PLUMBING PERMIT

PLAN NOTES:

DRAWINGS FOR ADDITIONAL INFORMATION.

- I. ITEMS NOTED BELOW REFER TO TAGS ON FLOOR PLAN. CONTRACTOR TO CONTACT ARCHITECT WITH ANY ERROR OR ISSUES WITH NOTES OR DIMENSION ON PLAN.
- 2. SEE STRUCTURAL DRAWINGS FOR ALL STRUCTURAL DETAILS AND INFORMATION.
- ACOUSTICAL CEILING GRID. SEE DETAIL THIS PAGE AND FINISH SCHEDULE FOR MORE INFORMATION. INSTALL PER MANUFACTURER'S SPECIFICATIONS.
- C-2 S" PAINTED GYPSUM BOARD CEILING OVER METAL FRAMING. LIGHT GAUGE METAL FRAMING CONTRACTOR TO PROVIDE FRAMING DETAILS FOR CEILINGS.
- C-3 PAINT STRUCTURE ABOVE. SEE FINISHED SCHEDULE FOR PAINT COLOR.
- CEILING MOUNTED SHUTTER. SEE FLOOR PLAN FOR SHUTTER SPECIFICATION. SEE DETAIL D-18, SHEET A3.3 FOR ADDITIONAL INFORMATION.
 - i-HOUR FIRE RATED LID. SEE DETAIL D-17, SHEET A3.2 FOR DETAILS.



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EVARD HEALTH ALLIANCE SILVER PALM LOCATION MELBOURNE, FL

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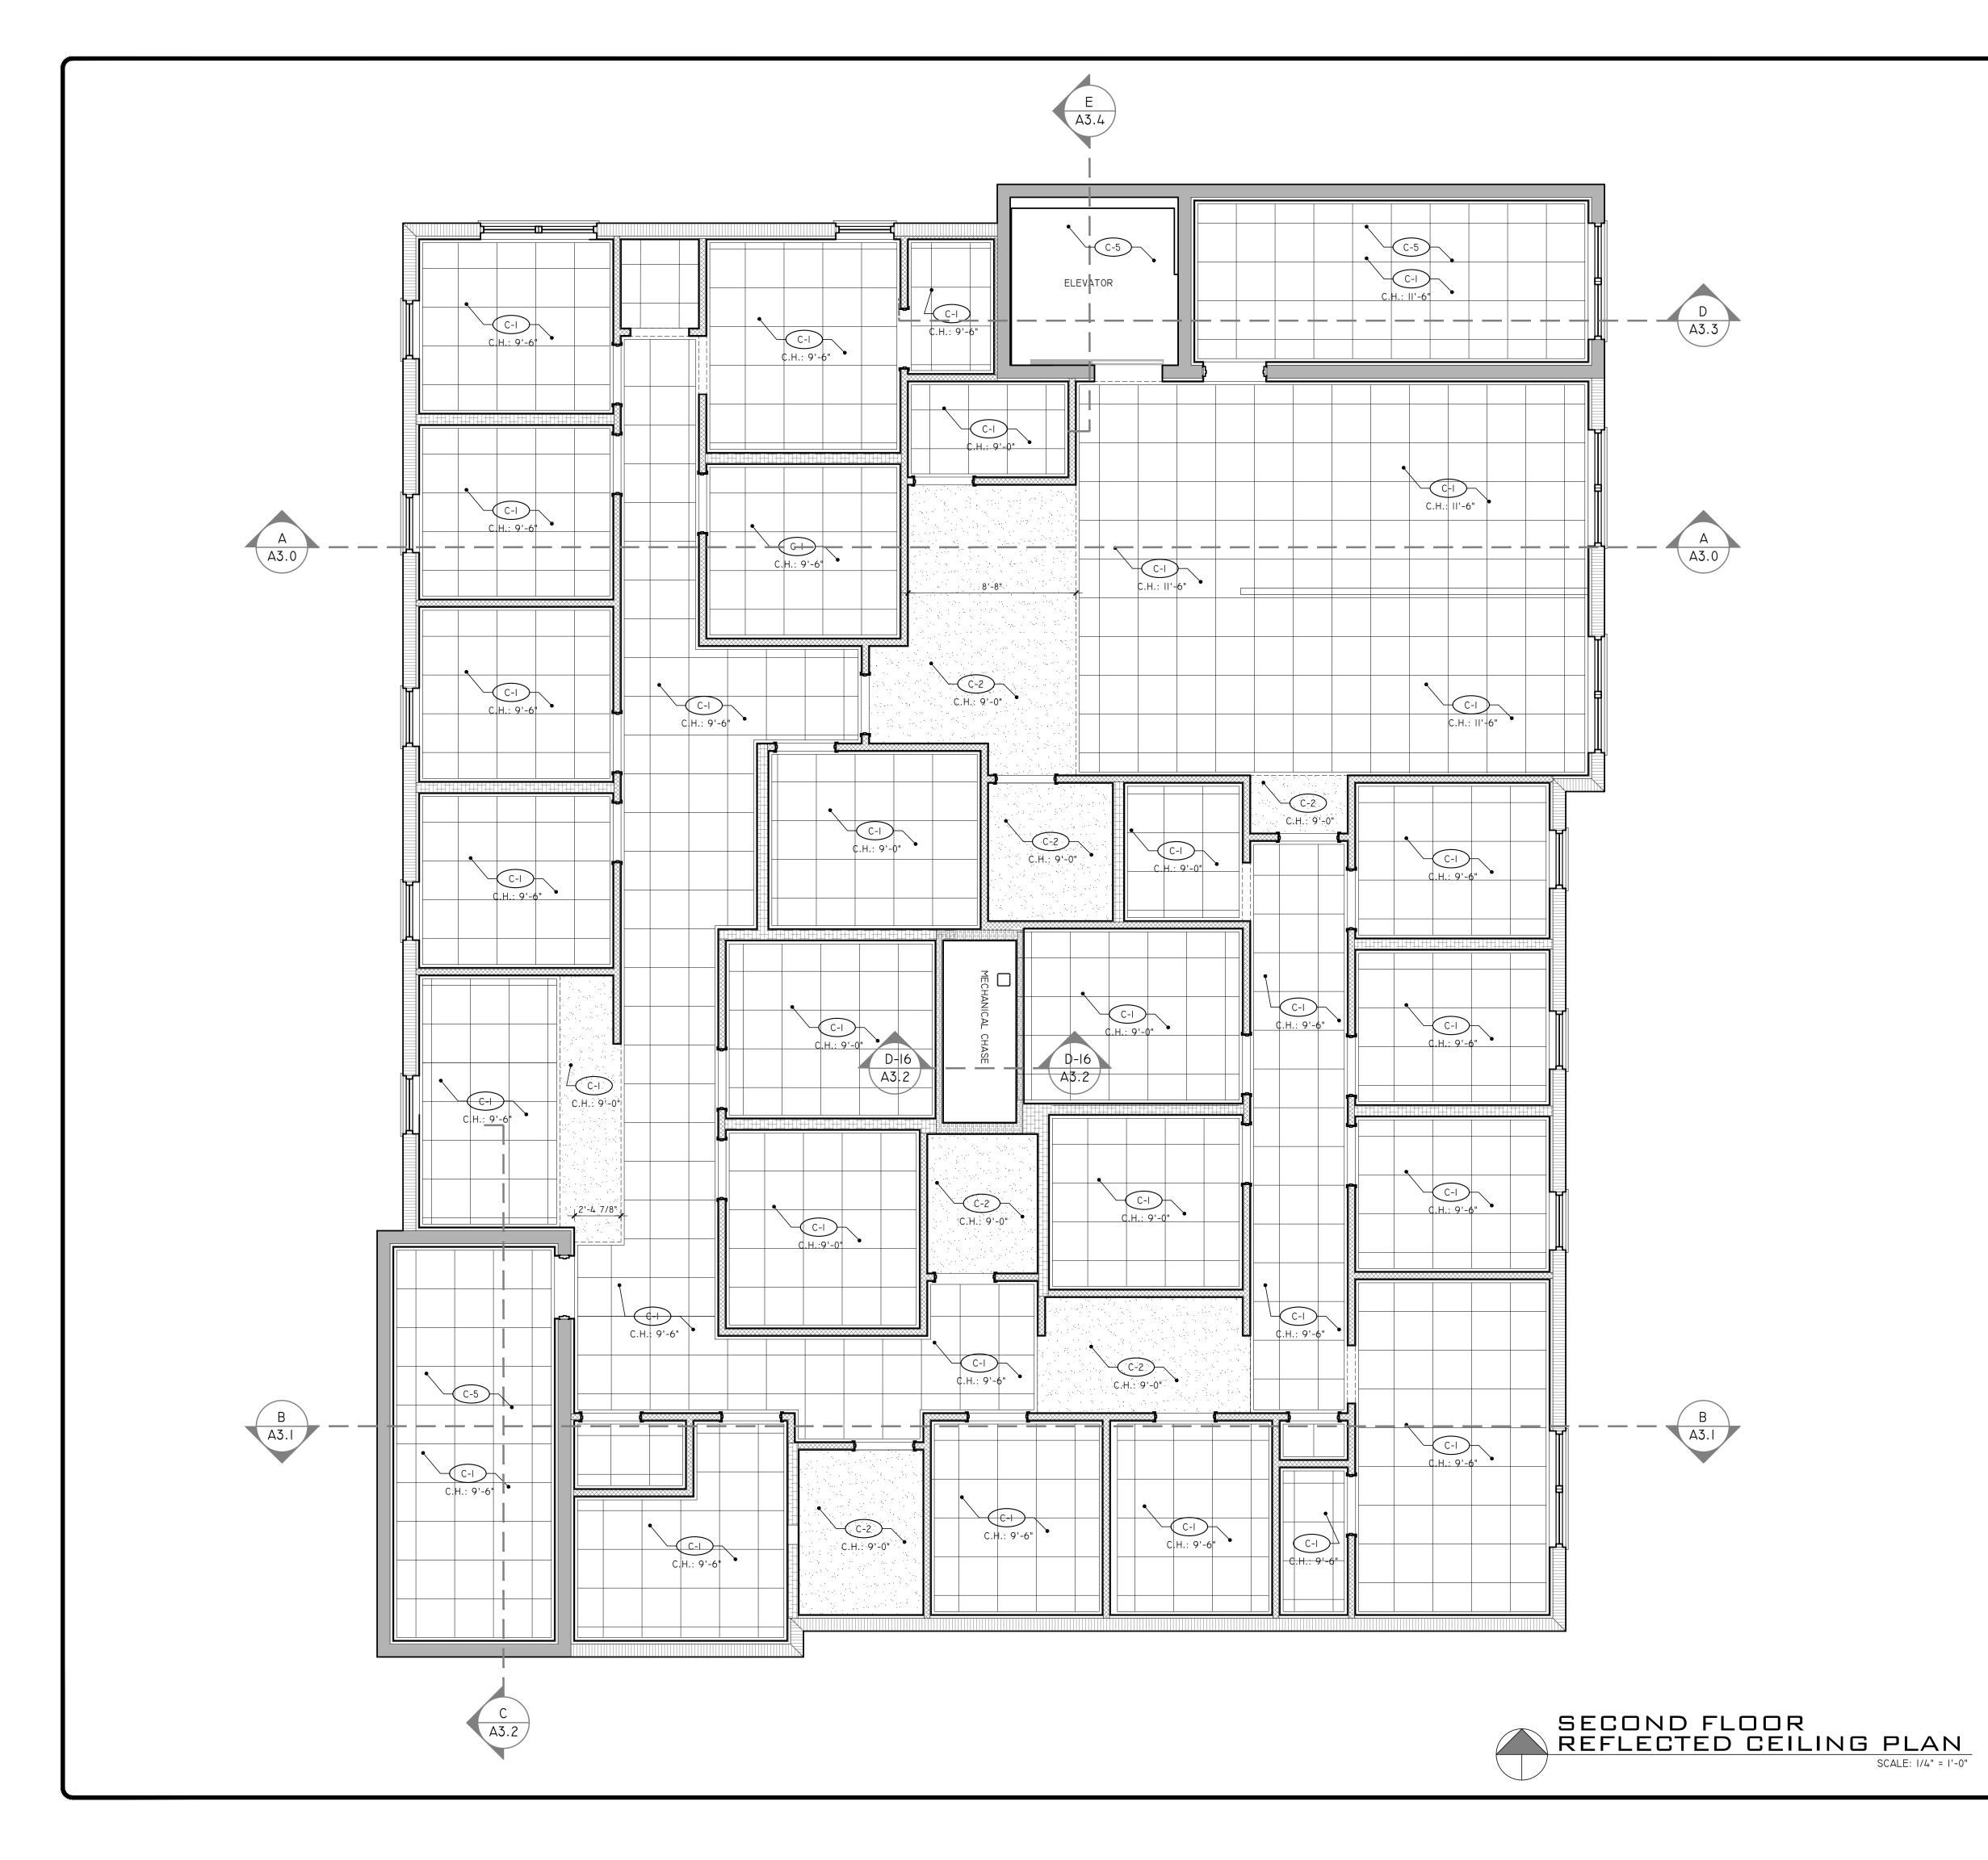
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SHEET TITLE

FIRST FLOOR REFLECTED CEILING PLAN

SHEET NUMBER

A1.21



REFLECTED CEILING PLAN NOTES

GENERAL NOTES:

- REFERENCE ARCHITECTURAL SPECIFICATION SHEET A0.2 FOR GENERAL CONSTRUCTION INFORMATION RELATED TO THE PROJECT.
- 2. FINISH FLOOR DATUM REFERENCES TOP OF SLAB DRAWINGS. VERIFY WITH SURVEY OR CIVIL ENGINEERING DRAWINGS.
- 3. EACH CONTRACTOR SHALL VERIFY ALL DIMENSIONS SHOWN ON THE DRAWING AND OBTAIN ALL MEASUREMENTS REQUIRED FOR PROPER EXECUTION OF WORK. DO NOT SCALE PLANS. CONTACT ARCHITECT FOR ANY ADDITIONAL INFORMATION OR DIMENSIONS REQUIRED.
- . DIMENSIONS ARE TAKEN FROM STRUCTURAL ELEMENTS ONLY. INTERIOR DIMENSIONS ARE TAKEN FROM ONE SIDE OF THE WALL. REFER TO WALL SCHEDULE FOR WALL THICKNESS AND CONSTRUCTION.
- . DETAILED DRAWINGS AND LARGER SCALE DRAWINGS TAKE PRECEDENCE OVER SMALL SCALE DRAWINGS.
- 6. FOR CONSTRUCTION DETAILS NOT SHOWN, USE THE PRODUCT MANUFACTURER'S WRITTEN INSTALLATION INSTRUCTIONS AND STANDARD DETAILS, IN STRICT ACCORDANCE WITH THE PROJECT SPECIFICATIONS REQUIREMENTS AND DESIGN INTENT.
- . GYPSUM BOARD SHALL BE INSTALLED PER ASTM C840-18 AND AS SPECIFIED PER THE MANUFACTURER'S SPECIFICATIONS. UNLESS OTHERWISE NOTE, INTERIOR GYPSUM BOARD WALLS SHALL BE FINISHED TO LEVEL 5.
- 8. SEE STRUCTURAL, MECHANICAL, ELECTRICAL AND PLUMBING PERMIT DRAWINGS FOR ADDITIONAL INFORMATION.

PLAN NOTES:

- ITEMS NOTED BELOW REFER TO TAGS ON FLOOR PLAN. CONTRACTOR TO CONTACT ARCHITECT WITH ANY ERROR OR ISSUES WITH NOTES OR DIMENSION ON PLAN.
- SEE STRUCTURAL DRAWINGS FOR ALL STRUCTURAL DETAILS AND INFORMATION.
- ACOUSTICAL CEILING GRID. SEE DETAIL THIS PAGE AND FINISH C-I SCHEDULE FOR MORE INFORMATION. INSTALL PER MANUFACTURER'S
- §" PAINTED GYPSUM BOARD CEILING OVER METAL FRAMING. LIGHT GAUGE 6 PAINTED GTPSOIT BOARD CEILING OVER METAL FRAMING. LIGHT G
 METAL FRAMING CONTRACTOR TO PROVIDE FRAMING DETAILS FOR CEILINGS.
- C-3 PAINT STRUCTURE ABOVE. SEE FINISHED SCHEDULE FOR PAINT COLOR.
- CEILING MOUNTED SHUTTER. SEE FLOOR PLAN FOR SHUTTER C-4 SPECIFICATION. SEE DETAIL D-18, SHEET A3.3 FOR ADDITIONAL
- I-HOUR FIRE RATED LID. SEE DETAIL D-17, SHEET A3.2 FOR DETAILS.



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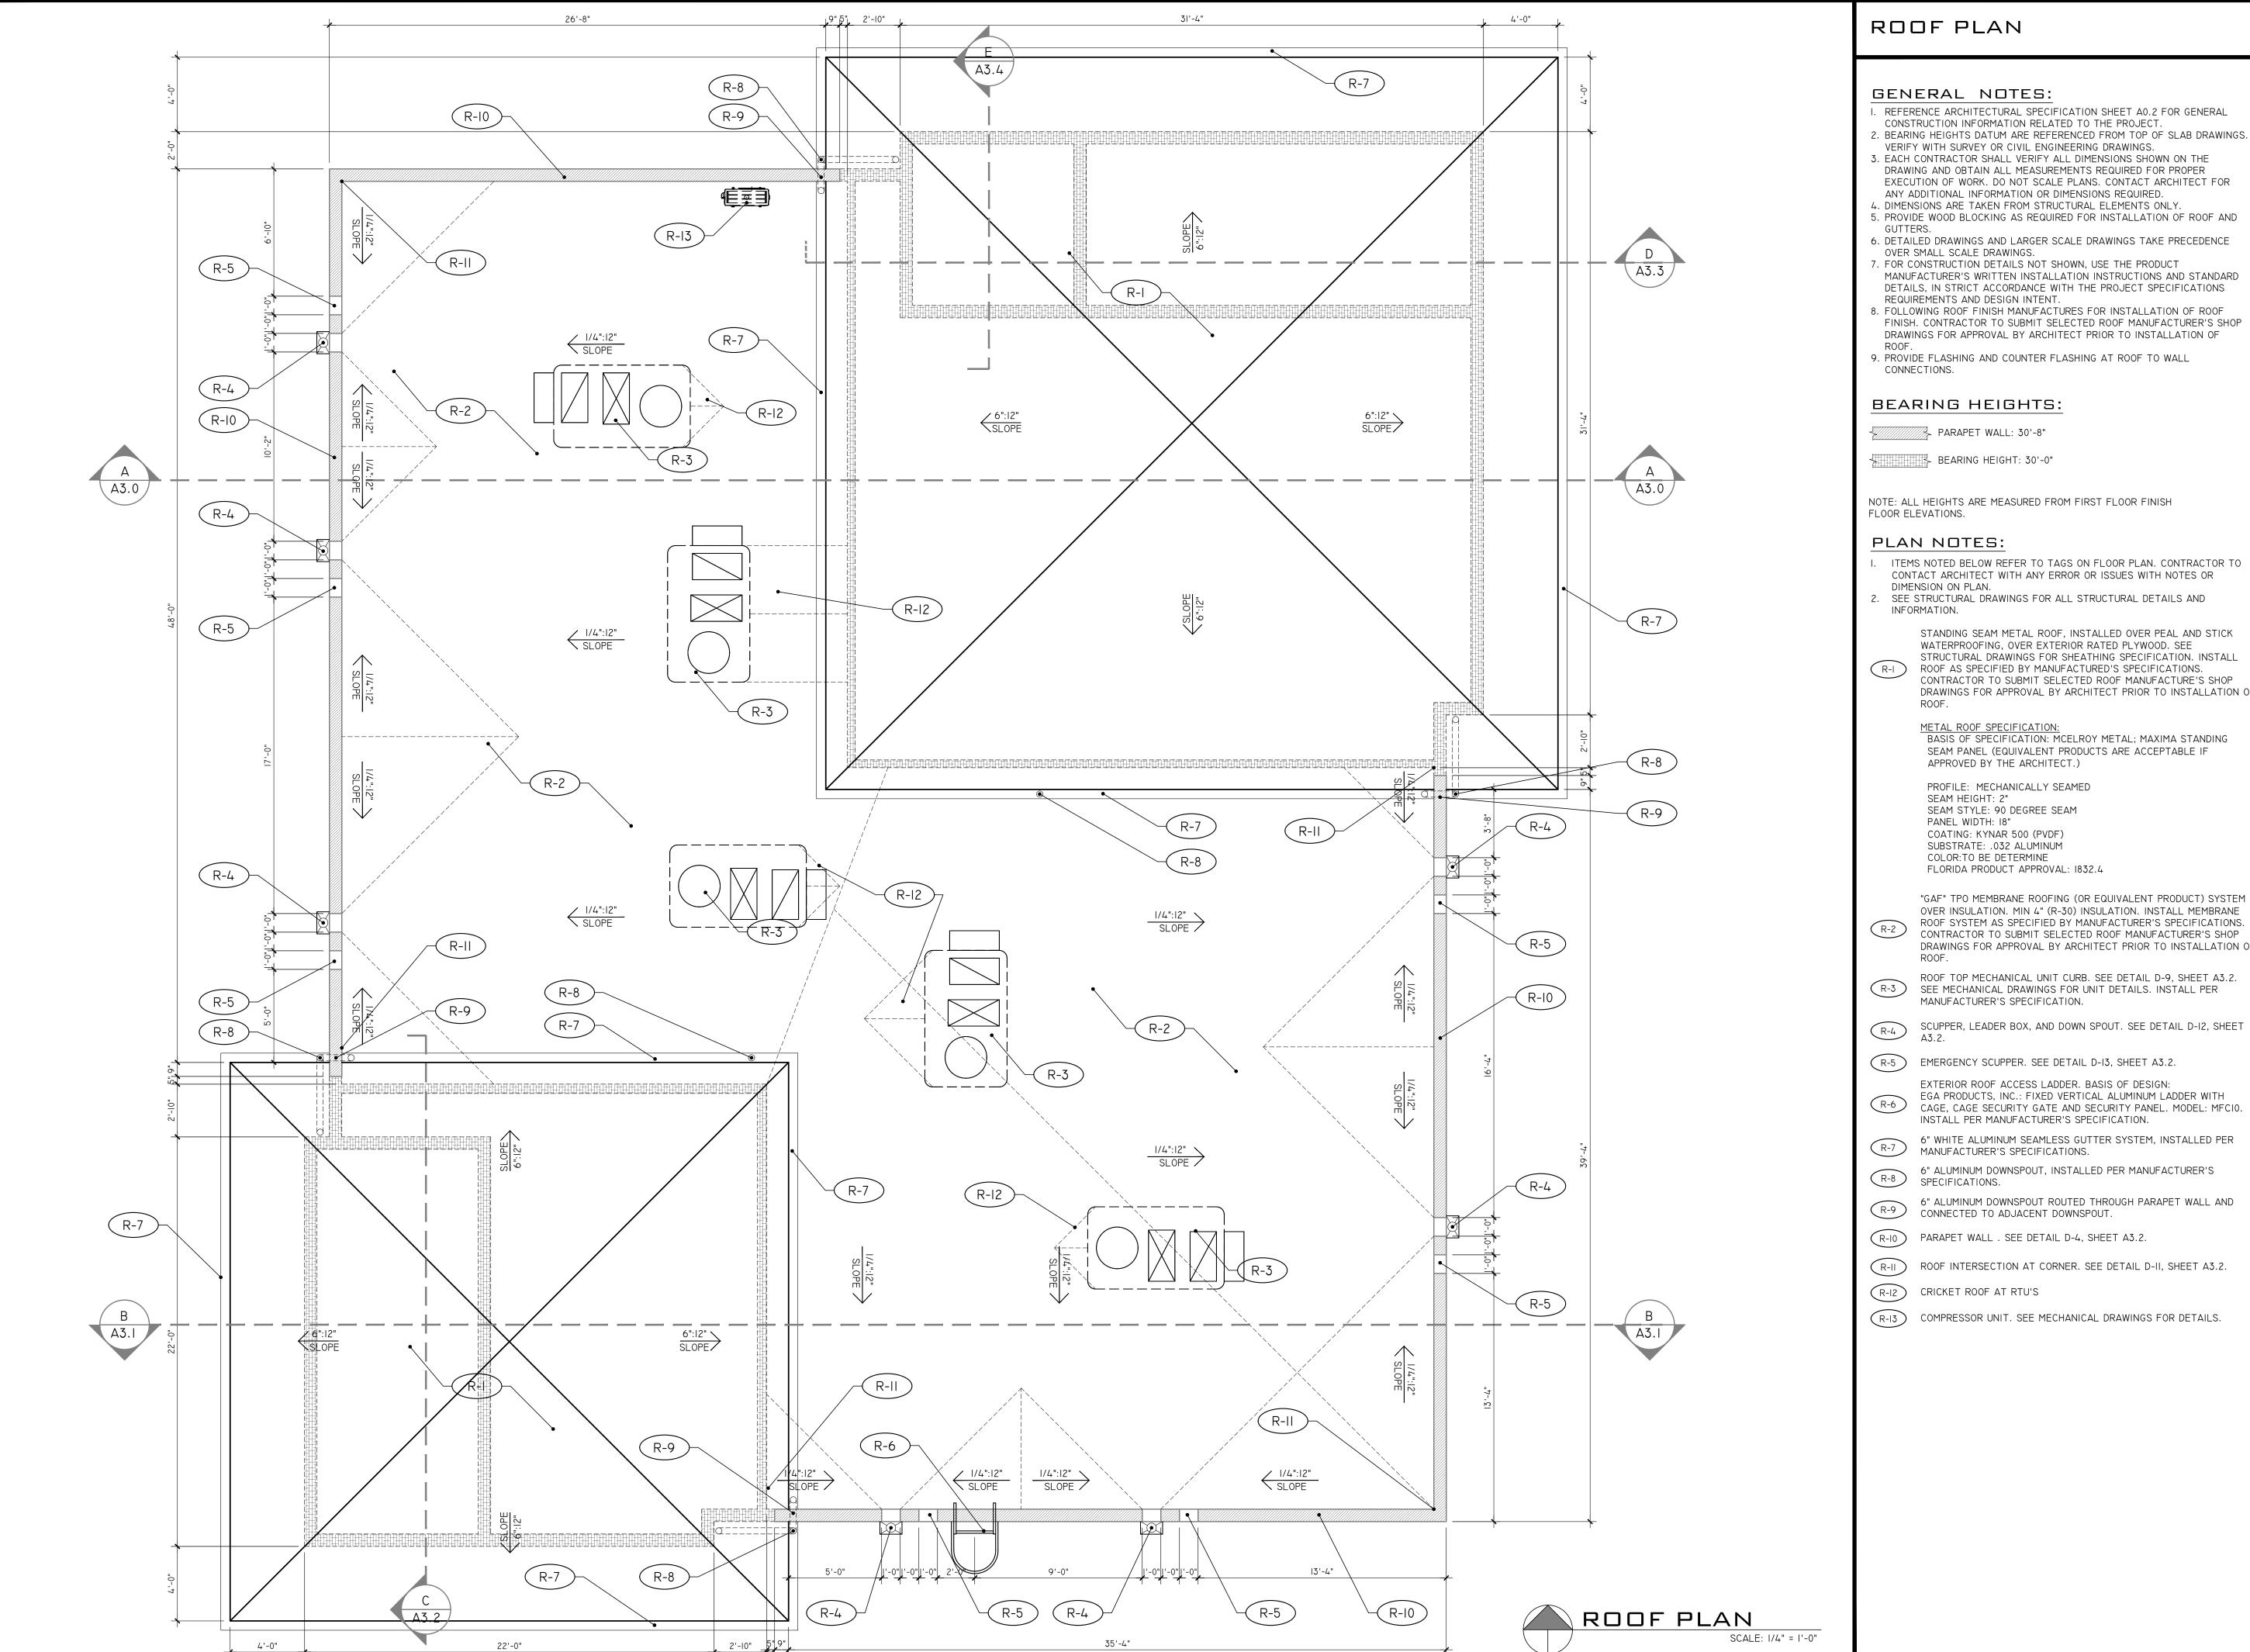
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BREVARD SILVER

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SHEET TITLE

SECOND FLOOR REFLECTED **CEILING PLAN**



I. REFERENCE ARCHITECTURAL SPECIFICATION SHEET A0.2 FOR GENERAL

- . BEARING HEIGHTS DATUM ARE REFERENCED FROM TOP OF SLAB DRAWINGS.
- 3. EACH CONTRACTOR SHALL VERIFY ALL DIMENSIONS SHOWN ON THE

- 6. DETAILED DRAWINGS AND LARGER SCALE DRAWINGS TAKE PRECEDENCE
- MANUFACTURER'S WRITTEN INSTALLATION INSTRUCTIONS AND STANDARD DETAILS, IN STRICT ACCORDANCE WITH THE PROJECT SPECIFICATIONS
- FINISH. CONTRACTOR TO SUBMIT SELECTED ROOF MANUFACTURER'S SHOP DRAWINGS FOR APPROVAL BY ARCHITECT PRIOR TO INSTALLATION OF

- ITEMS NOTED BELOW REFER TO TAGS ON FLOOR PLAN. CONTRACTOR TO CONTACT ARCHITECT WITH ANY ERROR OR ISSUES WITH NOTES OR
- STRUCTURAL DRAWINGS FOR SHEATHING SPECIFICATION. INSTALL CONTRACTOR TO SUBMIT SELECTED ROOF MANUFACTURE'S SHOP DRAWINGS FOR APPROVAL BY ARCHITECT PRIOR TO INSTALLATION OF

BASIS OF SPECIFICATION: MCELROY METAL; MAXIMA STANDING SEAM PANEL (EQUIVALENT PRODUCTS ARE ACCEPTABLE IF

- OVER INSULATION. MIN 4" (R-30) INSULATION. INSTALL MEMBRANE ROOF SYSTEM AS SPECIFIED BY MANUFACTURER'S SPECIFICATIONS. CONTRACTOR TO SUBMIT SELECTED ROOF MANUFACTURER'S SHOP DRAWINGS FOR APPROVAL BY ARCHITECT PRIOR TO INSTALLATION OF
- SCUPPER, LEADER BOX, AND DOWN SPOUT. SEE DETAIL D-12, SHEET
- EGA PRODUCTS, INC.: FIXED VERTICAL ALUMINUM LADDER WITH CAGE, CAGE SECURITY GATE AND SECURITY PANEL. MODEL: MFCIO.
- 6" ALUMINUM DOWNSPOUT, INSTALLED PER MANUFACTURER'S

ARCHITECTURE

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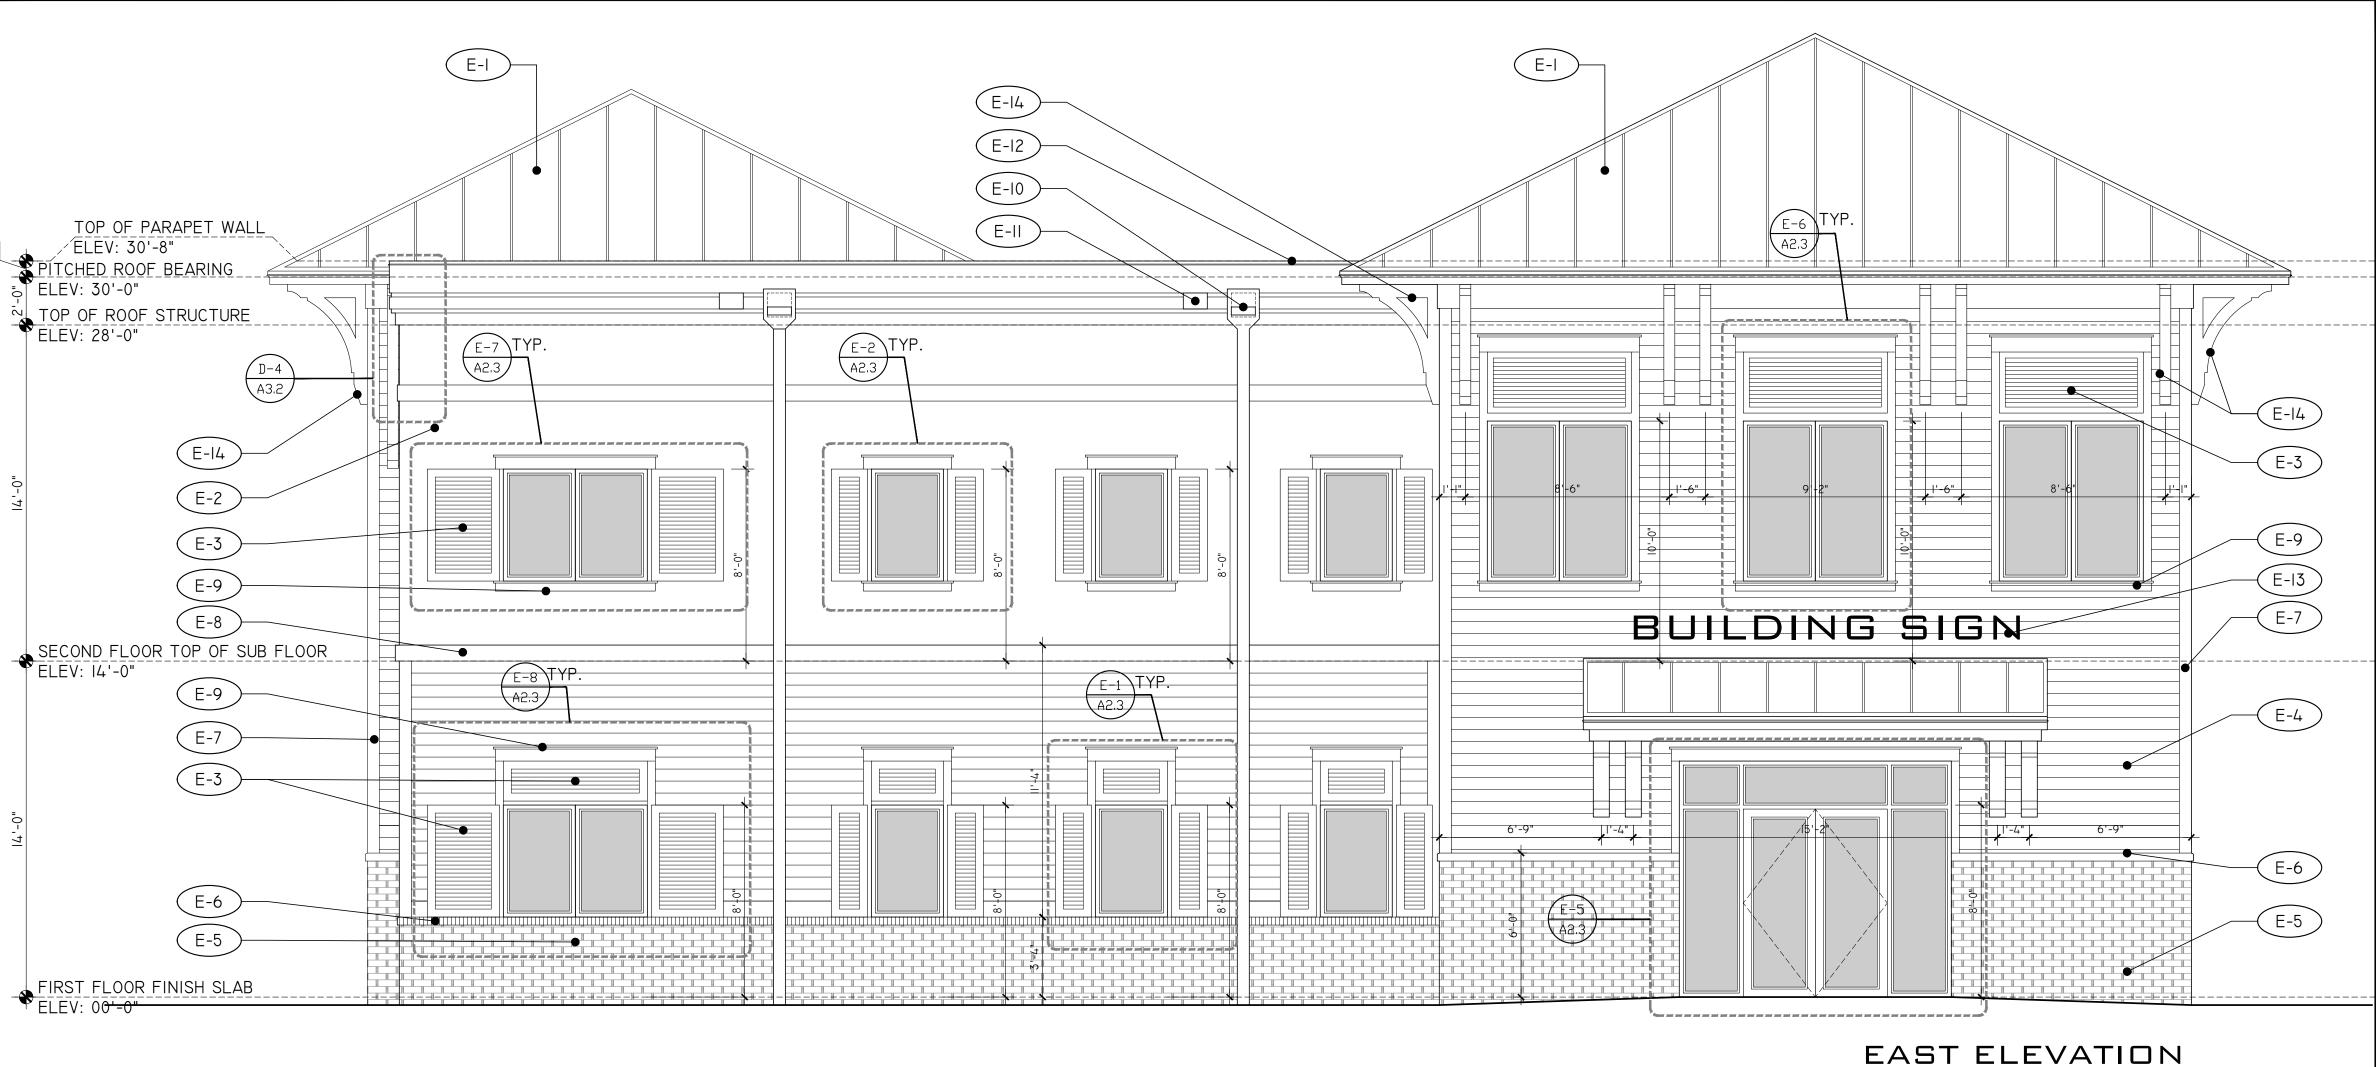
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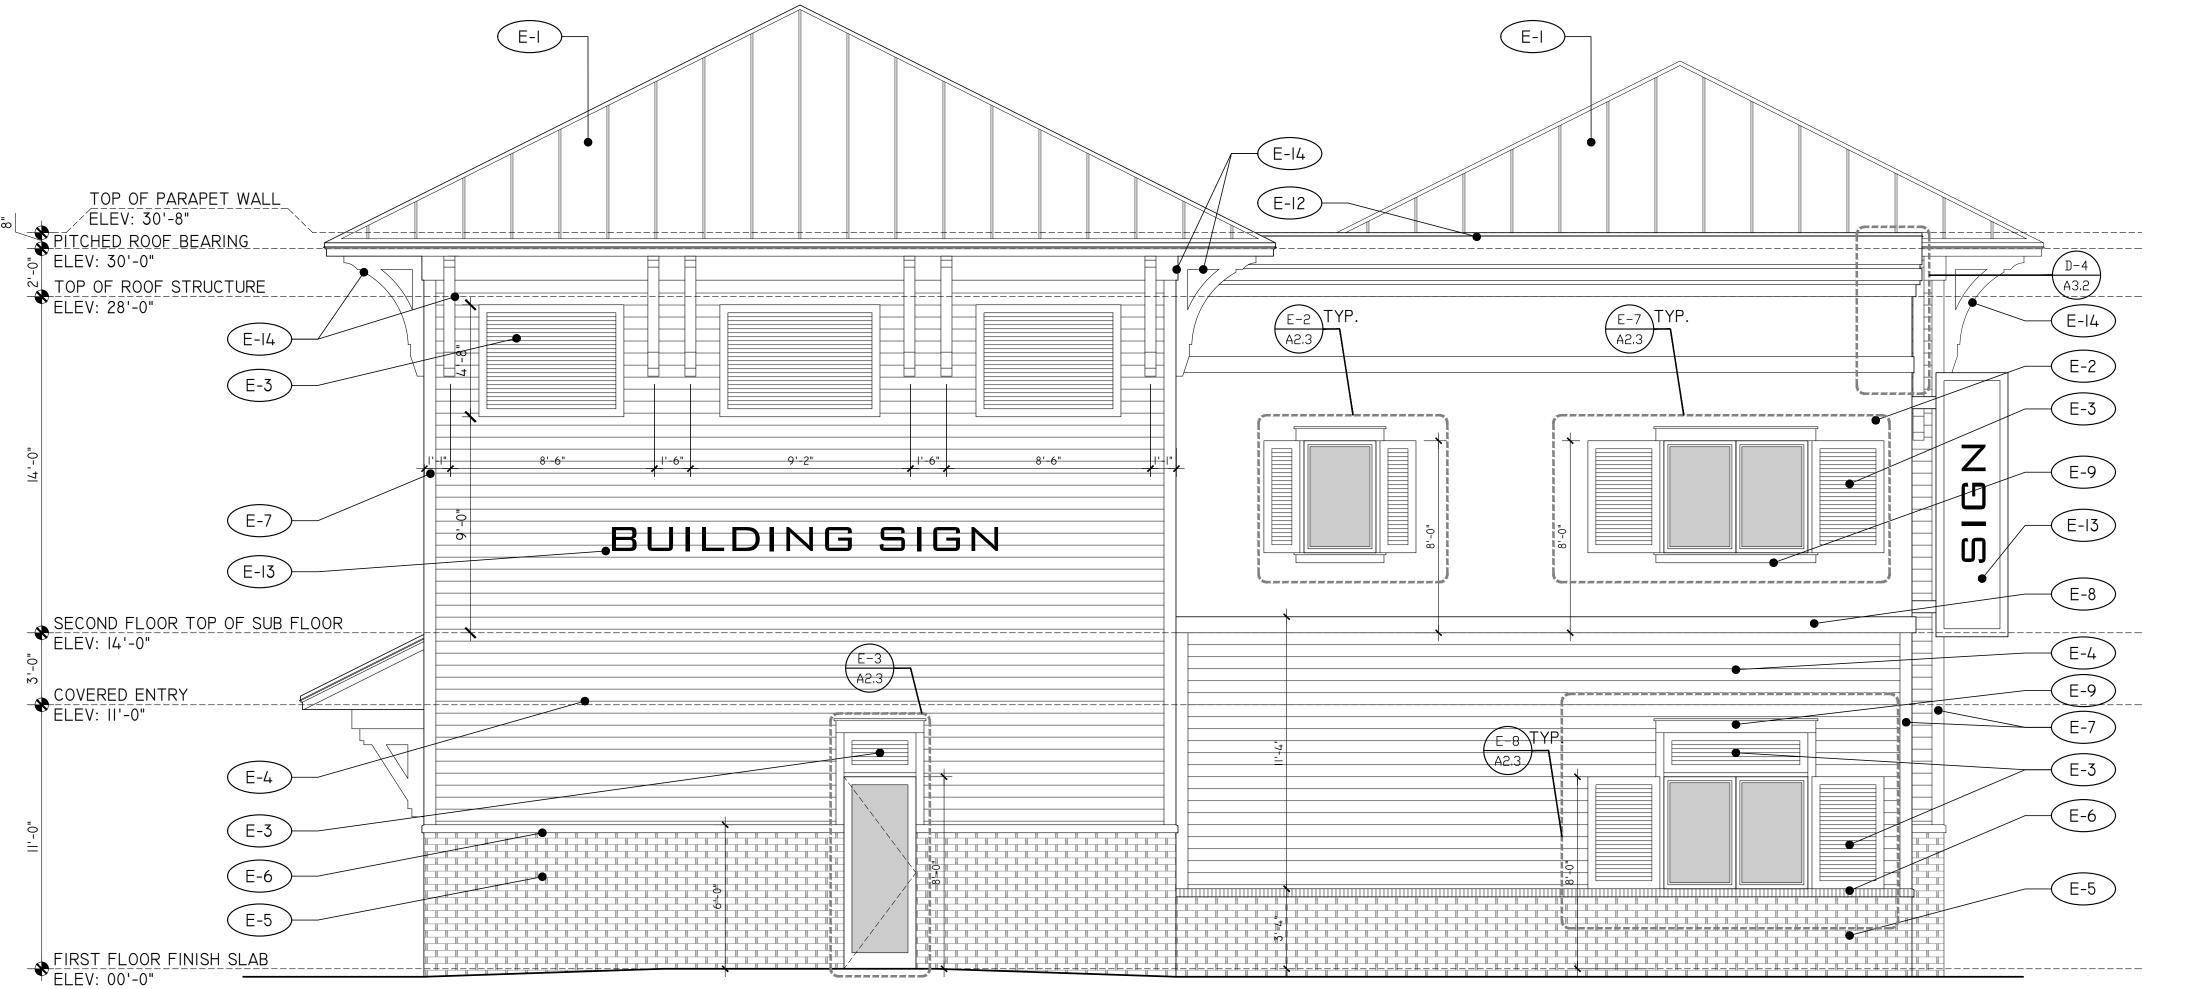
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ROOF

PLAN



SCALE: 1/4" = 1'-0"



NORTH ELEVATION

SCALE: 1/4" = 1'-0"

ELEVATION NOTES

GENERAL NOTES:

- I. REFERENCE ARCHITECTURAL SPECIFICATION SHEET A0.2 FOR GENERAL CONSTRUCTION INFORMATION RELATED TO THE PROJECT. 2. FINISH FLOOR DATUM REFERENCES TOP OF SLAB DRAWINGS. VERIFY WITH
- SURVEY OR CIVIL ENGINEERING DRAWINGS. 3. EACH CONTRACTOR SHALL VERIFY ALL DIMENSIONS SHOWN ON THE DRAWING AND OBTAIN ALL MEASUREMENTS REQUIRED FOR PROPER EXECUTION OF WORK. DO NOT SCALE PLANS. CONTACT ARCHITECT FOR ANY ADDITIONAL INFORMATION OR DIMENSIONS REQUIRED.
- 4. DIMENSIONS ARE TAKEN FROM STRUCTURAL ELEMENTS ONLY. 5. DETAILED DRAWINGS AND LARGER SCALE DRAWINGS TAKE PRECEDENCE
- OVER SMALL SCALE DRAWINGS. 6. FOR CONSTRUCTION DETAILS NOT SHOWN, USE THE PRODUCT MANUFACTURER'S WRITTEN INSTALLATION INSTRUCTIONS AND STANDARD DETAILS, IN STRICT ACCORDANCE WITH THE PROJECT SPECIFICATIONS REQUIREMENTS AND DESIGN INTENT.
- 7. ALL EXTERIOR PORCHES AND BALCONIES ARE SLOPED. SEE FLOOR PLAN FOR REQUIRED SLOPE. 8. SLOPE GRADE AWAY FROM STRUCTURE ON ALL SIDES.

ELEVATION NOTES:

- I. ITEMS NOTED BELOW REFER TO TAGS ON FLOOR PLAN. CONTRACTOR TO CONTACT ARCHITECT WITH ANY ERROR OR ISSUES WITH NOTES OR DIMENSION ON PLAN.
- 2. SEE STRUCTURAL DRAWINGS FOR ALL STRUCTURAL DETAILS AND INFORMATION.
- E-I STANDING SEAM METAL ROOF. SEE ROOF PLAN FOR MORE INFORMATION. INSTALLED PER MANUFACTURERS SPECIFICATIONS
- (E-2) SMOOTH STUCCO FINISH OVER CMU. SEE ARCHITECTURAL DRAWING SPECIFICATIONS FOR DETAILS. INSTALLED PER MANUFACTURERS SPECIFICATIONS
- PRE-MANUFACTURED PVC FIXED LOUVERED SHUTTER FROM HARIDE BRO INC. SIZE TO VERY BASED ON WINDOW OR DOOR. SEE SHEET
- (E-4) SIMULATED LAP SIDING FORMED USING PVC LAP SIDING STEP BEAD, SPACED AT 6" O.C. BEAD SPEC: PLASTIC PC COMPONENT SSB 75-50. INSTALL PER MANUFACTURER'S SPECIFICATION. SEE SECTIONS FOR MORE INFORMATION.
- (E-5) BRICK VENEER: ELDORADO STONE; TUNDRABRICK; COLOR: LATIGO INSTALL PER MANUFACTURER'S SPECIFICATION. SEE SECTIONS FOR MORE INFORMATION.
- (E-6) WAINSCOT SILL: ELDORADO STONE; SPLIT-EDGE WAINSCOT SILL; COLOR: COASTAL SAND INSTALL PER MANUFACTURER'S SPECIFICATION. SEE SECTIONS FOR MORE INFORMATION.
- (E-7) STUCCO CORNER TRIM: I" THICK X 6" WIDE. INSTALL USING I" THICK STUCCO CASING BEAD. INSTALL PER MANUFACTURER'S SPECIFICATIONS.
- (E-8) STUCCO TRIM BAND. SEE WALL SECTION D-3, SHEET A3.2 FOR MORE
- (E-9) WINDOW/DOOR CASING. SEE CASING PROFILES, SHEET A4.2.
- (E-IO) SCUPPER/LEADER BOX AND DOWN SPOUT. SEE ROOF PLAN, SHEET AI.30 FOR MORE DETAILS.
- E-II) EMERGENCY SCUPPER. SEE ROOF PLAN, SHEET AI.30 FOR MORE
- (E-I2) PARAPET WALL CAP. SEE DETAIL D-4, SHEET A3.2.
- E-I3 WALL MOUNTED SIGN. TO BE PROVIDE BY SIGNED CONTRACTOR AND APPROVED BY BREVARD HEALTH ALLIANCE.
- E-I4 HARDIE BRO INC. BRACKET. BKT32I2-4-6; SIZE: 7" X 40"X60"
- EXTERIOR ALUMINUM ACCESS LADDER WITH CAGE AND SECURITY E-I5 PANELS. SEE ROOF PLAN, SHEET AI.30 FOR LADDER SPECIFICATION AND LOCATION. INSTALL PER MANUFACTURER'S SPECIFICATION.

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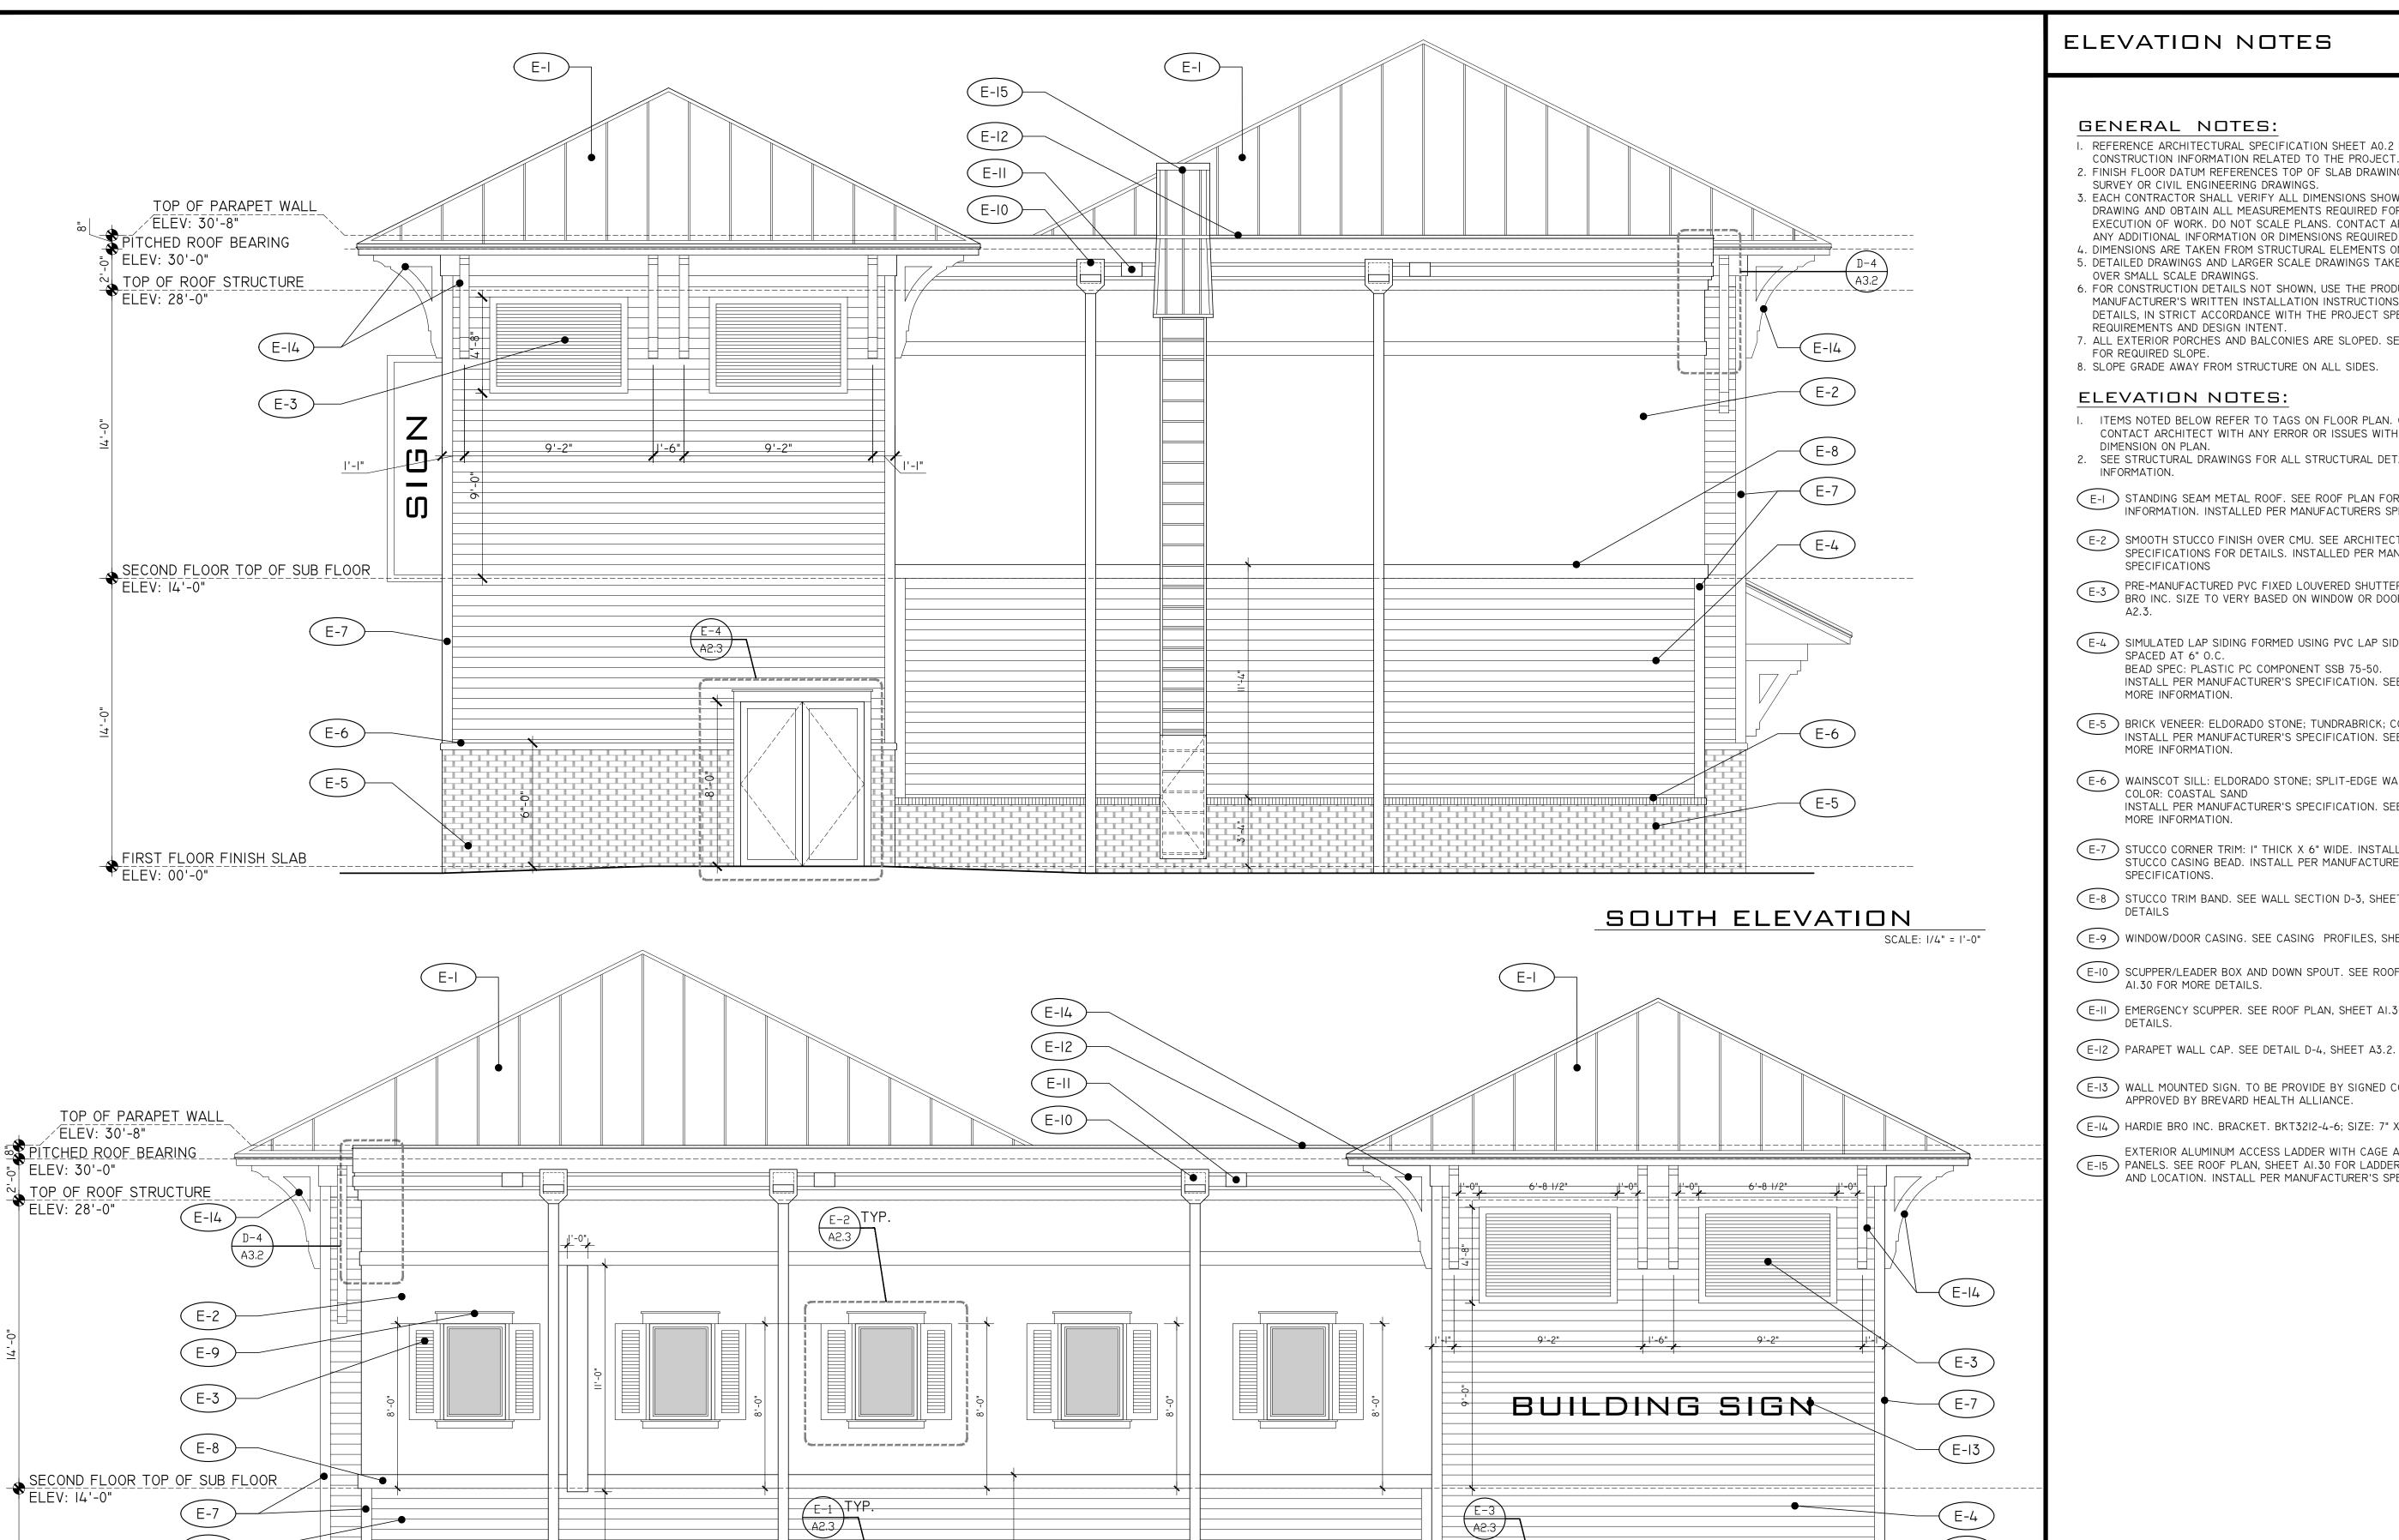
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SHEET TITLE

EXTERIOR ELEVATION



(E-9)

E-3

(E-6)

(E-5)

FIRST FLOOR FINISH SLAB ELEV: 00'-0"

ELEVATION NOTES

GENERAL NOTES:

- I. REFERENCE ARCHITECTURAL SPECIFICATION SHEET A0.2 FOR GENERAL CONSTRUCTION INFORMATION RELATED TO THE PROJECT. 2. FINISH FLOOR DATUM REFERENCES TOP OF SLAB DRAWINGS. VERIFY WITH
- SURVEY OR CIVIL ENGINEERING DRAWINGS. 3. EACH CONTRACTOR SHALL VERIFY ALL DIMENSIONS SHOWN ON THE DRAWING AND OBTAIN ALL MEASUREMENTS REQUIRED FOR PROPER EXECUTION OF WORK. DO NOT SCALE PLANS. CONTACT ARCHITECT FOR ANY ADDITIONAL INFORMATION OR DIMENSIONS REQUIRED.
- 4. DIMENSIONS ARE TAKEN FROM STRUCTURAL ELEMENTS ONLY. 5. DETAILED DRAWINGS AND LARGER SCALE DRAWINGS TAKE PRECEDENCE
- OVER SMALL SCALE DRAWINGS. 6. FOR CONSTRUCTION DETAILS NOT SHOWN, USE THE PRODUCT MANUFACTURER'S WRITTEN INSTALLATION INSTRUCTIONS AND STANDARD DETAILS, IN STRICT ACCORDANCE WITH THE PROJECT SPECIFICATIONS
- 7. ALL EXTERIOR PORCHES AND BALCONIES ARE SLOPED. SEE FLOOR PLAN FOR REQUIRED SLOPE.

8. SLOPE GRADE AWAY FROM STRUCTURE ON ALL SIDES.

ELEVATION NOTES:

- I. ITEMS NOTED BELOW REFER TO TAGS ON FLOOR PLAN. CONTRACTOR TO CONTACT ARCHITECT WITH ANY ERROR OR ISSUES WITH NOTES OR
- 2. SEE STRUCTURAL DRAWINGS FOR ALL STRUCTURAL DETAILS AND
- (E-I) STANDING SEAM METAL ROOF. SEE ROOF PLAN FOR MORE INFORMATION. INSTALLED PER MANUFACTURERS SPECIFICATIONS
- (E-2) SMOOTH STUCCO FINISH OVER CMU. SEE ARCHITECTURAL DRAWING SPECIFICATIONS FOR DETAILS. INSTALLED PER MANUFACTURERS SPECIFICATIONS
- PRE-MANUFACTURED PVC FIXED LOUVERED SHUTTER FROM HARIDE BRO INC. SIZE TO VERY BASED ON WINDOW OR DOOR. SEE SHEET
- E-4 SIMULATED LAP SIDING FORMED USING PVC LAP SIDING STEP BEAD, SPACED AT 6" O.C. BEAD SPEC: PLASTIC PC COMPONENT SSB 75-50. INSTALL PER MANUFACTURER'S SPECIFICATION. SEE SECTIONS FOR MORE INFORMATION.
- (E-5) BRICK VENEER: ELDORADO STONE; TUNDRABRICK; COLOR: LATIGO INSTALL PER MANUFACTURER'S SPECIFICATION. SEE SECTIONS FOR MORE INFORMATION.
- (E-6) WAINSCOT SILL: ELDORADO STONE; SPLIT-EDGE WAINSCOT SILL; COLOR: COASTAL SAND INSTALL PER MANUFACTURER'S SPECIFICATION. SEE SECTIONS FOR MORE INFORMATION.
- E-7 STUCCO CORNER TRIM: I" THICK X 6" WIDE. INSTALL USING I" THICK STUCCO CASING BEAD. INSTALL PER MANUFACTURER'S SPECIFICATIONS.
- (E-8) STUCCO TRIM BAND. SEE WALL SECTION D-3, SHEET A3.2 FOR MORE
- (E-9) WINDOW/DOOR CASING. SEE CASING PROFILES, SHEET A4.2.
- (E-IO) SCUPPER/LEADER BOX AND DOWN SPOUT. SEE ROOF PLAN, SHEET
- (E-II) EMERGENCY SCUPPER. SEE ROOF PLAN, SHEET AI.30 FOR MORE
- E-I3 WALL MOUNTED SIGN. TO BE PROVIDE BY SIGNED CONTRACTOR AND APPROVED BY BREVARD HEALTH ALLIANCE.
- E-I4 HARDIE BRO INC. BRACKET. BKT32I2-4-6; SIZE: 7" X 40"X60"

E-9

(E-3)

(E-6)

(E-5)

SCALE: 1/4" = 1'-0"

WEST ELEVATION

EXTERIOR ALUMINUM ACCESS LADDER WITH CAGE AND SECURITY E-I5 PANELS. SEE ROOF PLAN, SHEET AI.30 FOR LADDER SPECIFICATION AND LOCATION. INSTALL PER MANUFACTURER'S SPECIFICATION. ARCHITECTURE

1 5 4 2 G U A V A A V E . MELBOURNE, FL 32935 3 2 1 . 4 2 8 . 3 8 6 9

JOB #: C-2022-032 DRAWN: JKA

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DATE

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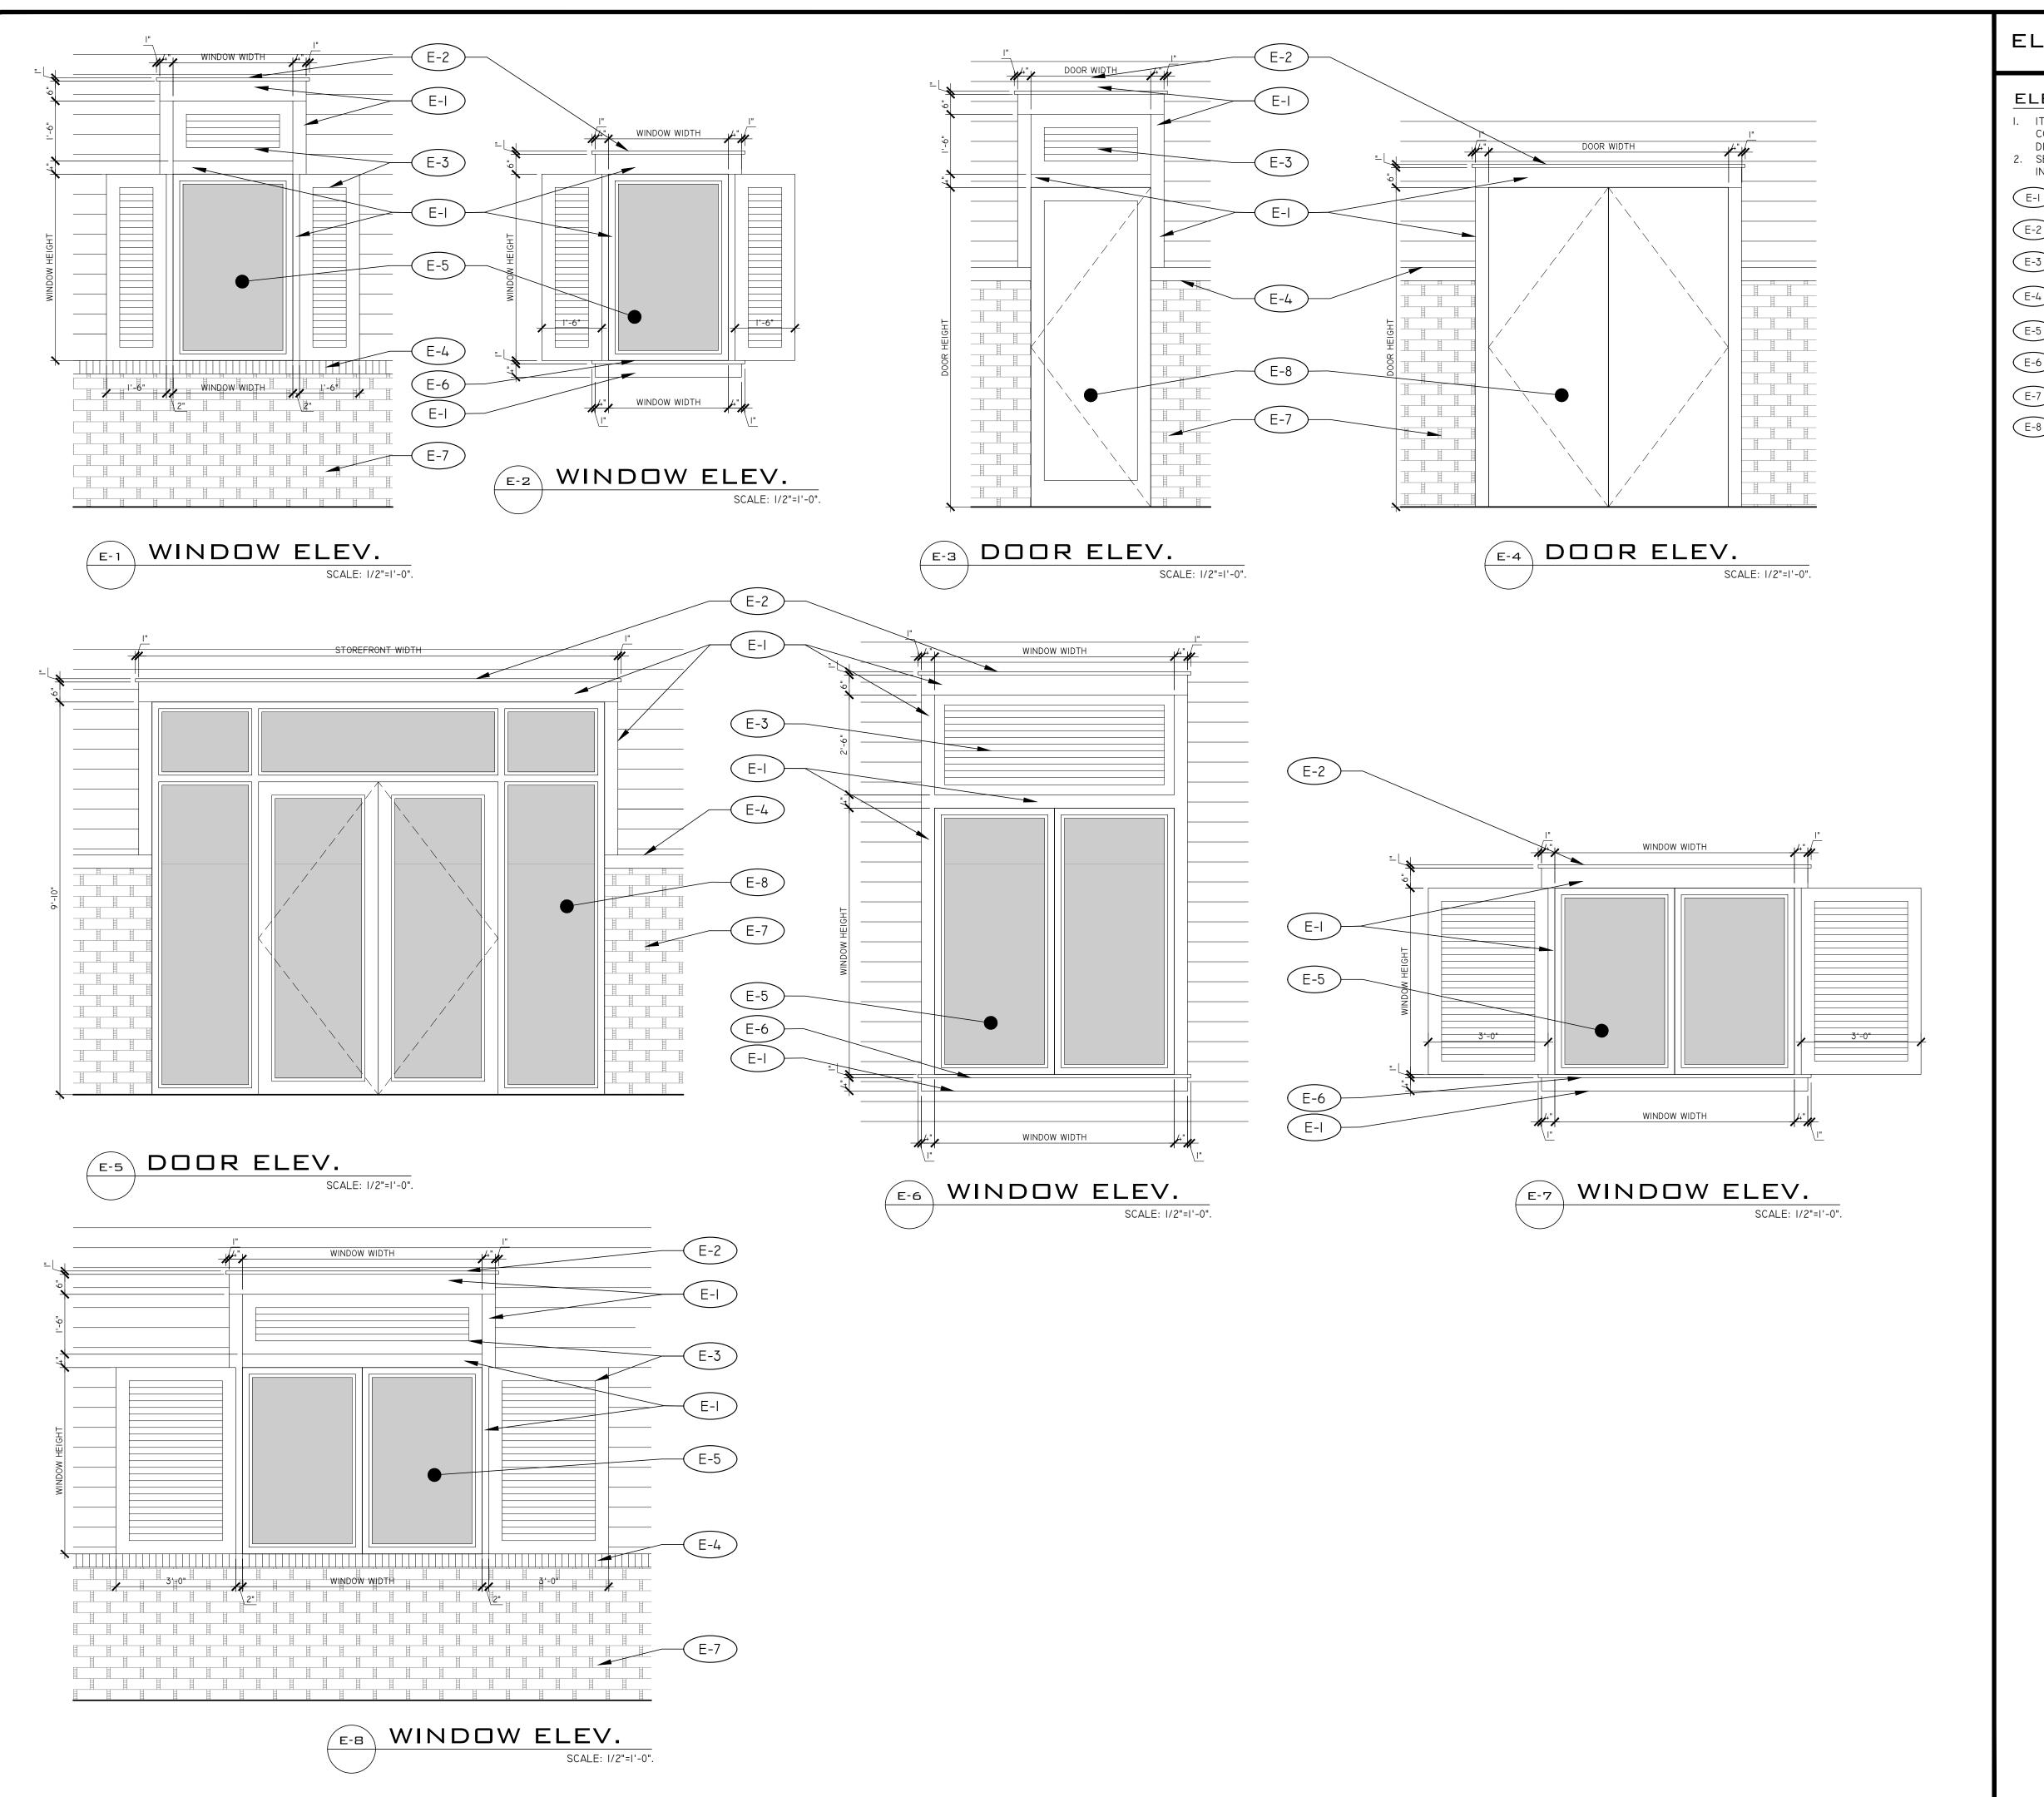
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SHEET TITLE

EXTERIOR ELEVATION



ELEVATION NOTES

ELEVATION NOTES:

- ITEMS NOTED BELOW REFER TO TAGS ON FLOOR PLAN. CONTRACTOR TO CONTACT ARCHITECT WITH ANY ERROR OR ISSUES WITH NOTES OR
- DIMENSION ON PLAN. SEE STRUCTURAL DRAWINGS FOR ALL STRUCTURAL DETAILS AND
- INFORMATION.
- E-I I" THICK STUCCO TRIM. SEE ELEVATION FOR TRIM DIMENSION.
- (E-2) 1.5" THICK STUCCO TRIM. SEE ELEVATION FOR TRIM DIMENSION.
- PRE-MANUFACTURED PVC FIXED LOUVERED SHUTTER FROM HARIDE BRO INC.
- STONE SILL. SEE EXTERIOR ELEVATION FOR STONE SPEC. INSTALL PER MANUFACTURER'S SPECIFICATION.
- E-5 WINDOW. SEE FLOOR PLAN FOR WINDOW TAG.
- E-6 I.5" THICK STUCCO TRIM. SLOPE TOP. SEE ELEVATION FOR TRIM DIMENSION.
- STONE VENEER. SEE EXTERIOR ELEVATION FOR STONE SPEC. INSTALL PER MANUFACTURER'S SPECIFICATION.
- E-8 DOOR. SEE FLOOR PLAN FOR DOOR TAG.

ARCHITECTURE

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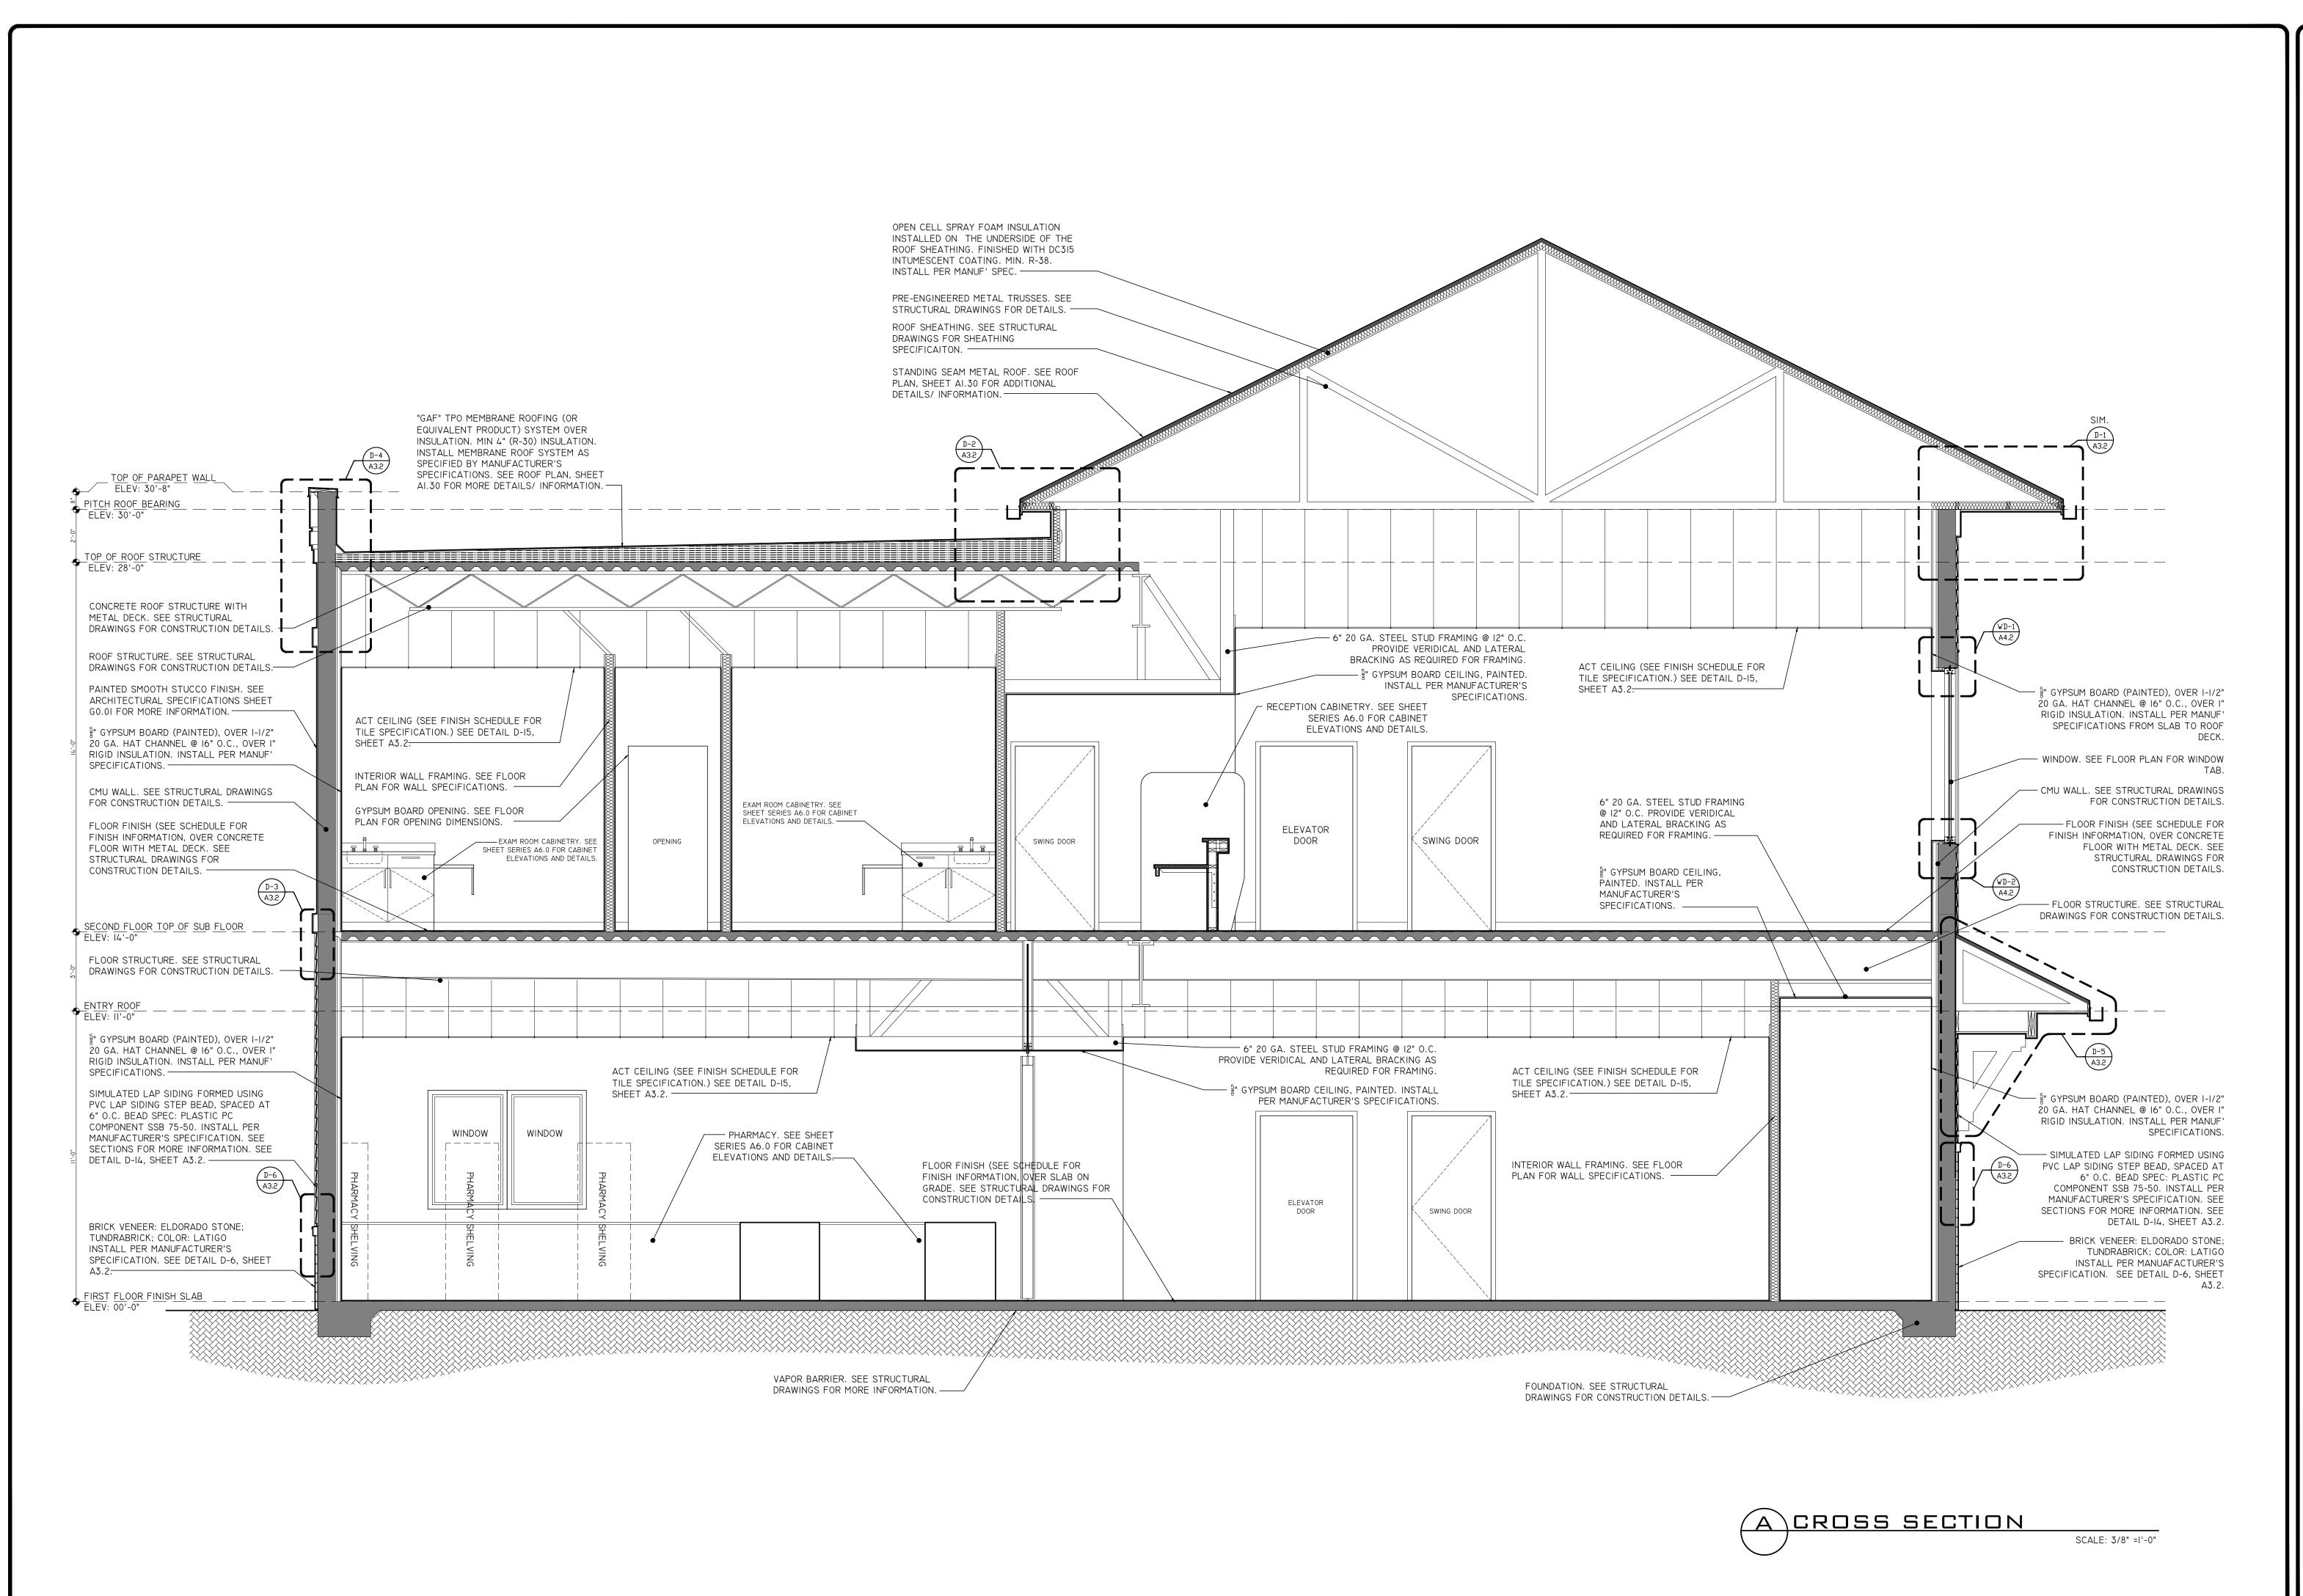
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SHEET TITLE

ELEVATION DETAILS

SHEET NUMBER

A2.3



ARCHITECTURE

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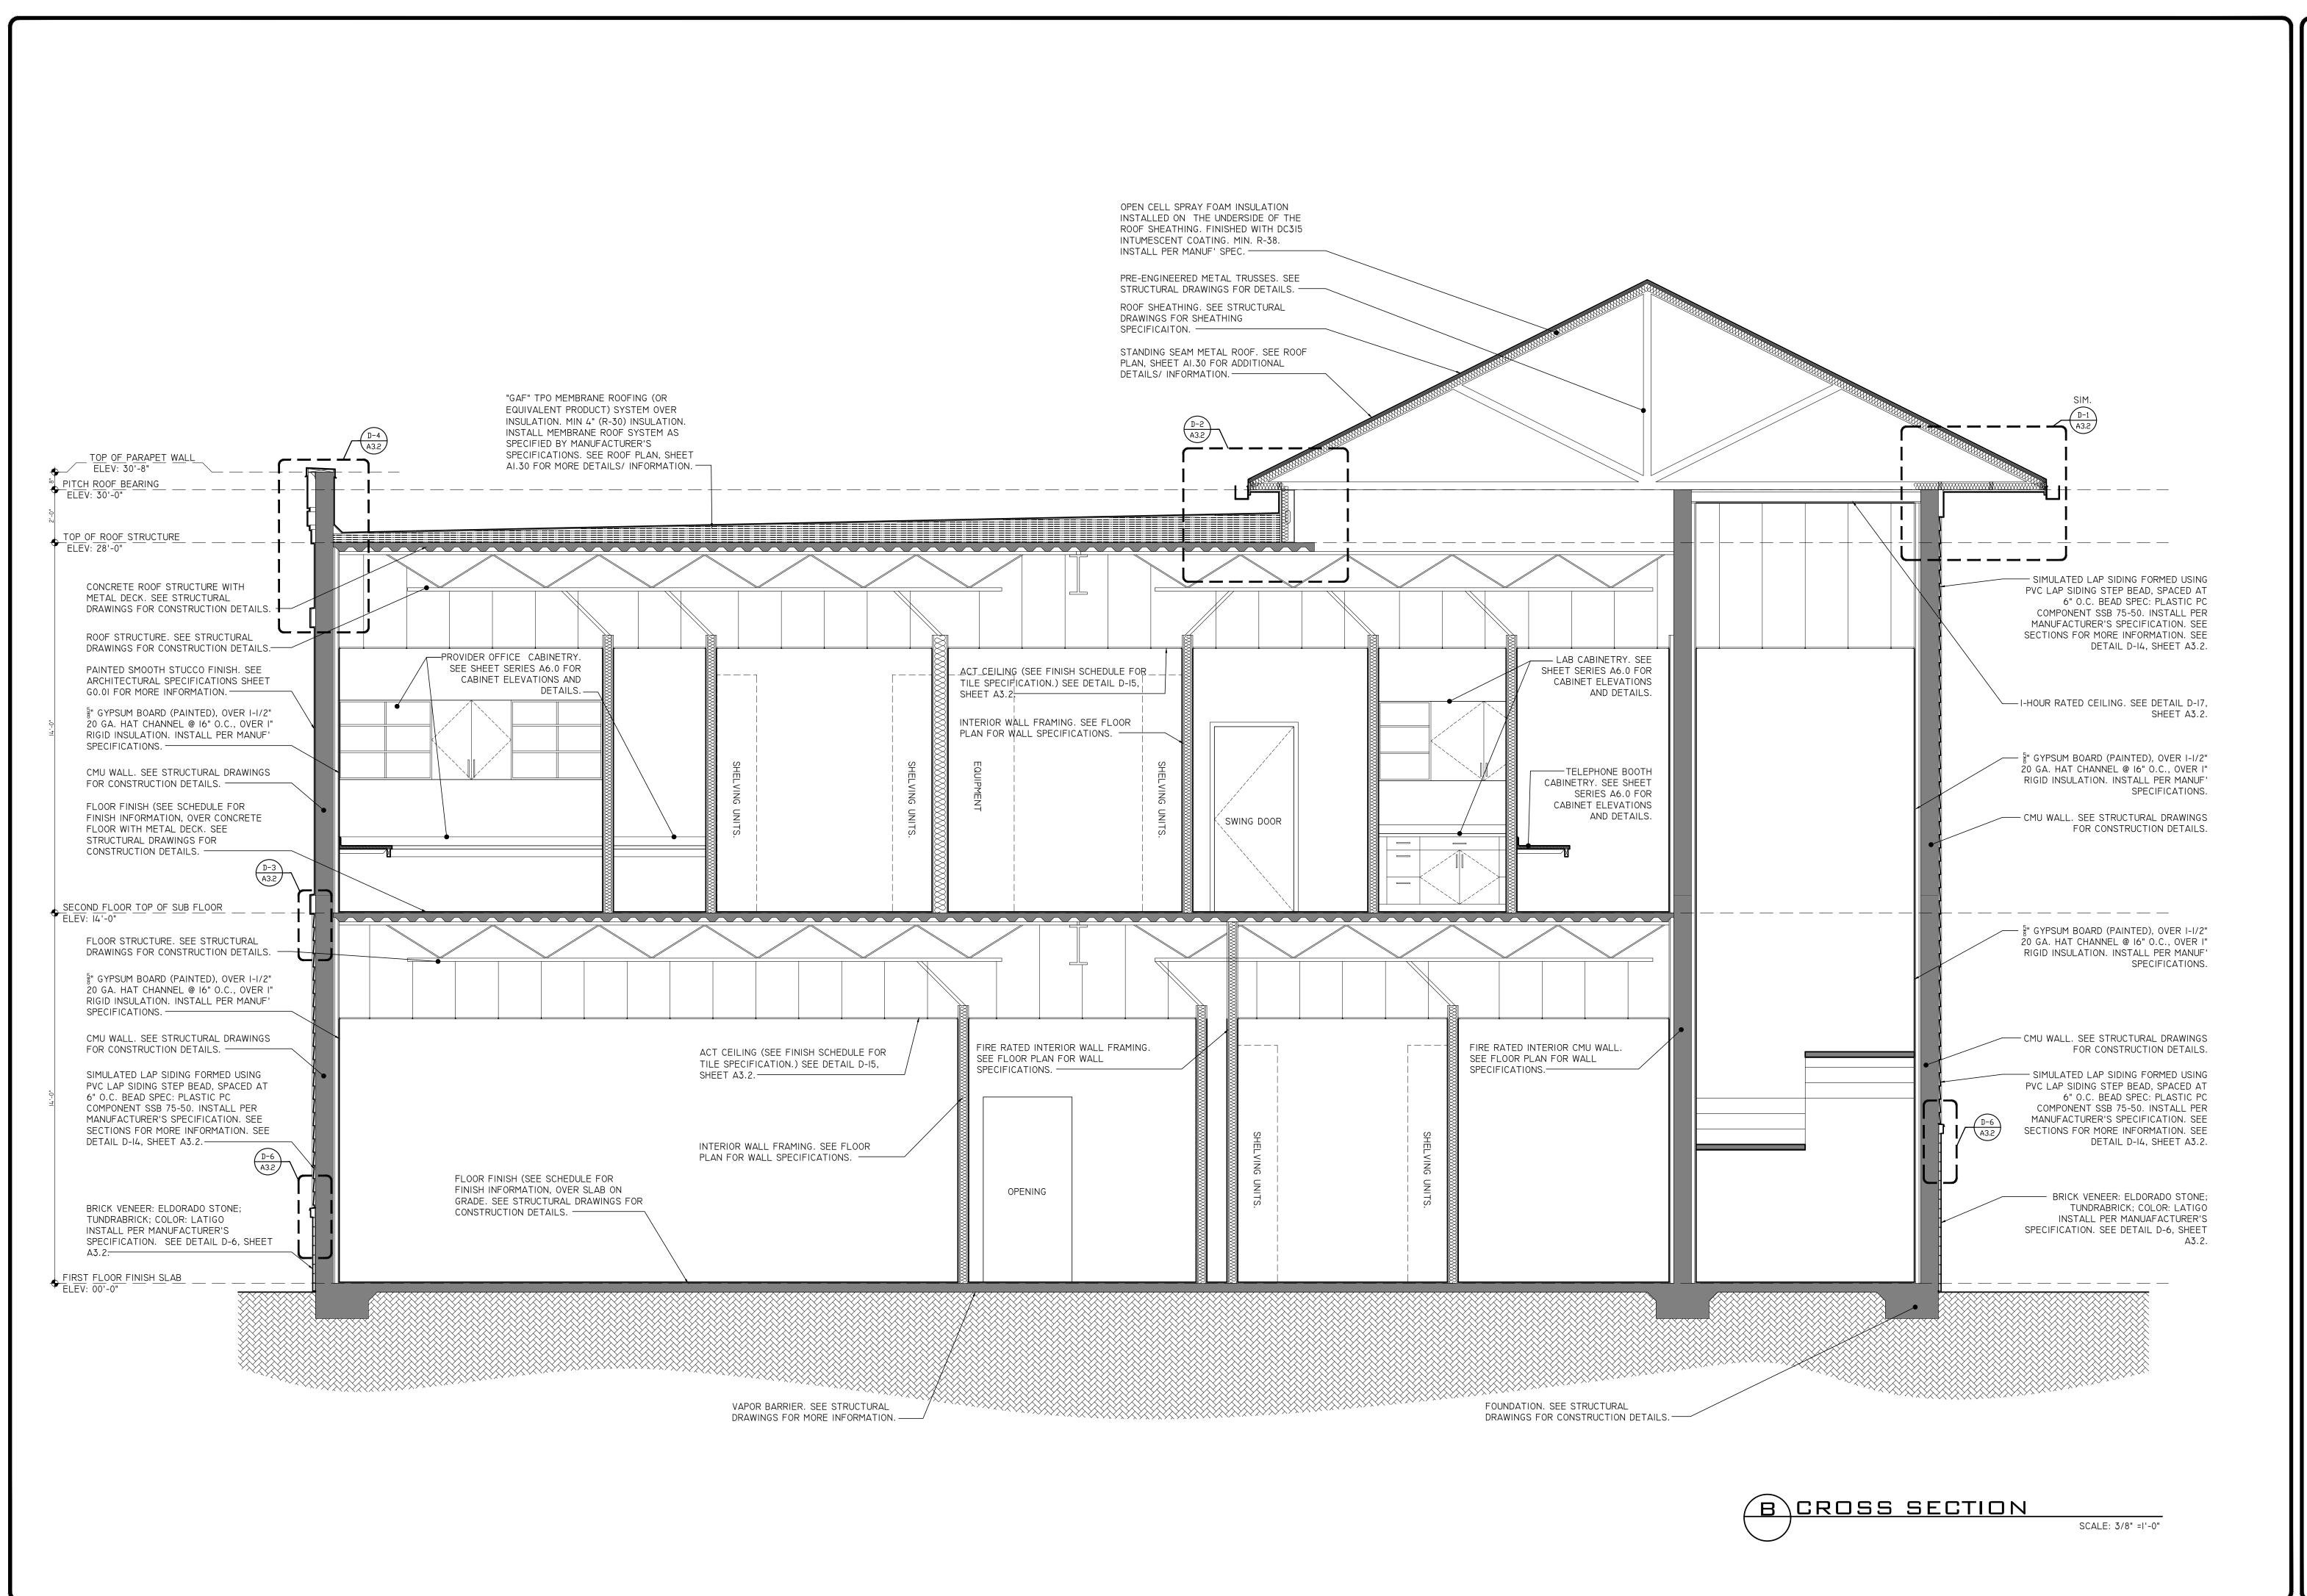
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> CROSS SECTION



Studio ARCHITECTURE

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ALTH ALLIANCE M LOCATION

BREVARD HEALTH A SILVER PALM LOC MELBOURNE, FL

SEAL


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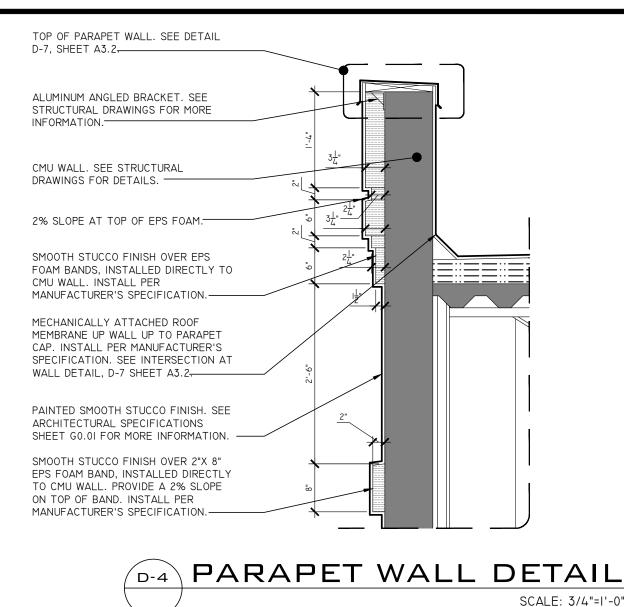
DATE: 2023-09-25
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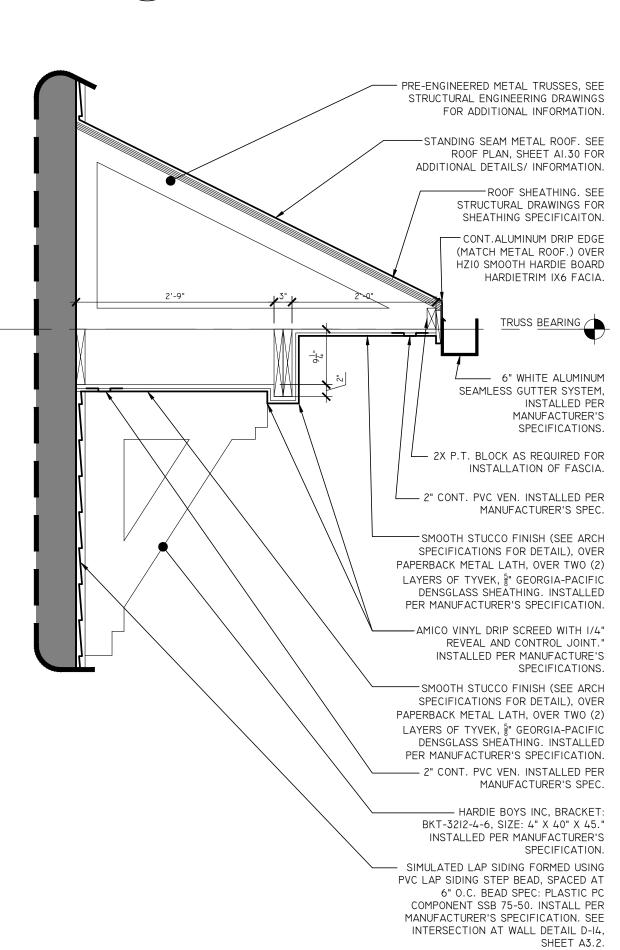
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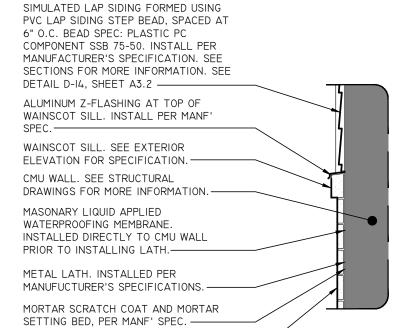
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A3.1







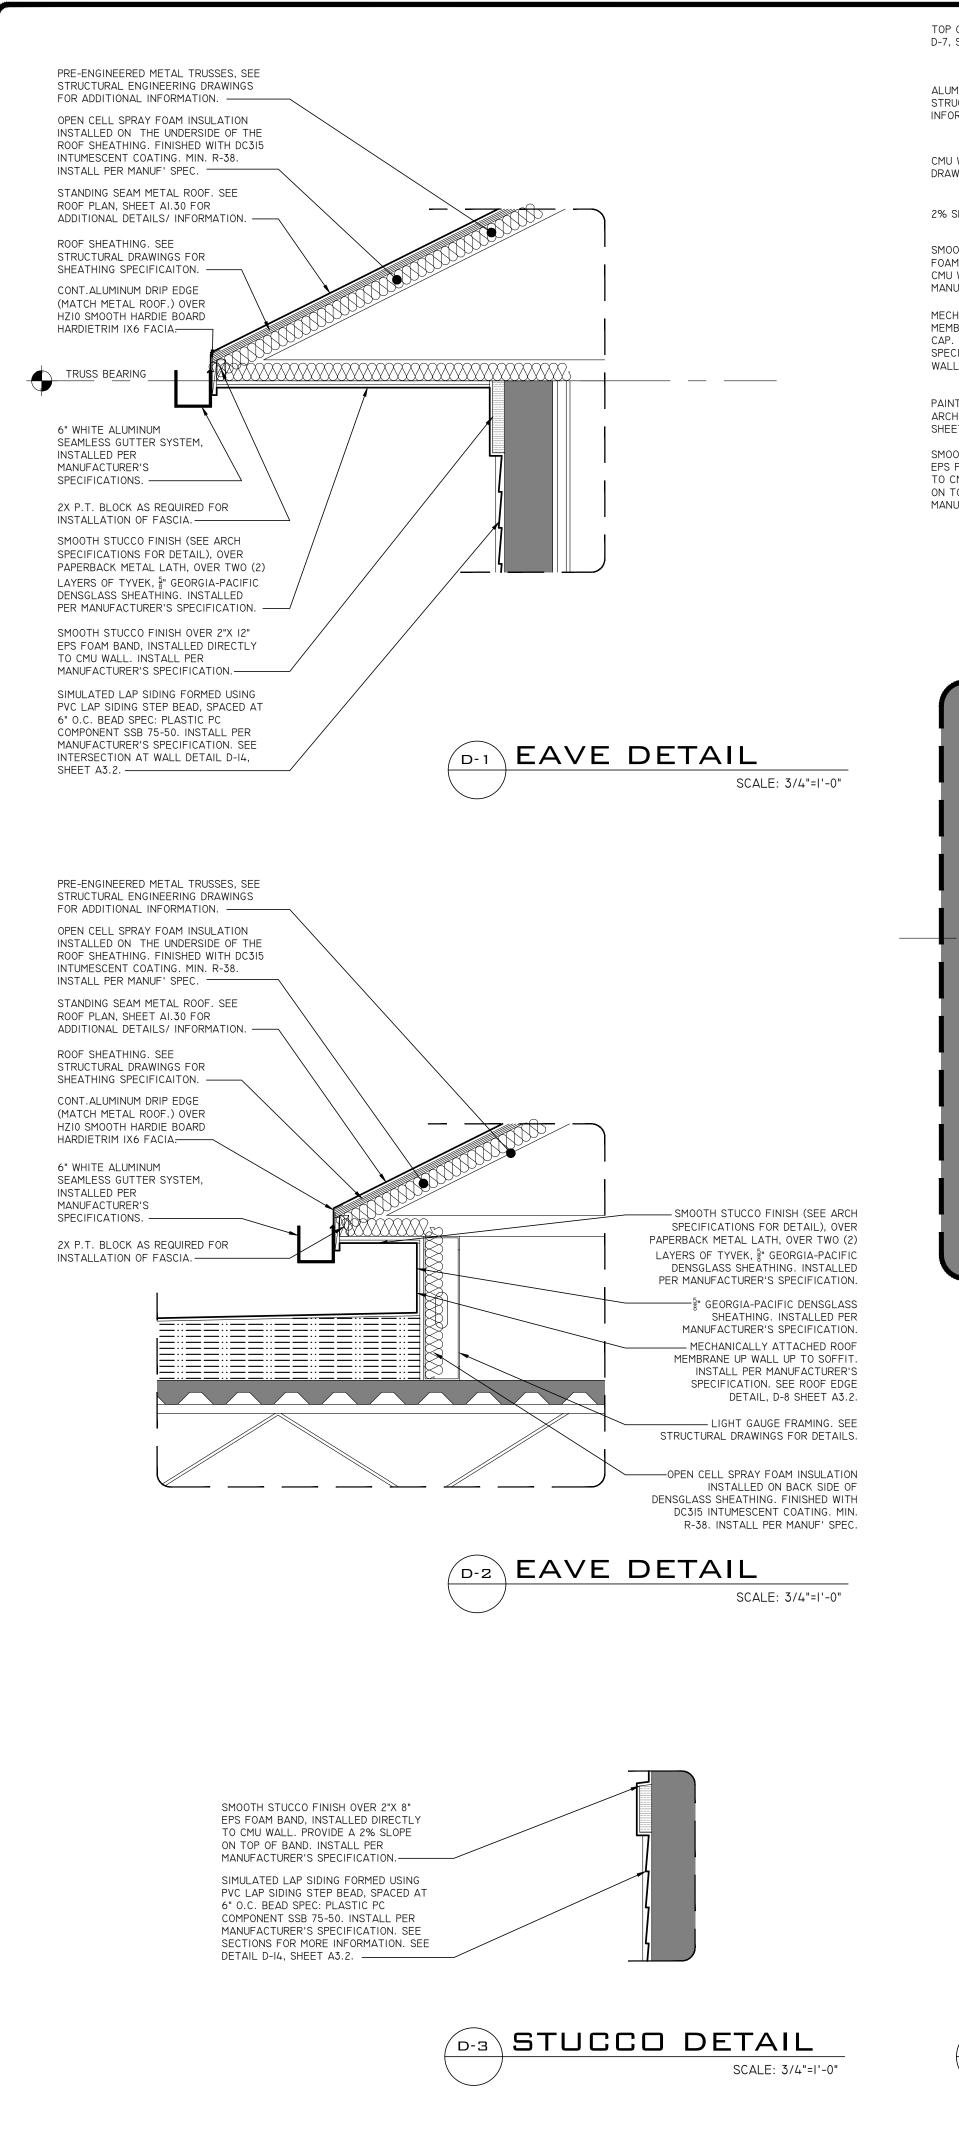


BRICK VENEER. SEE EXTERIOR ELEVATION FOR SPECIFICATION. —




SHED ROOF DETAIL

SCALE: 3/4"=1'-0"

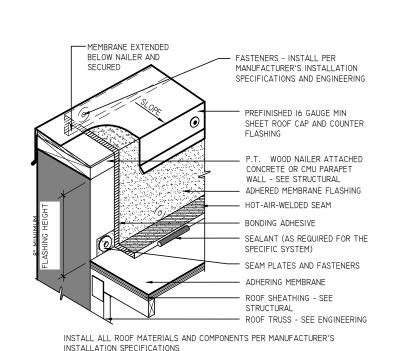


PARAPET WALL D-7 W/ ROOF CAP


SCALE: 3/4"=1'-0"

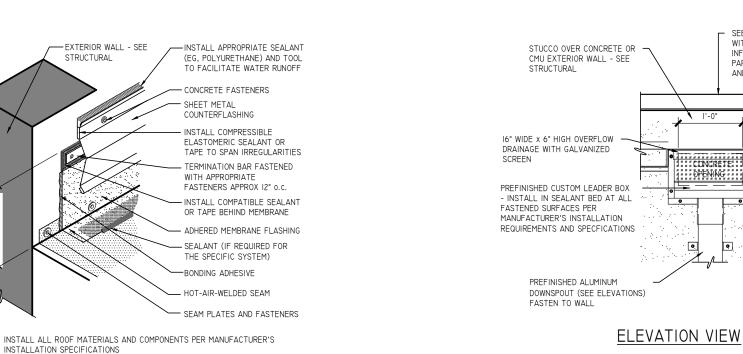



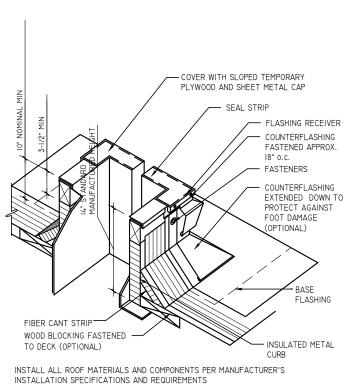




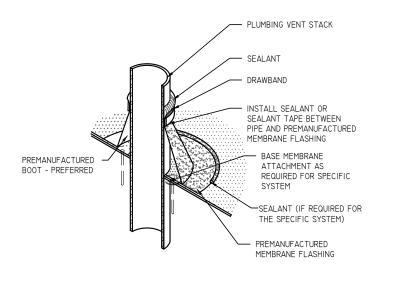

INSTALL ALL ROOF MATERIALS AND COMPONENTS PER MANUFACTURER'S



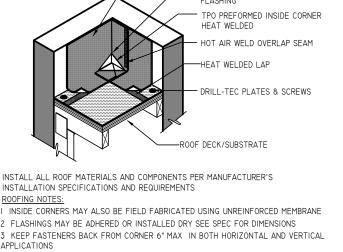

MEMBRANE PIECE TO MEMBRANE

SEE PARAPET WALL DETAIL

WITH ROOF CAP FOR ALL

INFORMATION ABOUT THE

PARAPET WALL, FRAMING

AND ROOF CAP

WITH ROOF CAP FOR ALL

INFORMATION ABOUT THE

PREFINISHED CUSTOM

LEADER BOX - INSTALL IN CONTINUOUS SEALANT

BED AT ALL FASTENING

2" @ OPENING EDGE

P.T. FURRING ATTACHED -

STUCCO OVER CONCRETE

PREFINISHED ALUMINUM

DOWNSPOUT (SEE ELEVATIONS)

OR CMU EXTERIOR WALL

FASTEN TO WALL

8"x8"xI6" BLOCK MISSING TO

PROVIDE OVERFLOW SCUPPER

FLASHING & COUNTER-FLASHIN

SPECIFICATIONS-

P.T. BLOCKING-

P.T. CANT STRIP -

SYSTEM INSTALLED PER MANUFACTURER'S SPECS

OVER 4" (MIIN) (R-30) RIGID INSULATION TAPERED TOWARD

ROOF DRAINS (SLOPE | "/FT.)

VERIFY SIZE WITH PLUMBING PLANS-

TO CONCRETE WALL

PARAPET WALL, FRAMING AND

ROOF CAP __ CONCRETE OR

CMU WALL - SEE

O ROOF MEMBRAN

OOF MEMBRANE TO WRAP

SCALE: 3/4"=1'-0"

BE WRAPPED OVER TOP OF 1/2 BLOCK SCUPPER

ENTIRE DRAINAGE AND

TRUSS OR ROOF FRAMING

- CONCRETE OR CMU WALL

I. TPO ROOF, RAIN GUTTER, AND DOWNSPOUTS TO BE INSTALLED PER

SECTION VIEW

(D-12) DOWN SPOUT DETAIL


OVERFLOW

MANUFACTURER'S INSTALLATION SPECIFICATIONS AND REQUIREMENTS


2. SEE ROOF PLAN FOR ALL OVERFLOW SCUPPER, ROOF DRAIN, AND DOWNSPOUT


STRUCTURAL

INSTALLATION SPECIFICATIONS AND REQUIREMENTS INSIDE CORNERS MAY ALSO BE FIELD FABRICATED USING UNREINFORCED MEMBRANE 2 FLASHINGS MAY BE ADHERED OR INSTALLED DRY SEE SPEC FOR DIMENSIONS 3 KEEP FASTENERS BACK FROM CORNER 6" MAX IN BOTH HORIZONTAL AND VERTICAL 4 PLATES & SCREWS - SPACING PER SPECIFICATIONS 5 APPLY TPO - CUT EDGE SEALANT TO ALL CUT REINFORCED TPO EDGES

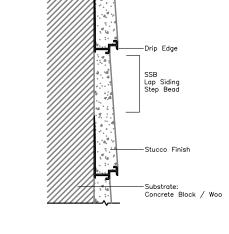




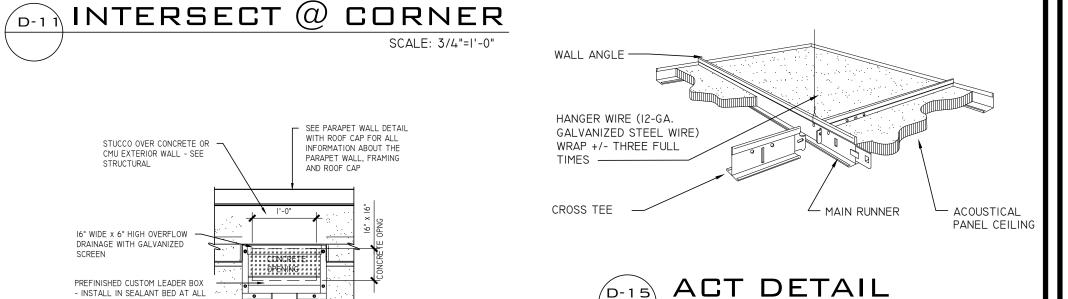

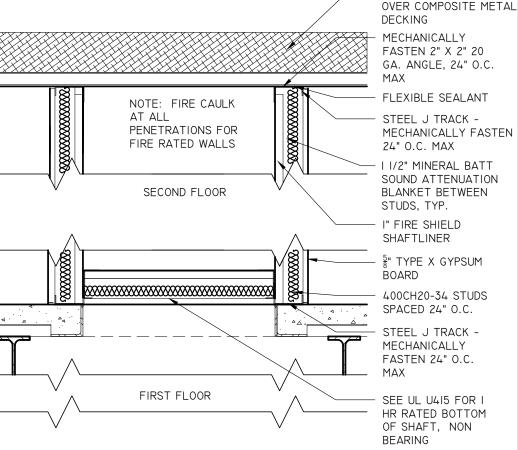

SEE FIRE WALL DETAIL N4, SHEET AI.01.

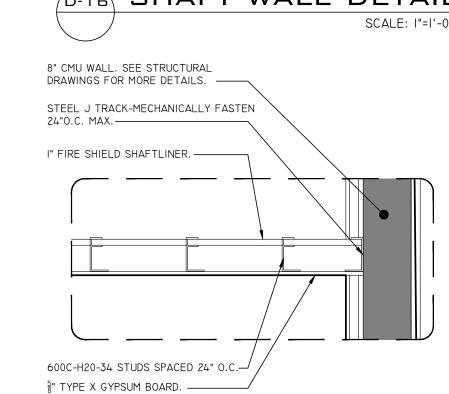



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ARCHITECTURE

1542 GUAVA AVE

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3 2 1 . 4 2 8 . 3 8 6 9

JOB #:

REVISIONS:

SCALE: N.T.S.

ROOFING ASSEMBLY,

TAPERED INSULATION

DRAWN: JKA

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> > SECTION **DETAILS**


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1-HOUR RATED SHAFT WALL DETAIL SCALE: I"=I'-0". NOTE: FIRE CAULK AT ALL PENETRATIONS

D-13 SCUPPER DETAIL SCALE: 3/4"=1'-0" SCALE: 3/4"=1'-0".

FOR FIRE RATED WALLS.

UL DESIGN NO. U415



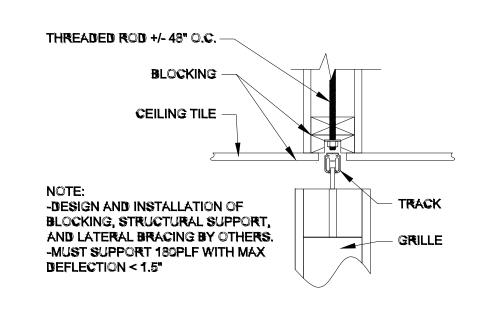

ARCHITECTURE

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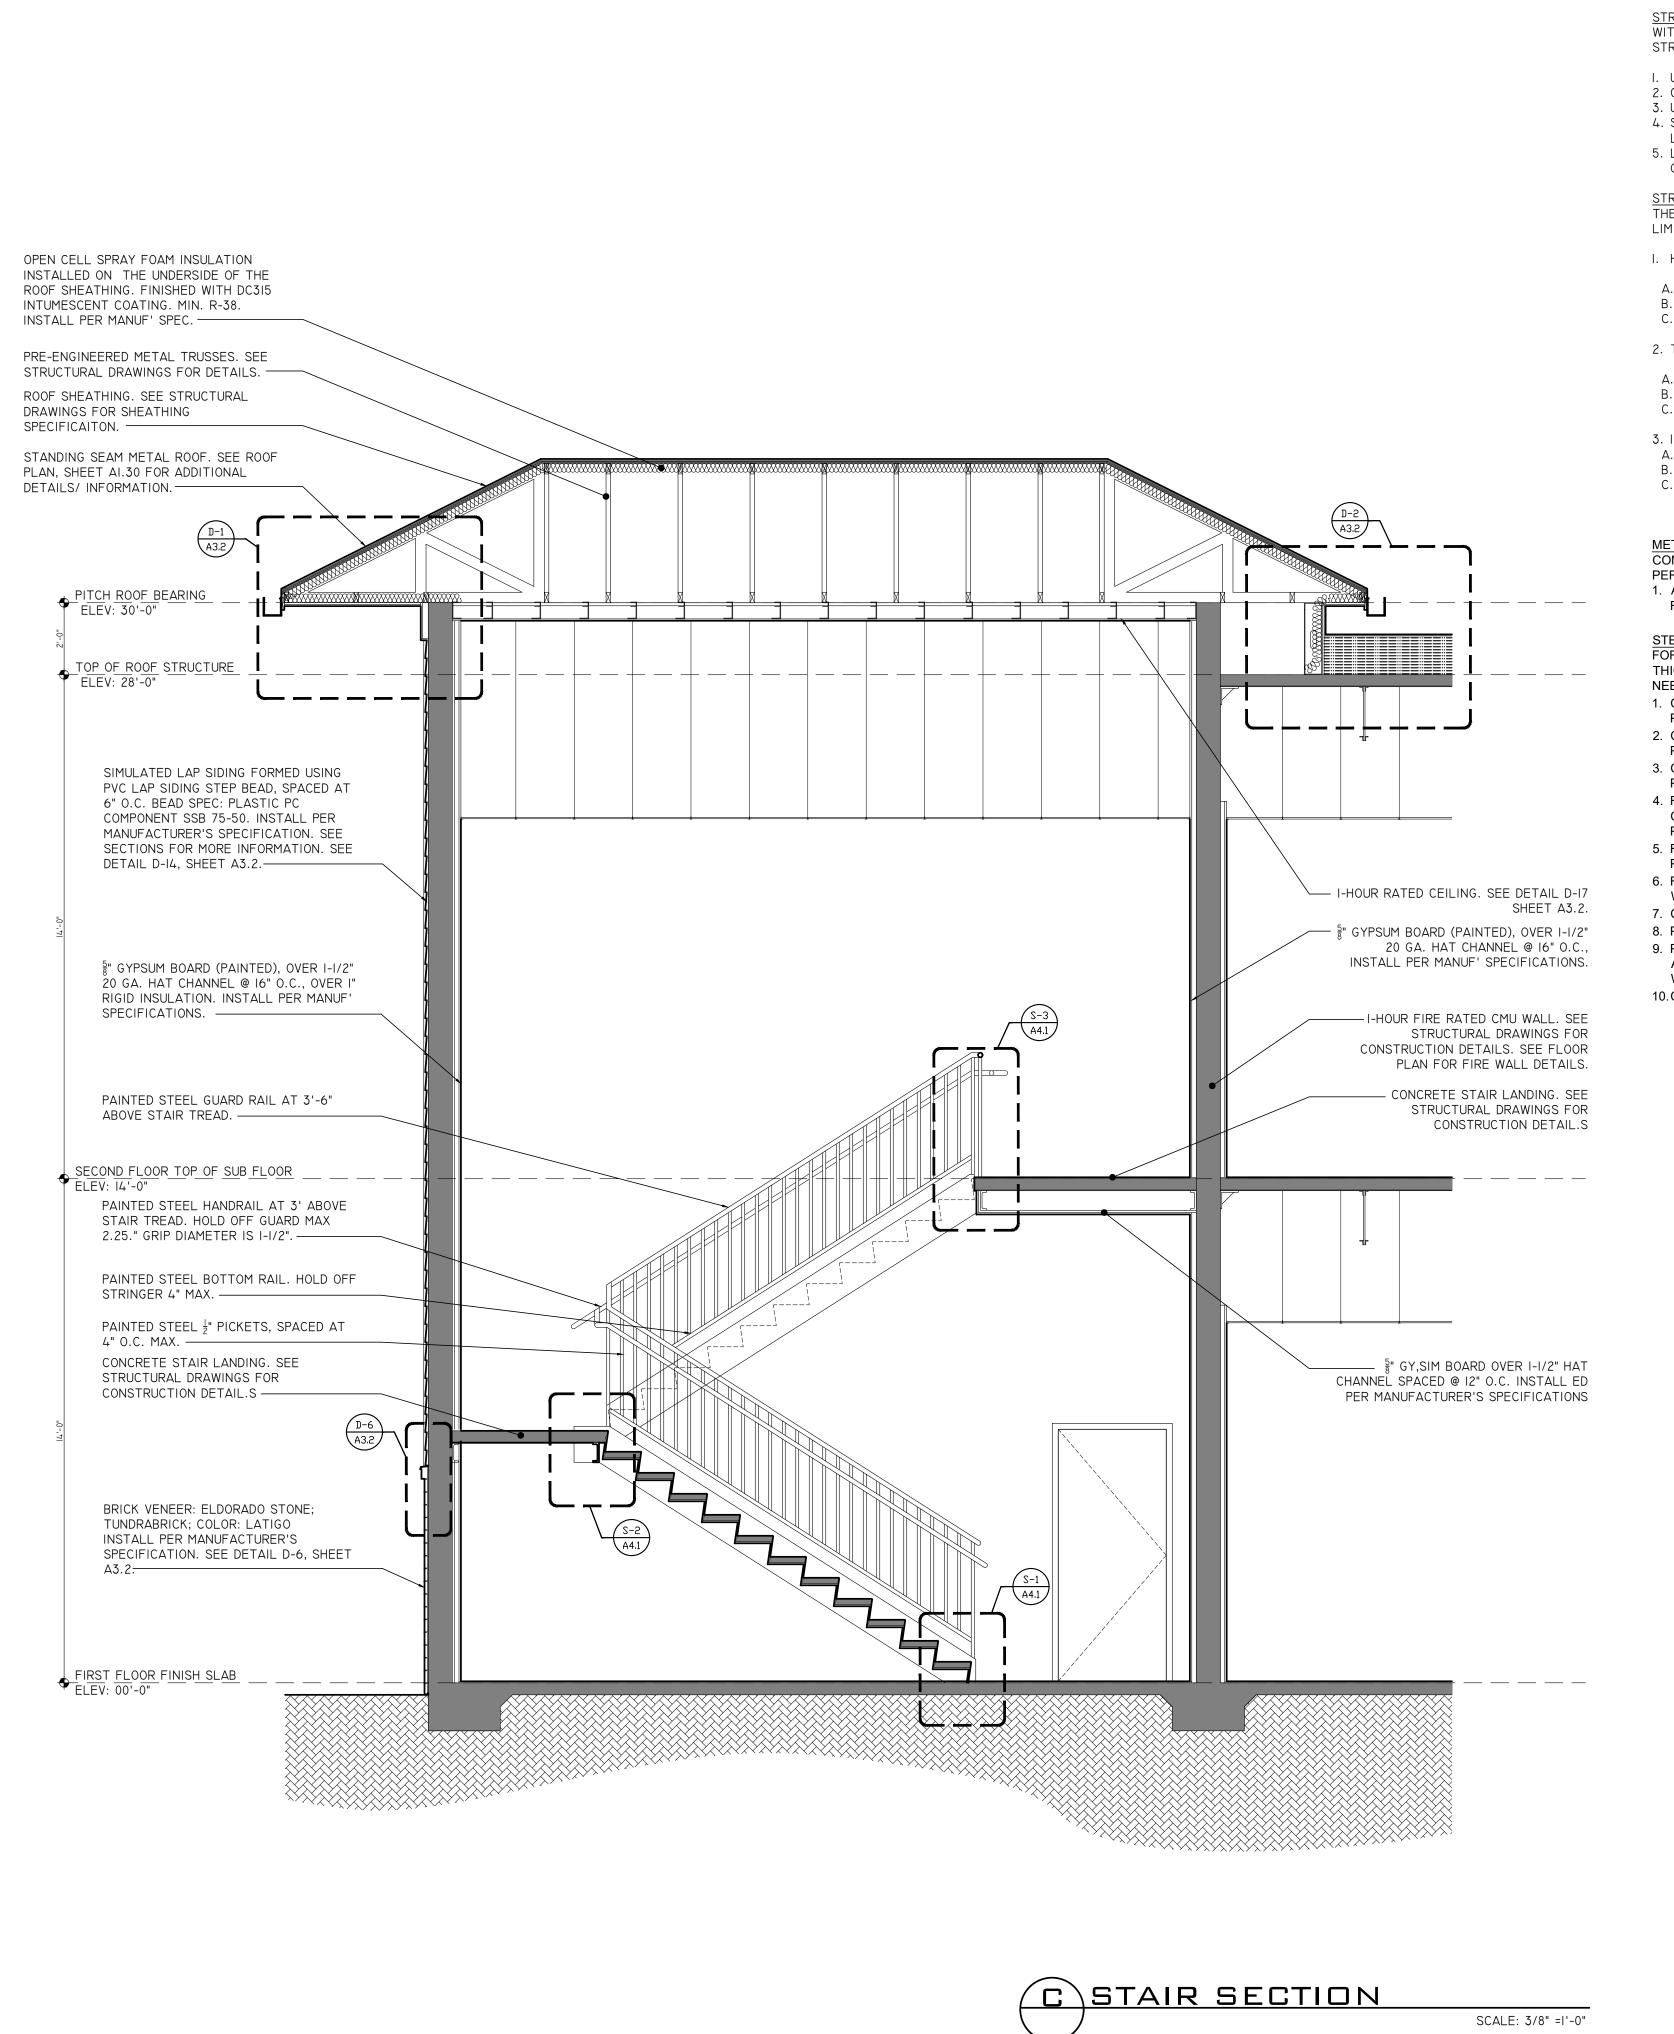
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SECTION DETAILS



STRUCTURAL PERFORMANCE OF STAIRS: PROVIDE METAL STAIRS CAPABLE OF WITHSTANDING THE EFFECTS OF GRAVITY LOADS AND THE FOLLOWING LOADS AND STRESSES WITHIN LIMITS AND UNDER CONDITIONS INDICATED:

I. UNIFORM LOAD: 100 LBF/SQ. FT.

- 2. CONCENTRATED LOAD: 300 LBF APPLIED ON AN AREA OF 4 SQ. IN. 3. UNIFORM AND CONCENTRATED LOADS NEED NOT BE ASSUMED TO ACT CONCURRENTLY. 4. STAIR FRAMING: CAPABLE OF WITHSTANDING STRESSES RESULTING FROM RAILING
- LOADS IN ADDITION TO LOADS SPECIFIED ABOVE. 5. LIMIT DEFLECTION OF TREADS, PLATFORMS, AND FRAMING MEMBERS TO AS INDICATED ON STRUCTURAL DRAWINGS OR 1/4 INCH, WHICHEVER IS LESS.

STRUCTURAL PERFORMANCE OF RAILINGS: PROVIDE RAILINGS CAPABLE OF WITHSTANDING THE EFFECTS OF GRAVITY LOADS AND THE FOLLOWING LOADS AND STRESSES WITHIN LIMITS AND UNDER CONDITIONS INDICATED:

I. HANDRAILS:

- A. UNIFORM LOAD OF 50 LBF/ FT. APPLIED IN ANY DIRECTION.
- CONCENTRATED LOAD OF 200 LBF APPLIED IN ANY DIRECTION. UNIFORM AND CONCENTRATED LOADS NEED NOT BE ASSUMED TO ACT
- CONCURRENTLY. 2. TOP RAILS OF GUARDS:
- A. UNIFORM LOAD OF 50 LBF/ FT. APPLIED IN ANY DIRECTION.
- CONCENTRATED LOAD OF 200 LBF APPLIED IN ANY DIRECTION. UNIFORM AND CONCENTRATED LOADS NEED NOT BE ASSUMED TO ACT
- 3. INFILL OF GUARDS: A. CONCENTRATED LOAD OF 50 LBF APPLIED HORIZONTALLY ON AN AREA OF I SQ. FT. UNIFORM LOAD OF 25 LBF/SQ. FT. APPLIED HORIZONTALLY.
- INFILL LOAD AND OTHER LOADS NEED NOT BE ASSUMED TO ACT CONCURRENTLY.


METAL-PAN STAIRS: FORM RISERS, SUBTREAD PANS, AND SUBPLATFORMS TO CONFIGURATIONS SHOWN FROM STEEL SHEET OF THICKNESS NEEDED TO COMPLY WITH PERFORMANCE REQUIREMENTS BUT NOT LESS THAN 0.0677 INCH.

1. AT CONTRACTOR'S OPTION, PROVIDE STAIR ASSEMBLIES WITH METAL-PAN SUBTREADS FILLED WITH REINFORCED CONCRETE DURING FABRICATION.


STEEL TUBE RAILINGS: FABRICATE RAILINGS TO COMPLY WITH REQUIREMENTS INDICATED FOR DESIGN, DIMENSIONS, DETAILS, FINISH, AND MEMBER SIZES, INCLUDING WALL THICKNESS OF TUBE, POST SPACING'S, AND ANCHORAGE, BUT NOT LESS THAN THAT

- NEEDED TO WITHSTAND INDICATED LOADS. 1. CONFIGURATION: 1-5/8-INCH- DIAMETER TOP AND BOTTOM RAILS, 1-1/2-INCH- SQUARE POSTS, AND 1/2-INCH- SQUARE PICKETS SPACED LESS THAN 4 INCHES CLEAR.
- 2. CONFIGURATION: 1-1/2-INCH- SQUARE TOP AND BOTTOM RAILS AND POSTS WITH INFILL PANELS MADE FROM WOVEN WIRE MESH IN STEEL CHANNEL FRAMES. 3. CONFIGURATION: 1-1/2-INCH- SQUARE TOP, BOTTOM, AND INTERMEDIATE RAILS AND
- POSTS. SPACE INTERMEDIATE RAILS LESS THAN 12 INCHES CLEAR.
- 4. FABRICATE RAILINGS WITH WELDED CONNECTIONS. COPE COMPONENTS AT CONNECTIONS TO PROVIDE CLOSE FIT, OR USE FITTINGS DESIGNED FOR THIS PURPOSE.
- 5. FORM CHANGES IN DIRECTION OF RAILINGS BY BENDING OR BY INSERTING PREFABRICATED FITTINGS.
- 6. FORM CURVES BY BENDING MEMBERS IN JIGS TO PRODUCE UNIFORM CURVATURE WITHOUT BUCKLING.
- 7. CLOSE EXPOSED ENDS OF RAILING MEMBERS WITH PREFABRICATED END FITTINGS. 8. PROVIDE WALL RETURNS AT ENDS OF WALL-MOUNTED HANDRAILS.
- 9. PROVIDE WALL BRACKETS, END CLOSURES, FLANGES, MISCELLANEOUS FITTINGS, AND ANCHORS FOR INTERCONNECTING COMPONENTS AND FOR ATTACHING TO OTHER

10. CONNECT POSTS TO STAIR FRAMING BY DIRECT WELDING.

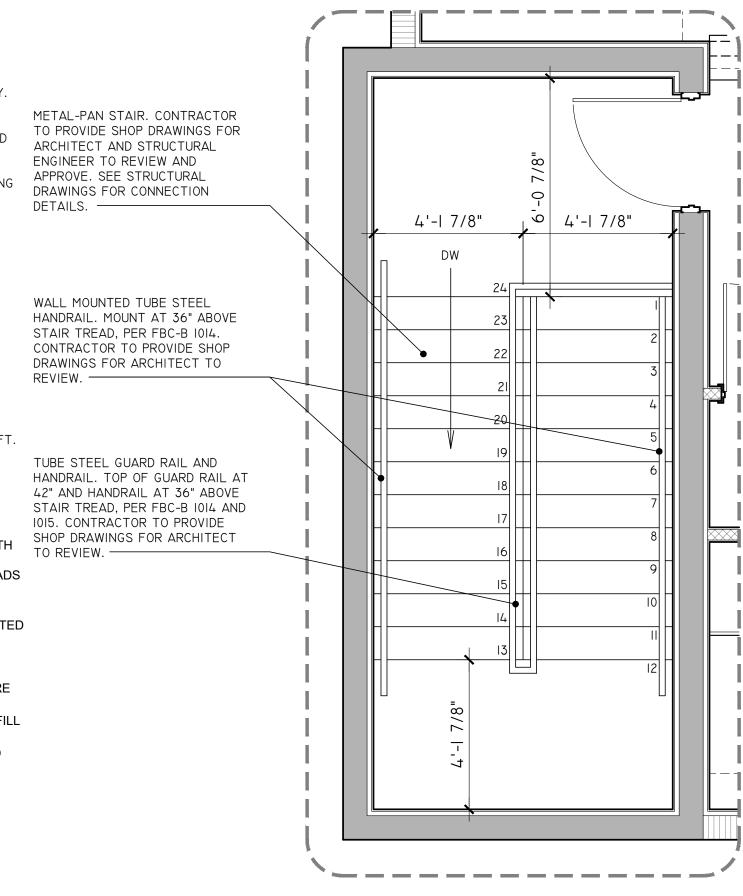



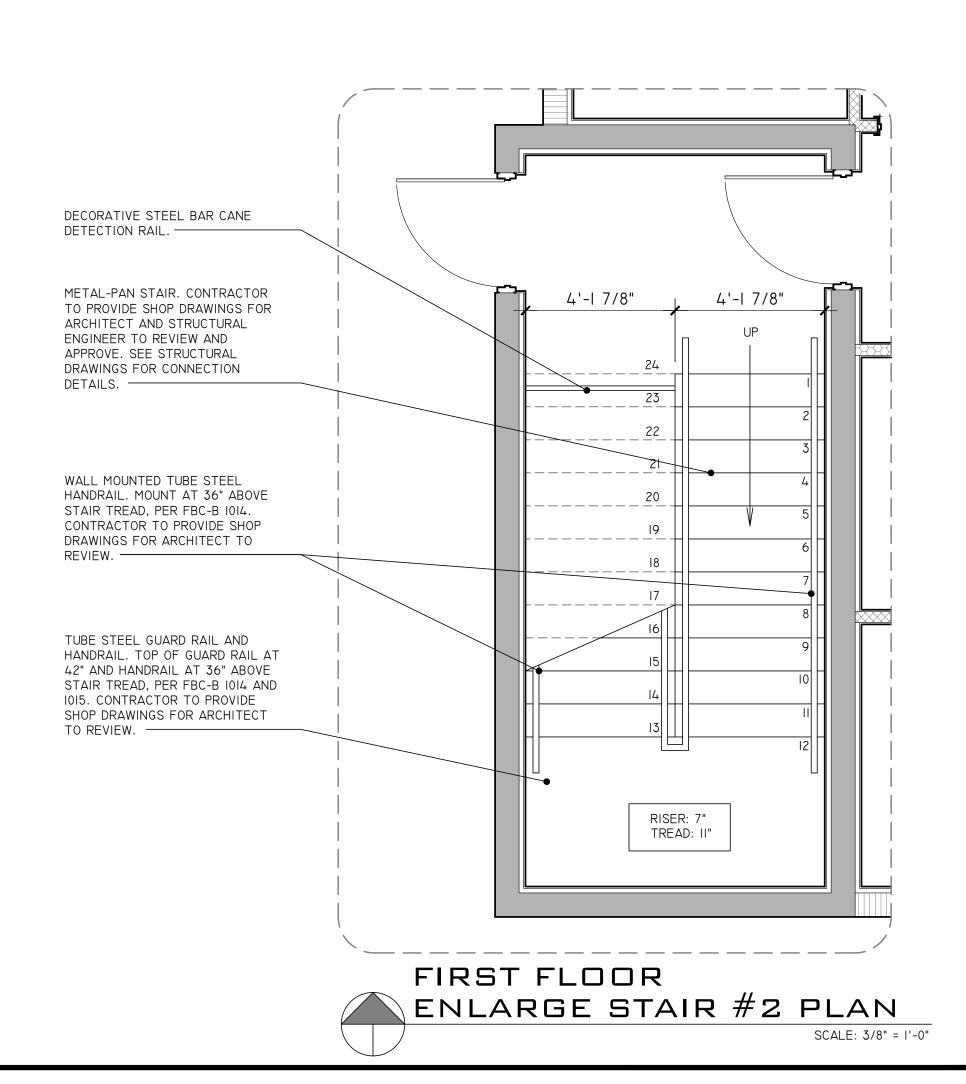



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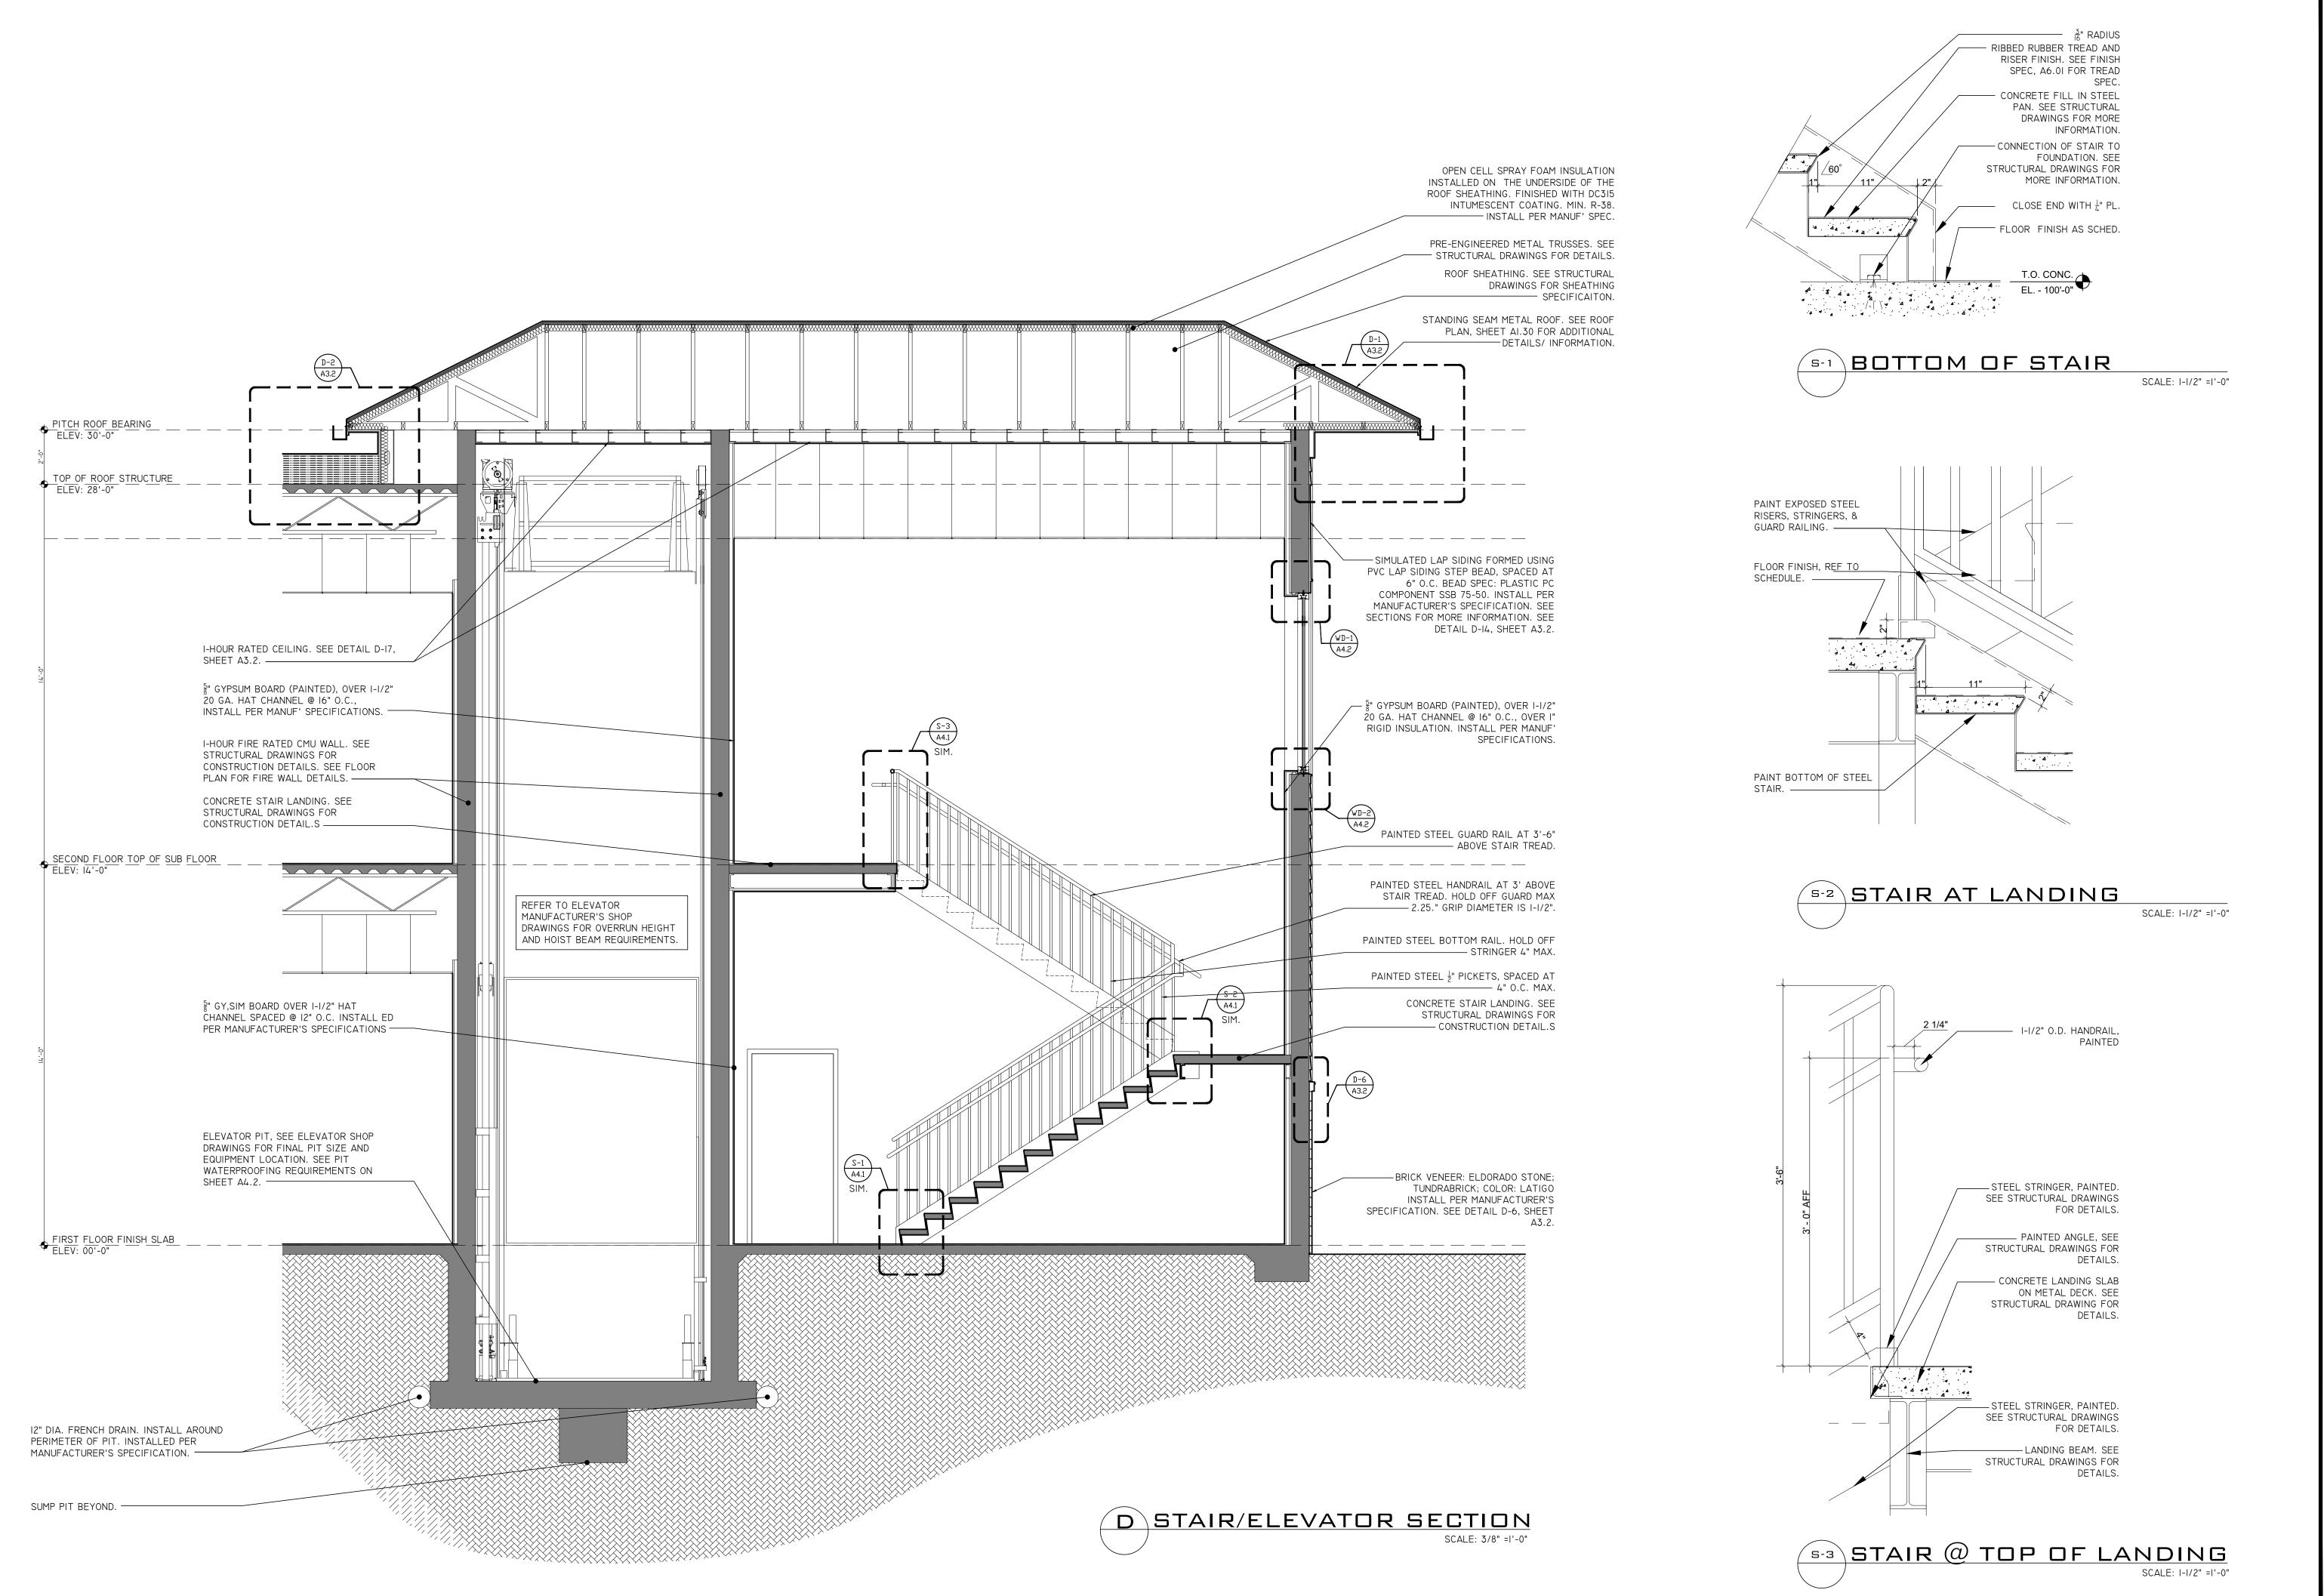
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> > STAIR SECTION



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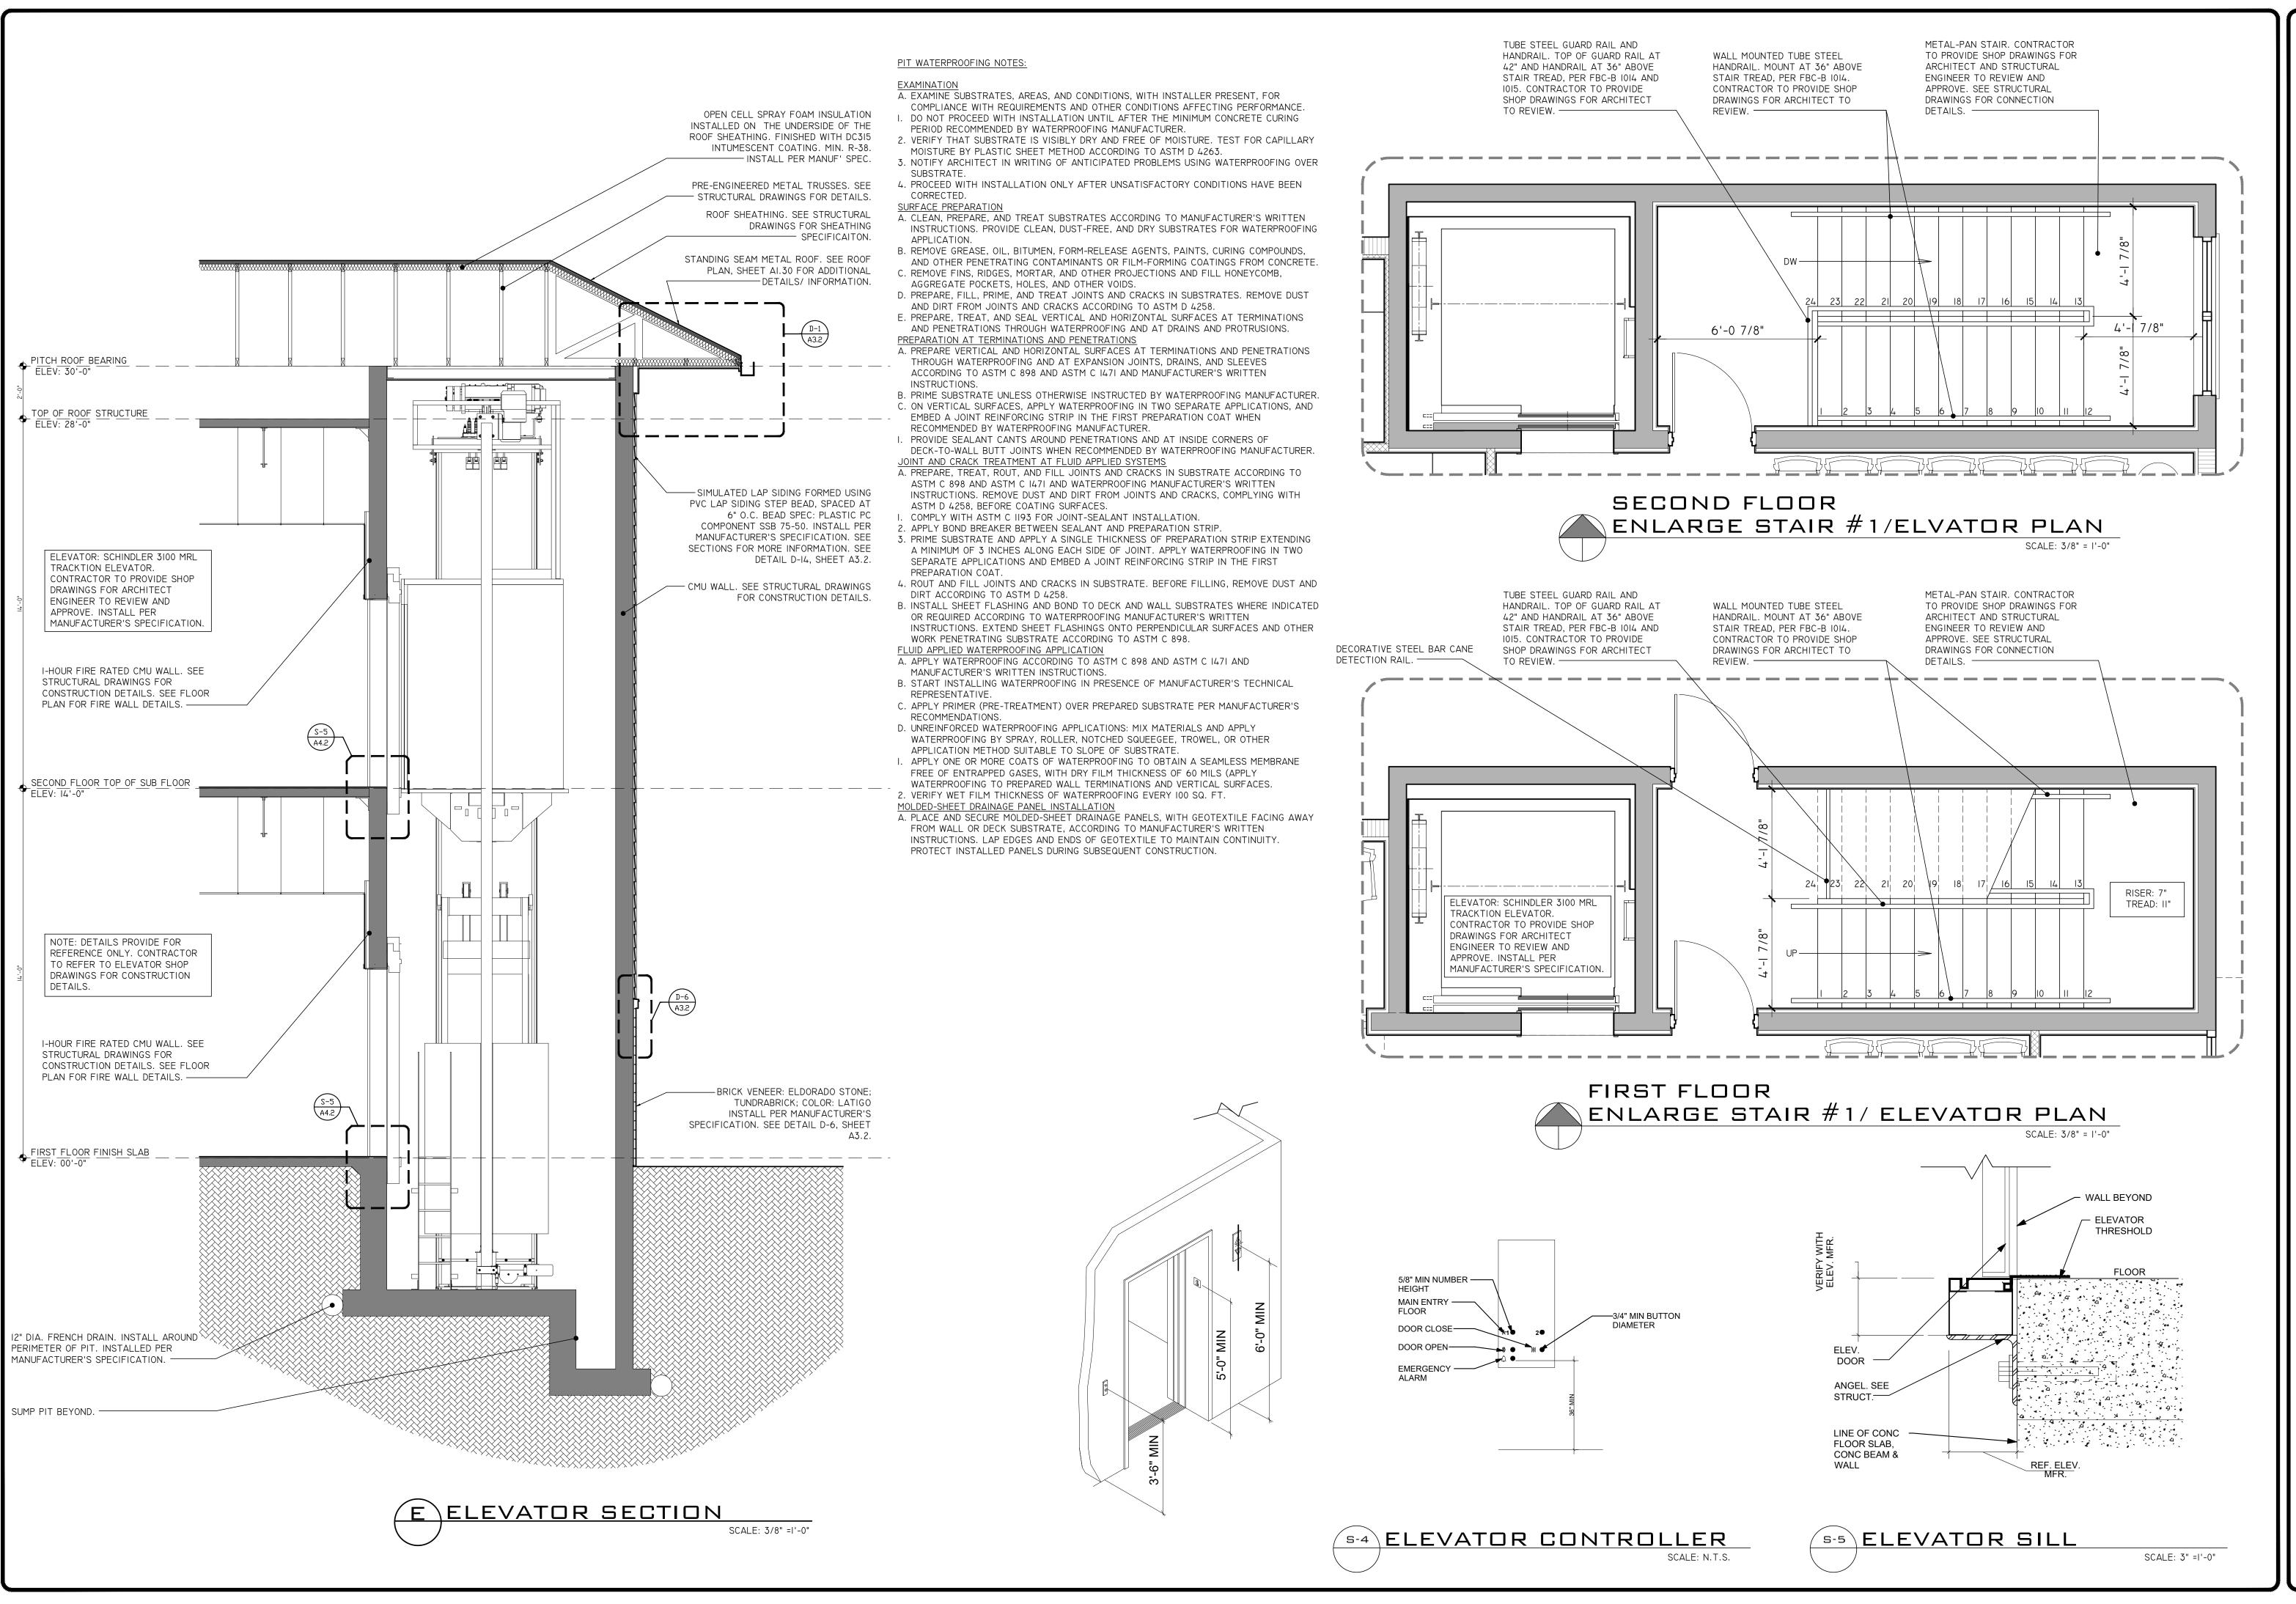
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STAIR/ **ELEVATOR**

SECTION



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ELEVATOR SECTION

INTERIOR	Do	OR SCHE	DULE							
ROOM NAME	TAG	DOOR SIZE (WIDTH X HEIGHT)	THICKNESS	FIRE DOOR YES/ NO	DOOR MATERIAL	FRAME MATERIAL	JAMB STYLE	HARDWARE	AUTOMATIC CLOSER	NOTES:
STAIR #I	(OO-A)	3'-0" X 7'-0	1.375"	60 MINUTE	MC5-60 FIRE RESISTANT CORE DOOR	FIVE LAKES MANUFACTURING	HMJ	PANIC HARDWARE (SEE SPEC)	YES	
MALE RESTROOM	(02-A)	3'-0" X 7'-0	1.375"	NO	BONDED 5-PLY PARTICLE CORE DOOR	FIVE LAKES MANUFACTURING	HMJ	PRIVACY (SEE SPEC)	YES	
WAITING AREA	(03-A)	3'-0" X 7'-0	1.375"	NO	BONDED 5-PLY PARTICLE CORE DOOR	FIVE LAKES MANUFACTURING	HMJ	ACCESS CONTROL (SEE SPEC)	YES	
WAITING AREA	(03-B)	3'-0" X 7'-0	1.375"	NO	BONDED 5-PLY PARTICLE CORE DOOR	FIVE LAKES MANUFACTURING	HMJ	ACCESS CONTROL (SEE SPEC)	YES	DELAYED EGRESS DOOR PER FBC-B 1010.1.9.8.
PHARMACY	(04-2)	3'-0" X 7'-0	1.375"	NO	BONDED 5-PLY PARTICLE CORE DOOR	FIVE LAKES MANUFACTURING	HMJ	ACCESS CONTROL (SEE SPEC)	YES	
BEHAVIORAL HEALTH OFFICE #I	(05-2)	3'-0" X 7'-0	1.375"	NO	BONDED 5-PLY PARTICLE CORE DOOR	FIVE LAKES MANUFACTURING	HMJ	PRIVACY (SEE SPEC)	NO	
NEW MOTHER'S ROOM	(06- A)	3'-0" X 7'-0	1.375"	NO	BONDED 5-PLY PARTICLE CORE DOOR	FIVE LAKES MANUFACTURING	HMJ	PRIVACY (SEE SPEC)	NO	
BEHAVIORAL HEALTH OFFICE #2	(07-B)	3'-0" X 7'-0	1.375"	NO	BONDED 5-PLY PARTICLE CORE DOOR	FIVE LAKES MANUFACTURING	HMJ	PRIVACY (SEE SPEC)	NO	
RECEPTION AREA	(08-4)	3'-0" X 7'-0	1.375"	NO	BONDED 5-PLY PARTICLE CORE DOOR	FIVE LAKES MANUFACTURING	НМЈ	ACCESS CONTROL (SEE SPEC)	YES	
MANAGER'S OFFICE	(09-2)	3'-0" X 7'-0	1.375"	NO	BONDED 5-PLY PARTICLE CORE DOOR	FIVE LAKES MANUFACTURING	HMJ	PRIVACY (SEE SPEC)	NO	
JANITOR'S CLOSET	(10-A)	3'-0" X 7'-0	1.375"	NO	BONDED 5-PLY PARTICLE CORE DOOR	FIVE LAKES MANUFACTURING	HMJ	ACCESS CONTROL (SEE SPEC)	YES	
BREAK ROOM	(II-A)	3'-0" X 7'-0	1.375"	NO	BONDED 5-PLY PARTICLE CORE DOOR	FIVE LAKES MANUFACTURING	HMJ	PASSAGE (SEE SPEC)	YES	
STAIR #2	(12-A)	3'-0" X 7'-0	1.375"	60 MINUTE	MC5-60 FIRE RESISTANT CORE DOOR	FIVE LAKES MANUFACTURING	HMJ	PANIC HARDWARE (SEE SPEC)	YES	
IT CLOSET	(13-A)	3'-0" X 7'-0	1.375"	NO	BONDED 5-PLY PARTICLE CORE DOOR	FIVE LAKES MANUFACTURING	HMJ	ACCESS CONTROL (SEE SPEC)	NO	
SUPPLY STORAGE	(14-4)	3'-0" X 7'-0	1.375"	NO	BONDED 5-PLY PARTICLE CORE DOOR	FIVE LAKES MANUFACTURING	HMJ	ACCESS CONTROL (SEE SPEC)	YES	
FEMALE RESTROOM	(15-A)	3'-0" X 7'-0	1.375"	NO	BONDED 5-PLY PARTICLE CORE DOOR	FIVE LAKES MANUFACTURING	HMJ	PRIVACY (SEE SPEC)	YES	
SANITARY ROOM	(16-4)	3'-0" X 7'-0	1.375"	NO	BONDED 5-PLY PARTICLE CORE DOOR	FIVE LAKES MANUFACTURING	HMJ	ACCESS CONTROL (SEE SPEC)	NO	
DENTAL OPERATORY	(17-4)	3'-0" X 7'-0	1.375"	NO	BONDED 5-PLY PARTICLE CORE DOOR	FIVE LAKES	HMJ	PRIVACY (SEE SPEC)	YES	
DENTAL OPERATORY	(17-B)	3'-0" X 7'-0	1.375"	NO	BONDED 5-PLY PARTICLE CORE DOOR	MANUFACTURING FIVE LAKES	HMJ	PASSAGE (SEE SPEC)	NO	
DENTAL OPERATORY	(17-0)	3'-0" X 7'-0	1.375"	NO	BONDED 5-PLY PARTICLE	MANUFACTURING FIVE LAKES	HMJ	PASSAGE (SEE SPEC)	NO	
DENTAL PROVIDER OFF.	(18-A)	3'-0" X 7'-0	SEE SPEC	NO	CORE DOOR BONDED 5-PLY PARTICLE	MANUFACTURING FIVE LAKES	POCKET	POCKET DOOR (SEE SPEC)	NO	POCKET DOOR
FAMILY HEALTH EXAM ROOM #I	200-3	3'-0" X 7'-0	1.375"	NO	CORE DOOR BONDED 5-PLY PARTICLE	MANUFACTURING FIVE LAKES	HMJ	PASSAGE (SEE SPEC)	NO	
FAMILY HEALTH PROVIDER OFFICE	201-2	3'-0" X 7'-0	1.375"	NO	CORE DOOR BONDED 5-PLY PARTICLE	MANUFACTURING FIVE LAKES	HMJ	PASSAGE (SEE SPEC)	NO	
OFFICE	(02-)	3'-0" X 7'-0	1.375"	NO	BONDED 5-PLY PARTICLE	MANUFACTURING FIVE LAKES	HMJ	PRIVACY (SEE SPEC)	NO	
WAITING AREA	(03-)	3'-0" X 7'-0	1.375"	60 MINUTE	CORE DOOR MC5-60 FIRE RESISTANT	MANUFACTURING FIVE LAKES	HMJ	PANIC HARDWARE (SEE SPEC)	YES	
WAITING AREA	(03-)	3'-0" X 7'-0	1.375"	NO	BONDED 5-PLY PARTICLE	MANUFACTURING FIVE LAKES	HMJ	ACCESS CONTROL (SEE SPEC)	YES	DELAYED EGRESS DOOR PER FBC-B 1010.1.9.8.
WAITING AREA	203-0	3'-0" X 7'-0	1.375"	NO	CORE DOOR BONDED 5-PLY PARTICLE	MANUFACTURING FIVE LAKES	HMJ	ACCESS CONTROL (SEE SPEC)	YES	DELAYED EGRESS DOOR PER FBC-B 1010.1.9.8.
FAMILY HEALTH EXAM	204-2	3'-0" X 7'-0	1.375"	NO	CORE DOOR BONDED 5-PLY PARTICLE	MANUFACTURING FIVE LAKES	HMJ	PASSAGE (SEE SPEC)	NO NO	DELATED EGILEGO POGICI EN 180 B 1010
ROOM #5 FAMILY HEALTH EXAM ROOM #2	205-2	3'-0" X 7'-0	1.375"	NO	CORE DOOR BONDED 5-PLY PARTICLE	MANUFACTURING FIVE LAKES	HMJ	PASSAGE (SEE SPEC)	NO	
FAMILY HEALTH EXAM	206-2	3'-0" X 7'-0	1.375"	NO	CORE DOOR BONDED 5-PLY PARTICLE	MANUFACTURING FIVE LAKES	HMJ	PASSAGE (SEE SPEC)	NO	
ROOM #3 FAMILY HEALTH EXAM	207-3	3'-0" X 7'-0	1.375"	NO	CORE DOOR BONDED 5-PLY PARTICLE	MANUFACTURING FIVE LAKES	HMJ	PASSAGE (SEE SPEC)	NO	
ROOM #4 FAMILY HEALTH EXAM	(08-B	3'-0" X 7'-0	1.375"	NO	CORE DOOR BONDED 5-PLY PARTICLE	MANUFACTURING FIVE LAKES	HMJ	PASSAGE (SEE SPEC)	NO	
ROOM #6 FEMALE RESTROOM	209-3	3'-0" X 7'-0	1.375"	NO	CORE DOOR BONDED 5-PLY PARTICLE	MANUFACTURING FIVE LAKES	HMJ	PRIVACY (SEE SPEC)	YES	
PEDS EXAM ROOM #1	211-A	3'-0" X 7'-0	1.375"	NO	CORE DOOR BONDED 5-PLY PARTICLE	MANUFACTURING FIVE LAKES	HMJ	PASSAGE (SEE SPEC)	NO NO	
PEDS EXAM ROOM #2	(212-A)	3'-0" X 7'-0	1.375"	NO	CORE DOOR BONDED 5-PLY PARTICLE	MANUFACTURING FIVE LAKES	HMJ	PASSAGE (SEE SPEC)	NO	
PEDS EXAM ROOM #4	@13- <u>A</u>	3'-0" X 7'-0	1.375"	NO	CORE DOOR BONDED 5-PLY PARTICLE	MANUFACTURING FIVE LAKES	HMJ	PASSAGE (SEE SPEC)	NO	
FAMILY HEALTH EXAM	214-2	3'-0" X 7'-0	1.375"	NO NO	CORE DOOR BONDED 5-PLY PARTICLE	MANUFACTURING FIVE LAKES	HMJ	PASSAGE (SEE SPEC)	NO NO	
ROOM #7 FAMILY HEALTH EXAM	216-2	3'-0" X 7'-0	1.375"	NO	CORE DOOR BONDED 5-PLY PARTICLE	MANUFACTURING FIVE LAKES	HMJ	PASSAGE (SEE SPEC)	NO NO	
ROOM #8 MALE RESTROOM	217-A	3'-0" X 7'-0	1.375"	NO	CORE DOOR BONDED 5-PLY PARTICLE	MANUFACTURING FIVE LAKES	HMJ	PRIVACY (SEE SPEC)	YES	
PEDS EXAM ROOM #5		3'-0" X 7'-0	1.375"	NO	CORE DOOR BONDED 5-PLY PARTICLE	MANUFACTURING FIVE LAKES	HMJ	PASSAGE (SEE SPEC)	NO NO	
PEDS EXAM ROOM #3	(218-A)	3'-0" X 7'-0	1.375"	NO NO	CORE DOOR BONDED 5-PLY PARTICLE	MANUFACTURING FIVE LAKES	HMJ	PASSAGE (SEE SPEC)	NO	
PEDS PROVIDER OFFICE	(219-A)	3'-0" X 7'-0	1.375"	NO NO	CORE DOOR BONDED 5-PLY PARTICLE	MANUFACTURING FIVE LAKES	HMJ	PASSAGE (SEE SPEC)	NO	
SUPPLY STORAGE	(20- A	3'-0" X 7'-0	1.375"	NO NO	CORE DOOR BONDED 5-PLY PARTICLE	MANUFACTURING FIVE LAKES	HMJ	ACCESS CONTROL (SEE SPEC)		
	(221-B)				CORE DOOR BONDED 5-PLY PARTICLE	MANUFACTURING FIVE LAKES			YES	
MEDICAL STORAGE	(22-)	3'-0" X 7'-0	1.375"	NO NO	CORE DOOR BONDED 5-PLY PARTICLE	MANUFACTURING FIVE LAKES	HMJ	ACCESS CONTROL (SEE SPEC)	YES	
CORRIDOR	(23-A)	3'-0" X 7'-0	1.375"	NO NO	CORE DOOR BONDED 5-PLY PARTICLE	MANUFACTURING FIVE LAKES	HMJ	ACCESS CONTROL (SEE SPEC)	YES	
CORRIDOR	(23-b)	3'-0" X 7'-0	1.375"	NO NO	CORE DOOR MC5-60 FIRE RESISTANT	MANUFACTURING FIVE LAKES	HMJ	PASSAGE (SEE SPEC)	YES	
CORRIDOR	23-0	3'-0" X 7'-0	1.375"	60 MINUTE	CORE DOOR BONDED 5-PLY PARTICLE	MANUFACTURING FIVE LAKES	HMJ	PANIC HARDWARE (SEE SPEC)	YES	
UNISEX RESTROOM	(24-)	3'-0" X 7'-0	1.375"	NO	CORE DOOR BONDED 5-PLY PARTICLE	MANUFACTURING FIVE LAKES	HMJ	PRIVACY (SEE SPEC)	YES	
LAB	(25-)	3'-0" X 7'-0	1.375"	NO	CORE DOOR	MANUFACTURING	HMJ	ACCESS CONTROL (SEE SPEC)	NO	


INTERIOR DOOR SPECIFICATION: FRAME: MESKER; DW SERIES DRYWALL FRAMES


DOOR: FIVE LAKES MANUFACTURING

<u>HARDWARE:</u> SEE SEPARATE HARDWARE DOCUMENT FOR MORE INFORMATION.

-ALL NEW HARDWARE TO BE COMMERCIAL GRADE AND MATCH EXISTING WITH ADA LEVERSET TYPE HARDWARE AND MEET ALL ADA REQUIREMENTS.
-LOCKSETS INSIDE THE BUILDING MAY NOT REQUIRE THE USE OF A KEY, TOOL, OR SPECIAL KNOWLEDGE TO UNLOCK FROM THE INSIDE OF THE ROOM. (7TH EDITION FLORIDA FIRE PREVENTION CODE).

-ALL DOORS SHALL BE EQUIPPED WITH FLOOR MOUNT DOOR-STOPS.

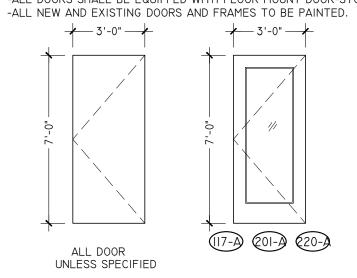

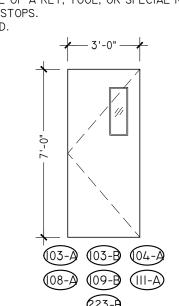

EXTERIOR DOOR SCHEDULE TAG DOOR SIZE (WIDTH X HEIGHT) THICKNESS TRANSOM SIDELIGHT DESCRIPTION MATERIAL FINISH AUTOMATIC HARDWARE NOTES (W. X H.) (W. X H.) PANIC HARDWARE /ACCESS CONTROL (100) 3'-0" X 8'-0" | SEE MANF' | IMPACT/ INSULATED N/A N/A SWINGING STOREFRONT SPEC (2) 3'-0" X 8'-0" SEE MANF' SEE SPEC N/A N/A SWINGING STORAGE IMPACT/ INSULATED STEEL (2) 3'-0" X 8'-0" SEE MANF' SEE ELEVATION FOR SEE YES SPEC SWINGING PULL/ PANIC HARDWARE IMPACT/ INSULATED STOREFRONT MORE DETAILS

STOREFRONT DOOR SPECIFICATION: STOREFRONT DOOR SYSTEM: YHS 50 TU/ MODEL 35H ENTRANCE DOOR.

GLASS: $I - \frac{5}{16}$ " IGU - INSUDE AND OUTSIDE GLAZED (STOREFRONT) I" IGU W/ LOW-E (DOOR)

COLOR: ANODIZED PLUS; YSIN- CLEAR

STAINLESS STEEL DOOR:
DOOR SYSTEM: MESKER, HURRICANE ASSEMBLIES

FRAME: 14 GA.; IMPACT RATED (FBC); A60 GALVANNEALED; MESKER GREY PRIMER DOOR: IMPACTED RATED(FBC); A60 GALVANNEALED, MESKER GREY PRIMER

HARDWARE: SEE SEPARATE HARDWARE DOCUMENT FOR MORE INFORMATION.

EXTERIOR DOOR NOTES:


I. SEE ELEVATIONS FOR DOOR APPEARANCE.

. ALL HARDWARE TO BE ADA AND FBC-A COMPLIANT HARDWARE.

. PROVIDE HURRICANE SHUTTERS WHERE IMPACT RATING IS NOT INDICATED. 4. ALL DIMENSIONS GIVEN ARE NOMINAL ONLY, VERIFY ALL ROUGH OPENING DIMENSIONS WITH DOOR MANUFACTURER, AS SELECTED BY OWNER.

5. ALL GLAZING TO BE LOW "E", INSULATED AND IMPACT RATED. 6. SEE DOOR INSTALLATION DETAILS THIS SHEET.

. PRIOR TO INSTALLING DOOR/STOREFRONT SYSTEM, PAINT ENTIRE JAMB OF DOOR ON ALL SIDES WITH LIQUID APPLIED WATERPROOFING MEMBRANE OVERLAPPING FACE OF BLOCK 4". CAULK DOOR PER MANF' SPEC.

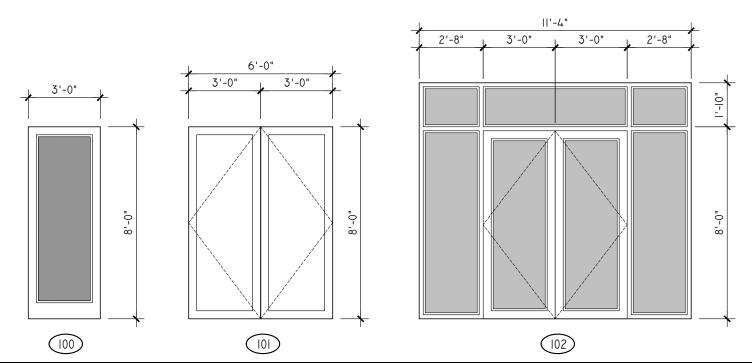

11W	WINDOW SCHEDULE												
TAG	WINDOW SIZE (WIDTH X HEIGHT)	TRANSOM (W. X H.)	DESCRIPTION	MATERIAL	MANUFACTURER	FINISH	COMMENTS						
100	(2) 3'-0" X 4'-8"	N/A	FIXED	ALUMINUM	SEE SPEC	SEE SPEC	IMPACT/ INSULATED						
101	3'-0" X 4'-8"	N/A	FIXED	ALUMINUM	SEE SPEC	SEE SPEC	IMPACT/ INSULATED						
200	(2) 3'-0" X 4'-8"	N/A	FIXED	ALUMINUM	SEE SPEC	SEE SPEC	IMPACT/ INSULATED						
201	3'-0" X 4'-8"	N/A	FIXED	ALUMINUM	SEE SPEC	SEE SPEC	IMPACT/ INSULATED						
202	(2) 3'-0" X 6'-8"	N/A	FIXED	ALUMINUM	SEE SPEC	SEE SPEC	IMPACT/ INSULATED						

STOREFRONT WINDOW SPECIFICATION: STOREFRONT DOOR SYSTEM: YHS 50 TU

COLOR: ANODIZED PLUS; YSIN- CLEAR

GLASS: I- $\frac{5}{16}$ " IGU - INSUDE AND OUTSIDE GLAZED (STOREFRONT)


EXTERIOR WINDOW NOTES:

I. SEE ELEVATIONS FOR WINDOW APPEARANCE

2. ALL DIMENSIONS GIVEN ARE NOMINAL ONLY, VERIFY ALL ROUGH OPENING DIMENSIONS WITH WINDOW MANUFACTURER, AS SELECTED BY OWNER.
3. ALL GLAZING TO BE LOW "E", INSULATED AND IMPACT RATED.

4. PROVIDE INSECT SCREENS ON ALL OPERABLE WINDOWS.

5. SEE WINDOW INSTALLATION DETAILS THIS SHEET.
6. PRIOR TO INSTALLING DOOR/STOREFRONT SYSTEM, PAINT ENTIRE JAMB OF DOOR ON ALL SIDES WITH LIQUID APPLIED WATERPROOFING MEMBRANE OVERLAPPING FACE OF BLOCK 4". CAULK DOOR PER MANF' SPEC.

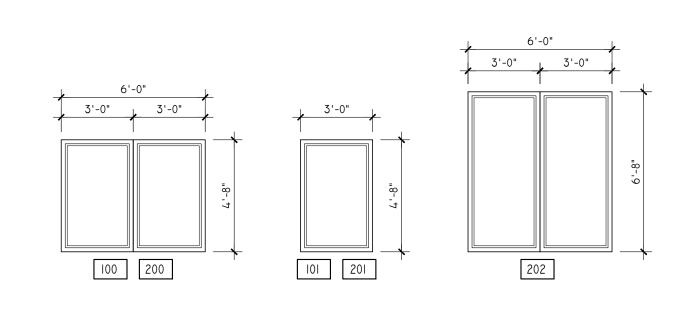

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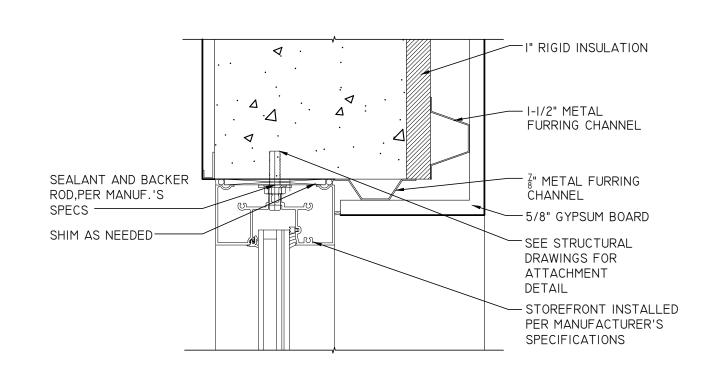
BREVARD SILVER

SEAL

ONLY


SHEET TITLE

WINDOW & DOOR SCHEDULES & ELEVATIONS




HEADER DETAIL (WD-1) STOREFRONT WINDOW

SCALE: 3"=1'-0"

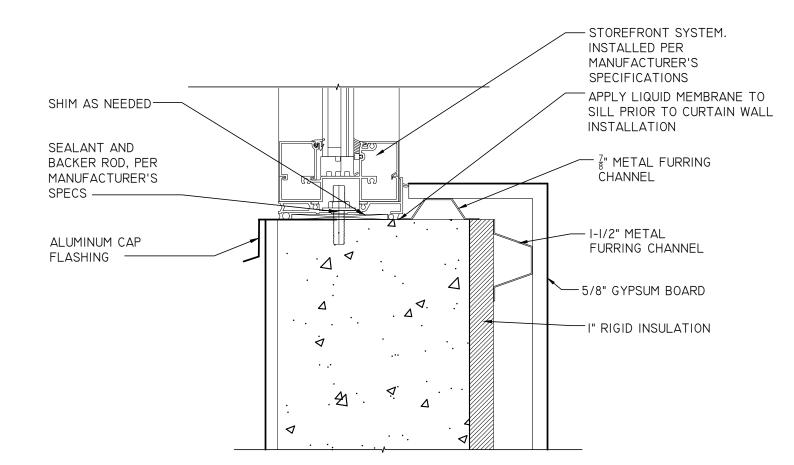


SILL DETAIL (WD-2) STOREFRONT WINDOW

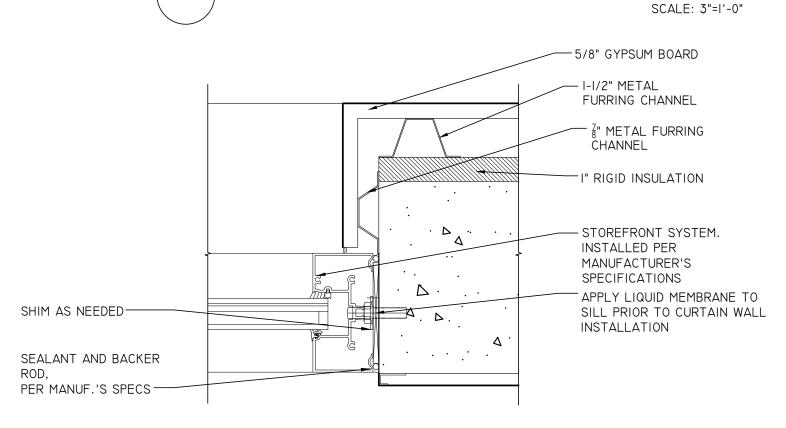

JAMB DETAIL WD-3 STOREFRONT WINDOW SCALE: 3"=1'-0"

-I" RIGID INSULATION - I-I/2" METAL FURRING CHANNEL SEALANT AND BACKER 7/8" METAL FURRING ČHANNEL PER MANUF.'S SPECS--5/8" GYPSUM BOARD SHIM AS NEEDED-SEE STRUCTURAL DRAWINGS FOR ATTACHMENT DETAIL - STOREFRONT INSTALLED PER MANUFACTURER'S SPECIFICATIONS

HEADER DETAIL WD-4 STOREFRONT DOOR SCALE: 3"=1'-0"

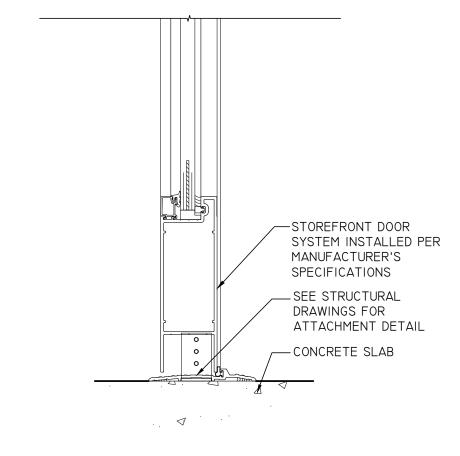

SILL DETAIL (WD-5) STOREFRONT DOOR

-5/8" GYPSUM BOARD — I-I/2" METAL FURRING CHANNEL 7 METAL FURRING CHANNEL - I" RIGID INSULATION - STOREFRONT SYSTEM. INSTALLED PER MANUFACTURER'S SPECIFICATIONS APPLY LIQUID MEMBRANE TO SHIM AS NEEDED-SILL PRIOR TO CURTAIN WALL

SCALE: 3"=1'-0"

INSTALLATION

SCALE: 3"=1'-0"

JAMB DETAIL WD-6 STOREFRONT DOOR

SEALANT AND BACKER

PER MANUF.'S SPECS


DOOR, SEE FLOOR PLANS AND DOOR TYPES, TYP.

- I" RIGID INSULATION — I-I/2" METAL FURRING CHANNEL CMU WALL · 4 CTSK EXP. BOLT (SHOWN) OR MASONRY ANCHOR AS APPLICABLE ─ 5/8" GYPSUM BOARD -BACKER ROD AND BACKER ROD AND SEALANT SEALANT METALLIC FILLER, HOLLOW METAL DOOR GROUND SMOOTH, AT FRAME, SEE DOOR NOTES EXP. BOLT CONDITION FILL FRAME SOLID WITH GROUT, TYP.

HEADER DETAIL WD-7 HOLLOW METAL DOOR SCALE: 3"=1'-0"


- METAL DOOR FRAME AND SEALANT PER SILL INSTALLED PER MANUFACTURER'S SPECS-MANUFACTURER'S SPECIFICATIONS SLOPE LANDING AWAY FROM DOOR. ——— — SEALANT PER MANUFACTURER'S SPECS -CONCRETE SLAB

SILL DETAIL WD-B HOLLOW METAL DOOR SCALE: 3"=1'-0"

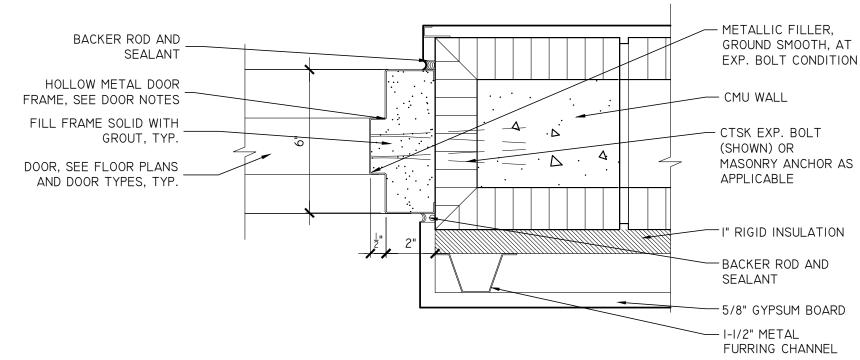

JAMB DETAIL WD-9 HOLLOW METAL DOOR

SCALE: 3"=1'-0"

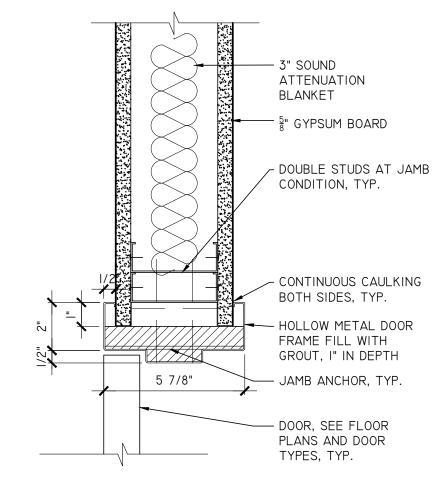

HEAD DETAIL WD-10 HOLLOW METAL DOOR

HOLLOW METAL DOOR FRAME FILL WITH GROUT, I" IN DEPTH - 5 GYPSUM BOARD - CONTINUOUS CAULKING BOTH SIDES, TYP. - 3" SOUND ATTENUATION BLANKET — DOUBLE STUDS AT JAMB CONDITION, TYP. ___ JAMB ANCHOR, TYP. — DOOR, SEE FLOOR PLANS AND DOOR TYPES, TYP.

JAMB DETAIL HOLLOW METAL DOOR SCALE: 3"=1'-0"

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> DATE: 2023-09-25 SHEET TITLE

, AL OCA

BREVARD SILVER

ARCHITECTURE

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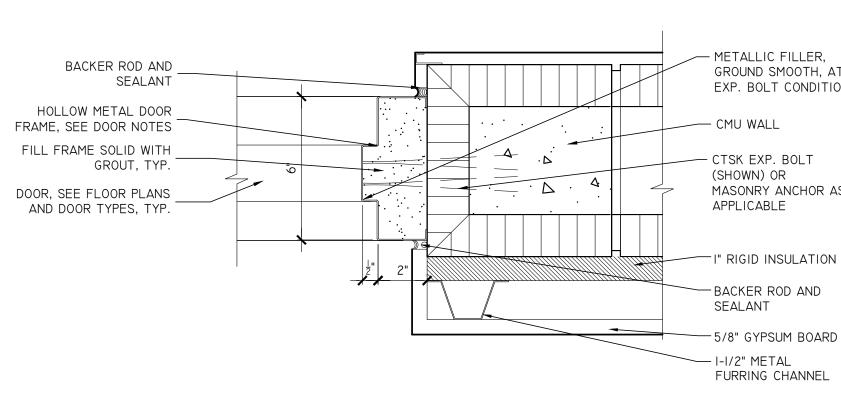
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REVISIONS:

WINDOW & DOOR DETAILS



FINISH SCHEDULE					
TYPE MARK	MANUFACTURER	MODEL	DESCRIPTION	DIMENSIONS	FINISH
CF-I	ARMSTRONG WWW.ARMSTRONGCEILINGS.COM	#1717	FINE FISSURED; 15/16" ANGLED TEGULAR; GRID PRELUDE XL 15" EXPOSED TEE SYSTEM.	24"W X 24"D X 3/4"H	WHITE
CF-2	NATIONAL GYPSUM WWW.NATIONALGYPSUM.COM	N/A	GOLD BOND XP HI-ABUSE GYPSUM BOARD	THICKNESS: 5"	N/A
WF-I	DALTILE WWW.DALTILE.COM	#C024	COHESION FINISH: MATTE SHADE VARIATION: V2-MEDIUM	12"W X 24"D	LIGHT GREY RECTANGLE
WF-2	DALTILE WWW.DALTILE.COM	#VVI3	VITRUVIAN FINISH: MATTE SHADE VARIATION: V1-LOW	3"W X 6"D	MATTE GREY
WF-3	CRANE COMPOSITES WWW.CRANECOMPOSITES.COM	#1130	VARIETEX LINEN TEXTURE	4'W X 8' D	COTTON WHITE
WF-4	SCHLUTER SYSTEMS WWW.SCHLUTER.COM	#2.10	2.10 SCHLUTER - QUADEC STAINLESS STEEL	N/A	STAINLESS STEEL
WF-5	VERSATEX WWW.VERSATEX.COM	N/A	SMOOTH, 8" X 1"	7-1/4" NOM.	SMOOTH
FF-I	DUR-A-FLEX WWW.DUR-A-FLEX.COM	EC	HYBRI-FLEX EC	3/16" THICK	TBD
FF-2	FLEXCO WWW.FLEXCOFLOORS.COM	1701 1776	HEAVY DUTY RADIAL II ONE-PIECE TREAD W/ RISER 1701 + 1776	N/A	TBD
BF-I	TARKETT WWW.COMMERCIAL.TARKETT.COM	TS 6"	JOHNSONITE BASEWORKS THERMOSET RUBBER	6" W/ TOE	CHARCOAL
MW-I	WILSONART WWW.WILSONART.COM	7911-60	MANITOBA MAPLE MATTE FINISH	N/A	MATTE FINISH
MW-2	WILSONART WWW.WILSONART.COM	1890K-22	SERRANIA	N/A	N/A

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I.) INSTALL ALL FINISH ITEMS PER MANUFACTURER'S SPECIFICATION.
2.) CONTRACTOR TO PROVIDE SUBMITTAL TO BOTH ARCHITECT AND CLIENT PRIOR TO ORDERING.

3.) WF-5: CHAIR RAIL MOLDING TO BE INSTALLED AT 32" ABOVE FINISH FLOOR.

PAINT SCHUDLE			
TYPE MARK	MANUFACTURER	MODEL	DESCRIPTION
PP-I	SHERWIN-WILLIAM WWW.SHERWIN-WILLIAMS.COM	SW 7013	IVORY LACE
PP-2	SHERWIN-WILLIAM WWW.SHERWIN-WILLIAMS.COM	SW 760I	DOCKSIDE BLUE
PP-3	SHERWIN-WILLIAM WWW.SHERWIN-WILLIAMS.COM	TBD	BLUE
PP-4	SHERWIN-WILLIAM WWW.SHERWIN-WILLIAMS.COM	TBD	ORANGE
PP-5	SHERWIN-WILLIAM WWW.SHERWIN-WILLIAMS.COM	TBD	GREEN
PP-6	SHERWIN-WILLIAM WWW.SHERWIN-WILLIAMS.COM	TBD	RED
PP-7	SHERWIN-WILLIAM WWW.SHERWIN-WILLIAMS.COM	TBD	TEAL
PP-8	SHERWIN-WILLIAM WWW.SHERWIN-WILLIAMS.COM	TBD	YELLOW
PP-9	SHERWIN-WILLIAM WWW.SHERWIN-WILLIAMS.COM	TBD	GREY
PP-10	SHERWIN-WILLIAM WWW.SHERWIN-WILLIAMS.COM	TBD	WHITE

NOTE: SEE SEPARATE PAINT SPECIFICATION FOR MORE INFORMATION.



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REVISIONS:

<u>A</u> - <u>A</u> - <u>A</u> - <u>A</u> - <u>A</u> -

BREVARD HEALTH ALLIANCE SILVER PALM LOCATION MELBOURNE, FL

SEAL


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DATE: 2023-09-25

SHEET TITLE

INTERIOR FINISH SCHEDULES

SHEET NUMBER

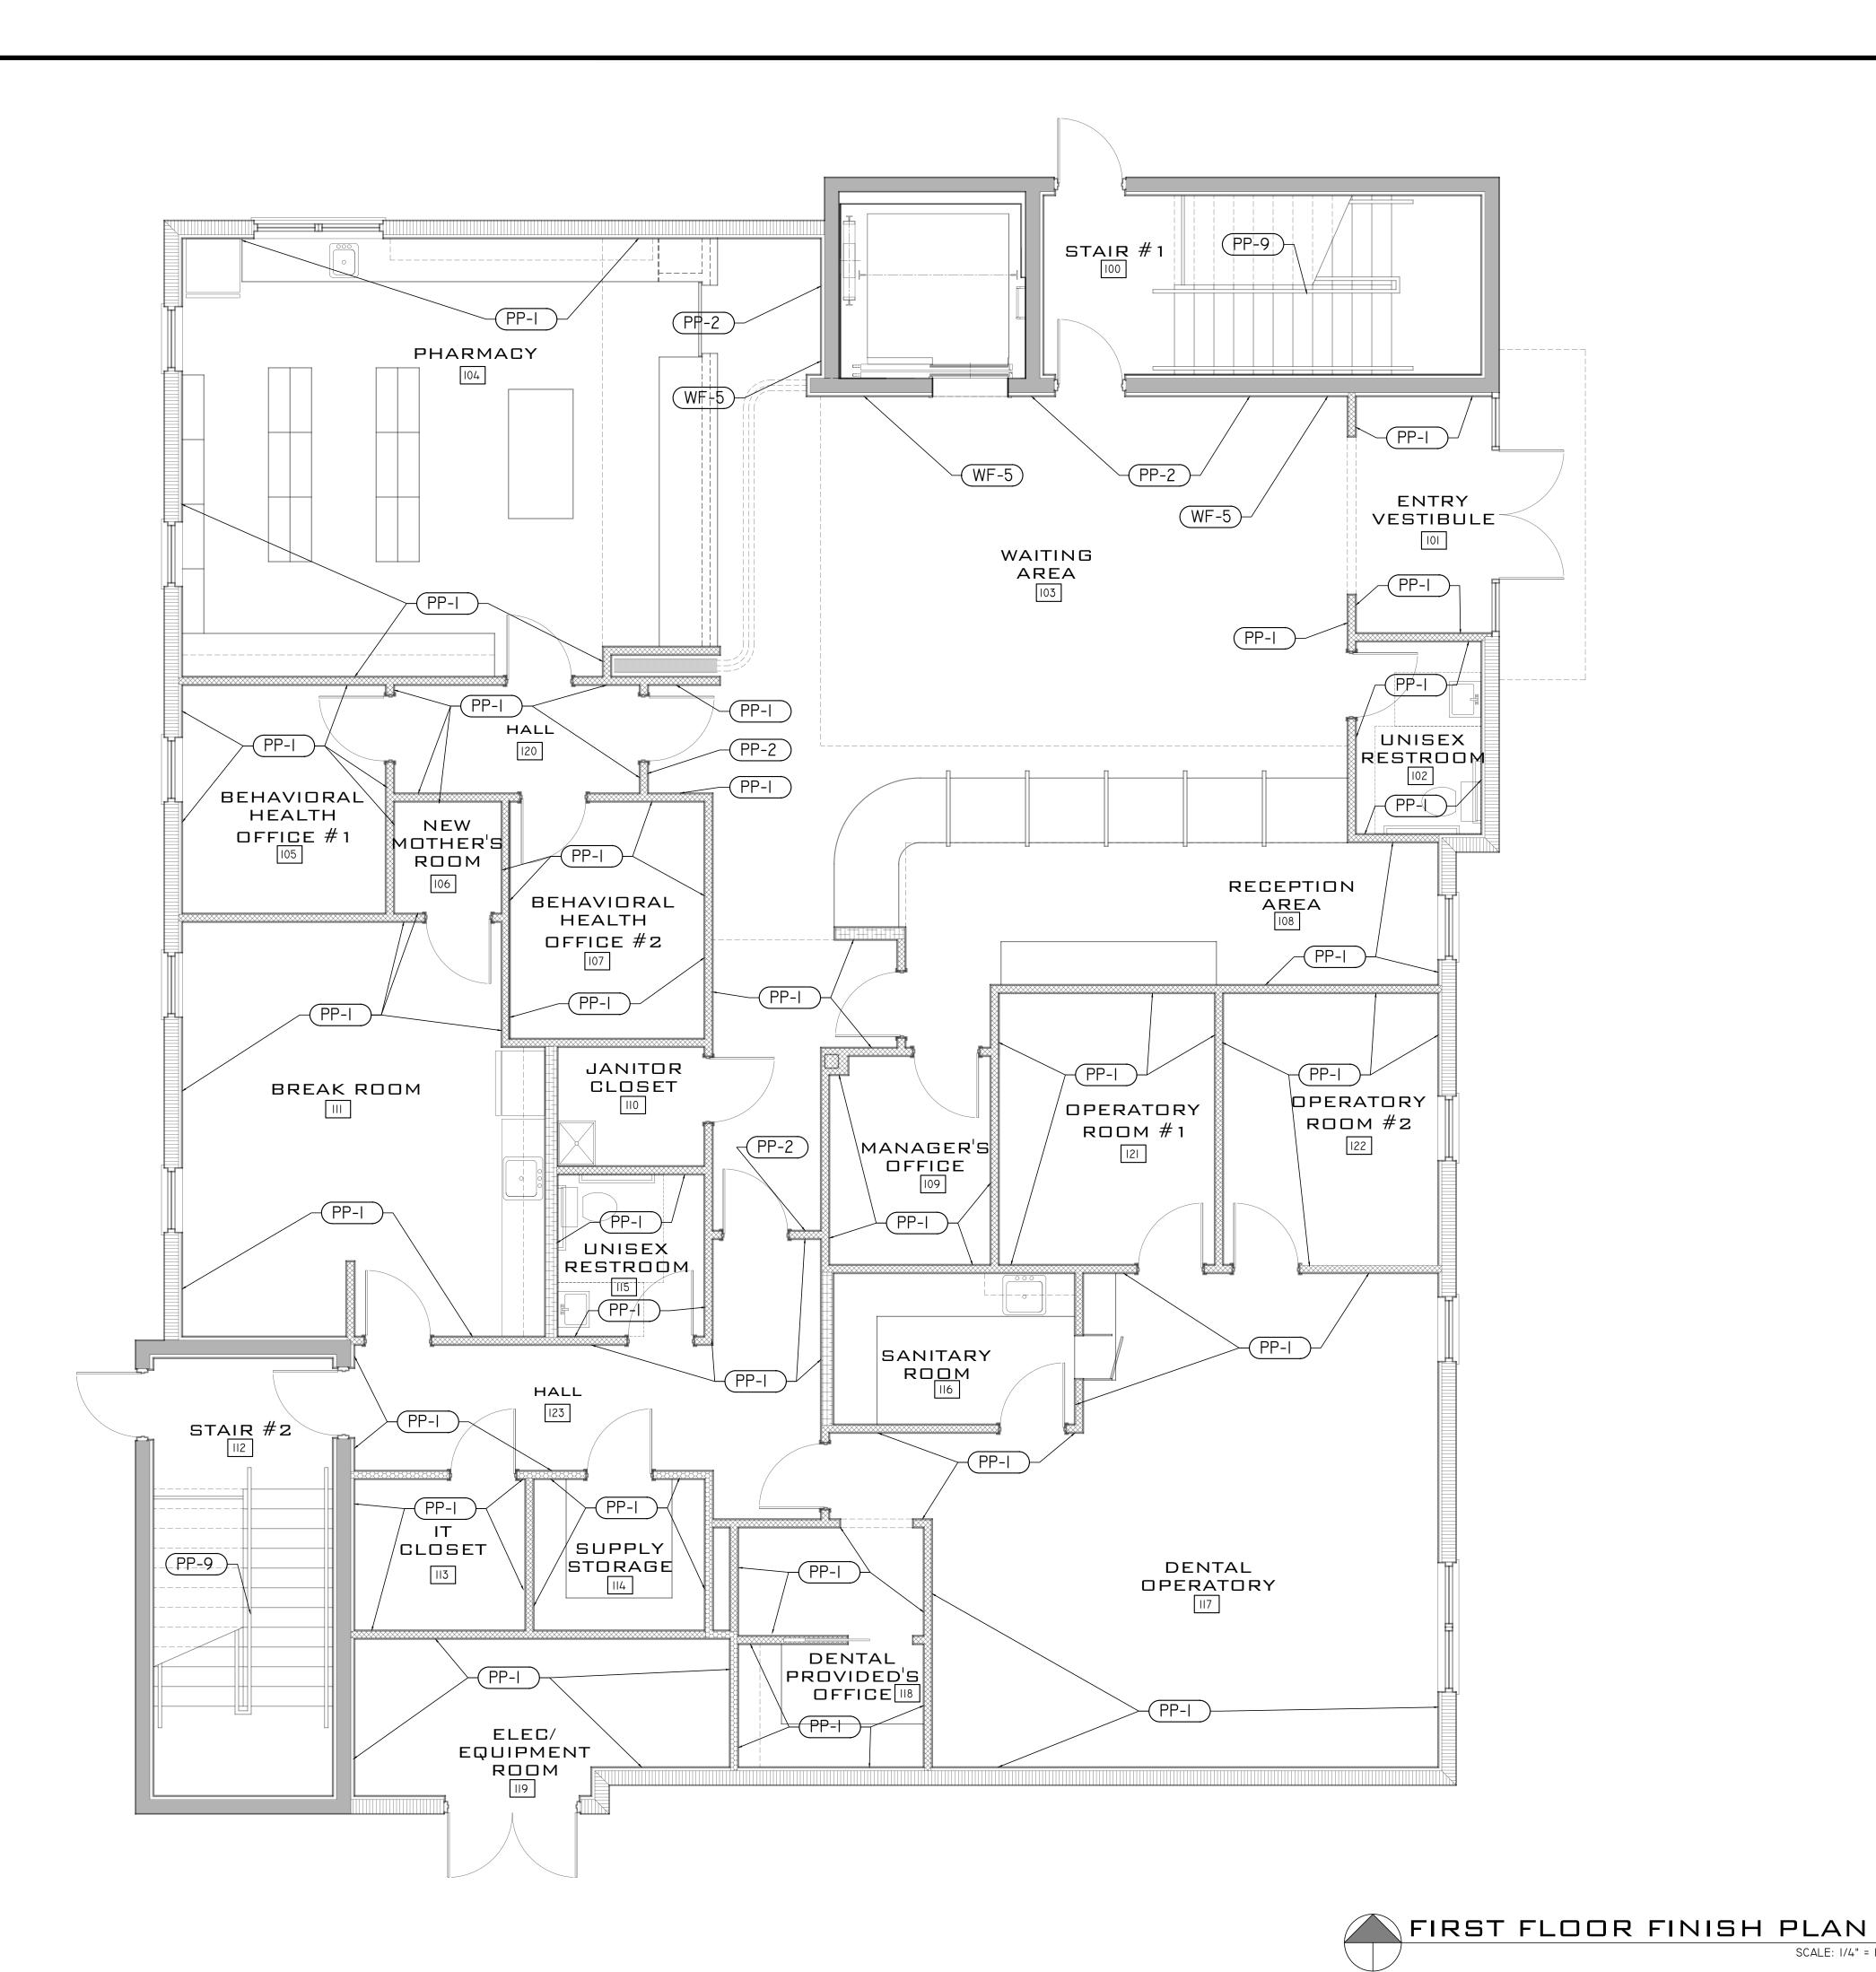

FLOOR PLAN NOTES

GENERAL NOTES:

- REFERENCE ARCHITECTURAL SPECIFICATION SHEET A0.2 FOR GENERAL CONSTRUCTION
- INFORMATION RELATED TO THE PROJECT. . EACH CONTRACTOR SHALL VERIFY ALL DIMENSIONS SHOWN ON THE DRAWING AND OBTAIN ALL MEASUREMENTS REQUIRED FOR PROPER EXECUTION OF WORK. DO NOT SCALE PLANS. CONTACT
- ARCHITECT FOR ANY ADDITIONAL INFORMATION OR DIMENSIONS REQUIRED. 3. PROVIDE WOOD BLOCKING AS REQUIRE FOR INSTALLATION OF CABINETS, EQUIPMENT, FIXTURES,
- BATHROOM ACCESSORIES AND AROUND WINDOWS AND DOORS. DETAILED DRAWINGS AND LARGER SCALE DRAWINGS TAKE PRECEDENCE OVER SMALL SCALE
- . FOR CONSTRUCTION DETAILS NOT SHOWN, USE THE PRODUCT MANUFACTURER'S WRITTEN
- INSTALLATION INSTRUCTIONS AND STANDARD DETAILS, IN STRICT ACCORDANCE WITH THE PROJECT SPECIFICATIONS REQUIREMENTS AND DESIGN INTENT.
- . GYPSUM BOARD SHALL BE INSTALLED PER ASTM C840-18 AND AS SPECIFIED PER THE MANUFACTURER'S SPECIFICATIONS. UNLESS OTHERWISE NOTE, INTERIOR GYPSUM BOARD WALLS
- SHALL BE FINISHED TO LEVEL 5. WALL CABINETRY TO BE PROVIDED BY OWNER OR CONTRACTOR SELECTED CABINET CONTRACTOR. CONTRACTOR TO COORDINATE ALL ELECTRICAL AND PLUMBING ELEMENTS WITH CABINET CONTRACTOR PRIOR TO INSTALLING.
- . MILLWORK SHALL BE INSTALLED PER THE ARCHITECTURAL MILLWORK INSTITUTE STANDARDS AND MANUFACTURE'S SPECIFICATIONS.
- . ALL APPLIANCES TO BE PROVIDED BY INTERIOR DESIGNER, APPLIANCE CONTRACTOR OR OTHER. COORDINATE ALL CABINET MILLWORK, ELECTRICAL LOCATIONS AND PLUMBING LINES WITH
- O. SEE STRUCTURAL, MECHANICAL, ELECTRICAL AND PLUMBING PERMIT DRAWINGS FOR ADDITIONAL INFORMATION.

FINISH NOTES:

SCALE: 1/4" = 1'-0"

- PRIOR TO ORDERING FINISH, CONTRACTOR TO SEND SUBMITTALS TO BOTH THE ARCHITECT AND CLIENT FOR REVIEW AND APPROVAL.
- ALL FINISHES TO BE INSTALLED PER MANUFACTURE'S SPECIFICATION BASED ON LOCAL SITE CONDITIONS.
- WALL TILE WH-I: SEE BATHROOM ELEVATIONS ON SHEET A6.25 FOR TILE INSTALLATION HEIGHTS. BACKSPLASH TILE WH-2: SEE BREAK ROOM INTERIOR ELEVATION FOR INSTALLATION LOCATION.
- SEE SEPARATE PAINT SPECIFICATION FOR ADDITIONAL INFORMATION. REFER TO ADA ACCESSIBILITY DETAILS SHEET GO.02 AND MANUFACTURER'S SPECIFICATIONS FOR
- INSTALLATION REQUIREMENTS. PAINT ALL GYPSUM BOARD CEILING WITH PAINT CALL OUT PP-10.

FINISH SCHEDULE - FIRST FLOOR

ROOM /#	FLOOR FINISH	WALL FINISH	CEILING FINISH	BASE BOARD
STAIR #1 (100)	FF-I/FF-2	SEE FLOOR PLAN	CF-2	BF-I
ENTRY VEST. (101)	FF-I	SEE FLOOR PLAN	CF-2	BF-I
MALE REST. (102)	FF-I	WF-I	CF-2	BF-2
WAITING AREA (103)	FF-I	SEE FLOOR PLAN	CF-I/CF-2	BF-I
PHARMACY (104)	FF-I	SEE FLOOR PLAN	CF-I/CF-2	BF-I
B.H. OFFICE #1 (105)	FF-I	SEE FLOOR PLAN	CF-I	BF-I
NEW MOTHER'S RM (106)	FF-I	SEE FLOOR PLAN	CF-I	BF-I
B.H. OFFICE #2 (107)	FF-I	SEE FLOOR PLAN	CF-I	BF-I
RECP. AREA (108)	FF-I	SEE FLOOR PLAN	CF-I/CF-2	BF-I
MANAGER'S OFFICE (109)	FF-I	SEE FLOOR PLAN	CF-I	BF-I
JAN. CLOSET (II0)	FF-2	SEE FLOOR PLAN	CF-I	BF-2
BREAK ROOM (III)	FF-I	WF-2	CF-I	BF-I
STAIR #2 (II2)	FF-I/FF-2	SEE FLOOR PLAN	CF-2	BF-I
IT CLOSET (II3)	FF-I	SEE FLOOR PLAN	CF-I	BF-I
SUPPLY STORAGE (II4)	FF-I	SEE FLOOR PLAN	CF-I	BF-I
FEMALE REST. (II5)	FF-I	WF-I	CF-2	BF-2
SAN. ROOM (II6)	FF-I	SEE FLOOR PLAN	CF-I	BF-I
DENTAL OPERATORY (117)	FF-I	SEE FLOOR PLAN	CF-I	BF-I
DENTAL OFFICE (II8)	FF-I	SEE FLOOR PLAN	CF-I	BF-I
ELEC/EQUIP ROOM (II9)	FF-I	SEE FLOOR PLAN	CF-I	BF-I
HALL (120)	FF-I	SEE FLOOR PLAN	CF-I	BF-I
OPERATORY ROOM (121)	FF-I	SEE FLOOR PLAN	CF-I	BF-I
OPERATORY ROOM (122)	FF-I	SEE FLOOR PLAN	CF-I	BF-I
HALL (123)	FF-I	SEE FLOOR PLAN	CF-I	BF-I



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H AL OCA BREVARD SILVER


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SHEET TITLE

FIRST FLOOR FINISH PLAN

SHEET NUMBER



FLOOR PLAN NOTES

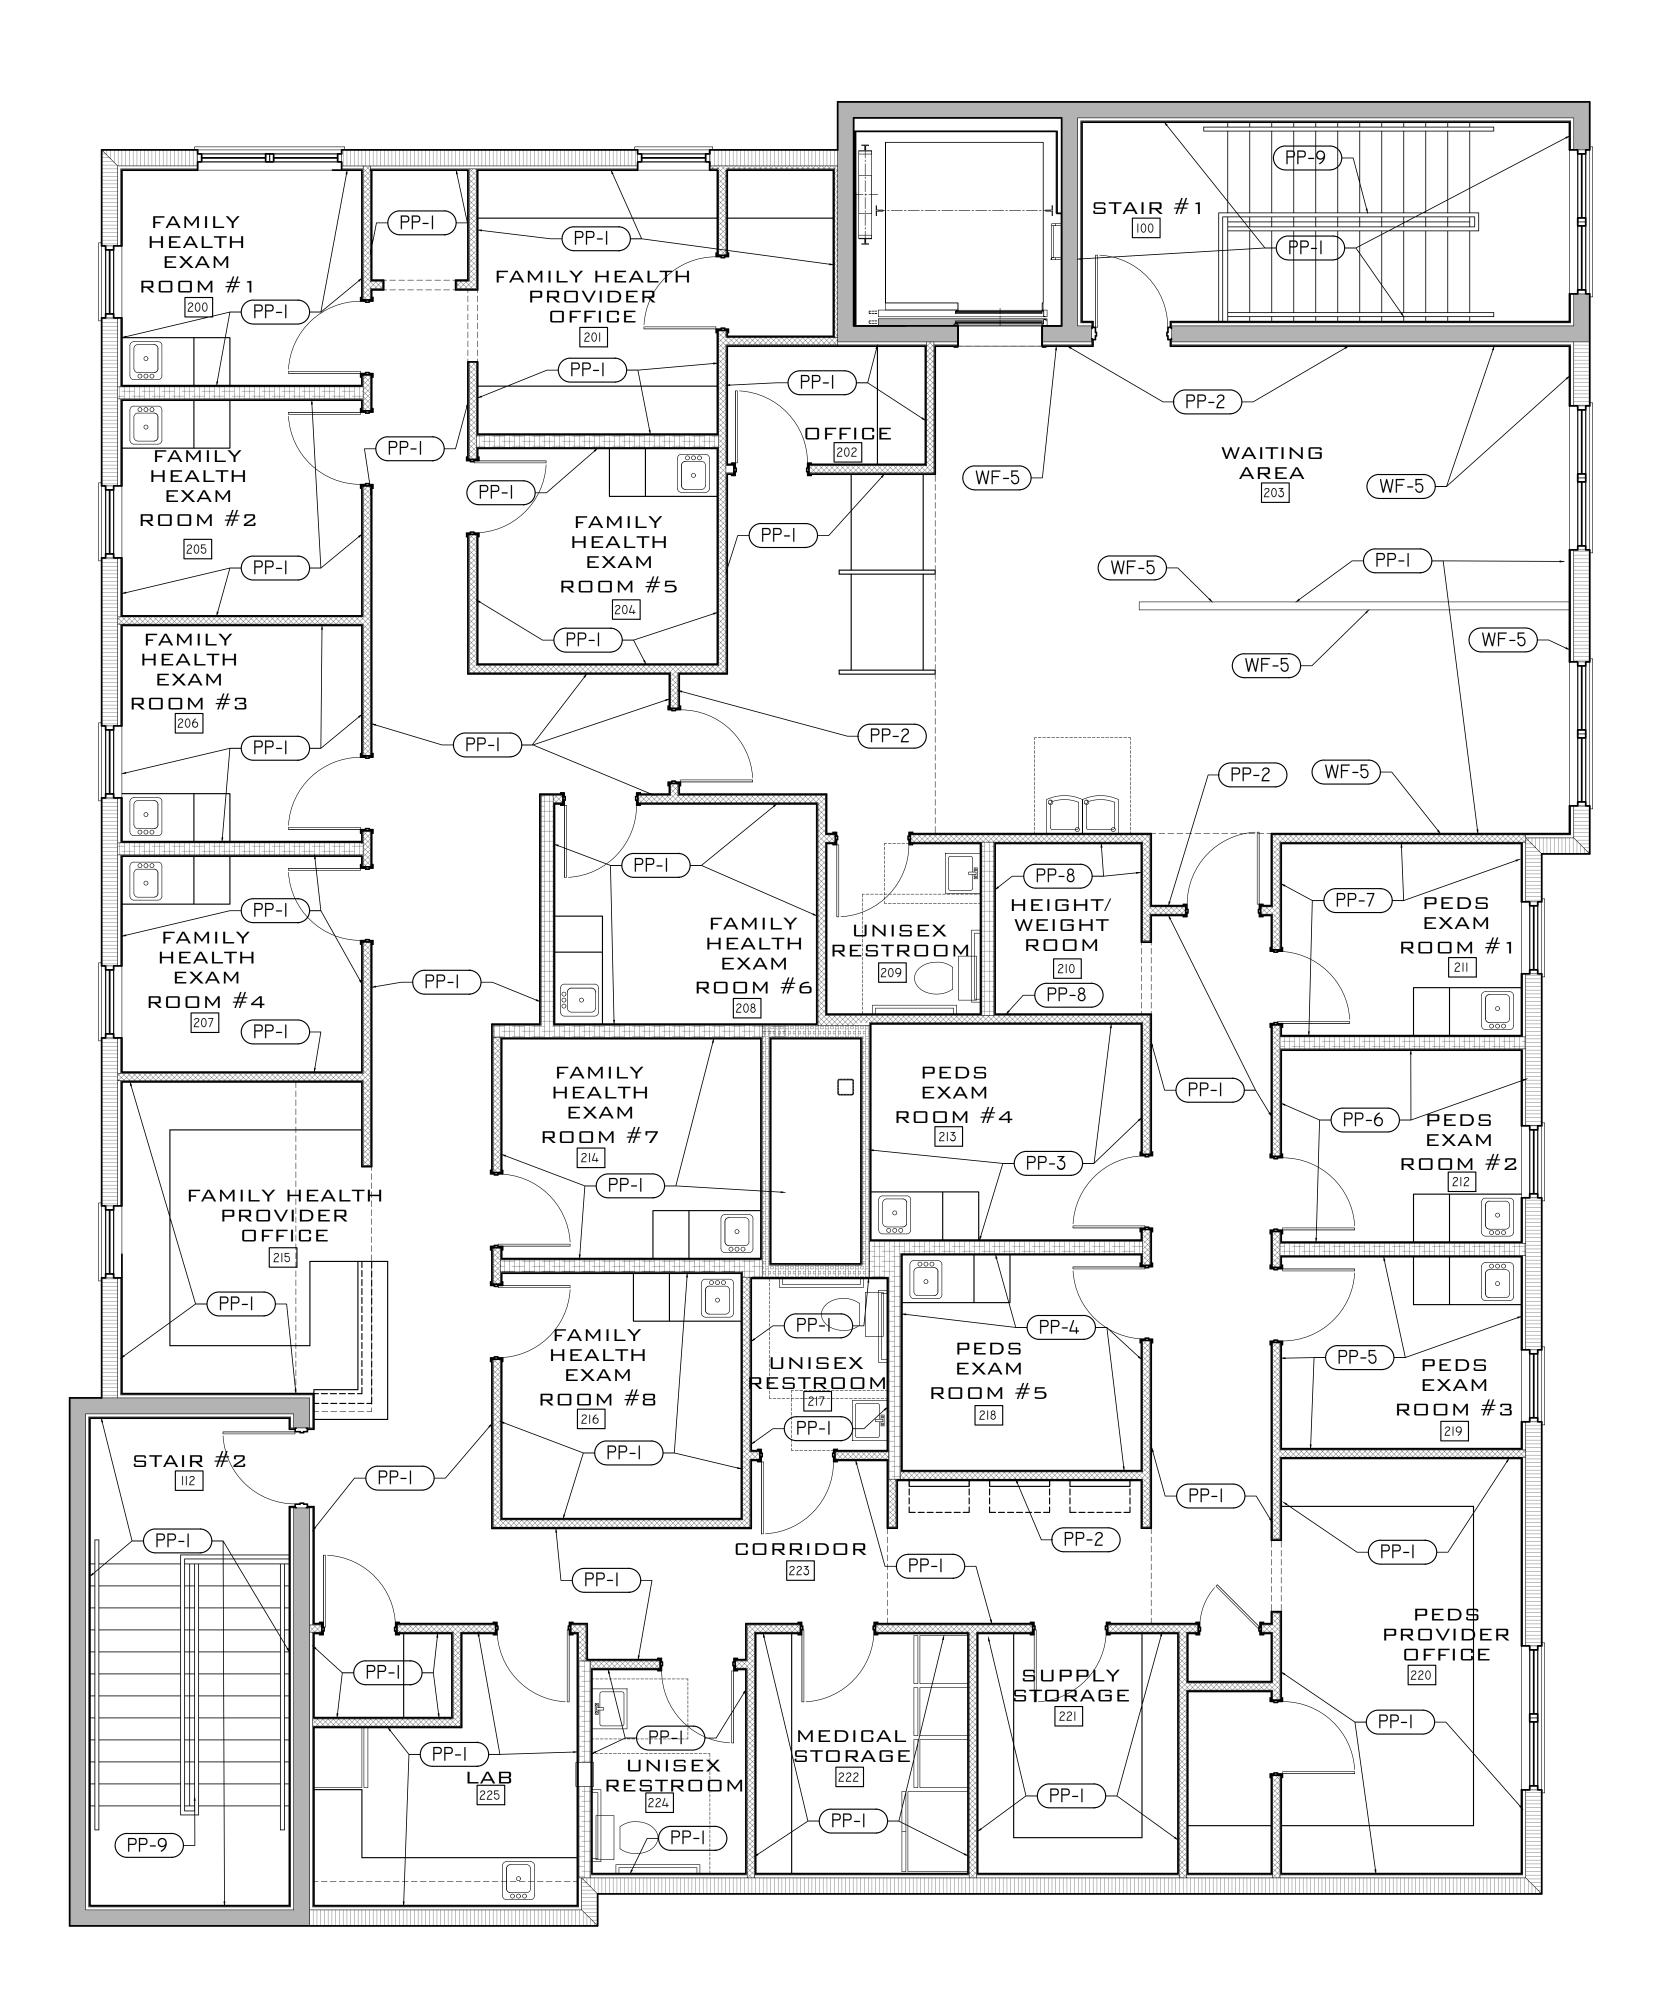GENERAL NOTES:

- REFERENCE ARCHITECTURAL SPECIFICATION SHEET A0.2 FOR GENERAL CONSTRUCTION INFORMATION RELATED TO THE PROJECT.
- 2. EACH CONTRACTOR SHALL VERIFY ALL DIMENSIONS SHOWN ON THE DRAWING AND OBTAIN ALL MEASUREMENTS REQUIRED FOR PROPER EXECUTION OF WORK. DO NOT SCALE PLANS. CONTACT ARCHITECT FOR ANY ADDITIONAL INFORMATION OR DIMENSIONS REQUIRED.
- 3. PROVIDE WOOD BLOCKING AS REQUIRE FOR INSTALLATION OF CABINETS, EQUIPMENT, FIXTURES, BATHROOM ACCESSORIES AND AROUND WINDOWS AND DOORS.
- 4. DETAILED DRAWINGS AND LARGER SCALE DRAWINGS TAKE PRECEDENCE OVER SMALL SCALE DRAWINGS.
- 5. FOR CONSTRUCTION DETAILS NOT SHOWN, USE THE PRODUCT MANUFACTURER'S WRITTEN INSTALLATION INSTRUCTIONS AND STANDARD DETAILS. IN STRICT ACCORDANCE WITH THE PROJECT SPECIFICATIONS REQUIREMENTS AND DESIGN INTENT.
- 6. GYPSUM BOARD SHALL BE INSTALLED PER ASTM C840-18 AND AS SPECIFIED PER THE MANUFACTURER'S SPECIFICATIONS. UNLESS OTHERWISE NOTE, INTERIOR GYPSUM BOARD WALLS SHALL BE FINISHED TO LEVEL 5.
- . WALL CABINETRY TO BE PROVIDED BY OWNER OR CONTRACTOR SELECTED CABINET CONTRACTOR. CONTRACTOR TO COORDINATE ALL ELECTRICAL AND PLUMBING ELEMENTS WITH CABINET CONTRACTOR PRIOR TO INSTALLING.
- B. MILLWORK SHALL BE INSTALLED PER THE ARCHITECTURAL MILLWORK INSTITUTE STANDARDS AND MANUFACTURE'S SPECIFICATIONS.
- 9. ALL APPLIANCES TO BE PROVIDED BY INTERIOR DESIGNER, APPLIANCE CONTRACTOR OR OTHER. COORDINATE ALL CABINET MILLWORK, ELECTRICAL LOCATIONS AND PLUMBING LINES WITH SELECTED APPLIANCES.
- 10. SEE STRUCTURAL, MECHANICAL, ELECTRICAL AND PLUMBING PERMIT DRAWINGS FOR ADDITIONAL INFORMATION.

FINISH NOTES:

SECOND FLOOR PLAN

SCALE: 1/4" = 1'-0"

- PRIOR TO ORDERING FINISH, CONTRACTOR TO SEND SUBMITTALS TO BOTH THE ARCHITECT AND CLIENT FOR REVIEW AND APPROVAL.
- 2. ALL FINISHES TO BE INSTALLED PER MANUFACTURE'S SPECIFICATION BASED ON LOCAL SITE
- CONDITIONS. 3. WALL TILE WH-I: SEE BATHROOM ELEVATIONS ON SHEET A6.25 FOR TILE INSTALLATION HEIGHTS.
- 4. BACKSPLASH TILE WH-2: SEE BREAK ROOM INTERIOR ELEVATION FOR INSTALLATION LOCATION. 5. SEE SEPARATE PAINT SPECIFICATION FOR ADDITIONAL INFORMATION.
- 6. REFER TO ADA ACCESSIBILITY DETAILS SHEET GO.02 AND MANUFACTURER'S SPECIFICATIONS FOR INSTALLATION REQUIREMENTS.
- 7. PAINT ALL GYPSUM BOARD CEILING WITH PAINT CALL OUT PP-10.

FINISH SCHEDULE - SECOND FLOOR

ROOM /#	FLOOR FINISH	WALL FINISH	CEILING FINISH	BASE BOARD
STAIR #1 (100)	FF-I/FF-2	SEE FLOOR PLAN	CF-I	BF-I
STAIR #2 (II2)	FF-I/FF-2	SEE FLOOR PLAN	CF-I	BF-I
F.H. EXAM ROOM #1 (200)	FF-I	SEE FLOOR PLAN	CF-I	BF-I
F.H. OFFICE (201)	FF-I	SEE FLOOR PLAN	CF-I	BF-I
OFFICE (202)	FF-I	SEE FLOOR PLAN	CF-I	BF-I
WAITING AREA (203)	FF-I	SEE FLOOR PLAN	CF-I/CF-2	BF-I
F.H. EXAM ROOM #5 (204)	FF-I	SEE FLOOR PLAN	CF-I	BF-I
F.H. EXAM ROOM #2 (205)	FF-I	SEE FLOOR PLAN	CF-I	BF-I
F.H. EXAM ROOM #3 (206)	FF-I	SEE FLOOR PLAN	CF-I	BF-I
F.H. EXAM ROOM #4 (207)	FF-I	SEE FLOOR PLAN	CF-I	BF-I
F.H. EXAM ROOM #6 (208)	FF-I	SEE FLOOR PLAN	CF-I	BF-I
FEMALE REST. (209)	FF-I	WF-I	CF-2	BF-2
WEIGHT/HEIGHT RM (210)	FF-I	SEE FLOOR PLAN	CF-I	BF-I
PEDS EXAM ROOM #1 (211)	FF-I	WF-3	CF-I	BF-I
PEDS EXAM ROOM #2 (212)	FF-I	WF-3	CF-I	BF-I
PEDS EXAM ROOM #4 (213)	FF-I	WF-3	CF-I	BF-I
F.H. EXAM ROOM #7 (214)	FF-I	SEE FLOOR PLAN	CF-I	BF-I
F.H. OFFICE (215)	FF-I	SEE FLOOR PLAN	CF-I/CF-2	BF-I
F.H. EXAM ROOM #8 (216)	FF-I	SEE FLOOR PLAN	CF-I	BF-I
MALE REST. (217)	FF-I	WF-I	CF-2	BF-2
PEDS EXAM ROOM #5 (218)	FF-I	WF-3	CF-I	BF-I
PEDS EXAM ROOM #3 (219)	FF-I	WF-3	CF-I	BF-I
PEDS OFFICE (220)	FF-I	SEE FLOOR PLAN	CF-I	BF-I
SUPPLY STORAGE (221)	FF-I	SEE FLOOR PLAN	CF-I	BF-I
MED STORAGE (222)	FF-I	SEE FLOOR PLAN	CF-I	BF-I
CORRIDOR (223)	FF-I	SEE FLOOR PLAN	CF-I/CF-2	BF-I
UNISEX REST. (224)	FF-I	WF-I	CF-2	BF-2
LAB (225)	FF-I	SEE FLOOR PLAN	CF-I	BF-I



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H AL BREVARD SILVER


SEAL

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SHEET TITLE

SECOND FLOOR FINISH PLAN

SHEET NUMBER

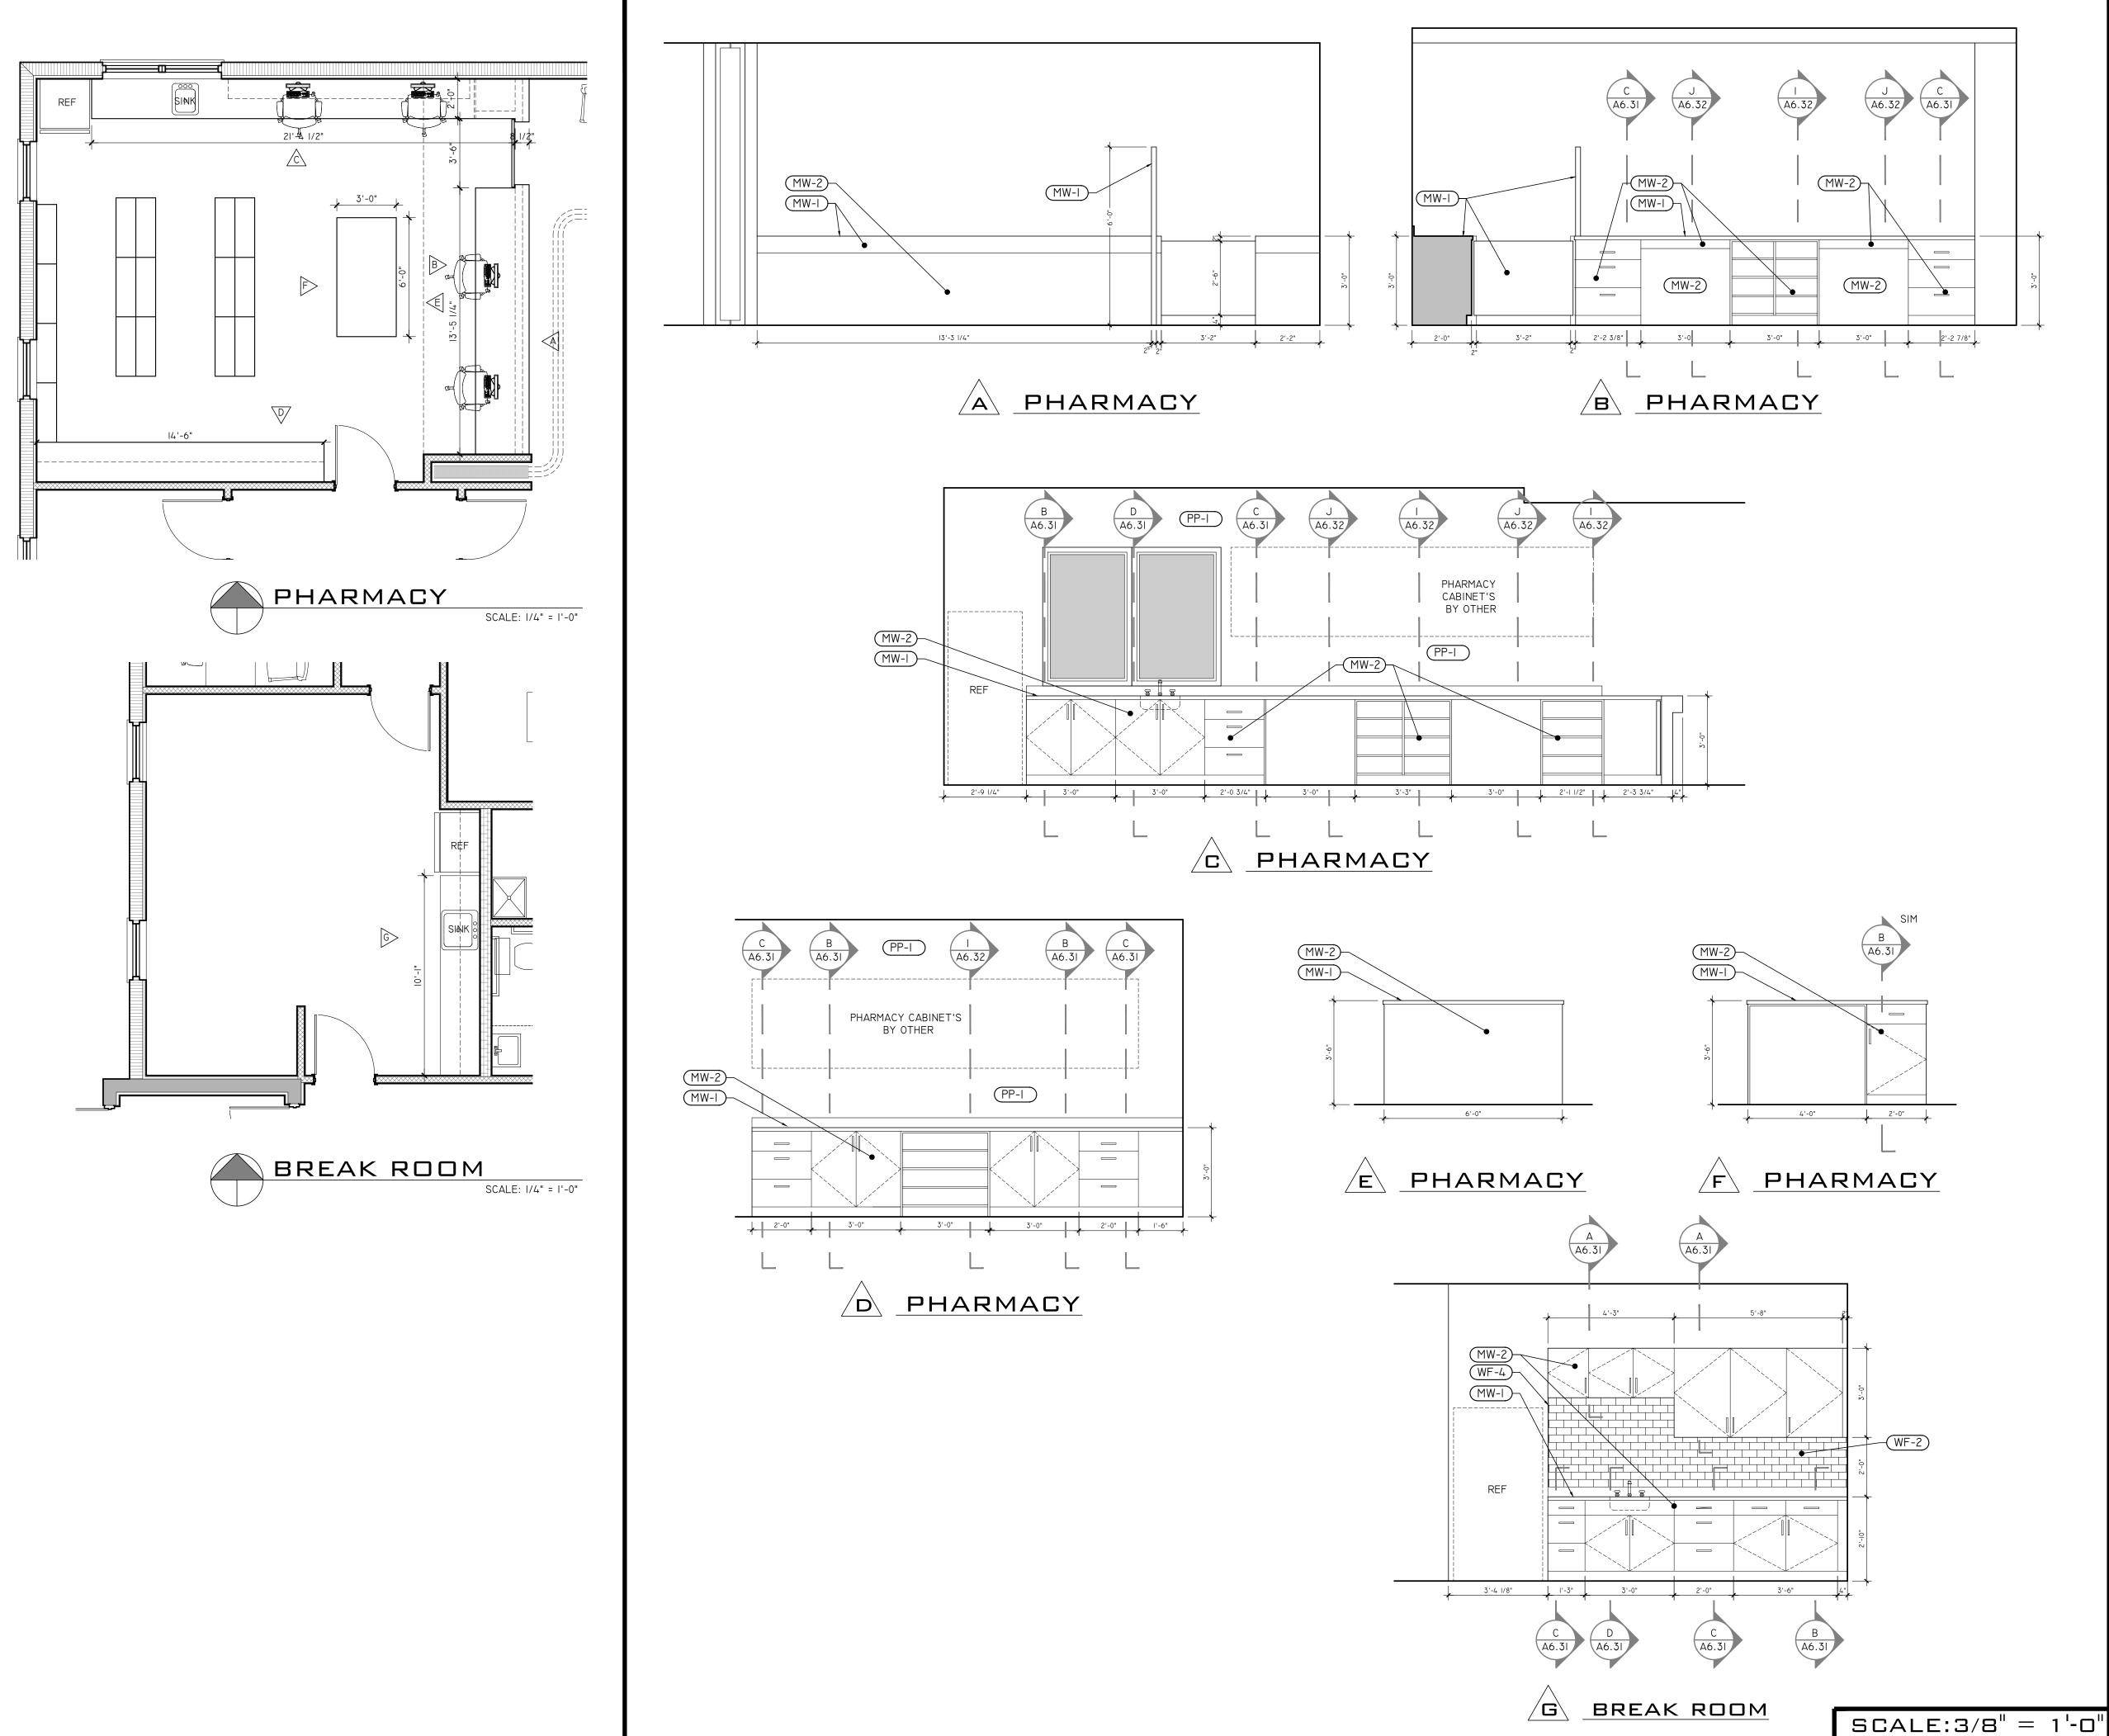

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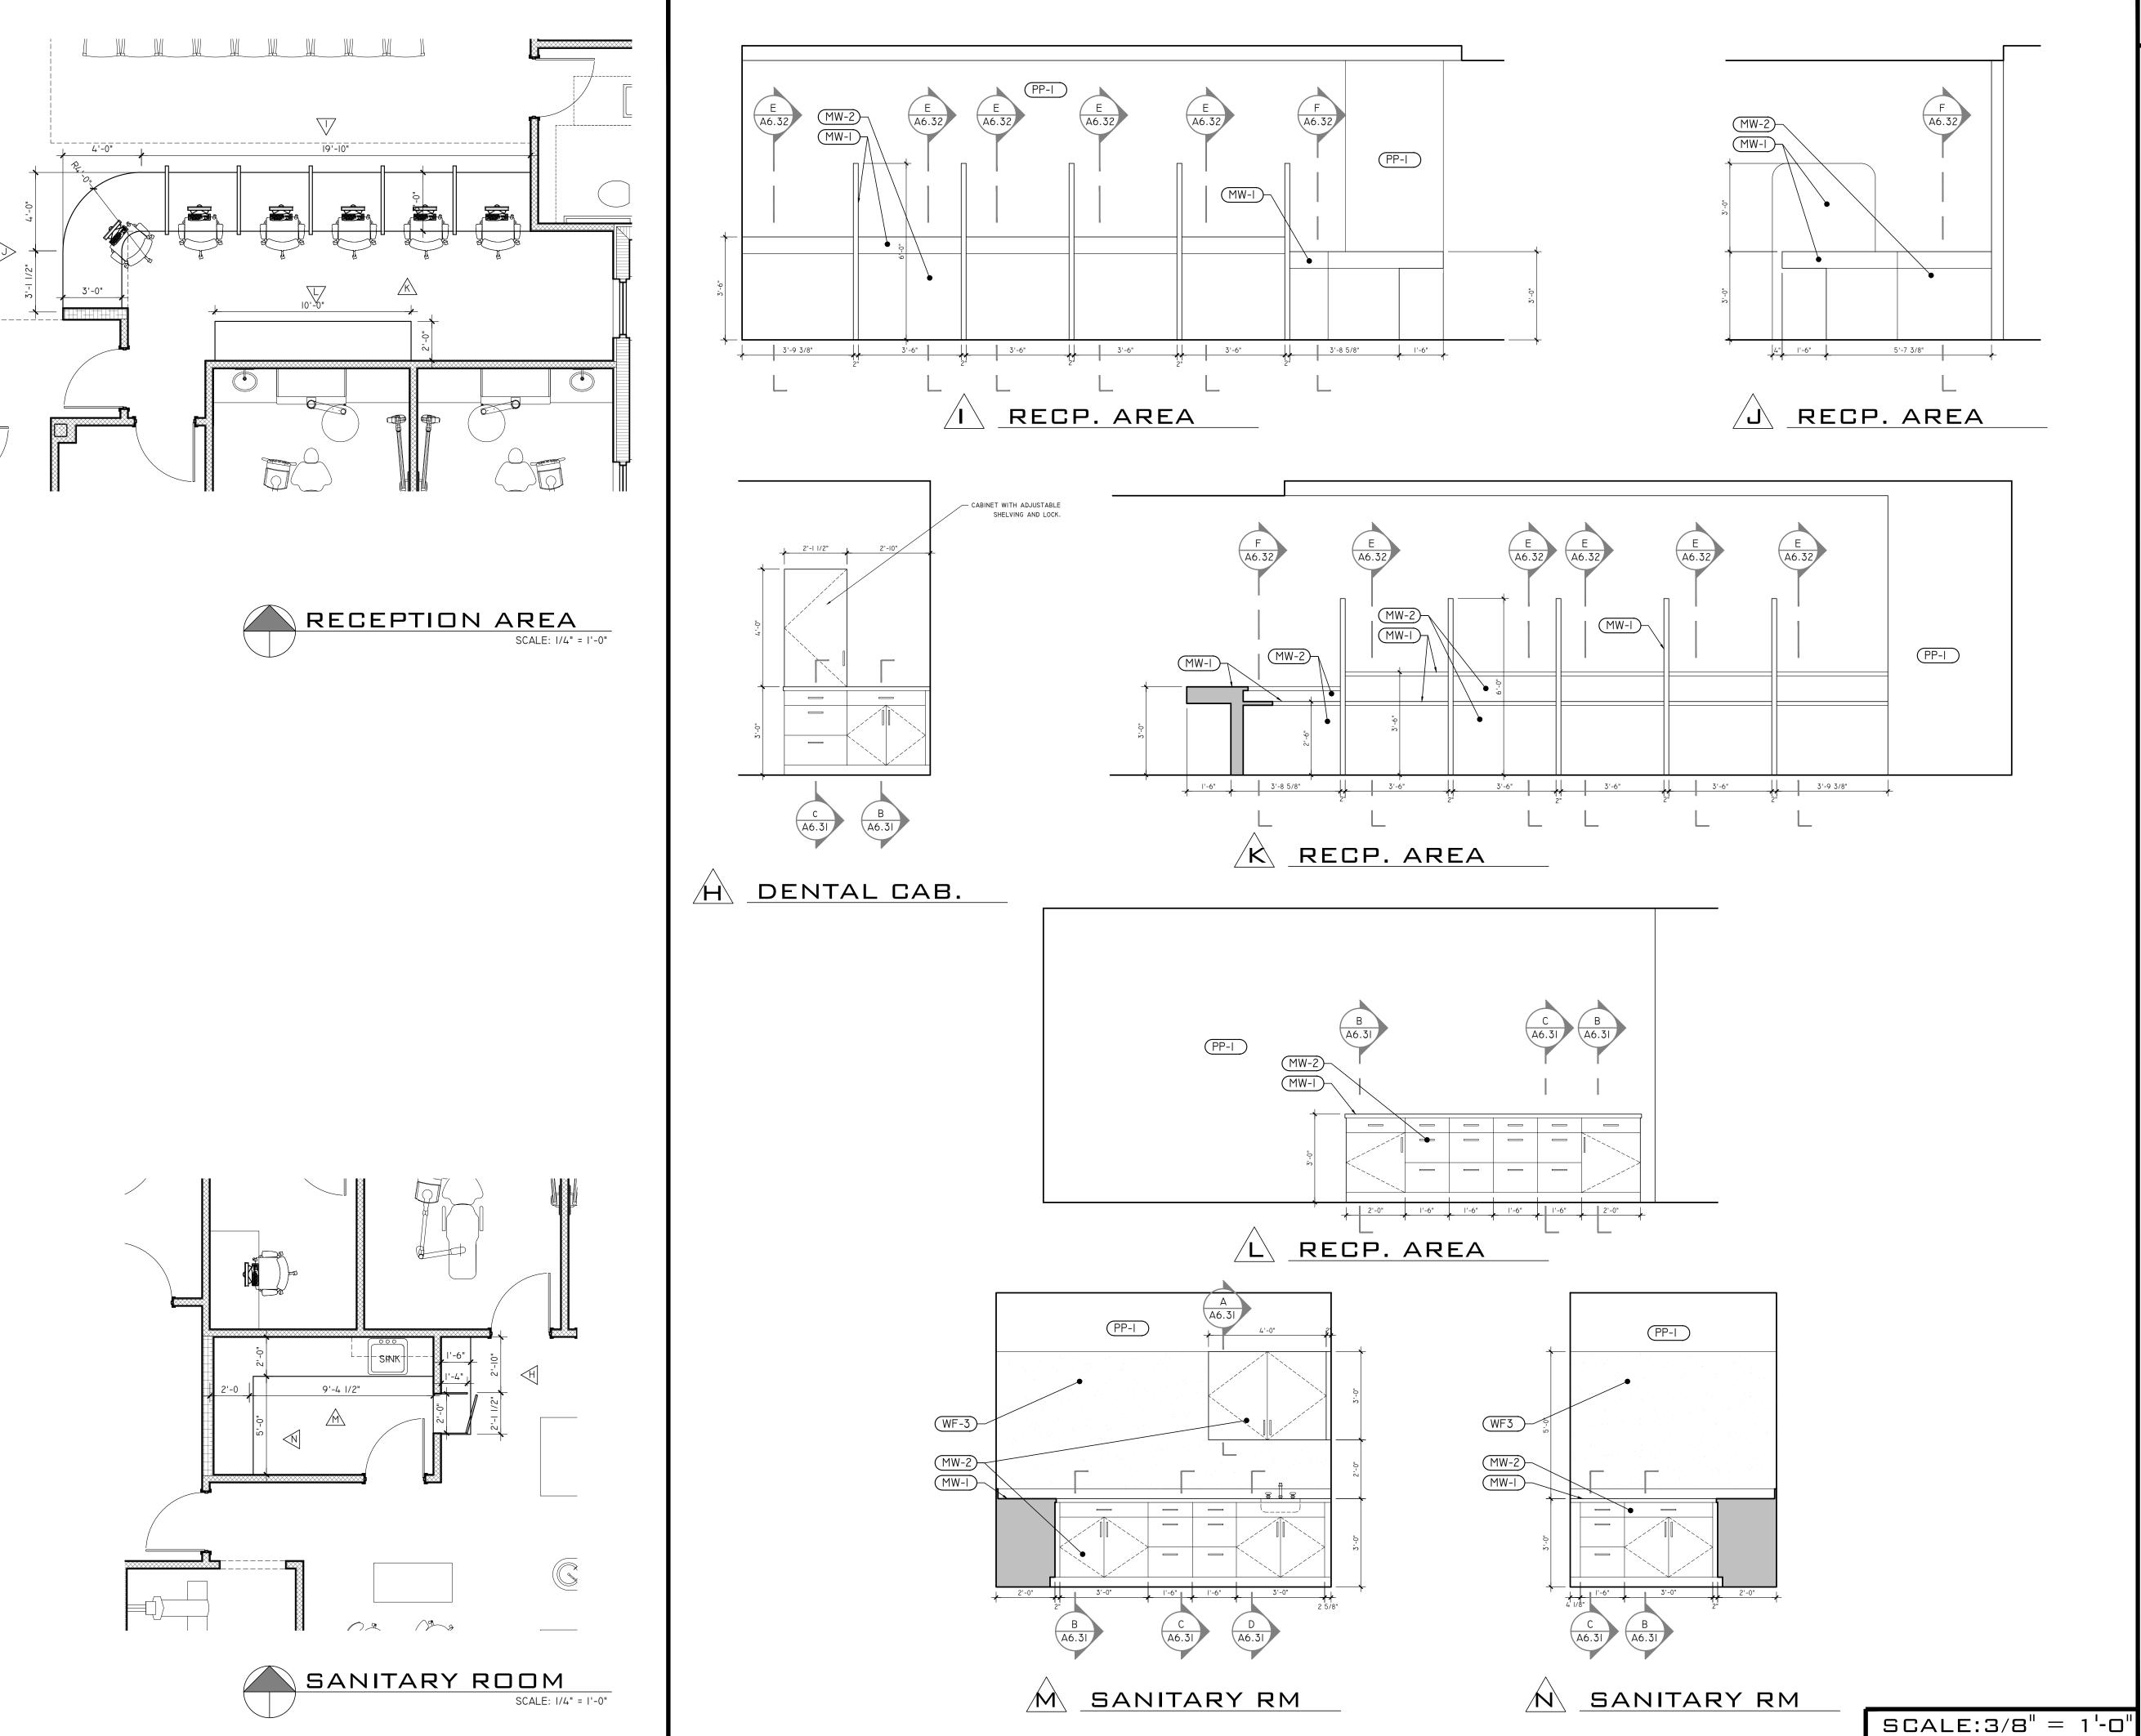
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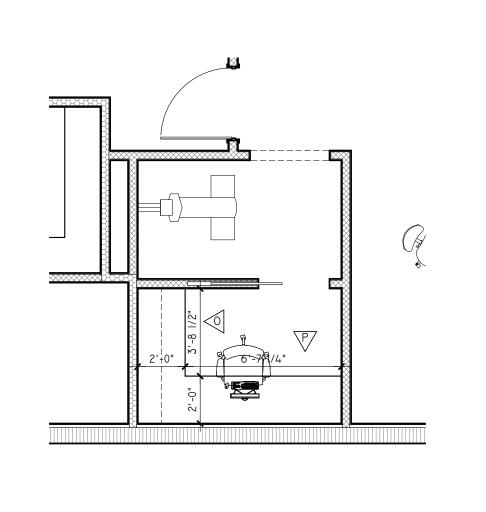
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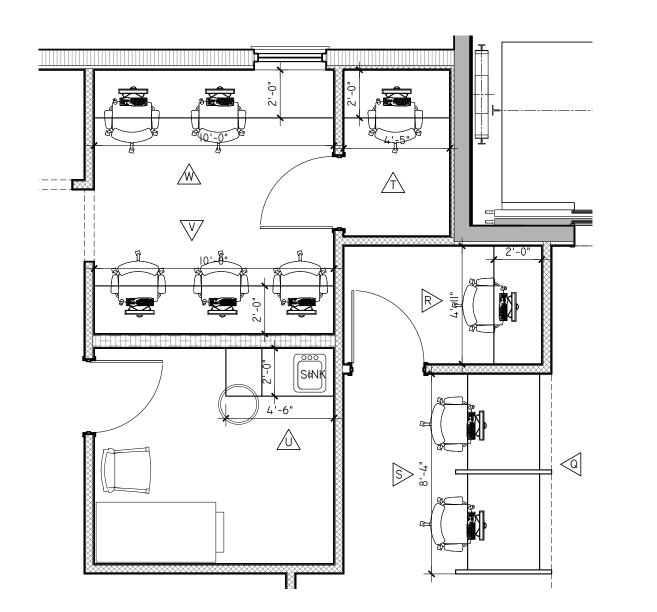
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INTERIOR **ELEVATIONS**


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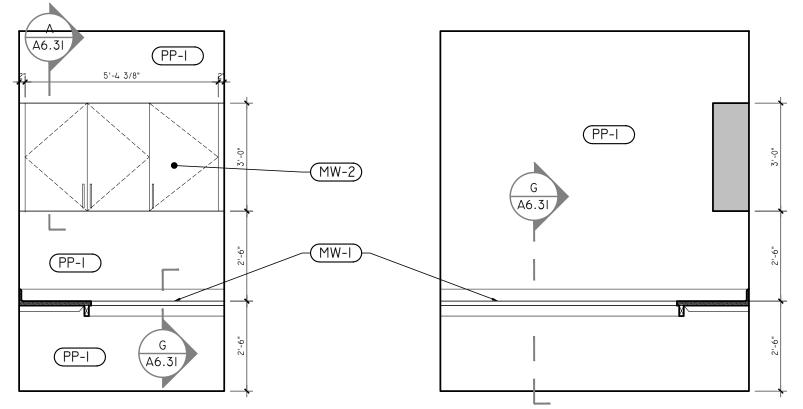




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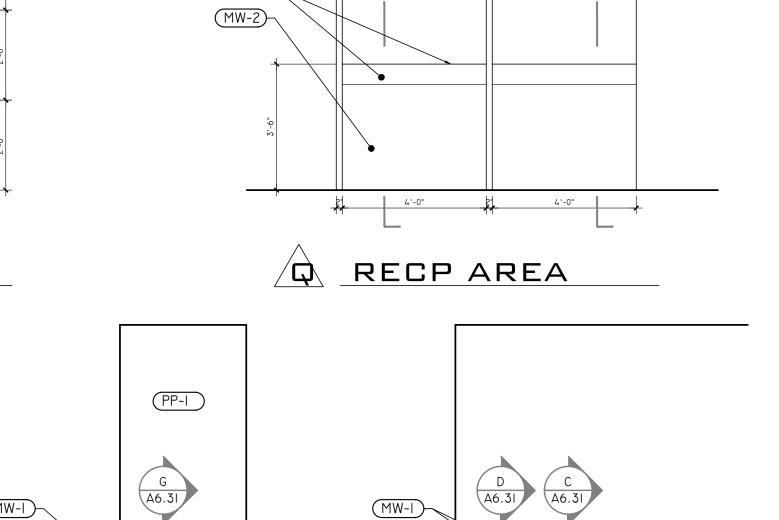






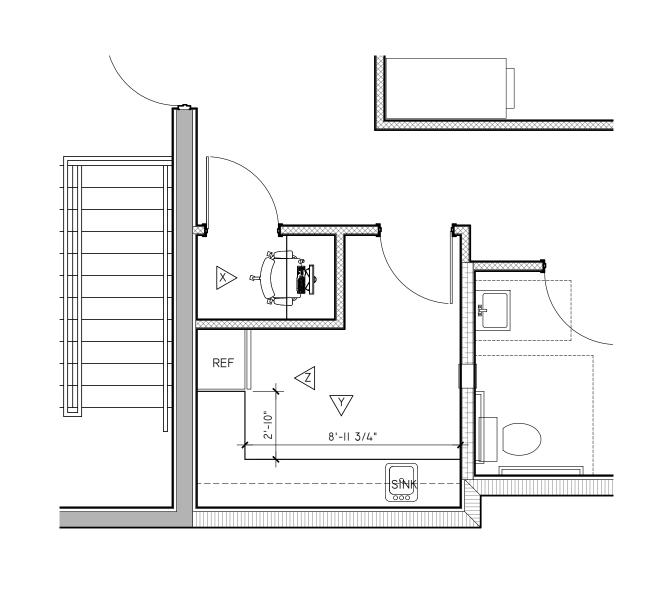


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MW-2)-

EXAM ROOM

PROV. OFFICE



PROV. OFFICE

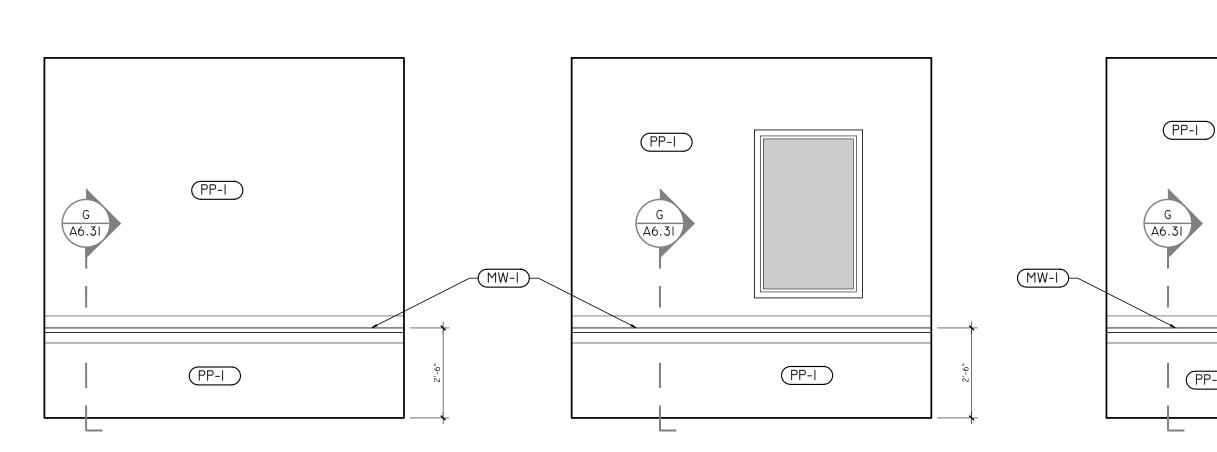

(PP-I)


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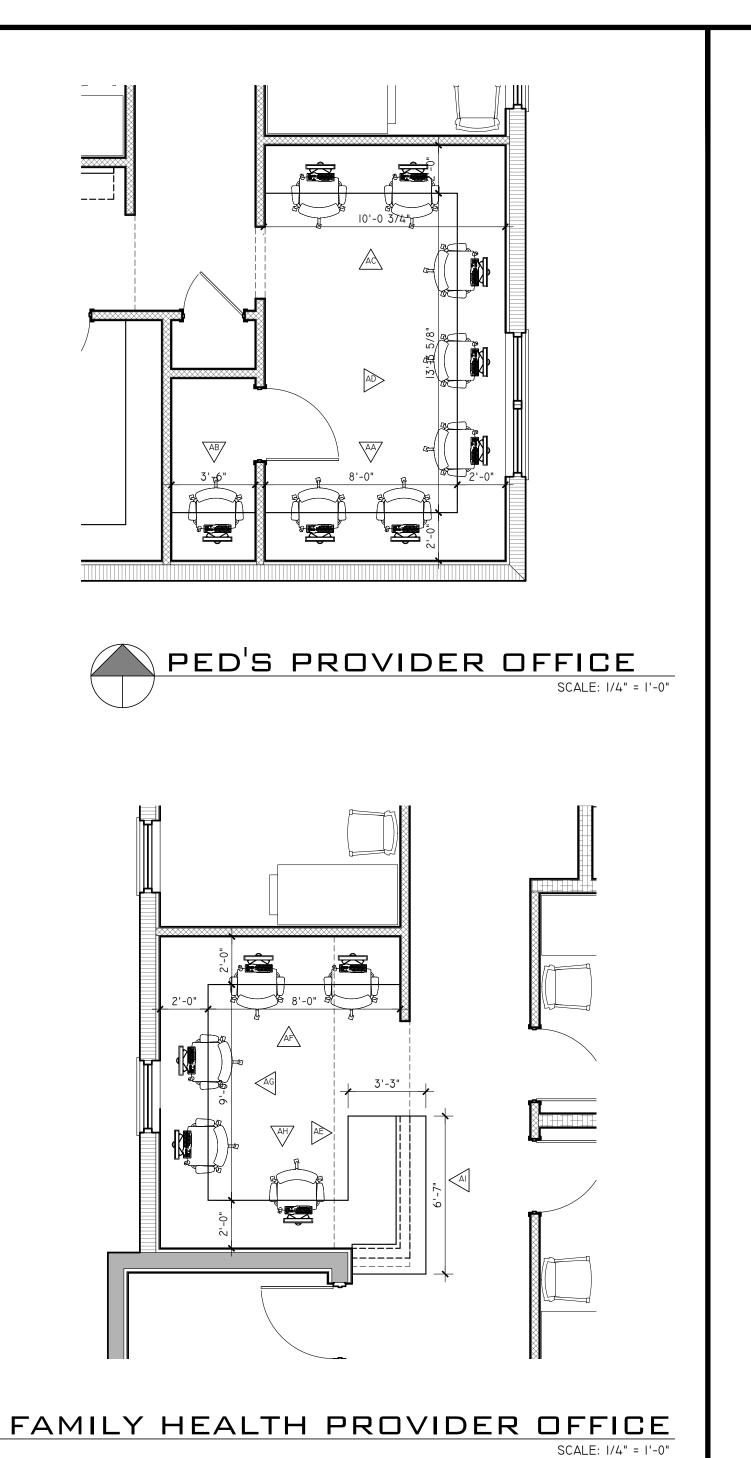
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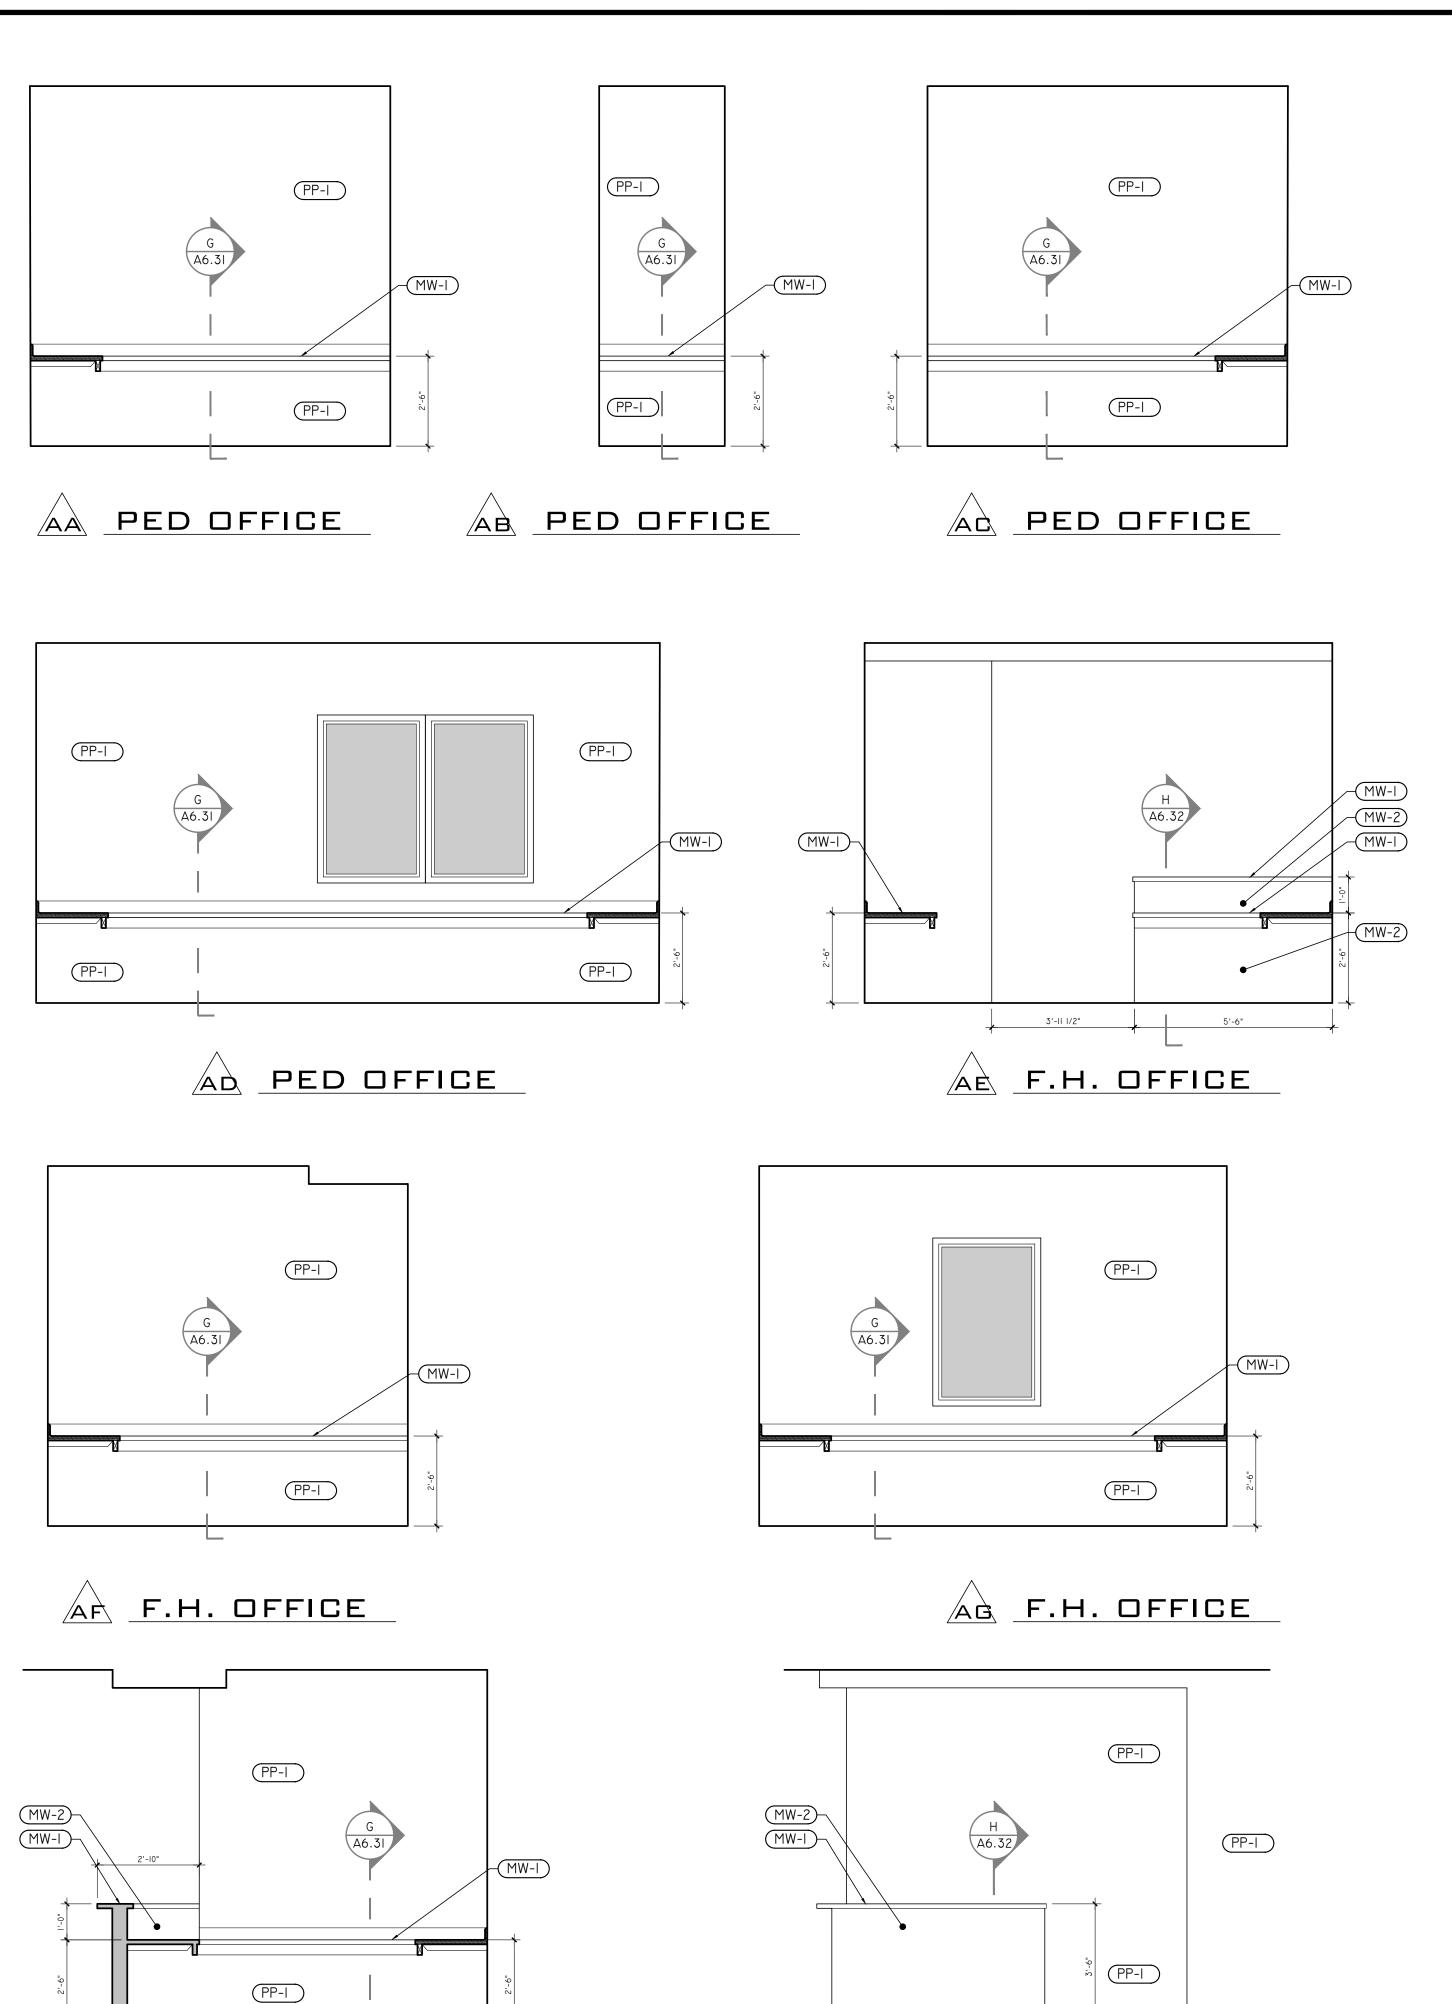
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INTERIOR **ELEVATIONS**

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F.H. OFFICE

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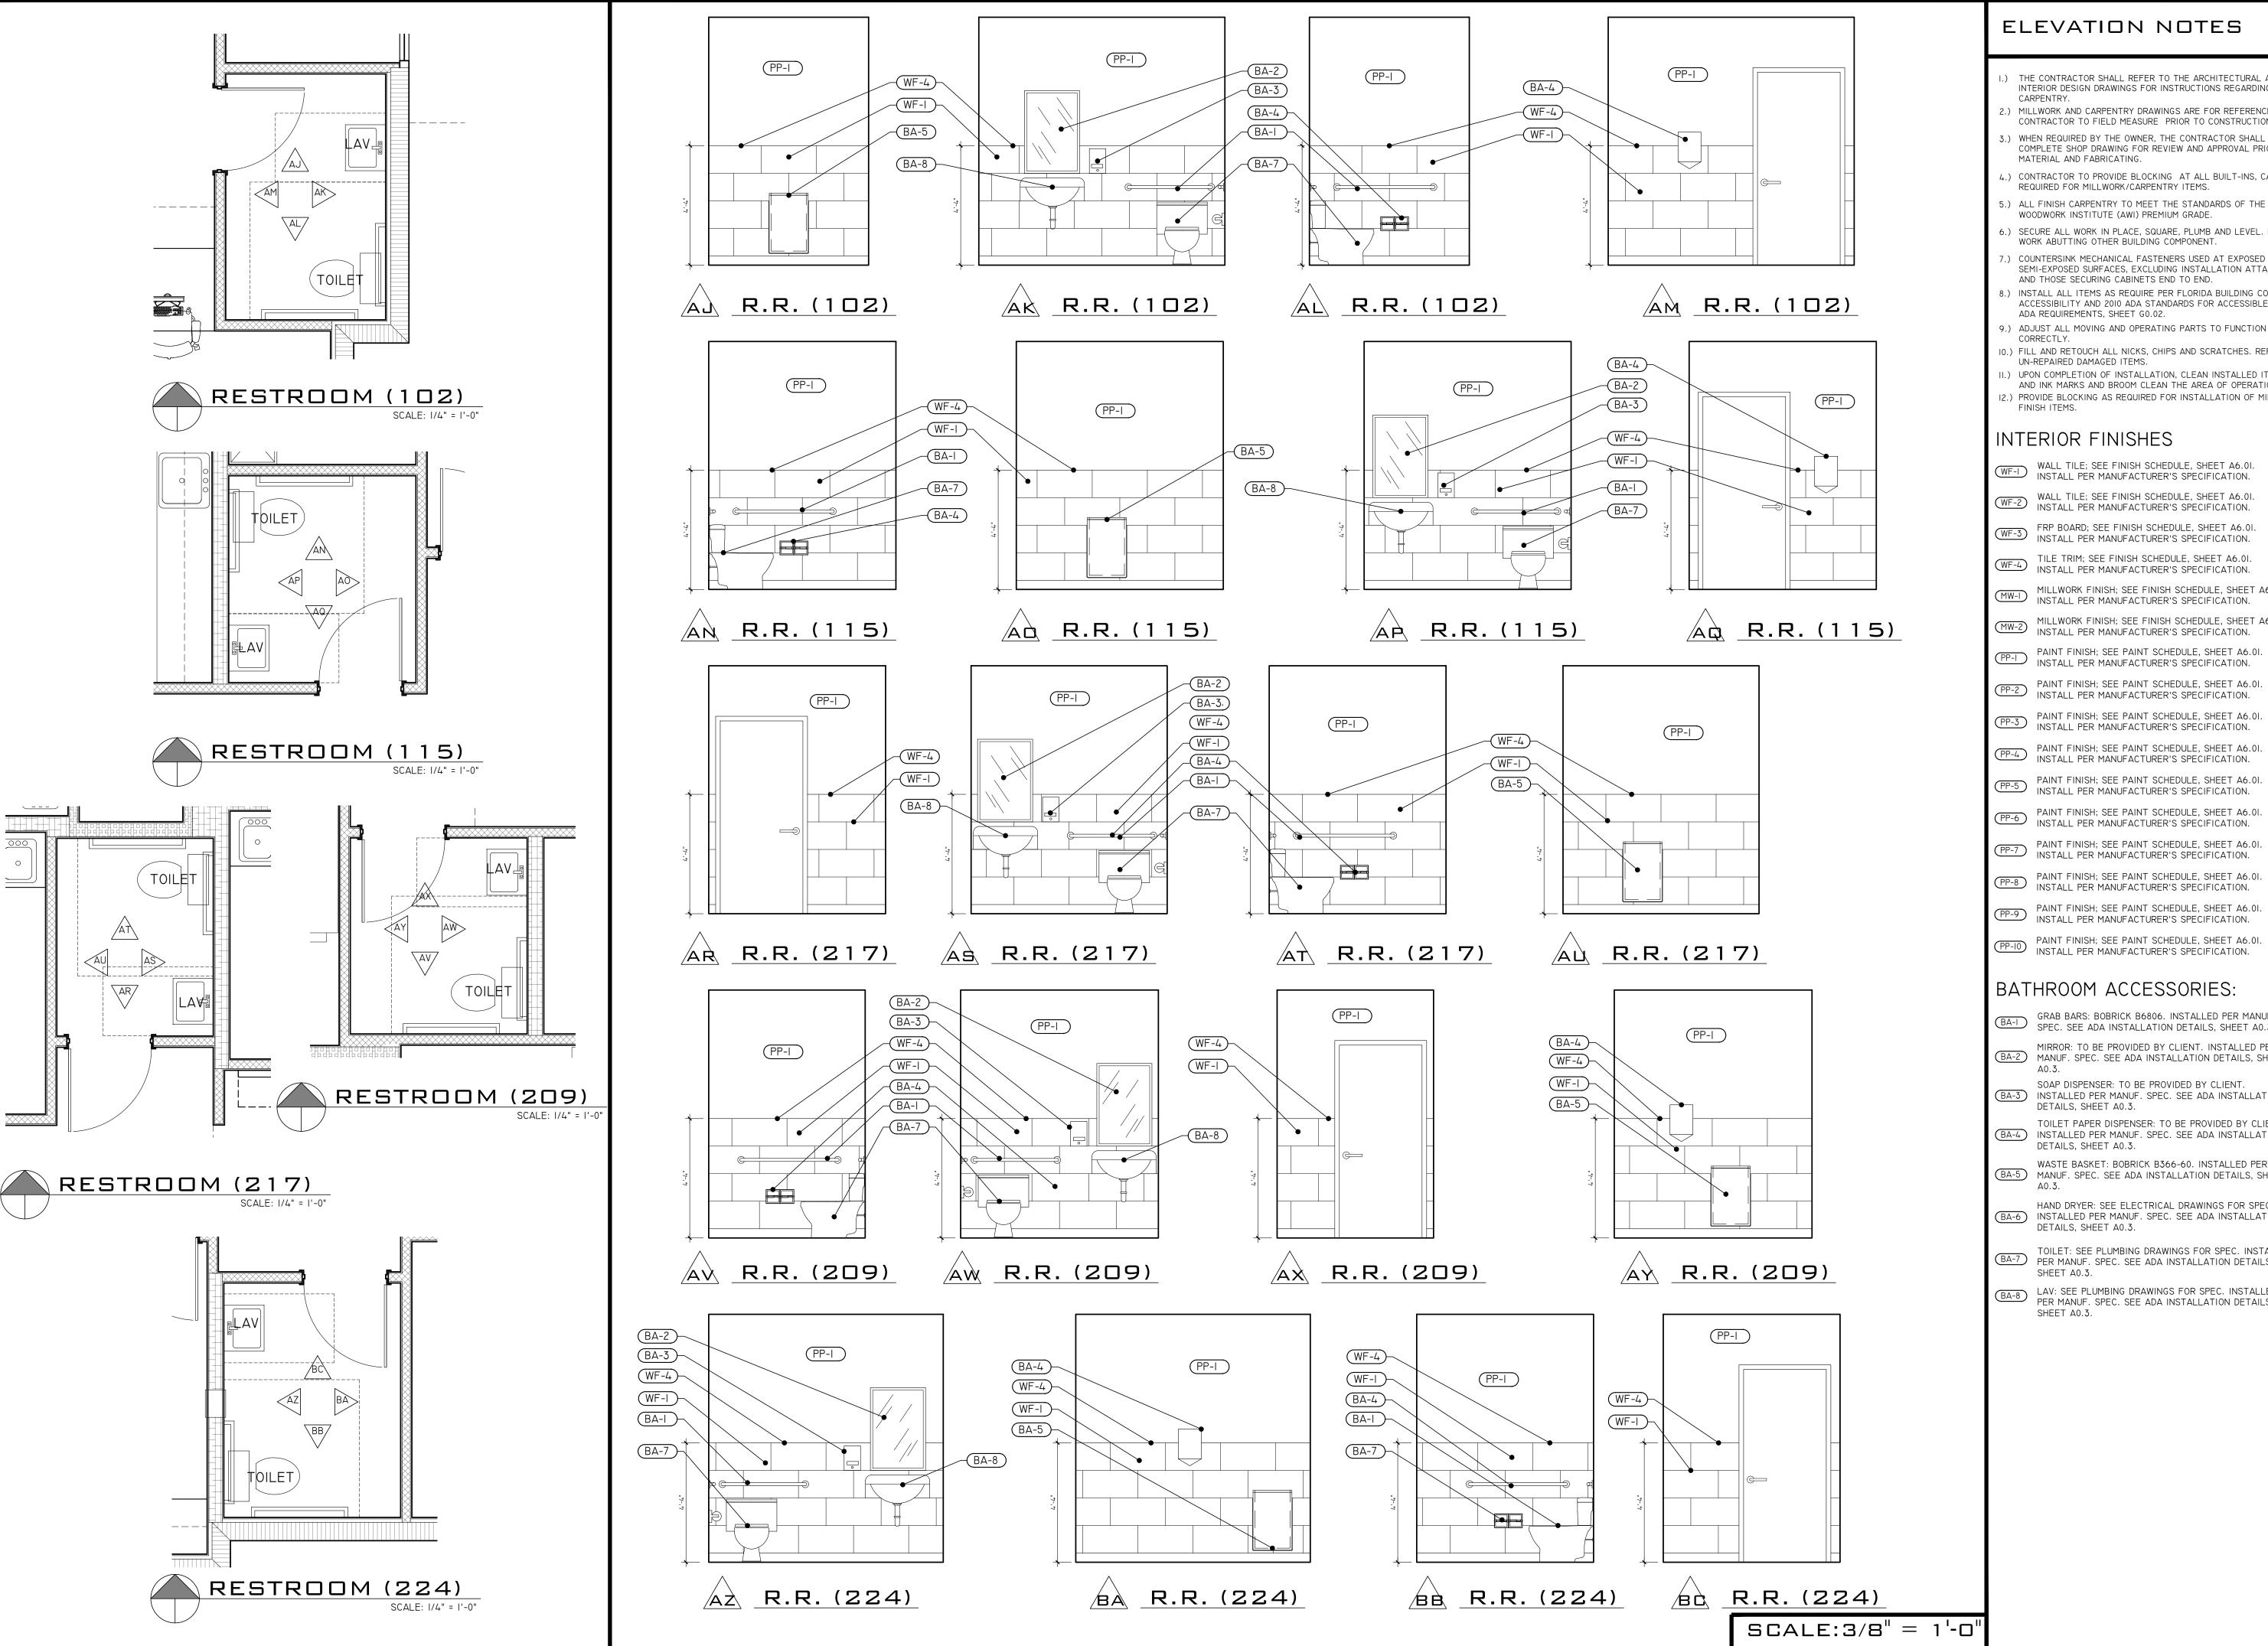
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A6.24

SCALE:3/8" = 1'-0"

F.H. OFFICE

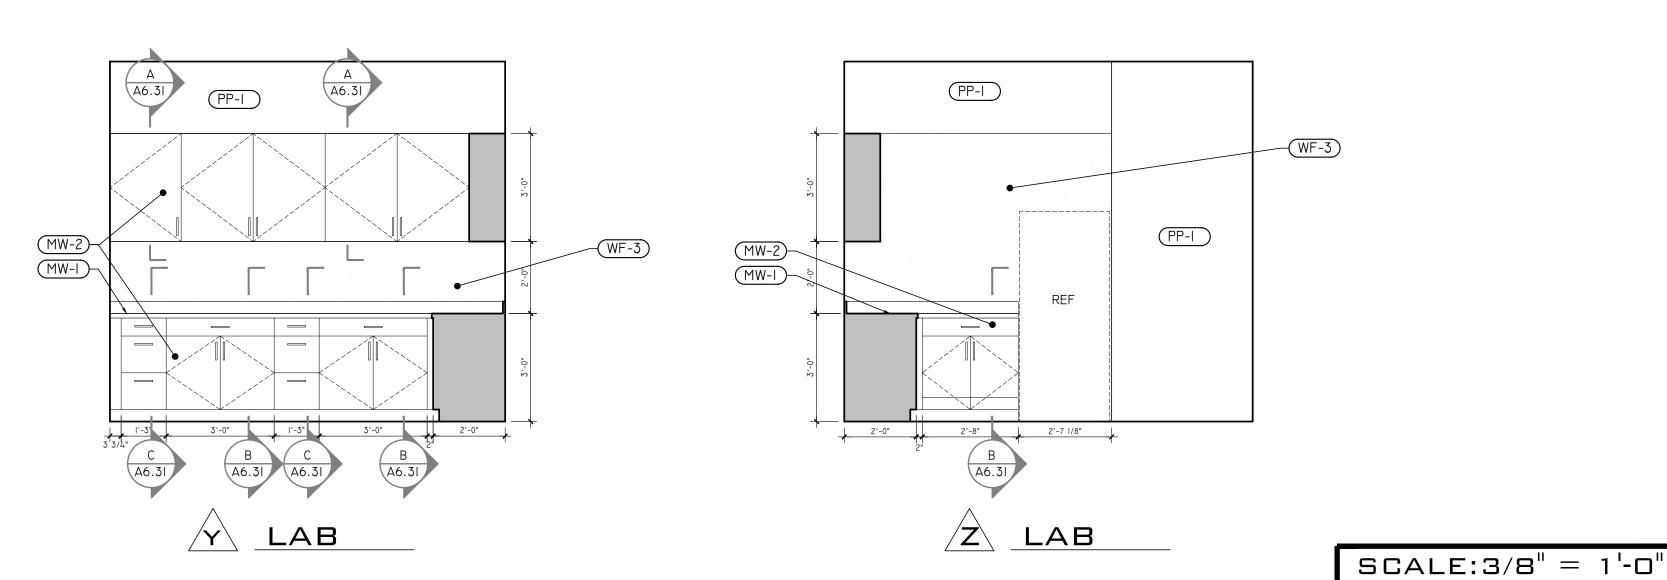

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- WF-I WALL TILE; SEE FINISH SCHEDULE, SHEET A6.01. INSTALL PER MANUFACTURER'S SPECIFICATION.
- WF-2 WALL TILE; SEE FINISH SCHEDULE, SHEET A6.0I. INSTALL PER MANUFACTURER'S SPECIFICATION.
- FRP BOARD; SEE FINISH SCHEDULE, SHEET A6.01. INSTALL PER MANUFACTURER'S SPECIFICATION.
- WF-4 TILE TRIM; SEE FINISH SCHEDULE, SHEET A6.01. INSTALL PER MANUFACTURER'S SPECIFICATION.
- MILLWORK FINISH; SEE FINISH SCHEDULE, SHEET A6.01. INSTALL PER MANUFACTURER'S SPECIFICATION.
- MILLWORK FINISH; SEE FINISH SCHEDULE, SHEET A6.01. INSTALL PER MANUFACTURER'S SPECIFICATION.
- PP-2 PAINT FINISH; SEE PAINT SCHEDULE, SHEET A6.01. INSTALL PER MANUFACTURER'S SPECIFICATION.
- PP-3 PAINT FINISH; SEE PAINT SCHEDULE, SHEET A6.01. INSTALL PER MANUFACTURER'S SPECIFICATION.
- PAINT FINISH; SEE PAINT SCHEDULE, SHEET A6.01. INSTALL PER MANUFACTURER'S SPECIFICATION.
- PAINT FINISH; SEE PAINT SCHEDULE, SHEET A6.01. INSTALL PER MANUFACTURER'S SPECIFICATION.
- PAINT FINISH; SEE PAINT SCHEDULE, SHEET A6.01. INSTALL PER MANUFACTURER'S SPECIFICATION.
- PP-7 PAINT FINISH; SEE PAINT SCHEDULE, SHEET A6.01. INSTALL PER MANUFACTURER'S SPECIFICATION.
- PP-8 PAINT FINISH; SEE PAINT SCHEDULE, SHEET A6.01. INSTALL PER MANUFACTURER'S SPECIFICATION.
- PAINT FINISH; SEE PAINT SCHEDULE, SHEET A6.01. INSTALL PER MANUFACTURER'S SPECIFICATION.
- PAINT FINISH; SEE PAINT SCHEDULE, SHEET A6.01. INSTALL PER MANUFACTURER'S SPECIFICATION.

BATHROOM ACCESSORIES:

- GRAB BARS: BOBRICK B6806. INSTALLED PER MANUF. SPEC. SEE ADA INSTALLATION DETAILS, SHEET A0.3.
- MIRROR: TO BE PROVIDED BY CLIENT. INSTALLED PER MANUF. SPEC. SEE ADA INSTALLATION DETAILS, SHEET
- SOAP DISPENSER: TO BE PROVIDED BY CLIENT.

 BA-3 INSTALLED PER MANUF. SPEC. SEE ADA INSTALLATION DETAILS, SHEET A0.3.
- TOILET PAPER DISPENSER: TO BE PROVIDED BY CLIENT.

 BA-4 INSTALLED PER MANUF. SPEC. SEE ADA INSTALLATION DETAILS, SHEET A0.3.
- WASTE BASKET: BOBRICK B366-60. INSTALLED PER MANUF. SPEC. SEE ADA INSTALLATION DETAILS, SHEET
- HAND DRYER: SEE ELECTRICAL DRAWINGS FOR SPEC. (BA-6) INSTALLED PER MANUF. SPEC. SEE ADA INSTALLATION DETAILS, SHEET A0.3.
- TOILET: SEE PLUMBING DRAWINGS FOR SPEC. INSTALLED PER MANUF. SPEC. SEE ADA INSTALLATION DETAILS, SHEET A0.3.
- (BA-8) LAV: SEE PLUMBING DRAWINGS FOR SPEC. INSTALLED PER MANUF. SPEC. SEE ADA INSTALLATION DETAILS, SHEET A0.3.

ARCHITECTURE

1 5 4 2 G U A V A A V E . MELBOURNE, FL 32935 3 2 1 4 2 8 3 8 6 9

JOB #: C-2022-032 DRAWN: JKA CHECKED: JKA

DATE

2023-09-25 PERMIT

REVISIONS:

H AL BREVARD SILVER


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INTERIOR **ELEVATIONS**

SHEET NUMBER



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design@meldstudioarchitecture.com

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2023-09-25

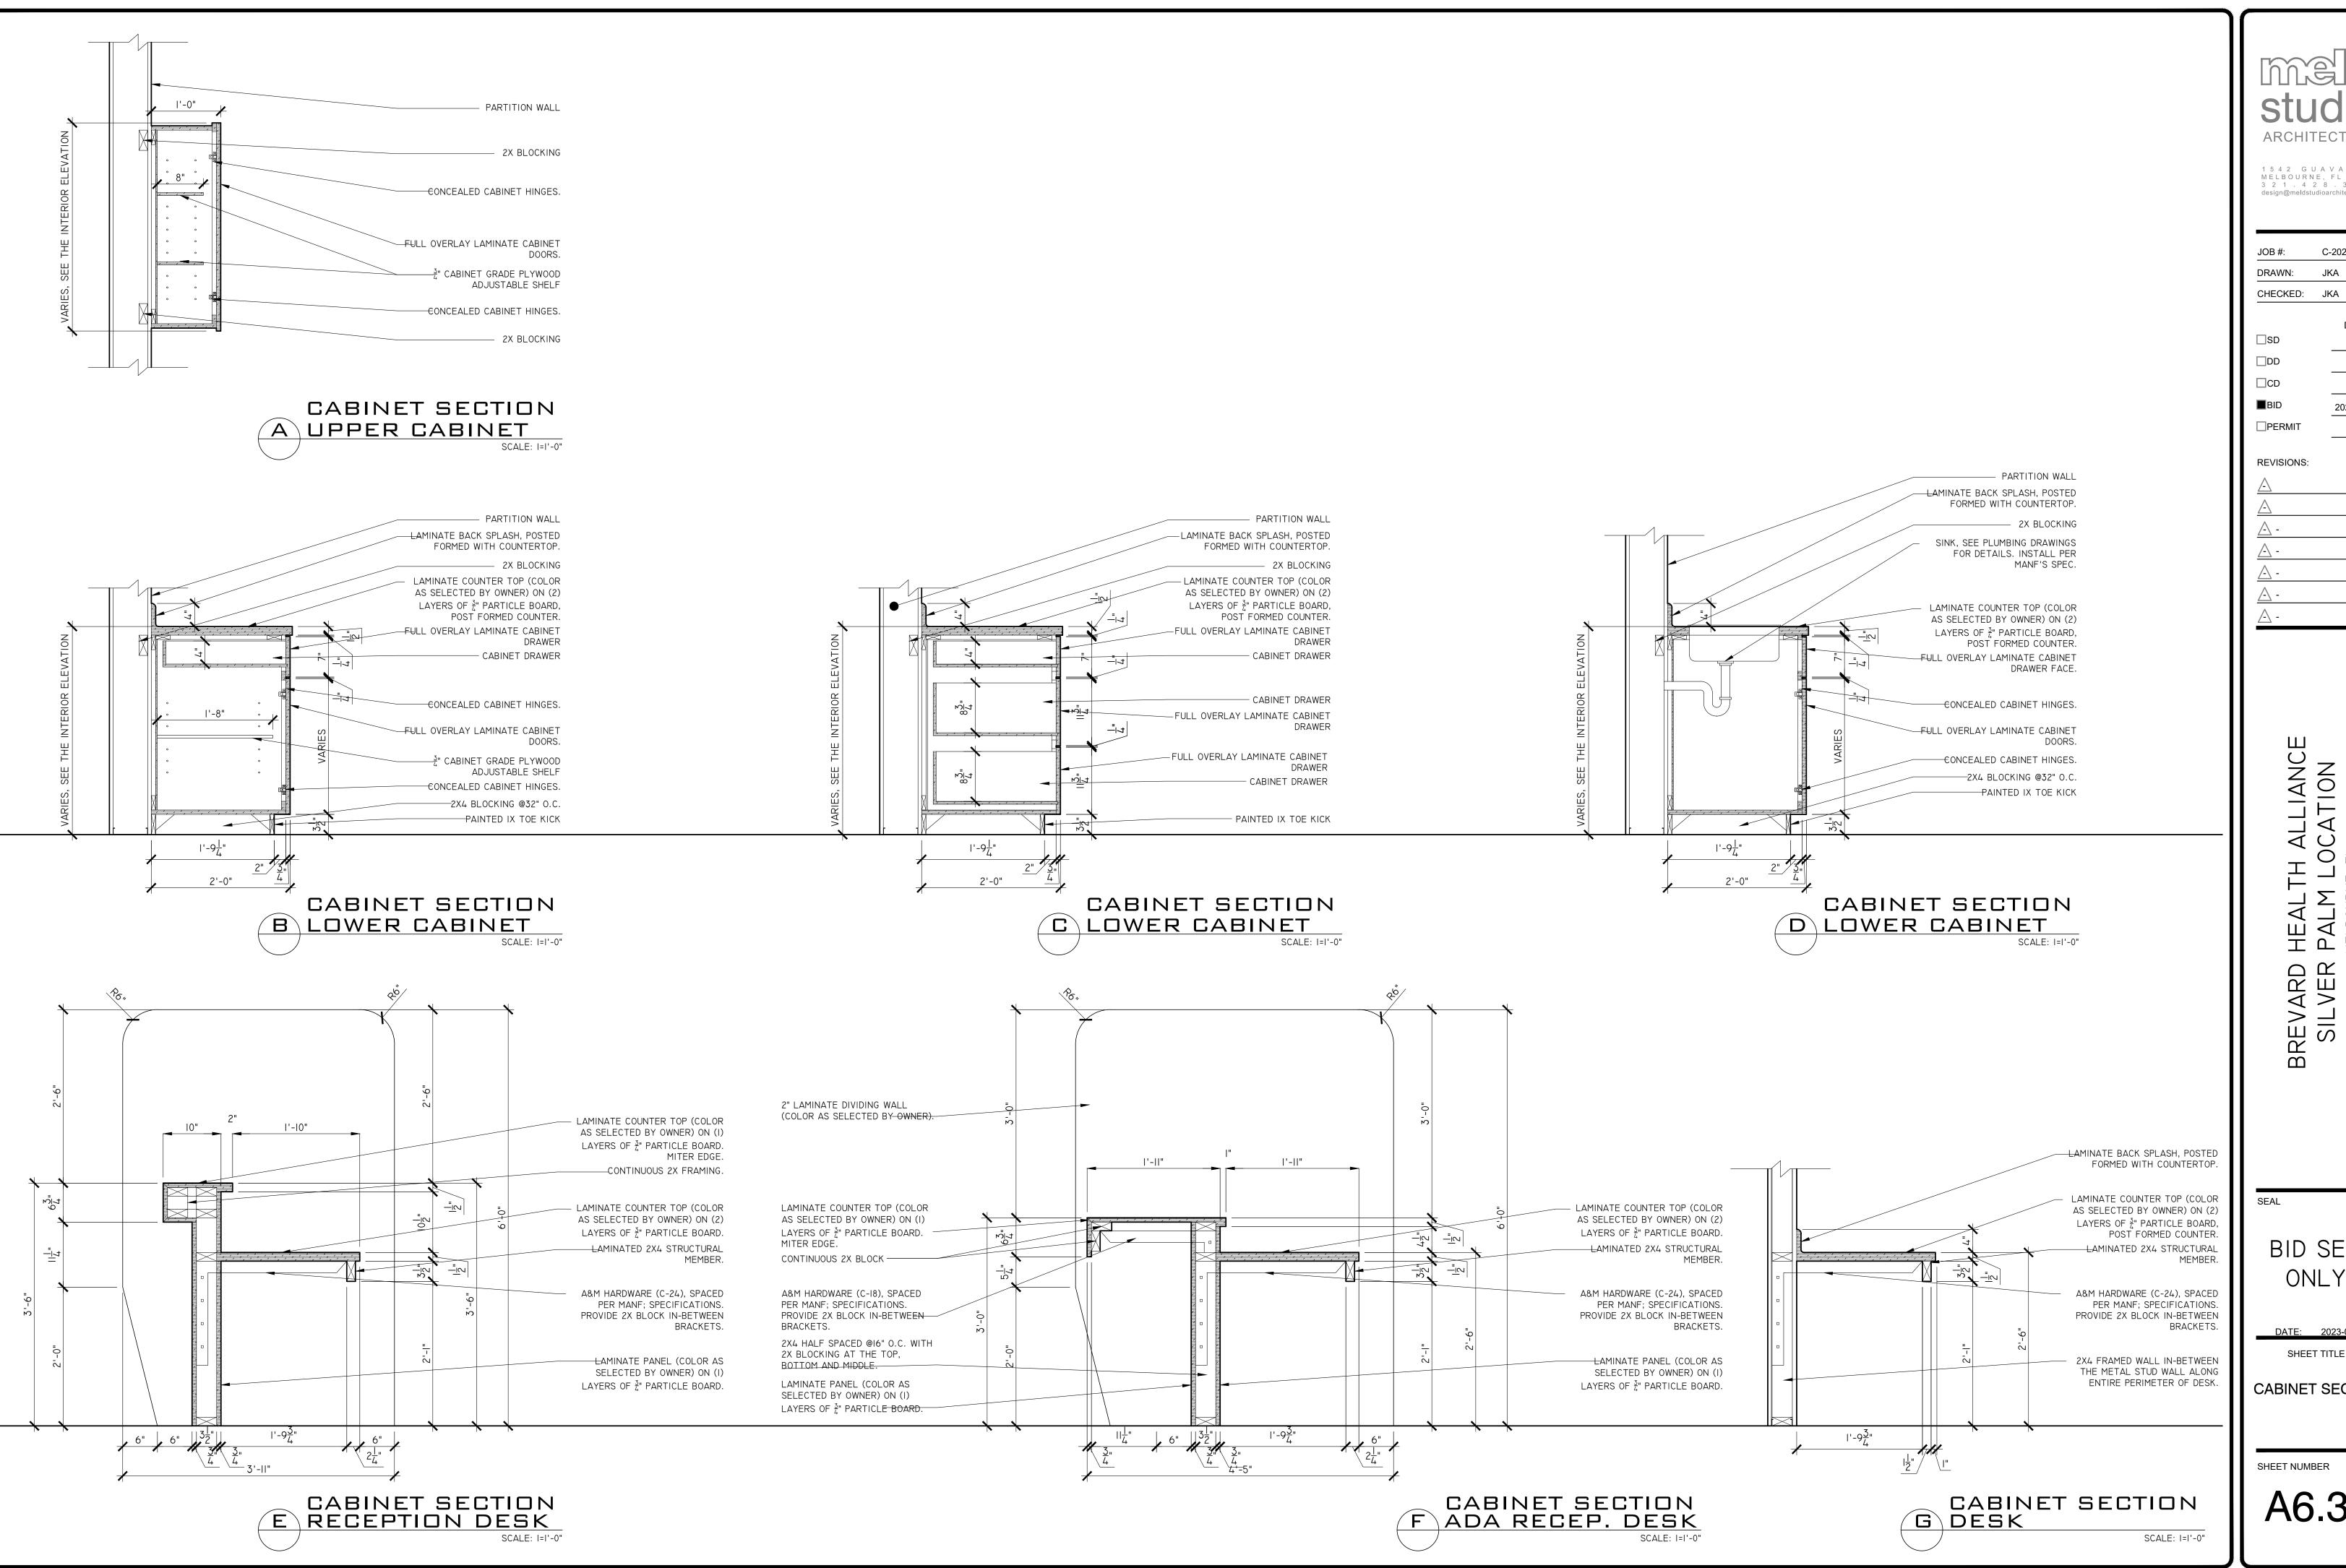REVISIONS:


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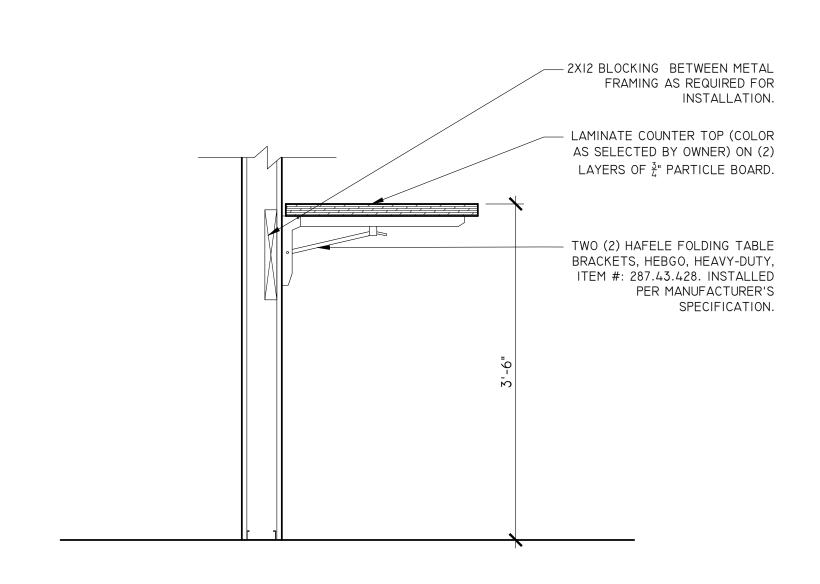
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> DATE: 2023-09-25 SHEET TITLE

CABINET SECTIONS

SHEET NUMBER





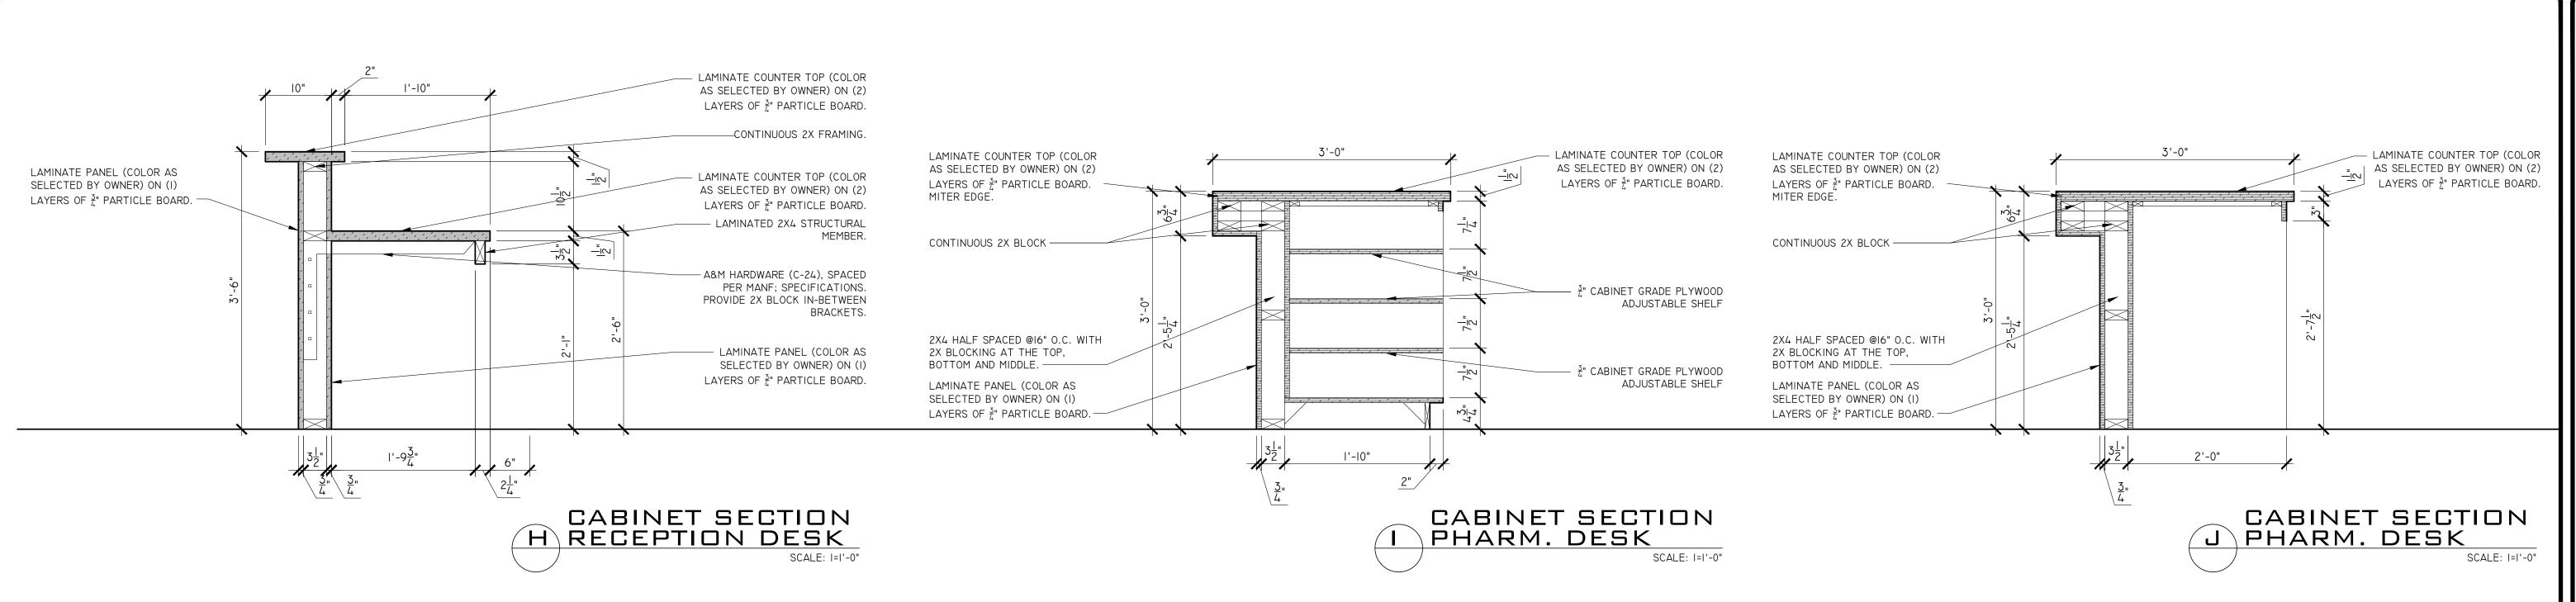

ARCHITECTURE

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