ATLANTIC FIELDS - GOLF HOUSE

2645 SE BRIDGE ROAD, HOBE SOUND, FL 33455









P + L PROJECT No. 22-061

PERMIT SET

11.01.2023



PEACOCK + LEWIS
Architects and Planner
LLC

1295 US Highway One Suite 200 North Palm Beach, FL. 33408

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DESIGN ARCHITECT

159 South Jackson St,



ATLANTIC FIELDS -GOLF HOUSE

PERMIT SET

2645 SE BRIDGE ROAD, HOBE SOUND, FL 33455

eal:

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COVER SHEET

Rev	Revisions:				
No.	Description	Date			

Comm:	Date:	
22-061	11.01.2023	
Drawn By:	Checked:	
P+L BC	FL	

Sheet:

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	DRAWING INDEX						
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		REVISION DESCRIPTION	H	G. DE	G. DE	ADDENDUM	
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		DATE	(11.01.2023)	(12.15.2023)	(03.15.2024)	33.22.2	
SHEET NO.	SHEET NAME	REV#	<u> </u>		\ <u>\</u>	(e)	
GENERAL		<u>~</u>				71	
A0.00 A0.05	DRAWING INDEX GENERAL NOTES AND PROJECT INFORMATION		X	X		X	
A0.10	LIFE SAFETY PLAN & CODE ANALYSIS		X	X		Х	
A0.15 A0.20	ADA COMPLIANCE ADA COMPLIANT		X	X	Х		
A0.20 A0.21	WINDOW SCHEDULES		X	X		X	
A0.22	LOUVER SCHEDULES		X	Χ		X	
A0.23 A0.24	DOOR SCHEDULE HM INT. DOOR DETAILS		X			X	
A0.25	WD INT. DOOR DETAILS					X	
A0.26 A0.31	EXT. HM DOOR DETAILS ASSEMBLIES - WALLS AND PARTITIONS		X			X	
A0.31	ASSEMBLIES - WALLS AND PARTITIONS ASSEMBLIES - WALLS AND PARTITIONS		X			X	
A0.33	ASSEMBLIES - WALLS AND PARTITIONS		Χ			X	
ARCHITECTURE	<u> </u>						
A1.01	SITE PLAN		Χ			Х	
A2.00 A2.01	OVERALL MAIN LEVEL FLOOR PLAN		X	_		X	
A2.01 A2.02	MAIN LEVEL PARTIAL PLAN A MAIN LEVEL PARTIAL PLAN B		X			X	
A2.03	OVERALL MAIN LEVEL DIMENSION PLAN		Χ			X	
A2.04 A2.05	MAIN LEVEL PARTIAL DIMENSION PLAN A MAIN LEVEL PARTIAL DIMENSION PLAN B		X			X	
A2.06	MAIN LEVEL CLARESTORY PLAN		Χ			Х	
A2.07 A2.10	OVERALL ROOF PLAN MAIN LEVEL SPECIAL CONDITION PLAN		X		Х	X	
A2.10 A3.00	OVERALL EXTERIOR ELEVATIONS		X			X	
A3.01	ENLARGED EXTERIOR ELEVATIONS		Χ			X	
A3.02 A3.03	ENLARGED EXTERIOR ELEVATIONS ENLARGED EXTERIOR ELEVATIONS		X			X	
A3.04	ENLARGED EXTERIOR ELEVATIONS		X			X	
A3.20	BUILDING SECTIONS		X			X	
A4.00 A4.01	WALL SECTIONS WALL SECTIONS		X			X	
A4.02	WALL SECTIONS		Χ			X	
A4.03 A4.04	WALL SECTIONS WALL SECTIONS		X			X	
A4.04 A4.05	WALL SECTIONS WALL SECTIONS		Χ		Х	Х	
A6.00	MAIN LEVEL RCP		Χ	X		X	
A7.00 A7.01	VERTICAL CIRCULATION VERTICAL CIRCULATION			Х		X	
A8.00	EXTERIOR DETAILS		X			X	
A8.01 A8.02	EXTERIOR DETAILS EXTERIOR DETAILS		X			X	
A8.03	EXTERIOR DETAILS			X		Х	
A8.04 A8.05	EXTERIOR DETAILS EXTERIOR DETAILS			X		X	
A8.05 A8.06	EXTERIOR DETAILS EXTERIOR DETAILS			X		X	
A8.07	EXTERIOR DETAILS		-	X		X	
A8.08 A8.09	EXTERIOR DETAILS EXTERIOR DETAILS			X		X	
A8.10	EXTERIOR CHIMNEY DETAILS					Х	
A8.11 A8.12	FRAMING DETAILS CEILING DETAILS					X	
A8.12 A8.13	EXTERIOR DETAILS					X	
						. 1	•
INTERIOR A5.00	MAIN LEVEL FINISH PLAN		X	Х		Х	
A5.01	MAIN LEVEL KEY PLAN		Χ	Χ		Х	
A5.02	MAIN LEVEL FURNITURE & POWER PLAN ENLARGED PLANS & INTERIOR ELEVATIONS		X	X		X	
A5.03 A5.04	ENLARGED PLANS & INTERIOR ELEVATIONS ENLARGED PLANS & INTERIOR ELEVATIONS		X	X		X	
A5.05	ENLARGED PLANS & INTERIOR ELEVATIONS		Χ	Χ	Χ	Х	
A5.06 A5.07	ENLARGED PLANS & INTERIOR ELEVATION ENLARGED PLANS & INTERIOR ELEVATIONS		X	X		X	
A5.08	ENLARGED PLANS & INTERIOR ELEVATIONS ENLARGED PLANS & INTERIOR ELEVATIONS			Χ		X	
A5.09	ENLARGED PLANS & INTERIOR ELEVATIONS ENLARGED PLANS & INTERIOR ELEVATIONS			X		Y	
A5.10 A5.11	ENLARGED PLANS & INTERIOR ELEVATIONS ENLARGED PLANS & INTERIOR ELEVATIONS			X		X	
A5.12	FINISH NOTES, SCHEDULES, & SPECIFICATIONS			X		Х	
A5.13 A5.14	MAIN LEVEL FINISH PLAN BACK OF HOUSE BACK OF HOUSE FINISH NOTES, SCHEDULES, &					X	
	SPECIFICATIONS		Х			X	
A9.00 A9.01	INTERIOR MILLWORK DETAILS INTERIOR MILLWORK DETAILS			X			
A9.01 A9.02	INTERIOR MILLWORK DETAILS INTERIOR MILLWORK DETAILS			X			
A9.03	INTERIOR MILLWORK DETAILS			Χ		X	
A9.04 A9.05	TYPICAL INTERIOR DETAILS TYPICAL INTERIOR DETAILS			X		X	
	. II IO. E III EI IIOI DE II IIEO					· ·	
STRUCTURAL S 1.01	EQUINDATION DI ANI	1	~	V		Y	
S-1.01 S-1.02	FOUNDATION PLAN ROOF FRAMING PLAN		X	X		X	
S-2.01	STRUCTURAL NOTES & SCHEDULES		Χ	X		X	
S-2.02 S-2.03	WIND LOADS TYPICAL DETAILS		X	Х		X	
S-2.03 S-2.04	TYPICAL DETAILS TYPICAL PT DETAILS		X	^		,,,	
S-3.01	SECTIONS SECTIONS		Χ	Χ		X	

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		REVISION DESCRIPTION PERMIT SET	BUILDING COMMENTS	DEPT. COMMENTS			
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SHEET NO.	SHEET NAME	REV#		%	(m)		
FIRE PROTECTION	DNI						
F0.01	GENERAL NOTES & DESIGN CRITERIA - FIRE PROTECTION	Х					
F2.00	LEVEL 01 - FLOOR PLAN - FIRE PROTECTION	X			X		
F5.01	DETAILS - FIRE PROTECTION	X					
F5.02	DETAILS - FIRE PROTECTION	X					
F6.01	SCHEDULE - FIRE PROTECTION	X					
PLUMBING							
P0.01	GENERAL NOTES, ABBREVIATIONS, & LEGEND - PLUMBING	Х			Х		
P1.00	FOUNDATION FLOOR PLAN - PLUMBING	X			X		
P2.00	LEVEL 01 - FLOOR PLAN - PLUMBING	Х			Х		
P2.01	ROOF PLAN - PLUMBING	X			X		
P3.01	LP GAS PLAN - PLUMBING RISER DIAGRAM - PLUMBING	X			X		
P4.01 P4.02	RISER DIAGRAM - PLUMBING RISER DIAGRAM - PLUMBING	X			X	_	+
P4.02	RISER DIAGRAM - PLUMBING	X			X	_	
P5.01	DETAILS - PLUMBING	X			X		
P5.02	DETAILS - PLUMBING	Х			Х		
P6.01	SCHEDULES - PLUMBING	X			X		
P6.02	SCHEDULES - PLUMBING	X					
MECHANICAL							
M0.01	GENERAL NOTES, ABBREVIATIONS, & LEGEND - HVAC	Х					
M2.00	LEVEL 01 - FLOOR PLAN - HVAC	Х			Х		
M2.01	ROOF PLAN - HVAC	Х			Х		
M5.01	DETAILS - HVAC	X					
M5.02 M6.01	DETAILS - HVAC SCHEDULES - HVAC	X	X		X		
IVIO.U I	SCHEDULES - HVAC	^					
ELECTRICAL							
E0.01	GENERAL NOTES AND SYMBOLS LEGEND - ELECTRICAL	X			Х		
E1.00	LEVEL 01 - FLOOR PLAN - LIGHTING	Х			Х		
E1.01	LEVEL 01-FLOOR PLAN-LIGHTING CONTROLS				X		
E2.00	LEVEL 01 - FLOOR PLAN - FUPE ALABAM	X			X		
E3.00 E4.01	LEVEL 01 - FLOOR PLAN - FIRE ALARM ENLARGED PLANS - ELECTRICAL	X			X		
E4.01	ROOF PLAN - ELECTRICAL	$\frac{\lambda}{X}$			X		
E5.01	DETAILS - ELECTRICAL	X					
E5.02	DETAILS - ELECTRICAL				Х		
E5.03	DETAILS - LIGHITNG CONTROLS				X		
E6.01	ONE-LINE DIAGRAM AND PANEL SCHEDULES - ELECTRICAL		X		Х		
COMMUNICATIO	NS						
T0.00	TECHNOLOGIY GENERAL NOTES & SYMBOLS		Х		Х		
T0.01	TECHNOLOGY EQUIPMENT LIST AND SINGLE LINES		X		X		
T1.00	TECHNOLOGY SITE PLAN		Х				
T2.00	TECHNOLOGY FLOOR PLAN		X				
T2.01	TECHNOLOGY ELECTRICAL FLOOR PLAN		X		v		
T2.10 T3.00	TECHNOLOGY REFLECTED CEILING PLAN TECHNOLOGY ENLARGED DETAILS	+	X		X		
T3.01	TECHNOLOGY ENLARGED DETAILS TECHNOLOGY ENLARGED DETAILS	+	X			_	
T4.00	TECHNOLOGY DETAILS		X				
T4.10	TECHNOLOGY DETAILS		Х				
T700	SHEET SPECIFICATIONS 01				X		
T701 T702	SHEET SPECIFICATIONS 02 SHEET SPECIFICATIONS 03				X		
T702	SHEET SPECIFICATIONS 03 SHEET SPECIFICATIONS 04				X		
T704	SHEET SPECIFICATIONS 05	+			X		
T705	SHEET SPECIFICATIONS 06				Х		
T706	SHEET SPECIFICATIONS 07				X		
T707	SHEET SPECIFICATIONS 08				X		
T708	SHEET SPECIFICATIONS 09		1		Х		
FOOD SERVICE	(FOR INFORMATION ONLY)						
FS1.00	FOODSERVICE FLOOR PLAN		Х				
FS1.11	FOODSERVICE EQUIPMENT PLAN		X				
FS1.12	FOODSERVICE BUILDING CONDITIONS/VENTILATION PLAN		X				
EC4 40	FOODSERVICE PLUMBING ROUGH-IN PLAN FOODSERVICE ELECTRICAL ROUGH-IN PLAN		X				
FS1.13 FS1.14	FOOD SERVICE EQUIPMENT PLAN	+	X				
FS1.14			X				
	FOODSERVICE BUILDING CONDITIONS PLAN	- 1					
FS1.14 FS2.11	FOODSERVICE BUILDING CONDITIONS PLAN FOODSERVICE PLUMBING ROUGH IN PLAN		X				_
FS1.14 FS2.11 FS2.12 FS2.13 FS2.14	FOODSERVICE PLUMBING ROUGH IN PLAN FOODSERVICE ELECTRICAL ROUGH-IN PLAN		X				
FS1.14 FS2.11 FS2.12 FS2.13 FS2.14 FS2.15	FOODSERVICE PLUMBING ROUGH IN PLAN FOODSERVICE ELECTRICAL ROUGH-IN PLAN FOODSERVICE ELEVATIONS		X				
FS1.14 FS2.11 FS2.12 FS2.13 FS2.14 FS2.15 FS2.16	FOODSERVICE PLUMBING ROUGH IN PLAN FOODSERVICE ELECTRICAL ROUGH-IN PLAN FOODSERVICE ELEVATIONS FOODSERVICE ELEVATIONS		X X X				
FS1.14 FS2.11 FS2.12 FS2.13 FS2.14 FS2.15 FS2.16 FS2.17	FOODSERVICE PLUMBING ROUGH IN PLAN FOODSERVICE ELECTRICAL ROUGH-IN PLAN FOODSERVICE ELEVATIONS FOODSERVICE ELEVATIONS FOODSERVICE ELEVATIONS		X X X				
FS1.14 FS2.11 FS2.12 FS2.13 FS2.14 FS2.15 FS2.16	FOODSERVICE PLUMBING ROUGH IN PLAN FOODSERVICE ELECTRICAL ROUGH-IN PLAN FOODSERVICE ELEVATIONS FOODSERVICE ELEVATIONS		X X X				
FS1.14 FS2.11 FS2.12 FS2.13 FS2.14 FS2.15 FS2.16 FS2.17 FS3.11	FOODSERVICE PLUMBING ROUGH IN PLAN FOODSERVICE ELECTRICAL ROUGH-IN PLAN FOODSERVICE ELEVATIONS FOODSERVICE ELEVATIONS FOODSERVICE ELEVATIONS FOODSERVICE EXHAUST HOOD 24		X X X X				



PEACOCK + LEWIS Architects and Planners, LLC

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design architect Olson Kundig



ATLANTIC FIELDS -GOLF HOUSE

PERMIT SET

2645 SE BRIDGE ROAD, HOBE SOUND, FL 33455

Seal:

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DRAWING INDEX

Revisions:

No.	Description	Date
1	Bldg. Dept. Comments	12.15.2023
3	Addendum #1	03.22.2024

Comm:	Date:
22-061	11.01.2023
Orawn By:	Checked:
P+L BC	FL.

Sheet:

A0.00

ABBREVIATIONS POUND OR NUMBER GAUGE **EXISTING** NEW GALVANIZED GENERAL CONTRACTOR DIAMETER GLASS GLUE-LAMINATED GR ANCHOR BOLT GRADE **GWB** GYPSUM WALL BOARD ACC ACCESS **GYPSUM ACOUS** ACOUSTICAL ASPHALT CONCRETE PAVING HOSE BIE ACS PNL ACCESS PANEL **HOLLOW CORE** ACOUSTIAL CEILING TILE HIGH DENSITY OVERLAY HEADER AMERICANS WITH DISABILITIES HARDWARE HDW ADJ ADJUSTABLE HDWD HARDWOOD ABOVE FINISHED FLOOR HOLLOW METAL AGGR AGGREGATE HORIZ HORIZONTAL AIR INFILTRATION BARRIER HIGH POINT ALTERNATE HOUR ALUM ALUMINIUM HOUR APPROX HEIGHT HVAC HEATING/VENTILATING/AIR CONDITIONING HOT WATER ARCH ARCHITECTURAL HW AUTO HOT WATER TANK AUTOMATIC INSIDE DIAMETER BITUMINOUS BITUM INCH BLDG BUILDING INCLUDED BLKG BLOCKING INSULATION BEAM INTERIOR ВО BOTTOM OF INVERT BOT BRG **BEARING** JUNCTION BOX BSMT BASEMEN^T JOINT FILLER BUR BUILT UP ROOFING JOINT KITCHEN CB CATCH BASIN KNOCKOUT CEM CEMENT CER CERAMIC LAMINATE; LAMINATED CIP CAST-IN-PLACE LAVATORY CONTROL JOINT POUNDS LBS LINEAR FEET (FOOT) CLK CAULKING CLO CLOSET LIVE LOAD CLR **CLEAR** LOCATION CMU CONCRETE MASONRY UNIT LOW POINT CNTR LIGHT COUNTE COL CONC CONCRETI MASONRY CONN CONNECTION MATERIAL CONSTR CONSTRUCTION MAXIMUM CONT CONTINUOUS MACHINE BOLT CONTR CONTRACTOR MEDICINE CABINET CORR CORRIDOR MEDIUM DENSITY FIBERBOARD CARPET; CARPETED MDO MEDIUM DENSITY OVERLAY MECH MECHANICAL MEMBRANE COUNTERSUNK MFMB CERAMIC TILE MEZZ MEZZANINE CTR CENTER MANUFACTURER CUBIC FEET MIRROR DOUBLE MISC MISCELLANEOUS DEMO DEMOLITION MASONRY OPENING DET MTD MOUNTED DIAMETER MTL METAL DIM DIMENSION MUL MULLION DEAD LOAD DN NORTH DOWN DR NOT APPLICABLE DOOR N/A DR OPNG DOOR OPENING NIC NOT IN CONTRACT DOWNSPOUT NO DS NUMBER DSP DRY STANDPIPE NOM NOMINAL DRAIN TILE NOISE REDUCTION DW NOT TO SCALE DISHWASHER NTS DWG DRAWING EAST OC ON CENTER EACH OCC OCCUPANTS EΑ FF EXHAUST FAN OUTSIDE DIAMETER: OVERFLOW DRAIN OD OFF EJ EXPANSION JOINT OFFICE **ELEVATION** OVERHEAD ELEC ELECTRICAL ORDINARY HIGH WATER MARK OHWM ELEV **ELEVATOR** OLF OCCUPANT LOAD FACTOR ENCL **ENCLOSURE** OPNG OPENING EQ **EQUAL** OPP OPPOSITE **EQUIP EQUIPMENT** ORIENTED STRAND BOARD EST **ESTIMATE** EW **FACH WAY** PBD PARTICLE BOARD **EXIST EXISTING** PCC PRECAST CONCRETE EXPANDED; EXPANSION POUNDS PER CUBIC FOOT PCF EXP BT EXPANSION BOLT PERF PERFORATED EXPO **EXPOSED** PERP PERPENDICULAR EXT EXTERIOR PLATE PLASTIC LAMINATI FIRE ALARM PLAS PLASTER FB FLAT BAR PLWD PLYWOOD FD FLOOR DRAIN PNL FIRE EXTINGUISHER PNT POINT FEC FIRE EXTINGUISHER CABINET PAIR FINISH TO FINISH PRCST PRECAST FF EL FINISH FLOOR ELEVATION POUNDS PER CUBIC FOOT FH FIRE HYDRANT PSI POUNDS PER SQUARE INCH FHC FIRE HOSE CABINET PT PRESERVATIVE TREATED FIN PTN PARTITION FIN FLR FINISH FLOOR POLYVINYL CHLORIDE FLASH FLASHING FLR FLOOR; FLOORING RISER **FLUOR** FLUORESCENT RETURN AIR FOC FACE OF CONCRETE **RADIUS** FOF FACE OF FINISH **ROOF DRAIN** FOIC FURNISHED BY OWNER-INSTALLED BY REF REFERENCE CONTRACTOR REFR REFRIGERATOR FACE OF MASONRY REG REGISTER FOS FACE OF STUDS REINF REINFORCED FP **FIREPROOF** REM REMAINDER FPL **FIREPLACE** REQUIRED FR FRAME RESIL RESILIENT FOOT OR FEET REV REVISION(S); REVISED FTG **FOOTING** RIGHT HAND **FURR FURRING** ROOM

FUT

FW

FUTURE

FULL WIDTH

	GENERAL SYM	BOLS LEGEND
DUGH OPENING AIN WATER LEADER	1. GRID LINE REFERENCE	#
UTH LF-ADHERED FLASHING LF-ADHERED MEMBRANE LID CORE HEDULE	2. LEVEL / DATUM REFERENCE	NAME_ELEVATION
OKE DETECTOR TION ETY GLAZING OWER ET	3. EXTERIOR ELEVATION REFERENCE	Drawing Number Sheet Number
ET METAL ITHING F; SHELVING AR ON GRADE EIFICATION	4. INTERIOR ELEVATION REFERENCE	# Drawing Number # Sheet Number
ARE FOOT (FEET) ARE INCH(ES) NLESS STEEL IDARD EL RAGE JCTURAL	5. BUILDING SECTION REFERENCE	Drawing Number AX.XX Sheet Number
PENDED ETRICAL	6. WALL SECTION REFERENCE	Drawing Number AX.XX Sheet Number
AD IGUE AND GROOVE EPHONE RAZZO IPERED GLASS CK OF DF BEAM	7. DETAIL SECTION REFERENCE	X — Drawing Number — Sheet Number
OF CONCRETE; CURB OF FLOOR; FOOTING; FRAME OF MASONRY OF PARAPET; PAVEMENT OGRAPHY OF SLAB; STEEL OF WALL E STEEL RMOSTAT CAL	8. CALLOUT/DETAIL REFERENCE	X Drawing Number Sheet Number
ESS NOTED OTHERWISE 'L BASE EER TICAL	9. REVISION REFERENCE	#
ΓΙΒULE ΓΙCAL GRAIN FY IN FIELD 'L TILE	10. ROOM REFERENCE	ROOM NAME
OUT	11. ASSEMBLY REFERENCE	X#>
ER CLOSET D OW FLANGE ELANGE REAM	12. WINDOW REFERENCE	W#
FLANGE BEAM D GLASS ER HEATER ER LINE	13. DOOR REFERENCE	D001
DED ERPROOF ERPROOF MEMBRANE ER RESISTANT SCOT	14. NORTH ARROW	
SAFETY GLASS SHT ER	MATERIALS LE	GEND
DED WIRE FABRIC DED WIRE MESH	WOOD BLOCKING (SHIM)	WOOD FRAMING (CONTINUOUS)
	FINISHED WOOD	PLYWOOD
	BATT INSULATION	RIGID INSULATION
	MINERAL WOOL	FOAM INSULATION

INSULATION

GRAVEL

ALUMINUM

SCHED

SECT

SHR

SHTG

SOG

SPEC

SQ FT

SQ IN

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VEST

WDW

WLD

WPM

WSCT

WSG

WT

WTR

WWF

WR

TYP

STRUCT

BUILDING CODE / ZONING SUMMARY

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PROJECT ADDRESS: APPLICABLE CODES 2645 SE Bridge Road, Hobe Sound, FL 33445

Rural Lifestyle / Rural Density

FLORIDA BUILDING CODE: BUILDING 7TH EDITION 2020 FLORIDA BUILDING CODE: MECHANICAL 7TH EDITION 2020 FLORIDA BUILDING CODE: PLUMBING 7TH EDITION 2020 FLORIDA BUILDING CODE: ACCESSIBILITY 7TH EDITION 2020 FLORIDA BUILDING CODE: GAS 7TH EDITION 2020 FLORIDA BUILDING CODE: FIRE PREVENTION 2020 N.F.P.A., 1, UNIFORM FIRE CODE, FLORIDA EDITION - 7TH EDITION

N.F.P.A, 101, LIFE SAFETY CODE, FLORIDA EDITION - 7TH EDITION NATIONAL ELECTRICAL CODE, 2017 EDITION

AUTHORITY HAVING JURISDICTION: MARTIN COUNTY MARTIN COUNTY BUILDING:

PUD PROPOSED ZONING: COMMERCIAL PROPOSED USE:

LAND USE DESIGNATION:

ARCHITECTURAL GENERAL NOTES

- THE ARCHITECTURAL DESIGN AND DETAIL DRAWINGS ARE THE LEGAL PROPERTY OF THE ARCHITECT AND ARE INSTRUMENT OF SERVICE NOT TO BE REPRODUCED IN WHOLE OR IN PARTS WITHOUT THE EXPRESS WRITTEN CONSENT OF THE SAME.
- IT IS THE INTENT OF THE ARCHITECT THAT THE CONSTRUCTION DOCUMENTS AND SPECIFICATIONS BE IN CONFORMANCE WITH ALL REQUIREMENTS OF THE BUILDING AUTHORITIES HAVING JURISDICTION OVER THIS TYPE OF CONSTRUCTION AND OCCUPANCY.
- 3. IT IS NOT THE INTENT OF THESE PLANS TO SHOW EVERY MINOR DETAIL OF CONSTRUCTION. THE CONTRACTOR IS EXPECTED TO FURNISH AND INSTALL ALL ITEMS TO COMPLETE ALL BUILDING SYSTEMS AND PROVIDE ALL NECESSARY APPURTENANCES FOR EQUIPMENT TO BE PLACED IN PROPER WORKING ORDER AND IN ACCORDANCE WITH ALL APPLICABLE CODES, RULES, AND
- 4. ALL DETAILS AND SECTIONS SHOWN ON THE DRAWINGS ARE INTENDED TO BE TYPICAL AND SHALL BE CONSTRUCTED TO APPLY TO ANY SIMILAR SITUATION ELSEWHERE IN THE WORK EXCEPT WHERE A DIFFERENT DETAIL IS SHOWN. DETAILED AND LARGER SCALE DRAWINGS TAKE PRECEDENCE OVER SMALL SCALE DRAWINGS.
- 5. DO NOT SCALE DRAWINGS, USE DIMENSIONS, DIMENSIONS NOTED "AS REQUIRED", "VERIFY" "MATCH EXISTING" OR OTHER SIMILAR TERMS ARE TO BE VERIFIED BY THE CONTRACTOR. NOTIFY ARCHITECT OF DISCREPANCIES OBTAIN CLARIFICATION FROM ARCHITECT BEFORE PROCEEDING.
- 6. SITE TO BE FILLED TO CITY & COUNTY FLOOD CRITERIA ELEVATION N.A.V.D. OR AN ELEVATION NO LESS THAN HIGHEST APPROVED CROWN ELEVATION OF THE ROAD ABUTTING THE PROPERTY.
- ALL DESIGN LOADS ARE TO BE AT MINIMUM PER FBC 2020 & FBC-R AND AS OTHERWISE INDICATED IN THE CONTRACT.
- 8. ALL EXTERIOR WINDOWS & DOORS SHALL BE IMPACT RESISTANT.
- 9. ALL PENETRATIONS THRU ANY RATED ASSEMBLY SHALL BE PROVIDED WITH UL APPROVED PENETRATION RATED MATERIAL.
- 10. HARDWARE, BATHROOM AND LIGHTING FIXTURES, AND OTHER MISCELLANEOUS ITEMS NOT SPECIFICALLY CALLED OUT ON DRAWINGS SHALL BE SELECTED BY OWNER.
- 11. ALL MECHANICAL, PLUMBING AND ELECTRICAL SHALL COMPLY WITH THE FBC 2020 (MECH),(ELECT),(PLUMB).
- 12. ALL WORK TO BE TRUE TO LINE, PLUMB AND SQUARE AND ADEQUATELY SUPPORTED. FILL ALL VOIDS BETWEEN COMPONENTS. ALL ITEMS THAT DO NOT MEET THE ARCHITECT'S SATISFACTION AS TO GOOD TRADE PRACTICES AND QUALITY WORKMANSHIP WILL BE REPLACED AT THE
- 13. WHEN CONFLICTING INFORMATION IS FOUND IN THE DRAWINGS AND/OR SPECIFICATIONS. THE CONTRACTOR SHALL CONTACT THE ARCHITECT FOR CLARIFICATION PRIOR TO CONSTRUCTION.
- 14. THE CONTRACTOR IS TO ACQUIRE ALL REQUIRED PERMITS FOR DEMOLITION (IF APPLICABLE),
- CONSTRUCTION, AND OCCUPANCY OF THE PROJECT. 15. THE CONTRACTOR SHALL SUBMIT A SCHEDULE FOR DEMOLITION (IF APPLICABLE) AND
- CONSTRUCTION PROCEDURES AND OPERATIONAL SEQUENCE FOR REVIEW AND ACCEPTANCE BY 16. CONTRACTOR IS TO COORDINATE AND SCHEDULE THE WORK OF ALL TRADES TO INSURE THE
- WORK IS COMPLETED IN A TIMELY MANNER, COMPLYING WITH OWNER/CONTRACTOR AGREEMENT.
- 17. CONTRACTOR SHALL SUBMIT PRODUCT APPROVAL DATA FOR ALL PRODUCTS AND MATERIALS AS REQUIRED BY CODE AND SPECIFIC MUNICIPALITY THE PROJECT IS LOCATED IN.
- 18. CONTRACTOR SHALL SUBMIT, WITHIN 15 DAYS FROM OWNER/CONTRACTOR CONTRACT, A SHOP DRAWING AND SUBMITTAL SCHEDULE FOR ARCHITECT AND OWNER APPROVAL
- 19. CONTRACTOR SUBMITTALS MUST BE SUBMITTED VIA E-MAIL IN ELECTRONIC FORMAT FOR ARCHITECT/ENGINEER/OWNER RECORDS, PLUS ANY ADDITIONAL SETS REQUIRED FOR PERMITTING AND CONTRACTORS USE ALL SUBMITTALS MUST BE COMPLETE (NO PARTIAL SUBMITTALS WILL BE RECEIVED). ALL SHOP DRAWINGS MUST BE REVIEWED AND APPROVED BY THE CONTRACTOR BEFORE SUBMITTING TO THE ARCHITECT/ENGINEER AND OWNER.
- 20. CONTRACTOR SHALL SUBMIT TO ARCHITECT SIGNED & SEALED TRUSS SHOP DRAWINGS FOR APPROVAL PRIOR TO FABRICATION.
- 21. CONTRACTOR SHALL PROVIDE THE ARCHITECT AND OWNER WITH RED-LINED AS-BUILT DRAWINGS FOR ANY AND ALL FIELD CHANGES AND/OR ADDITIONS TO THE WORK INCLUDED IN THE DRAWINGS AS PART OF THE PROJET CLOSEOUT DOCUMENTS.
- 22. ALL WORK DONE UNDER THE SUPERVISION OF THE CONTRACTOR SHALL BE IN A NEAT AND WORKMAN-LIKE MANNER AND IN ACCORDANCE WITH ALL GOVERNING AGENCIES, APPLICABLE CODES, RULES AND REGULATIONS HAVING JURISDICTION.
- 23. CONTRACTOR SHOULD MAINTAIN THE SITE SAFE AND CLEAR OF DEBRIS. ALL CONSTRUCTION DEBRIS IS TO BE REMOVED FROM THE WORK AREAS DAILY AND FROM THE SITE AT PROPER
- 24. THE CONTRACTOR SHALL PROVIDE AN ON-SITE DUMPSTER IN A LOCATION APPROVED BY THE OWNER FOR THE DISPOSAL OF REMOVED MATERIAL. THE DUMPSTER SHALL BE EMPTIED AT APPROPRIATE INTERVALS TO PREVENT OVERFLOW AND UNSIGHTLY CONDITIONS.
- 25. CONTRACTOR SHALL BE RESPONSIBLE FOR THE PROTECTION OF HIS WORK, INCLUDING BUT NOT LIMITED TO VANDALISM, THEFT, ETC.
- 26. CONTRACTOR ASSUMES FULL RESPONSIBILITY FOR PROTECTION AND SAFEKEEPING OF GOODS BEING INSTALLED UNDER THIS CONTRACT, AS WELL AS FOR COMPLIANCE WITH ALL APPLICABLE
- 27. THE ARCHITECT IS NOT RESPONSIBLE FOR CONSTRUCTION MEANS, METHODS, SEQUENCES, PROCEDURES OR FOR PRECAUTIONS AND PROGRAMS RELATED TO THE PROJECT'S
- 28. THE CONTRACTOR IS TO VISIT THE SITE AND VERIFY ALL EXISTING BUILDING AND SITE CONDITIONS AND DIMENSIONS. SHOULD ANY DISCREPANCIES BE ENCOUNTERED BETWEEN THE DRAWINGS AND THE FIELD CONDITIONS, THE ARCHITECT/ENGINEER SHOULD BE NOTIFIED IN WRITING 7 DAYS PRIOR TO SUBMITTING HIS BID. ANY DISCREPANCIES SHALL BE RESOLVED BY THE ARCHITECT/ENGINEER PRIOR TO PROCEEDING WITH THE WORK.
- 29. CONTRACTOR IS TO PROVIDE ALL THE SUPPLEMENTARY MATERIALS REQUIRED TO PROPERLY INSTALL, SUPPORT, BRACE AND SHORE ALL BUILDING COMPONENTS WITHIN THE SCOPE OF THE
- 30. CONTRACTOR SHALL SUPPLY, LOCATE AND BUILD INTO THE WORK ALL INSERTS, ANCHORS, ANGLES. PLATES, OPENINGS, SLEEVES, HANGERS, SLAB DEPRESSIONS, AND PITCHES AS MAY BE REQUIRED TO ATTACH AND ACCOMMODATE OTHER WORK.
- 31. CONTRACTOR SHALL BE RESPONSIBLE FOR COMPLIANCE WITH SPECIFIC STANDARDS AND REQUIREMENTS BY CORRESPONDING TESTING AGENCIES ON ASSEMBLIES CALLED OUT IN DRAWINGS & SPECIFICATIONS.
- 32. CONTRACTOR SHALL EMPLOY AND PAY FOR SERVICES OF AN INDEPENDENT, QUALIFIED TESTING LABORATORY TO PERFORM SOIL COMPACTION TEST AS WELL AS COMPREHENSIVE STRENGTH TEST IN CONCRETE SAMPLINGS, AS PER ASTM STANDARDS.
- 33. CONTRACTOR SHALL PROVIDE MOCKUP FOR EXTERIOR AND INTERIOR FINISHES AND COLOR SELECTIONS FOR ARCHITECT AND OWNER'S APPROVAL
- 34. "ALIGN" MEANS ALIGN FINISH MATERIALS OF ELEMENTS INDICATED.
- 35. FLOOR ELEVATIONS INDICATED ARE TO TOP OF CONCRETE SLAB, UNLESS NOTED OTHERWISE.
- 36. SHEET METAL DETAIL REFERENCES ARE TO SMACNA PLATES/FIGURES, 5TH EDITION, 1993. CORRESPONDING CONDITIONS FROM CURRENT SMACNA EDITION ARE ACCEPTABLE.

VICINITY MAP



LOCATION MAP



COMPLETENESS OF BID

- . THE CONTRACTOR IS TO ASSUME THE CONTRACT IS COMPLETE AS TO ALL NECESSARY PARTS AND SHALL BID ACCORDINGLY. THE CONTRACTOR SHALL SUPPLY AND INSTALL ALL NECESSARY DEVICES AND EQUIPMENT TO ENSURE A SAFE AND WORKABLE SYSTEM, OMISSIONS FROM THE PLANS AND SPECIFICATIONS OF ANY FOUIPMENT DEVICE FTC. REQUIRED BY APPLICABLE CODES AND STANDARDS. SHALL NOT RELIEVE THE CONTRACTOR OF ANY RESPONSIBILITY TO FURNISH AND INSTALL SAME AT NO ADDITIONAL COST TO THE OWNER, SHOULD ANY OMISSION BE DISCOVERED IN THE PLANS, IT MUST BE BROUGHT TO THE ATTENTION OF THE OWNER AND ARCHITECT IN A TIMELY MANNER PRIOR TO THE START OF ANY WORK. SUCH MODIFICATION SHALLBE MADE BY A LETTER DESCRIBING FULLY SUCH OMISSION.
- . ALL WORK, WHETHER SHOWN OR IMPLIED, UNLESS SPECIFICALLY QUESTIONED, SHALL BE CONSIDERED FULLY UNDERSTOOD IN ALL RESPECTS BY THE GENERAL CONTRACTOR, AND THEY WILL BE RESPONSIBLE FOR ANY MISINTERPRETATIONS OR CONSEQUENCES THEREOF FOR ALL
- 3. THE DRAWINGS AND SPECIFICATIONS ARE DESIGN DRAWINGS AND GENERALLY ARE DIAGRAMMATIC. THEY DO NOT SHOW EVERY CONDITION OR COMPONENT WHICH MAY BE REQUIRED IN THE CONTRACT WORK FOR INSTALLATION IN THE SPACE ALLOTTED. THE CONTRACTOR SHALL FOLLOW THE DRAWINGS AS CLOSELY AS PRACTICAL AND HE SHALL INSTALL ADDITIONAL MATERIALS AND SYSTEMS BASED UPON MEASUREMENTS TAKEN AT THE BUILDING AS MAY BE REQUIRED FOR INSTALLATION OF THE WORK. CHANGES FROM THESE DRAWINGS REQUIRED TO MAKE THIS WORK CONFORM TO THE BUILDING CONSTRUCTION WORK OF OTHER TRADES SHALL BE MADE BY THIS CONTRACTOR WITHOUT ADDITIONAL COST TO THE OWNER, BUT ONLY WITH THE PRIOR APPROVAL OF THE ARCHITECT/ENGINEER, ALL MAJOR CHANGES SHALL BE SHOWN ON SHOP DRAWINGS TO BE SUBMITTED BEFORE THE CHANGES
- . THE CONTRACTOR SHALL EXAMINE ALL DRAWINGS AND ALL SECTIONS OF THE SPECIFICATIONS AND SHALL BE RESPONSIBLE FOR ASCERTAINING TO WHAT EXTENT OTHER DRAWINGS AND SECTIONS AFFECT THE WORK. EACH SUBTRADE WILL BE RESPONSIBLE FOR REVIEWING THE ENTIRE SET OF DRAWINGS AND NOTING THEIR WORK AS APPLICABLE. ALL WORK INDICATED OR INFERRED ON THE DRAWINGS AND/OR SPECIFICATIONS, WILL BE DEEMED AND INCLUDED IN ALL
- 5. NO MATERIAL SUBSTITUTIONS SHALL BE MADE. THE ARCHITECT WILL CONSIDER MATERIAL CHANGE REQUESTS ON AN INDIVIDUAL BASIS. CONTRACTOR MUST SUBMIT SAMPLES AND CUT SHEETS, WITH SPECIFICATIONS, FOR WRITTEN APPROVAL BY THE ARCHITECT PRIOR TO THE START OF ANY WORK
- i. IN CASE OF DISAGREEMENT BETWEEN DRAWINGS AND SPECIFICATIONS. WITHIN EITHER DOCUMENT ITSELF, BETTER QUALITY OR GREATER QUANTITY OF WORK WILL BE BASIS OF

NOTICE TO BIDDERS

REFER TO CONSTRUCTION DOCUMENTS BY OTHERS FOR THE FOLLOWING WORK WHICH IS NOT PART OF THE PEACOCK + LEWIS CONSTRUCTION DOCUMENT PACKAGE BUT IS PART OF THE OVERALL

- LANDSCAPE/IRRIGATION DESIGN CIVIL DESIGN
- LAND PLANNING ACOUSTICAL DESIGN
- INTERIOR DESIGN
- LOW VOLTAGE /AUDIO-VISUAL 9. FOOD SERVICE DESIGN

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LAND PLANNER: LUCIDO AND ASSOCIATES

701 SE OCEAN BLVD STUART, FL 34994

PHONE: (772) 220-2100 CONTACT: SAM SALEMA EMAIL: SSALEMA@LUCIDODESIGN.COM

GOLF COURSE DESIGN: FAZIO GOLF COURSE DESIGNERS, INC.

17755 SE FEDERAL HIGHWAY,

CIVIL ENGINEER / SURVEY:

TEQUESTA, FL 34996

590 PEACOCK BLVD., PORT ST. LUCIE, FL 34986

TRAFFIC ENGINEER:

O'ROURKE ENGINNERING & SURVEYING, INC. 22 SE SEMINOLE STREET

VELCON ENGINEERING & SURVEYING, INC

STUART, FL 34994 **ENVIRONMENTAL**

EW CONSULTANTS, INC.

1000 SE MONTERY COMMONS BLVD., SUITE 208, STUART, FL 34996

MEP ENGINEER: OCI ASSOCIATES, INC

2 HARVARD CIR, SUITE 100,

WEST PALM BEACH, FL 33409 AV CONSULTANT

300 4TH STREET,

KCL ENGINEERING

WEST DES MOINES, IA 50265 PHONE:(515) 724-7938

CONTACT: CHRIS DAVIS EMAIL: CDAVIS@KCLENGINEERING.COM

STRUCTURAL ENGINEER: ONM&J STRUCTURAL ENGINEER

1655 PALM BEACH LAKES BLVD., SUITE 204, WEST PALM BEACH, FL 33401

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ATLANTIC FIELDS **GOLF HOUSE**

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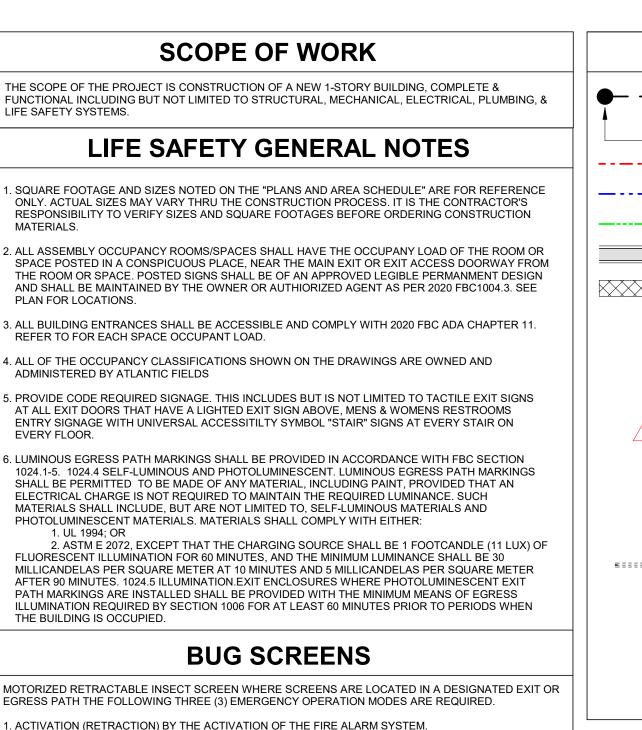
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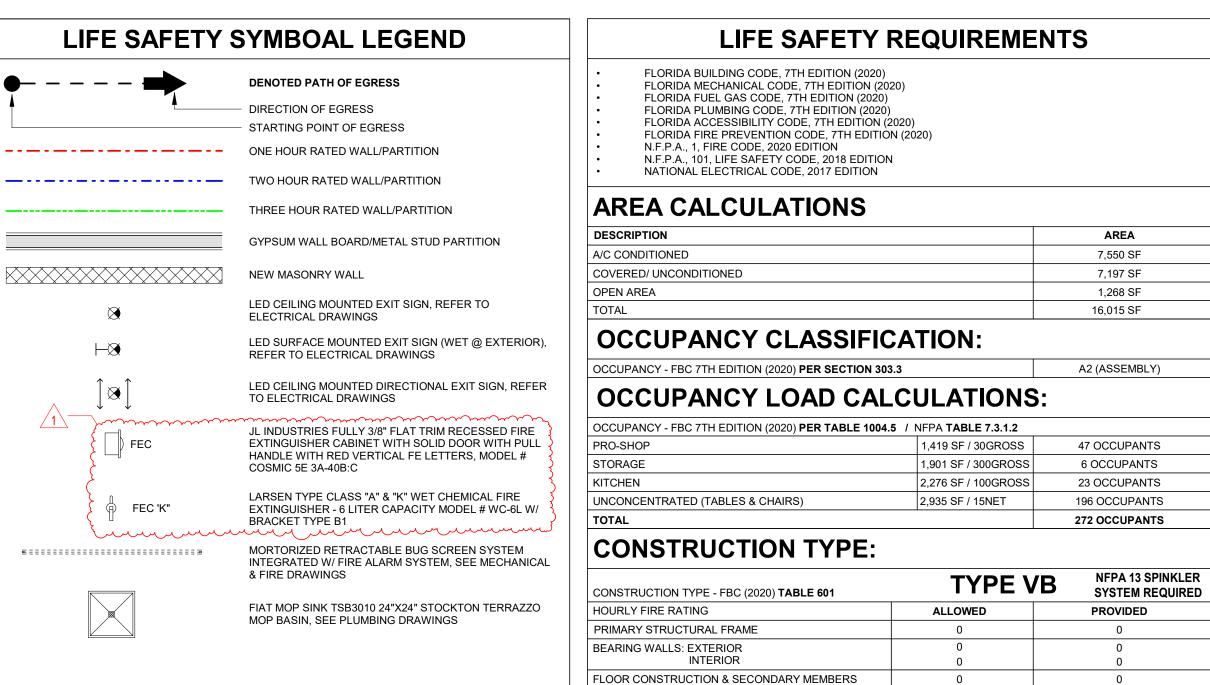
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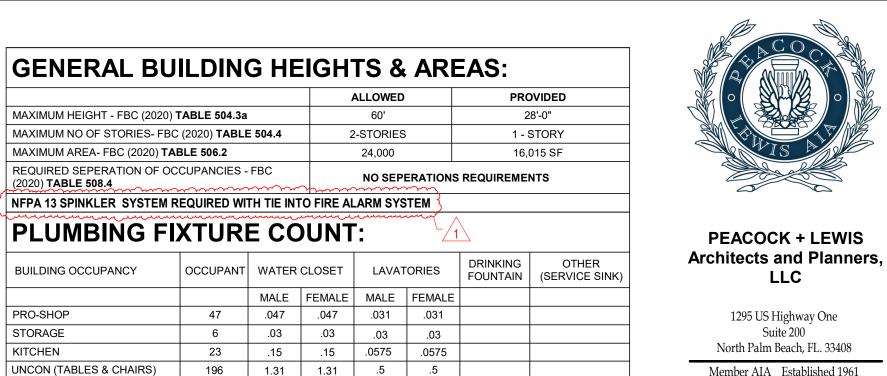
2. ACTIVATION (RETRACTION) IN THE EVENT OF LOSS OF POWER BY AN EMERGENCY POWER SOURCE

SUCH AS BATTERY BACKUP OR EMERGENCY GENERATOR



ROOF CONSTRUCTION & SECONDARY MEMBERS

DEFFERRED SUBMITTAL



PRO-SHOP STORAGE KITCHEN ASSEMBLY

REQ'D PROV REQ'D PROV REQ'D PROV REQ'D PROV

14" | 176" | 2" | 176" | 7" | 176" | 59" | 176"

REQ'D | PROV | REQ'D | PROV | REQ'D | PROV | REQ'D | PROV

REQ'D PROV REQ'D PROV REQ'D PROV REQ'D PROV

REQ'D | PROV | REQ'D | PROV | REQ'D | PROV | REQ'D | PROV

44" 176" 44" 176" 44" 176" 44" 176"

REQ'D PROV REQ'D PROV REQ'D PROV REQ'D PROV

75' N/A 100' 71' 75' 57' 75' 58'

250' | 65' | 400' | 93' | 250' | 90' | 250' | 107'

REQ'D PROV REQ'D PROV REQ'D PROV REQ'D PROV

32" | 48" | 32" | 48" | 32" | 36" | 32" | 36"

10" | 48" | 1" | 48" | 5" | 36" | 40" | 36'

(2020) TABLE 508.4

BUILDING OCCUPANCY

UNCON (TABLES & CHAIRS)

TOTAL REQUIRED - FBC PLUMBING (2020)

MEANS OF EGRESS:

STAIRWAYS - FBC (2020) PER SECTION 1005.3.1

OTHER EGRESS COMPONENTS - FBC (2020) PER

SIZE OF DOOR - FBC (2020) PER SECTION 1010.1.1

STAIR WIDTH & CAPACITY - FBC (2020) PER SECTION

MAX COMMON PATH OF TRAVEL - FBC (2020) PER

MAX CORRIDOR WIDTH - FBC (2020) PER TABLE

*410.4 SUBSTITUTION: WHERE RESTAURANTS PROVIDE DRINKING WATER IN A CONTAINER FREE OF CHARGE.

MAX TRAVEL DISTANCE - FBC (2020) PER TABLE 1017.2 | REQ'D | PROV | REQ'D | PROV | REQ'D | PROV | REQ'D | PROV |

DRINKING FOUNTAINS SHALL NOT BE REQUIRED IN THOSE RESTAURANTS.

PRO-SHOP

STORAGE

KITCHEN

TABLE 403.1

TOTAL PROVIDED

SECTION 1005.3.2

TABLE 1006.2.1

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orohibited. LIFE SAFETY PLAN & CODE ANALYSIS

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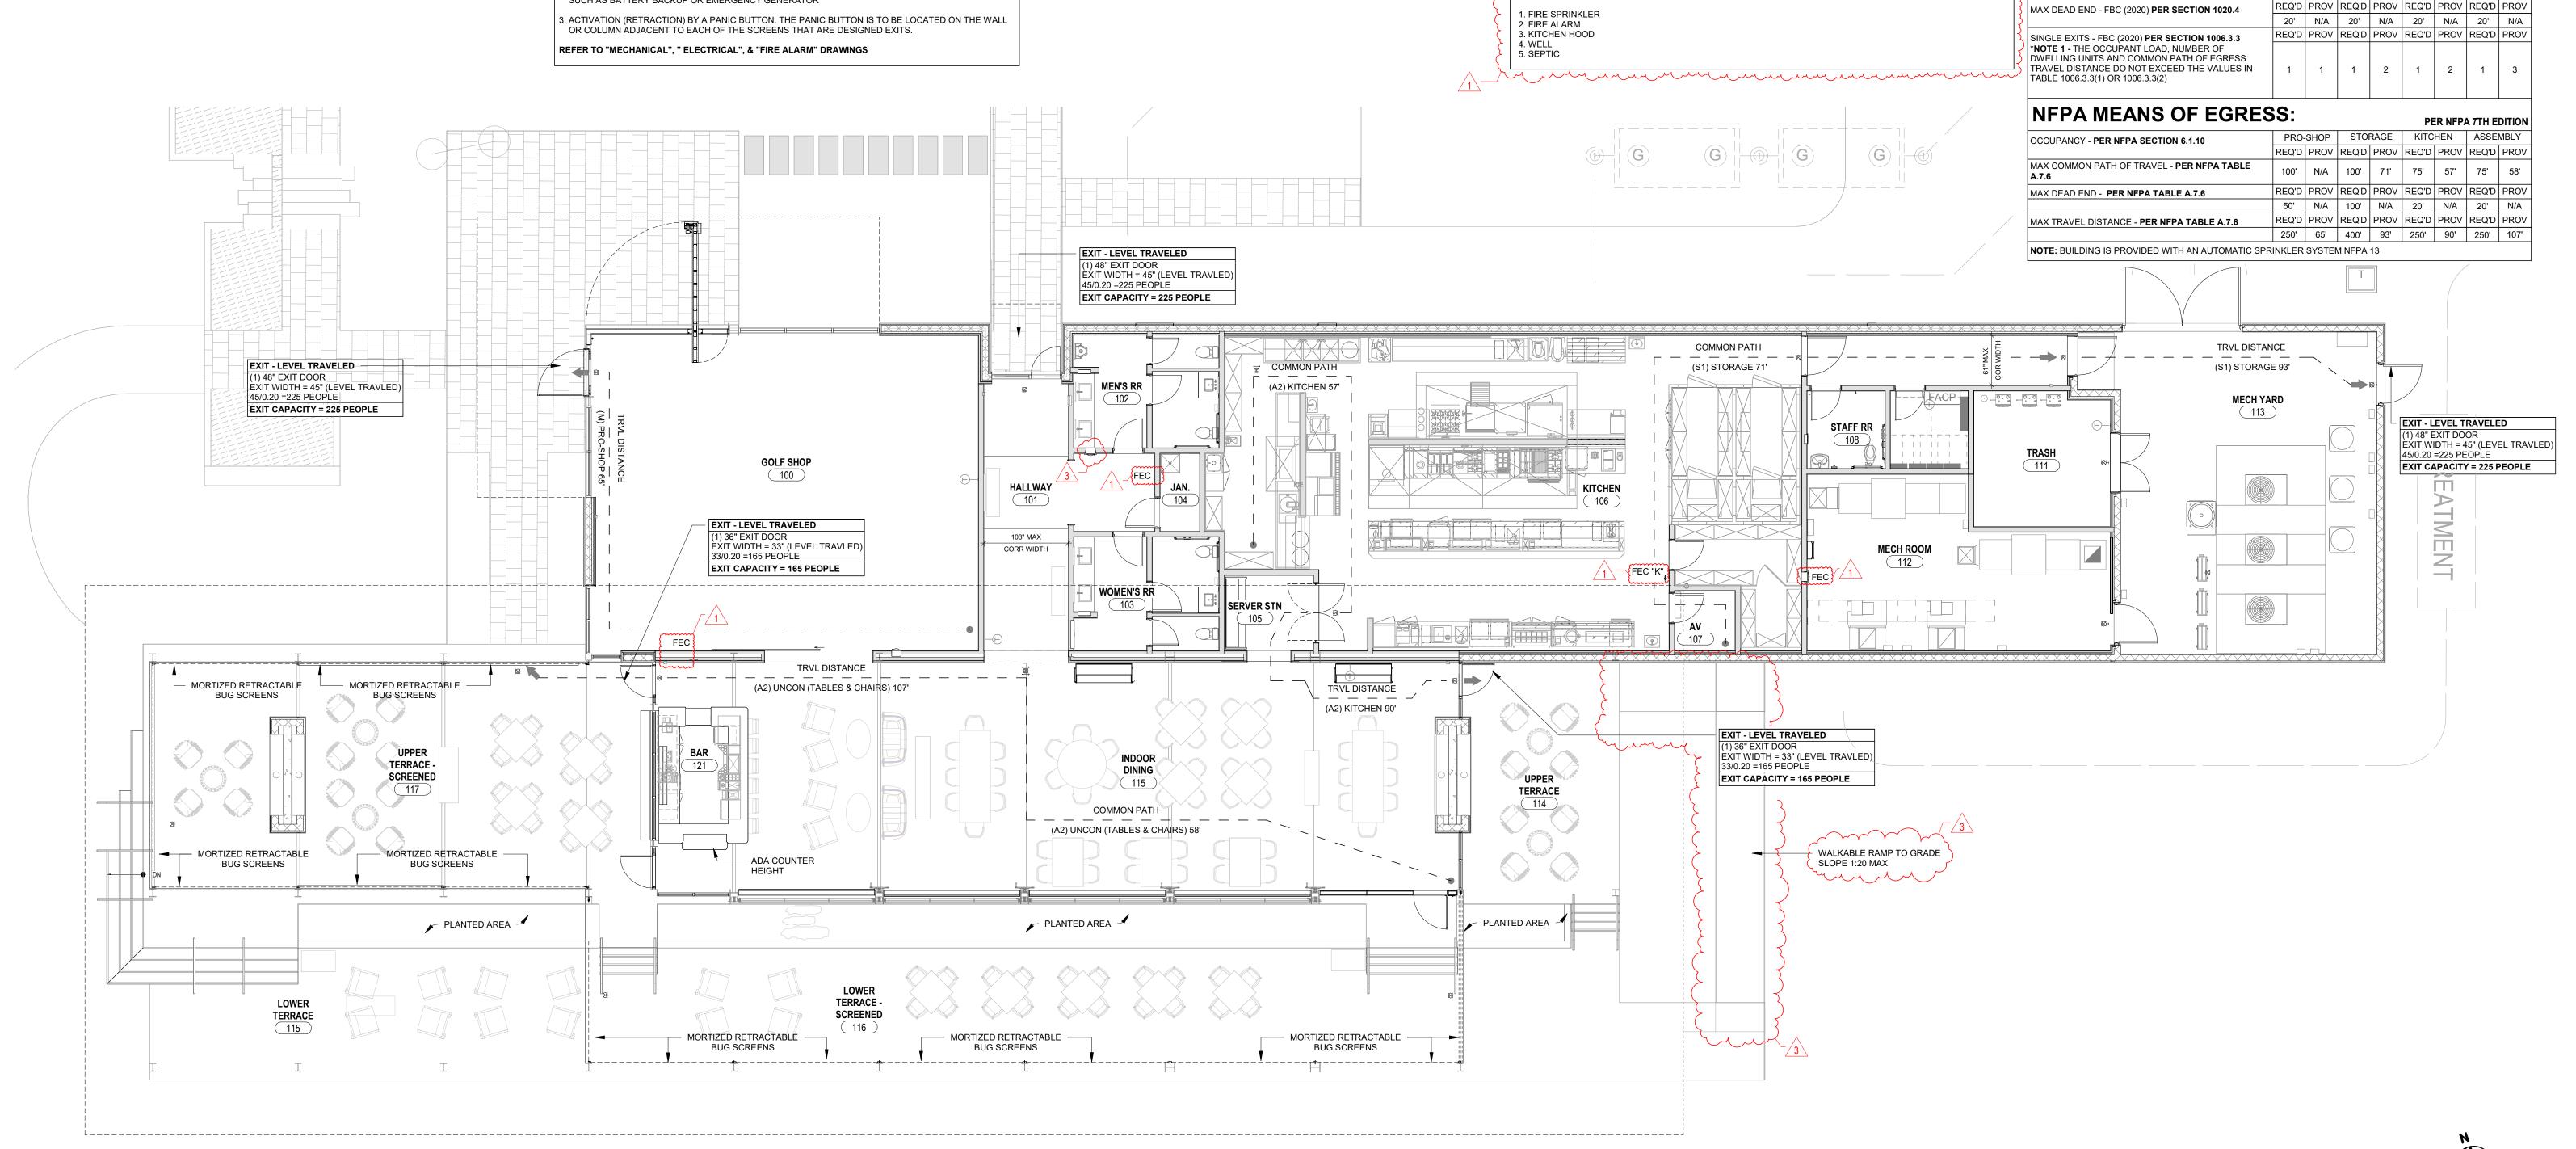
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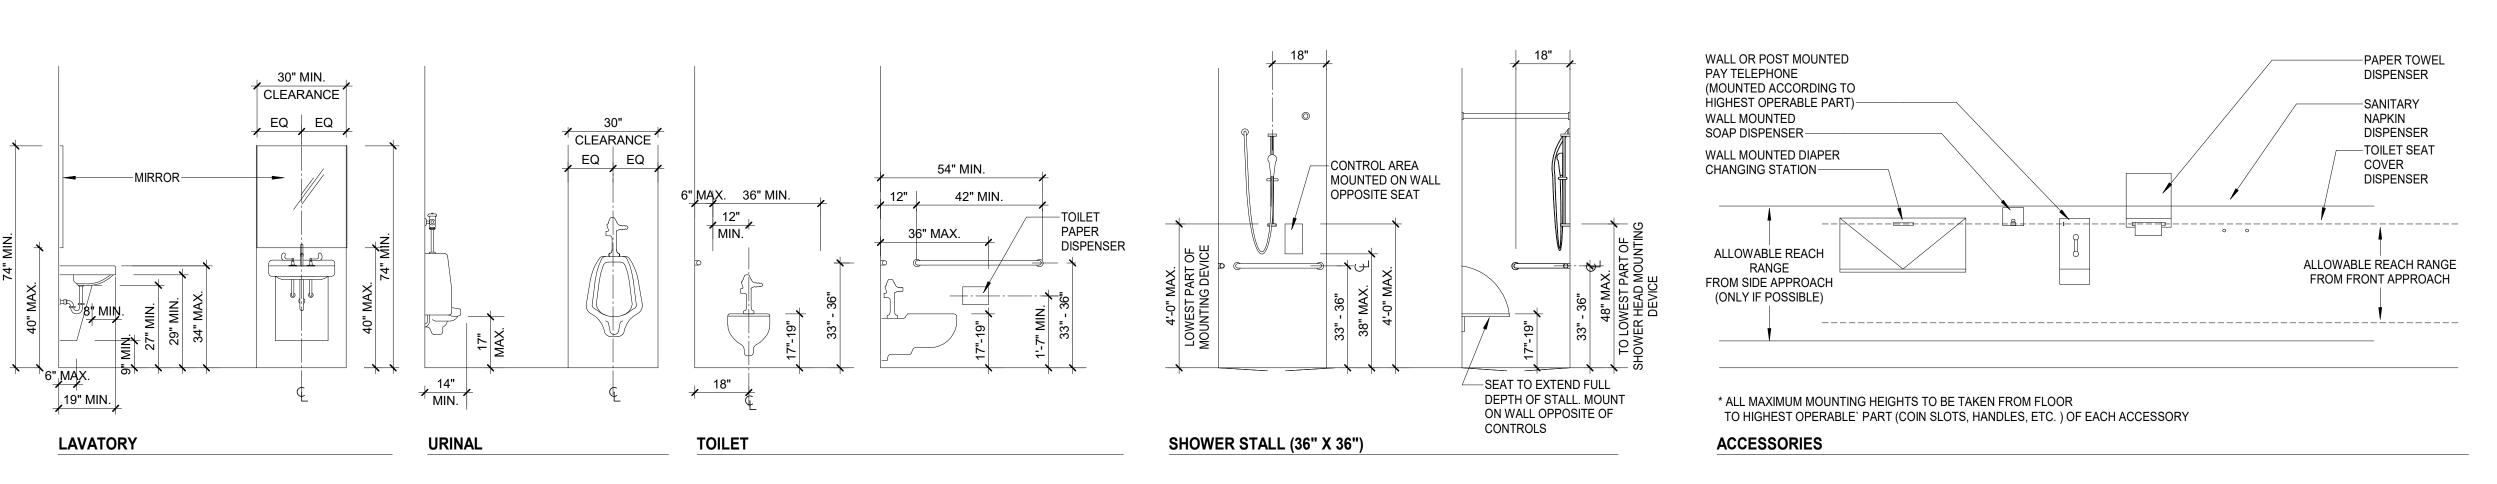
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3	Addendum #	1	03.22.2024
Coi		Date	
C01	Comm:		:

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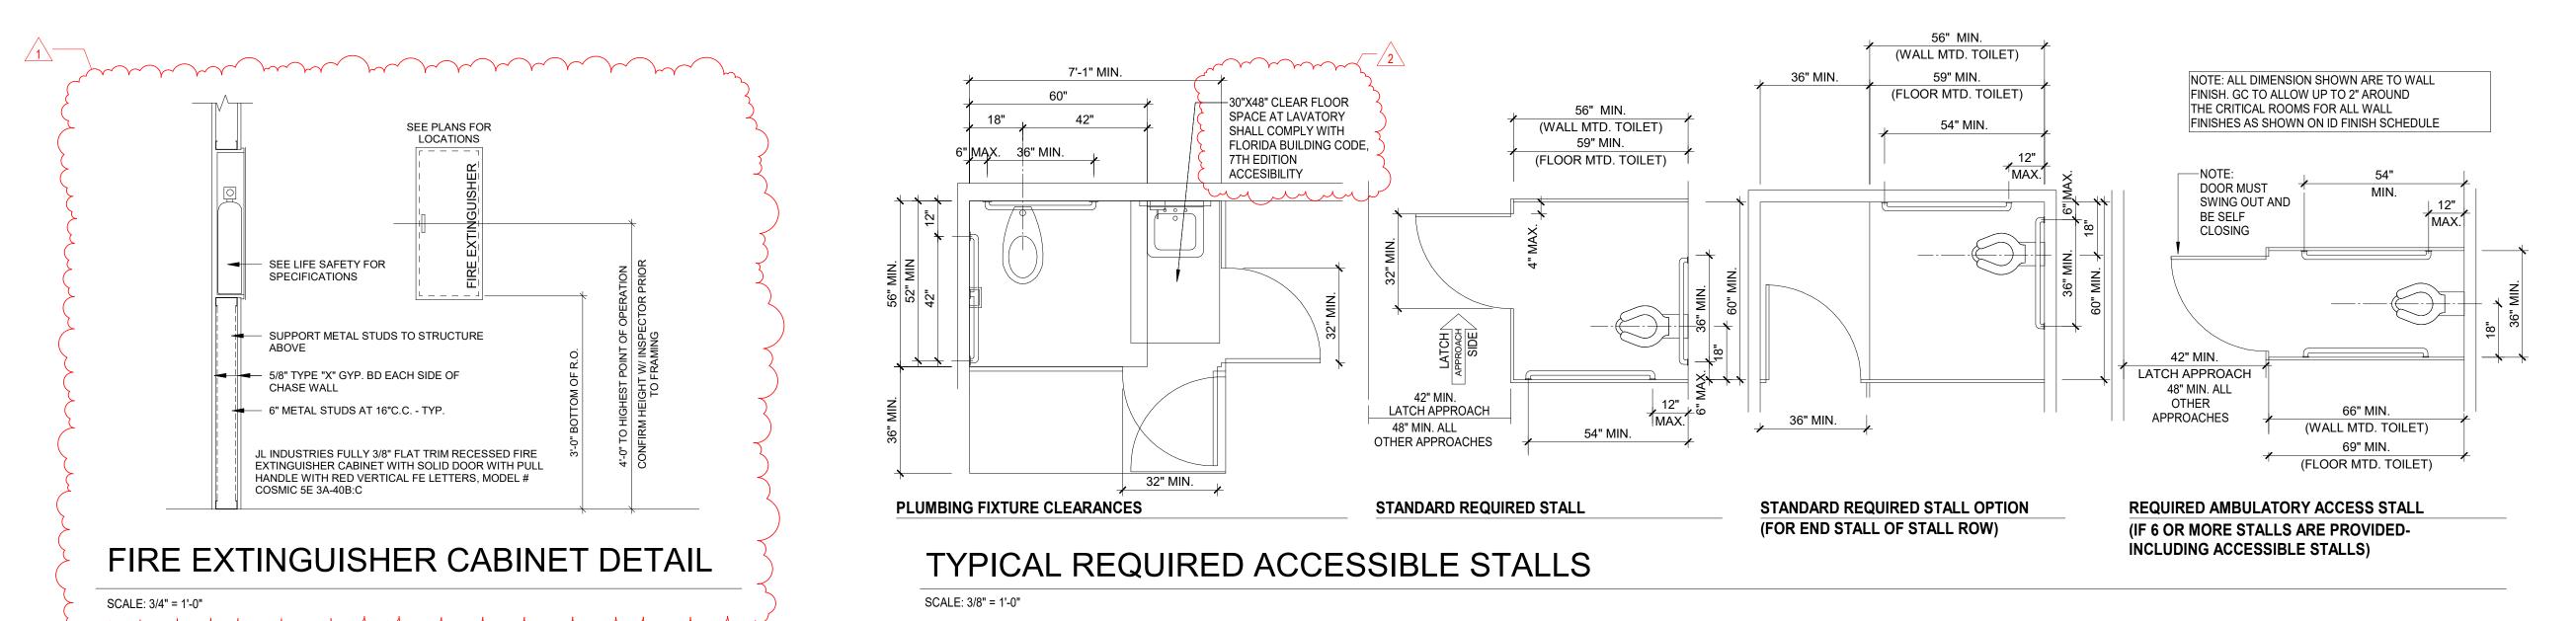
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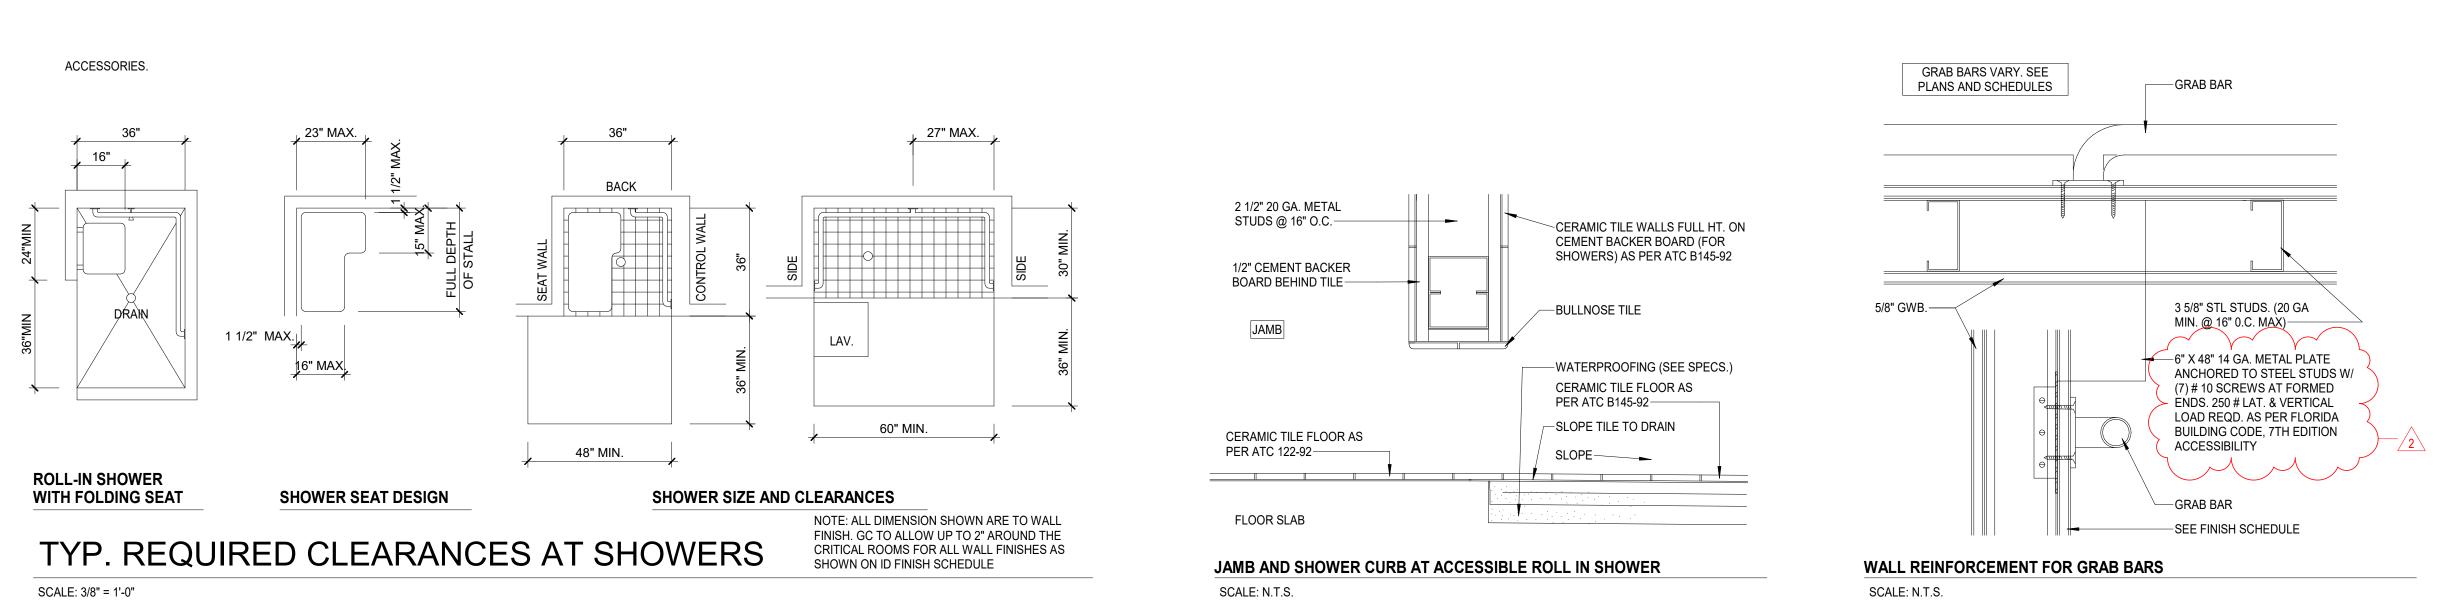




TYP. MOUNTING HEIGHTS - RESTROOMS

SCALE: 3/8" = 1'-0"





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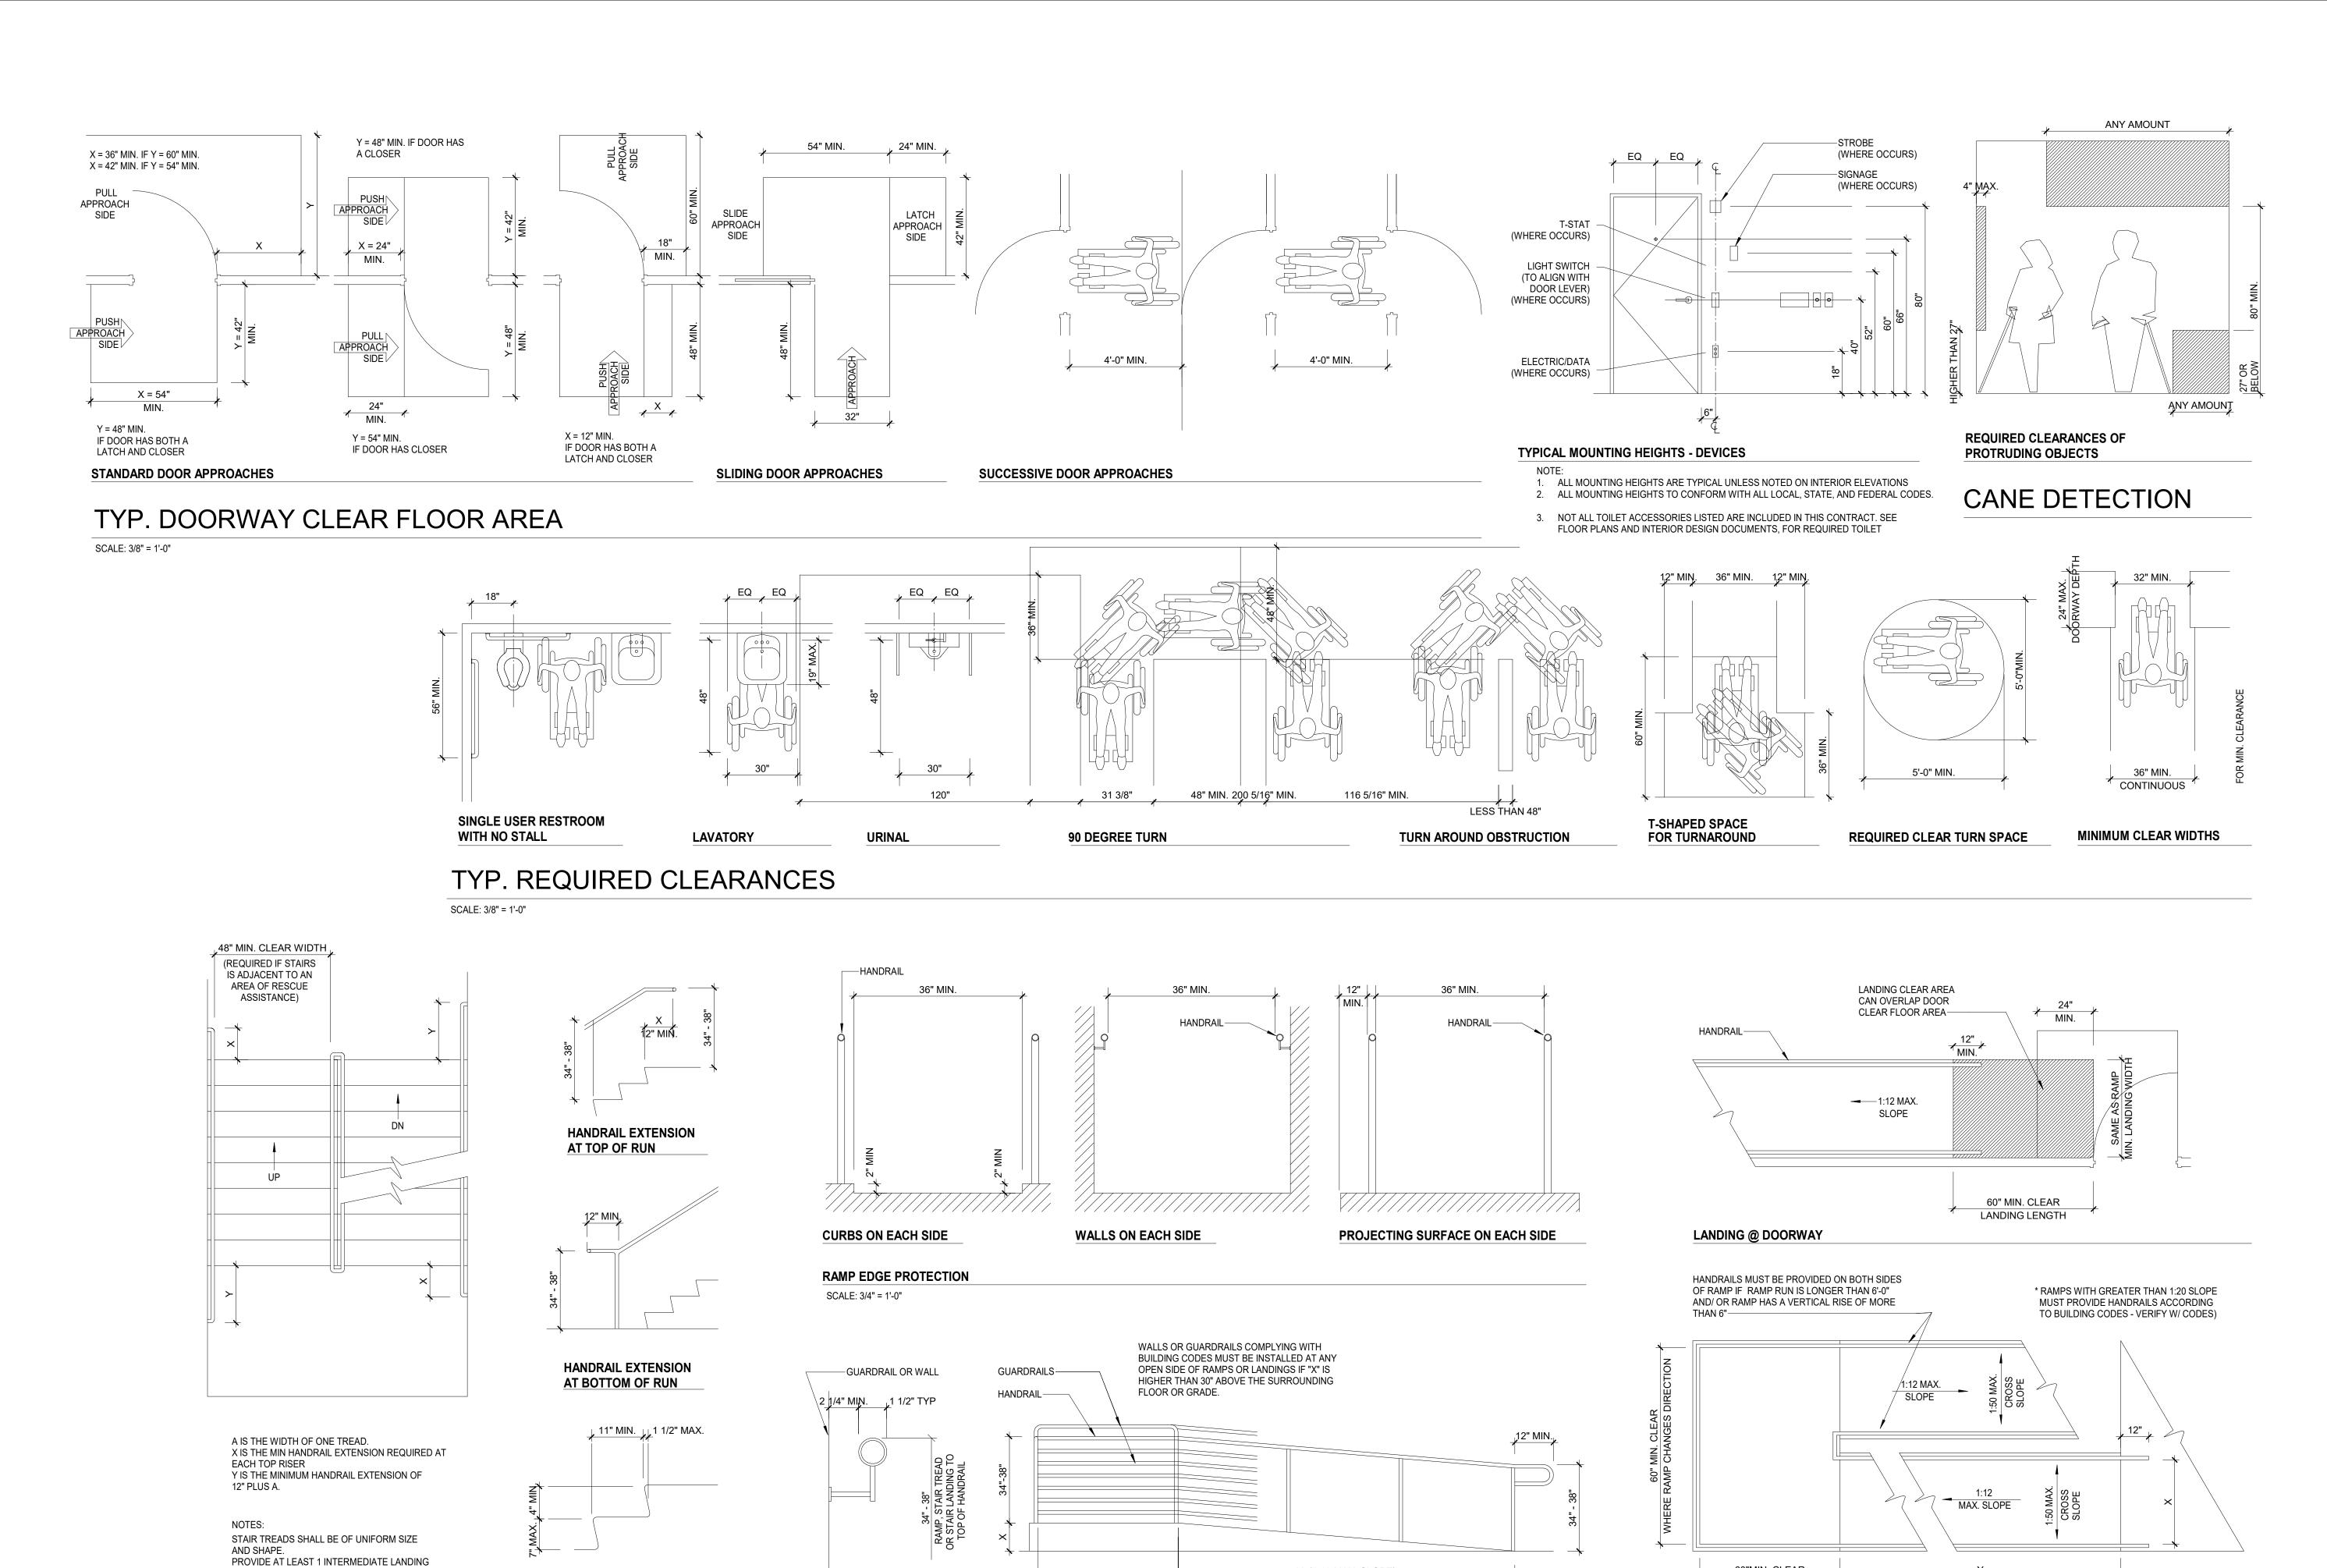
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60" CLEAR MIN.

"X" = 30" MAX. PER

ANY ONE RAMP RUN

HANDRAIL AT RAMP

HANDRAIL MOUNTING

REQUIREMENTS

SCALE: 3" = 1'-0"

Y (1:12 MAX. SLOPE)

IF Y= MORE THAN 72", HANDRAILS MUST BE

BE PROVIDED ON EACH SIDE OF RAMP.

STAIR AND RAMP ACCESSIBILITY REQUIREMENTS

STAIR TREAD AND RISER

REQUIREMENTS

PER EVERY 12' OF VERTICAL STAIRWAY RISE.

HANDRAIL ENDS TO BE EITHER ROUNDED

OR RETURNED SMOOTHLY TO WALL,

FLOOR OR POST.



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X = 36" MIN. CLEAR IF

Y = 30'-0" OR LESS OR

X = 44" MIN. CLEAR IF

Y = MORE THAN 30'-0"

* MAX. RISE PER ANY

RUN LENGTH IS

30" VERTICALLY

60"MIN. CLEAR

LANDING

LANDING @ SWITCHBACK RAMP

Sheet:

A0.20

WINDOW TYPES 1. ALL EXTERIOR DOORS ARE TO BE WIND LOAD & IMPACT RATED AS INDICATED IN THE SCHEDULE & ALL INTERIOR GLASS TO **GENERAL WINDOW NOTES** 2. CONTRACTOR TO VERIFY MASONRY OPENINGS WITH MANUFACTURER OF ACTUAL DOORS PURCHASED FOR THE PROJECT. A. PROVIDE BUCKING MATERIAL BY GENERAL CONTRACTOR 3. SEE SCHEDULE FOR DOOR WIDTH & HEIGHTS, TYP. munum punumum R.O. EQ EQ EQ EQ G. PROVIDE STRUCTURAL MULLIONS FOR LARGE OPENINGS. 7'-6" 14'-2" R.O. R.O. SEE DOOR SCHEDULE EQ HAND FUNCTION AND FINISH OF HARDWARE. SF-2 SF-3 SF-4 SF-5 TYPE: SF-1 TYPE: SF-2 TYPE: SF-3 TYPE: SF-4 TYPE: SF-5 3. SOLARBAN 70 EXTERIOR IMPACT RATED ALUMINUM STOREFRONT SYSTEM STOREFRONT SYSTEM STOREFRONT SYSTEM STOREFRONT SYSTEM STOREFRONT SYSTEM ES WINDOW SERIES ES-5250 FL #27598 R3 14'-0" R.O. R.O. 4'-8 1/4" 3'-8 1/2" 3'-8 1/2" EQ EQ 14'-8" SEE DOOR SCHEDULE R.O. R.O. R.O. EQ 3'-11 1/4" SEE DOOR SCHEDULE SF-6 SF-7 SF-11 SF-12 SF-9 SF-8 **TYPE: SF-12** TYPE: SF-7 **TYPE: SF-10 TYPE: SF-11** TYPE: SF-6 TYPE: SF-8 TYPE: SF-9 EXTERIOR IMPACT RATED ALUMINUM STOREFRONT SYSTEM ES WINDOW SERIES ES-5250 FL #27598 R3 4'-5 1/2" R.O. EQ 9'-6 1/2" R.O. 13'-6" EQ EQ R.O. EQ 100'-0" SF-16 SF-17 SF-14 SF-13 TYPE: SF-13 TYPE: SF-14 TYPE: SF-15 TYPE: SF-16 **TYPE: SF-17** EXTERIOR IMPACT RATED ALUMINUM STOREFRONT STOREFRONT SYSTEM STOREFRONT SYSTEM STOREFRONT SYSTEM SLIDING SERVICE WINDOW SYSTEM STOREFRONT SYSTEM ES WINDOW SERIES ES-2020 ES WINDOW SERIES ES-5250 ES WINDOW SERIES ES-5250 ES WINDOW SERIES ES-5250 ES WINDOW SERIES ES-5250 FL #27598 R3 FL #27598 R3 FL # 22267-R9

WINDOW NOTES

B. PROVIDE JAMB EXTENSIONS WHERE REQUIRED.

C. ALL WINDOW SIZES SHOWN ARE NOMINAL CONTRACTOR SHALL FIELD VERIFY ALL ROUGH OPENINGS PRIOR TO ORDERING WINDOWS.

D. PROVIDE IMPACT RESISTANT EXTERIOR DOOR AND WINDOW ASSEMBLIES AT ALL OPENINGS THAT COMPLY WITH STATE OF FLORIDA PRODUCT APPROVAL OR MIAMI DADE NOA (AS REQUIRED BY AHJ). MANUFACTURER SHALL PROVIDE CURRENT VALID MIAMI DADE COUNTY NOA OR FLÓRIDA PRODUCT APPROVAL FOR ENTIRE SYSTEM ASSEMBLY MEETING OR EXCEEDING DESIGN WIND LOAD REQUIREMENTS.

E. CONTRACTOR SHALL PROVIDE WINDOW SHOP DRAWINGS TO ARCHITECT FOR APPROVAL PRIOR TO PROCEEDING WITH WORK.

F. CONTRACTOR SHALL PROVIDE DOOR/WINDOW HARDWARE SCHEDULE TO ARCHITECT/OWNER FOR APPROVAL PRIOR TO PROCEEDING WITH WORK.

H. ALL HARDWARE SHALL COMPLY WITH FBC - ACCESSIBILITY CODE 2020 7TH EDITION. SUBMIT A FINAL HARDWARE SCHEDULE FOR ARCHITECTS REVIEW COORDINATE HARDWARE WITH DOORS, FRAMES AND RELATED WORK TO ENSURE PROPER SIZE,

I. REFER TO STRUCTURAL DRAWINGS FOR REQUIRED WIND-LOAD DESIGN CRITERIA.

LOUVER NOTES

1. ALL LOUVERS TO BE SIZED IN ACCORDANCE WITH THE MECHANICAL DRAWINGS FOR REQUIRED FREE AREA.

2. PROVIDE IMPACT RESISTANT EXTERIOR LOUVERS ASSEMBLIES PER MECHANICAL DRAWINGS THAT COMPLY WITH STATE OF FLORIDA PRODUCT APPROVAL OR MIAMI DADE NOA (AS REQUIRED BY THE AHJ). MANUFACTURER SHALL PROVIDE CURRENT VALID MIAMI DADE NOA OR FLORIDA PRODUCT APPROVAL FOR ENTIRE SYSTEM MEETING OR EXCEEDING DESIGN WIND LOAD REQUIREMENTS.

3. REFER TO EXTERIOR ELEVATIONS FOR EXACT LOCATIONS OF LOUVERS.

GLAZING NOTES

2. U-VALUE 0.9 OR LOWER



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ATLANTIC FIELDS -**GOLF HOUSE**

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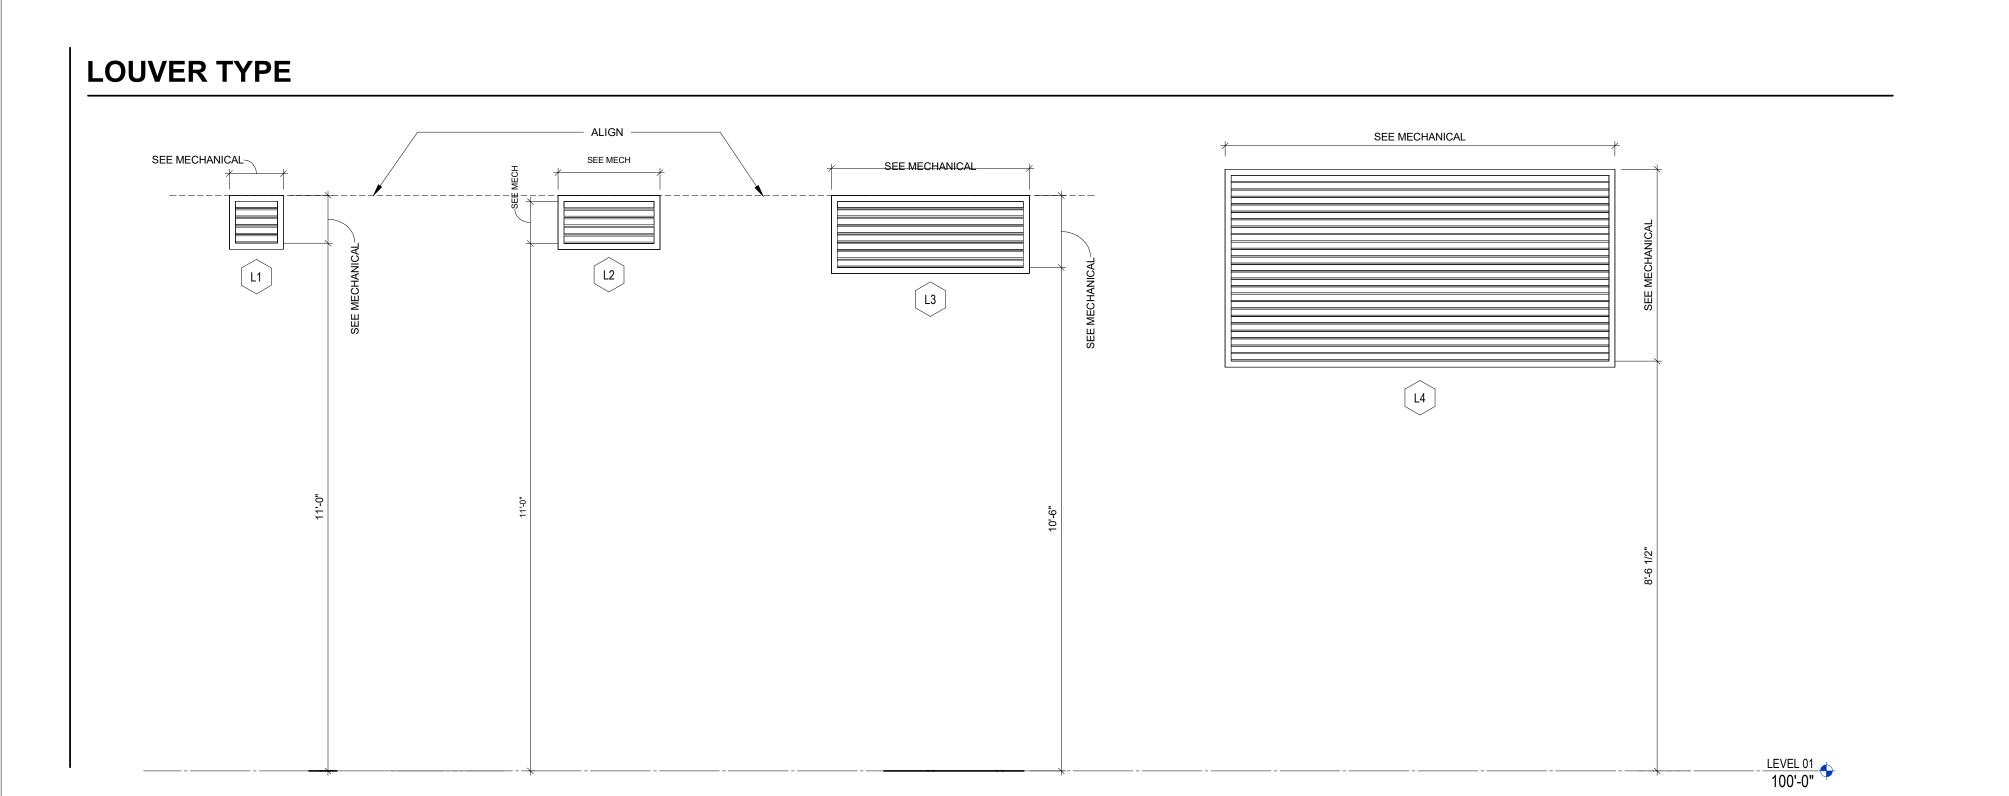
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WINDOW SCHEDULES

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22-061	11.01.2023
Drawn By:	Checked:
Author	Checker



WINDOW NOTES

GENERAL WINDOW NOTES

A. PROVIDE BUCKING MATERIAL BY GENERAL CONTRACTOR

B. PROVIDE JAMB EXTENSIONS WHERE REQUIRED.

C. ALL WINDOW SIZES SHOWN ARE NOMINAL CONTRACTOR SHALL FIELD VERIFY ALL ROUGH OPENINGS PRIOR TO ORDERING WINDOWS.

- D. PROVIDE IMPACT RESISTANT EXTERIOR DOOR AND WINDOW ASSEMBLIES AT ALL OPENINGS THAT COMPLY WITH STATE OF FLORIDA PRODUCT APPROVAL OR MIAMI DADE NOA (AS REQUIRED BY AHJ). MANUFACTURER SHALL PROVIDE CURRENT VALID MIAMI DADE COUNTY NOA OR FLORIDA PRODUCT APPROVAL FOR ENTIRE SYSTEM ASSEMBLY MEETING OR EXCEEDING DESIGN WIND LOAD REQUIREMENTS.
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- F. CONTRACTOR SHALL PROVIDE DOOR/WINDOW HARDWARE SCHEDULE TO ARCHITECT/OWNER FOR APPROVAL PRIOR TO PROCEEDING WITH WORK.

G. PROVIDE STRUCTURAL MULLIONS FOR LARGE OPENINGS.

H. ALL HARDWARE SHALL COMPLY WITH FBC - ACCESSIBILITY CODE 2020 7TH EDITION. SUBMIT A FINAL HARDWARE SCHEDULE FOR ARCHITECTS REVIEW COORDINATE HARDWARE WITH DOORS, FRAMES AND RELATED WORK TO ENSURE PROPER SIZE, HAND FUNCTION AND FINISH OF HARDWARE.

I. REFER TO STRUCTURAL DRAWINGS FOR REQUIRED WIND-LOAD DESIGN CRITERIA.

LOUVER NOTES

- 1. ALL LOUVERS TO BE SIZED IN ACCORDANCE WITH THE MECHANICAL DRAWINGS FOR REQUIRED FREE AREA.
- 2. PROVIDE IMPACT RESISTANT EXTERIOR LOUVERS ASSEMBLIES PER MECHANICAL DRAWINGS THAT COMPLY WITH STATE OF FLORIDA PRODUCT APPROVAL OR MIAMI DADE NOA (AS REQUIRED BY THE AHJ). MANUFACTURER SHALL PROVIDE CURRENT VALID MIAMI DADE NOA OR FLORIDA PRODUCT APPROVAL FOR ENTIRE SYSTEM MEETING OR EXCEEDING DESIGN WIND LOAD REQUIREMENTS.

3. REFER TO EXTERIOR ELEVATIONS FOR EXACT LOCATIONS OF LOUVERS.

GLAZING NOTES

1. SHGC 0.5. MIN 2. U-VALUE 0.9 OR LOWER 3. SOLARBAN 70



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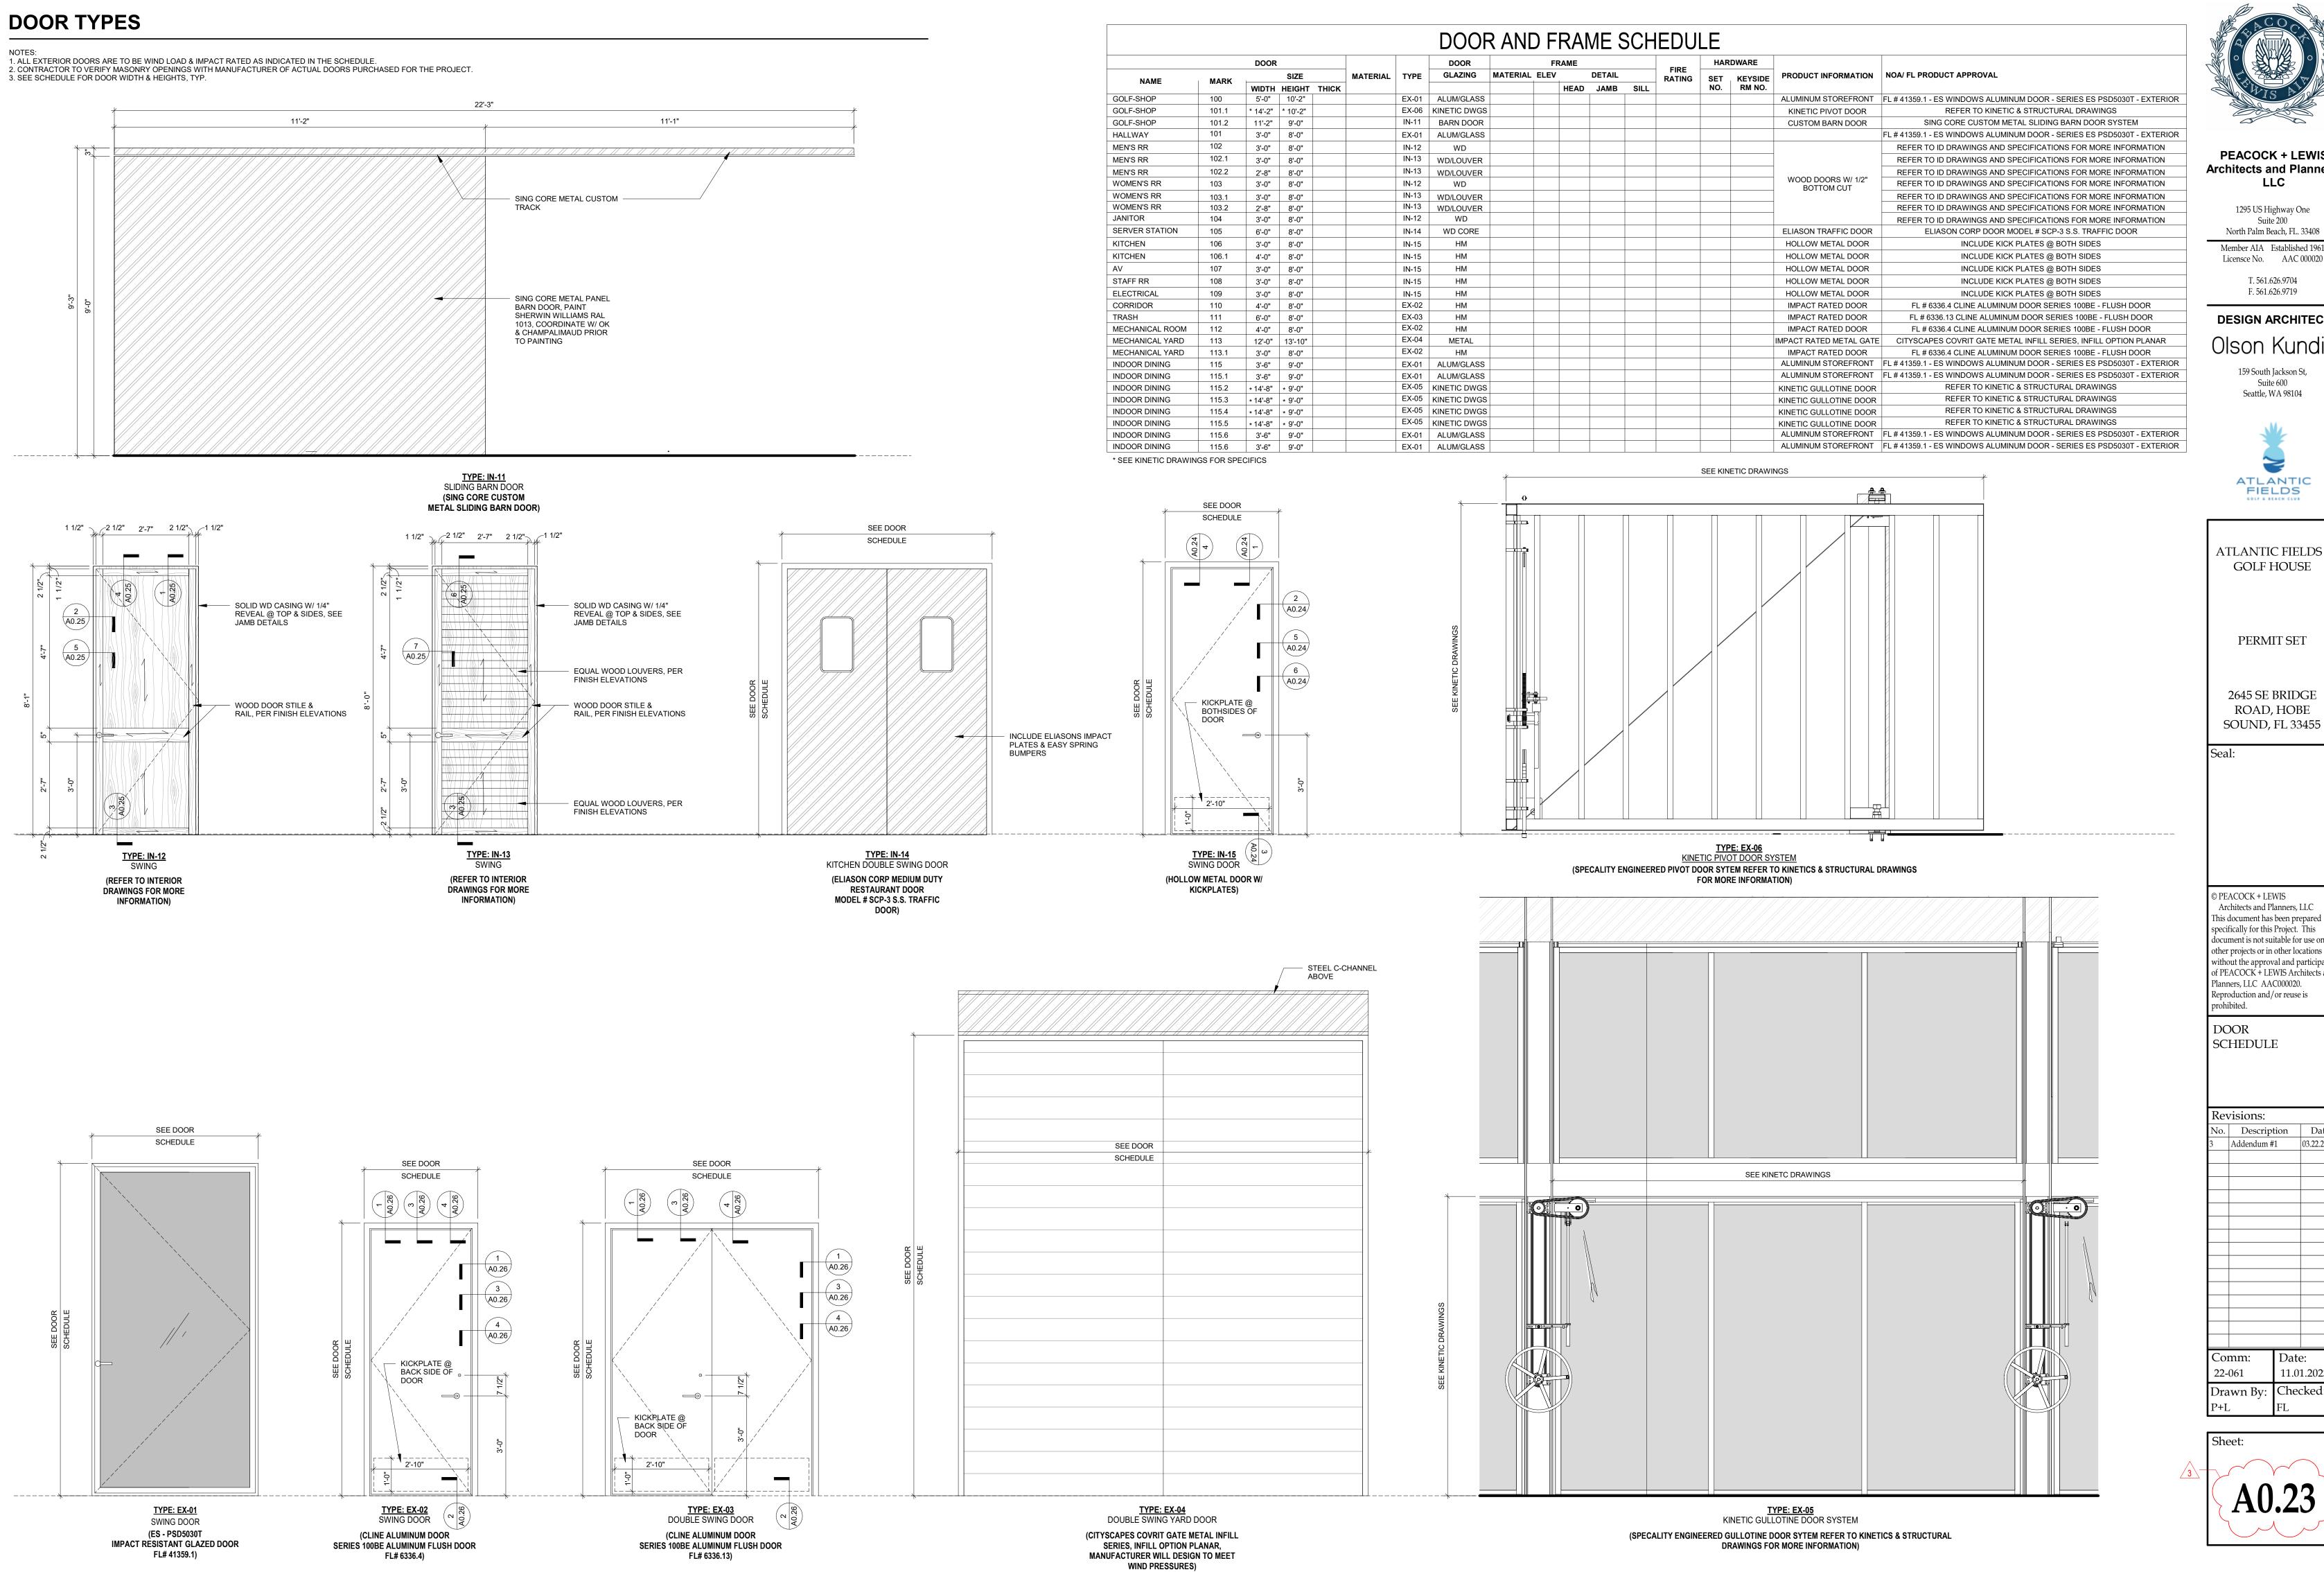
LOUVER SCHEDULES

Revisions:					
No.	Description Date				
3	Addendum #1	03.22.2024			

Comm:	Date:
22-061	11.01.2023
Drawn By:	Checked:
Author	Checker









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DESIGN ARCHITECT Olson Kundig

> 159 South Jackson St, Suite 600 Seattle, WA 98104



ATLANTIC FIELDS **GOLF HOUSE**

PERMIT SET

2645 SE BRIDGE ROAD, HOBE SOUND, FL 33455

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DOOR SCHEDULE

Revisions: No. Description Date Addendum #1 03.22.2024 Date: Comm:

11.01.2023 Checked: Drawn By:

Sheet:


DOOR NOTES

- 1. PROVIDE GROUT FILL FRAMES.
- 2. PROVIDE STC-45 OR BETTER SOUND RATED DOORS.
- 3. PROVIDE CUSTOM PULL DOOR HARDWARE.
- 4. EXTERIOR DOOR SYSTEM TO MEET SECTION 1609 OF FBC 2020 WIND LOADS.


5. PROVIDE SPRING LOADED HINGES.

- 6. PROVIDE 2X4 (2X6 WHERE NEEDED) ALUM. STRUCT. HEADER BETWEEN DOOR AND TRANSOM.
- 7. PROVIDE 2X4 (2X6 AS NEEDED) ALUM. STRUCT. MULLION BETWEEN DOOR AND SIDELITE.
- 8. UNDERCUT DOOR 1" FOR VENTILATION.
- 9. CONTRACTOR TO VERIFY MASONRY OPENING (M.O.). DOOR MANUFACTURE TO INDICATE AS PART OF SHOP DRAWINGS DOOR SIZE AND FRAME MASONRY OPENINGS CAN ACCOMODATE BEFORE ORDERING DOORS.
- 10. PROVIDE FINAL HARDWARE SUBMITTAL, INDCLUDING CUT SHEETS, FOR APPROVAL BY OWNER AND ARCHITECT.
- 11. IMPACT RESISTENT ALUMINUM SLIDING/FOLDING DOOR SYSTEM WITH RECESS TRACK AND FLUSH THRESHOLD. INSTALL PER MANUFACTURER'S RECOMMENED INSTALLATION PROCEDURE.
- 12. IMPACT RESISTENT STEEL DOOR SYSTEM. DETAILS AND INSTALLATION PER MANUFACTURER'S RECOMMENED INSTALLATION PROCEUDRE AND SHOP DRAWINGS.
- 13. IMPACT RATED WINDOWS/DOOR ASSEMBLIES TO COMPLY WITH STATE OF FLORIDA PRODUCT APPROVAL OR MIAMI DADE NOA (AS REQUIRED BY THE AHJ).


 MANUFACTURER SHALL PROVIDE CURRENT VALID MIAMI DADE NOA OR FLORIDA PRODUCT APPROVAL FOR ENTIRE SYSTEM MEETING OR EXCEEDING THE
 DESIGNED WIND LOAD REQUIREMENTS. FINISH PER MANUFACTURERS STANDARD COLORS, COORDINATE COLOR WITH OWNER/ARCHITECT PRIOR TO PURCHASE.
- 14. PROVIDE SLIDING POCKET DOOR HARDWARE AND MECHANISM, PER PORTLAB MAUFACTURERS SPECIFICATIONS.
- 15. COORDINATE WITH LOW VOLTAGE AND ELECTRICAL DRAWINGS FOR DOOR OPERATION AND SECURITY SYSTEM SPECIFICATIONS.
- 16. DOOR ASSEMBLY TO RESIST THE PASSAGE OF SMOKE.
- 17. HOLLOW METAL FRAME ONLY, NO DOOR TO BE INSTALLED.
- 18. REFER TO INTERIOR DESIGN DRAWINGS FOR OPENING/CASING DETAILS AND DIMENSIONS.
- 19. DOOR AS PART OF MILLWORK PACKAGE, REFER TO INTERIOR DESING DRAWINGS FOR DETAILS AND FINISH.
- 20. OPENING AS PART OF MILLWORK PACKAGE, REFER TO INTERIOR DESING DRAWINGS FOR DETAILS AND FINISH.
- 21. PROVIDE HARDWARE FOR 180 DEGREE SWING.
- 22. DOOR FINISH PER MANUFACTURER STANDARD COLORS.
- 23. ALL EXTERIOR DOORS SHALL BE EQUIPPED WITH PANIC HARDWARE.
- 24. ALL EXIT DOORS SHAL BE ARRANGED TO OPEN READILLY FROM THE EGRESS SIDE WITHOUT THE USE OF A KEY, TOOL OR SPECIAL KNOWLEDGE.
- 25. PROVIDE PANIC HADWARE.
- 26. PROVIDE "HOLD OPEN" DEVICES SUCH AS THE ACTIVATION OF THE BUILDING FIRE ALARM SYSTEM SHALL AUTOMATICALLY RELEASE THE MAGNETIC "HOLD OPEN" DEVICE AND THIS DOOR TO SELF LATCH INTO A CLOSED POSITION IN ORDER TO MAINTAIN 1 HOUR FIRESEPARATION BETWEEN THE SPACES. THIS DOOR SHALL REMAIN CLOSED UNTIL FIRE ALARM SYSTEM HAS BEEN MANUALLY RESET.
- 27. PROVIDE CLOSER ON ALL FIRE RATED DOORS.28. FIBERGLASS DOORS AND FRAMES. PROJECT SPECIFIIC ENGINEERING WILL BE SUBMITTED PRIOR TO INSTALLATION.
- 29. DOOR IS LOCKED AT ALL TIMES PREVENTING UNAUTHORIZED ENTRY. FREE EGRESS AT ALL TIMES
- 30. SEE KINETIC DRAWINGS FOR ANY NOMANCLATURE REFERRING TO KINETCS

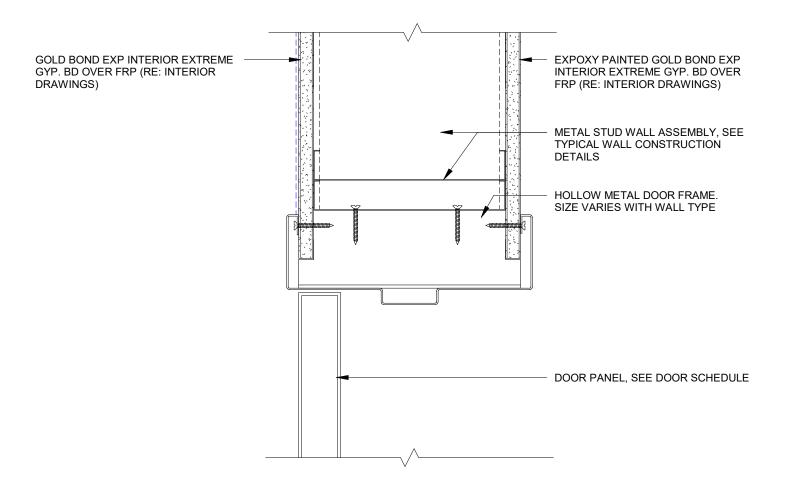




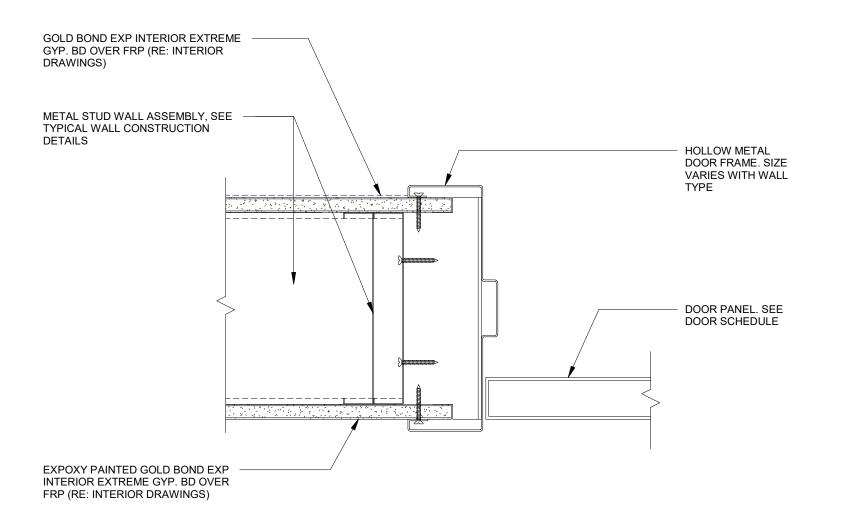


5 IN-15 JAMB DETAIL FRP/ PT. GYP. SCALE: 3" = 1'-0"

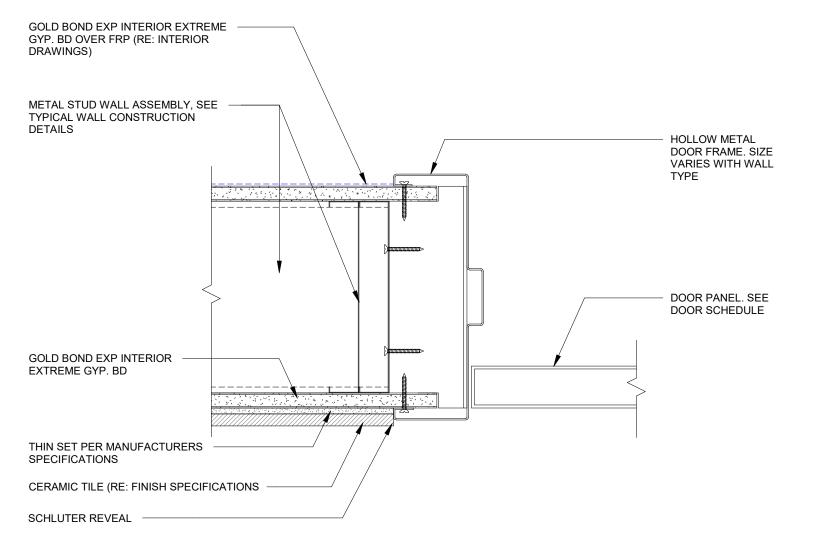


6 IN-15 JAMB DETAIL TILE/ FRP

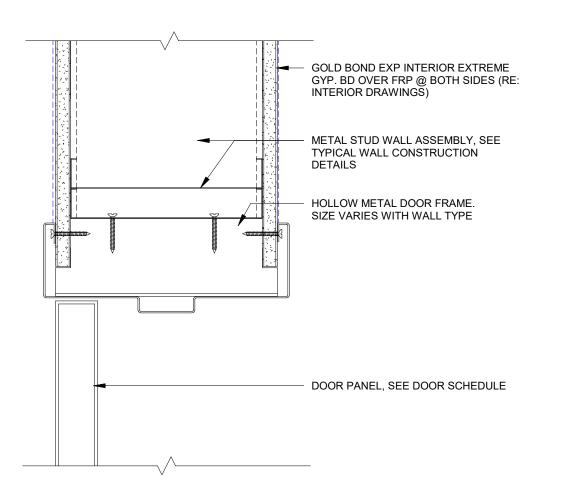



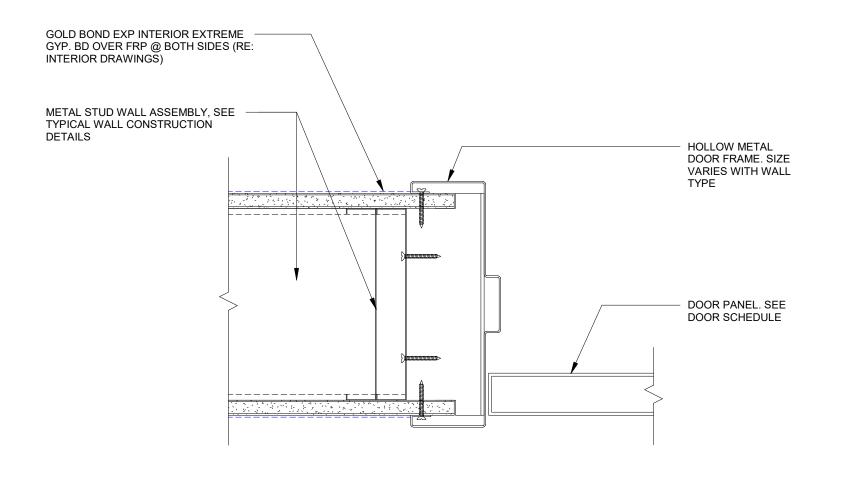



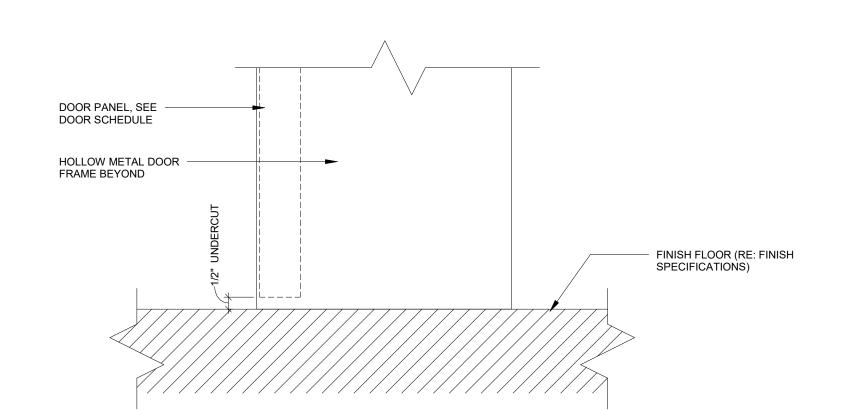





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Olson Kundia

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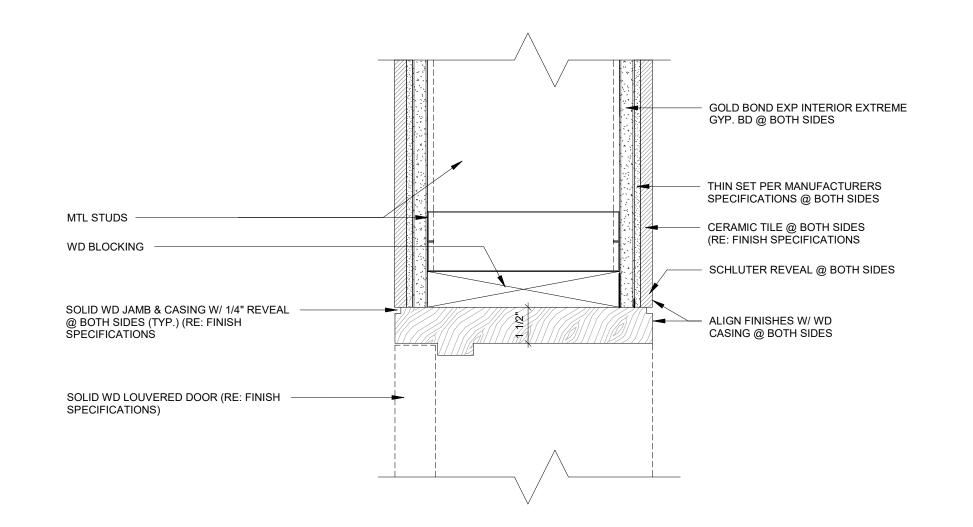
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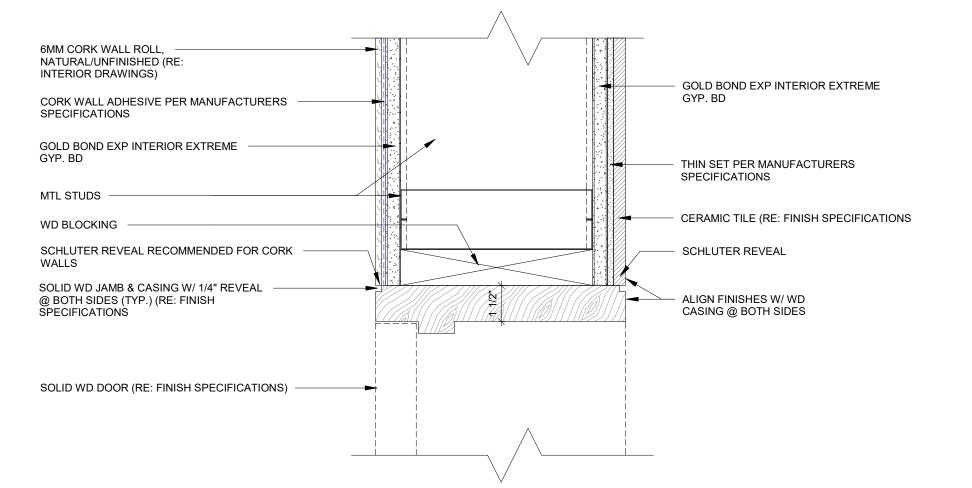
No. Description Date

3 Addendum 2024

Comm: Date: 11.01.2023
Drawn By: Checked: FI


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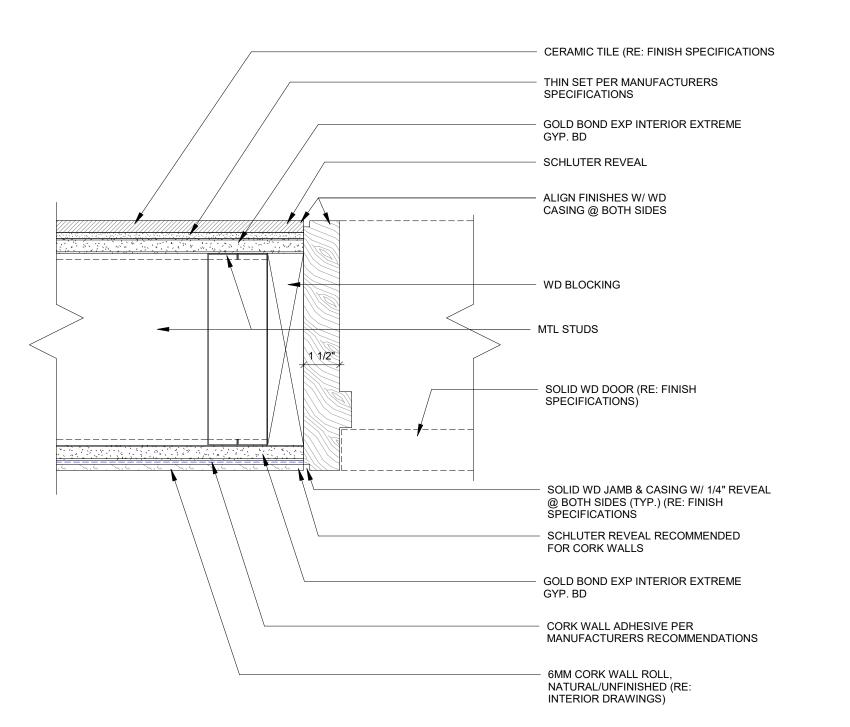
6 IN-12 HEADER DETAIL TILE/ TIL

SCALE: 3" = 1'-0"



IN-12 HEADER DETAIL CORK/ TIL

SCALE: 3" = 1'-0"

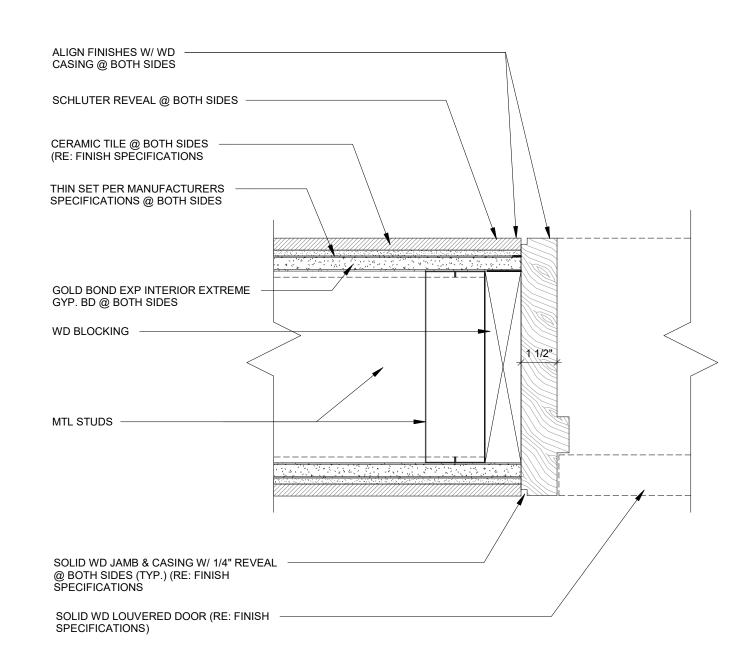


IN-12 JAMB DETAIL TILE/ TILE

7


IN-12 JAMB DETAIL CORK/ TILE

5

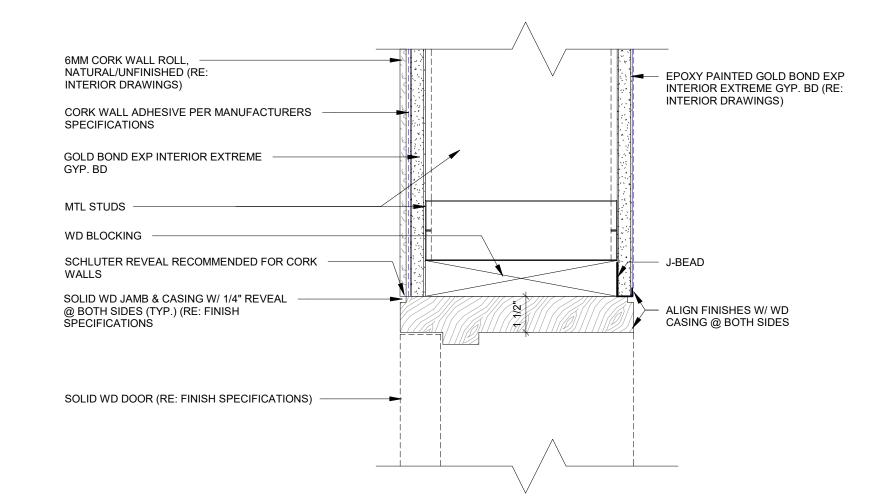


IN-12 HEADER DETAIL CORK/ P.T. GYP.

SCALE: 3" = 1'-0"

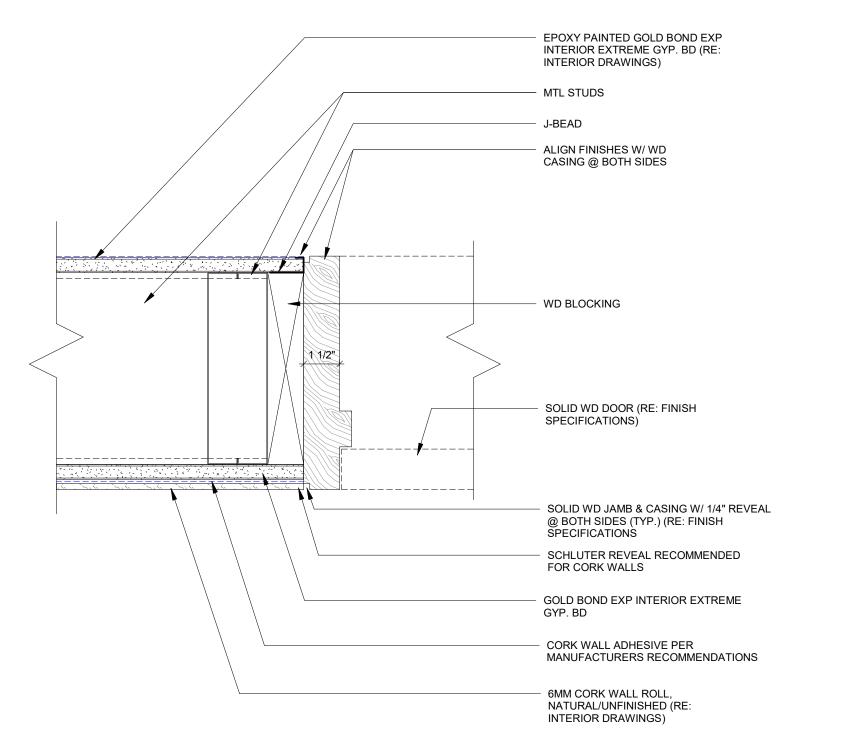

IN-12 JAMB DETAIL CORK/ P.T. GYP.

SCALE: 3" = 1

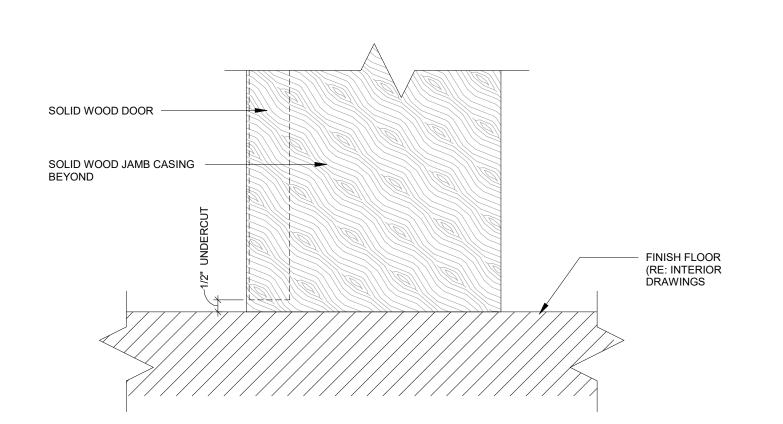

IN-12 SILL DETAIL

SCALE: 3" = 1'-0"



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No. Description Date

3 Addendum 03.22.

#1 2024


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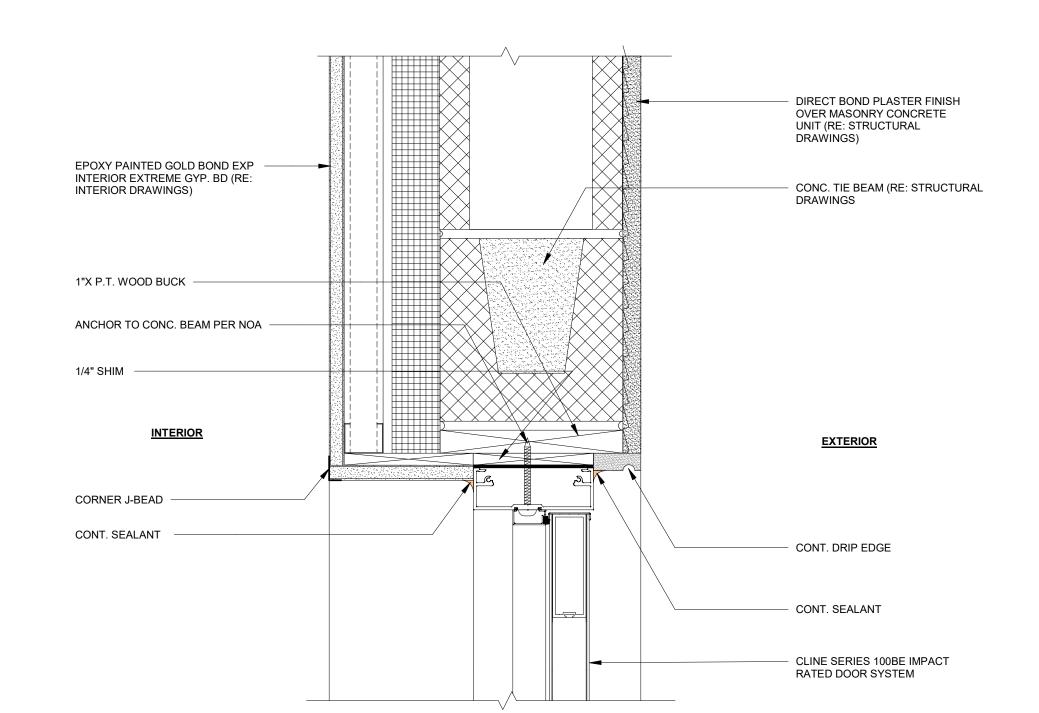
 22-061
 11.01.2023


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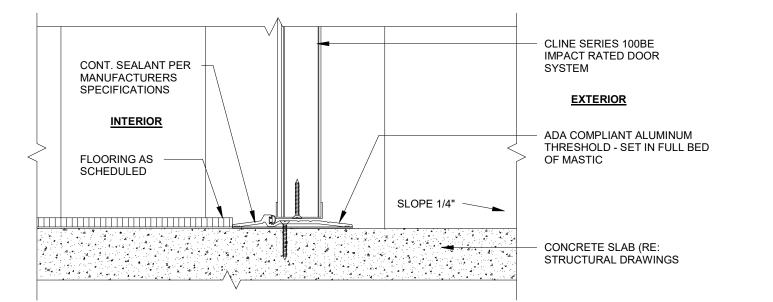








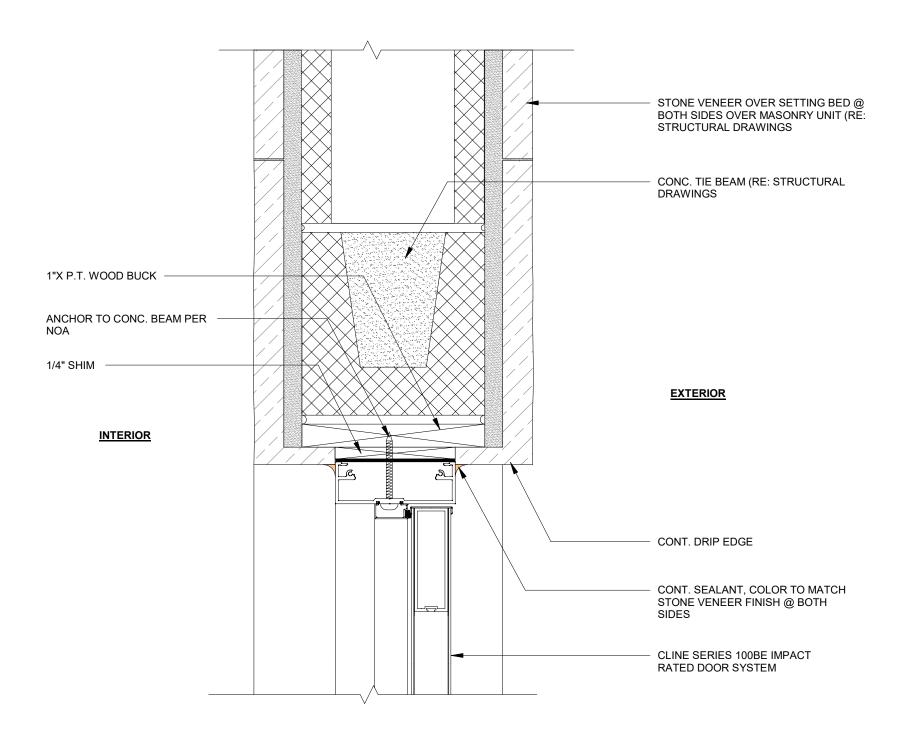

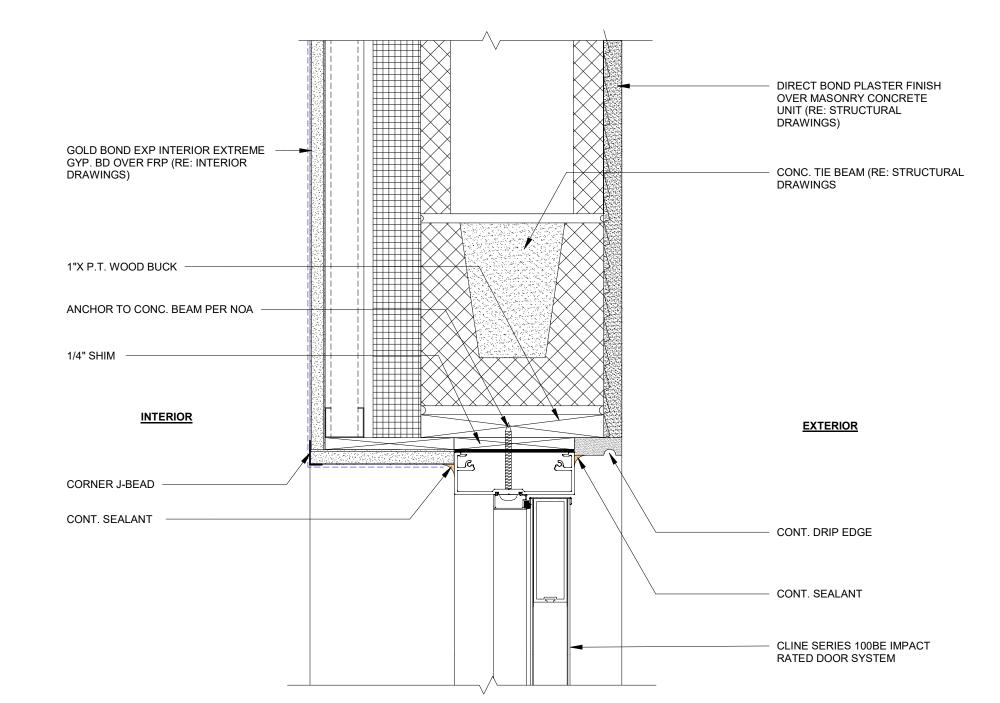

EX02 - EX03 SILL DETAILSCALE: 3" = 1'-0"



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EXT. HM DOOR DETAILS


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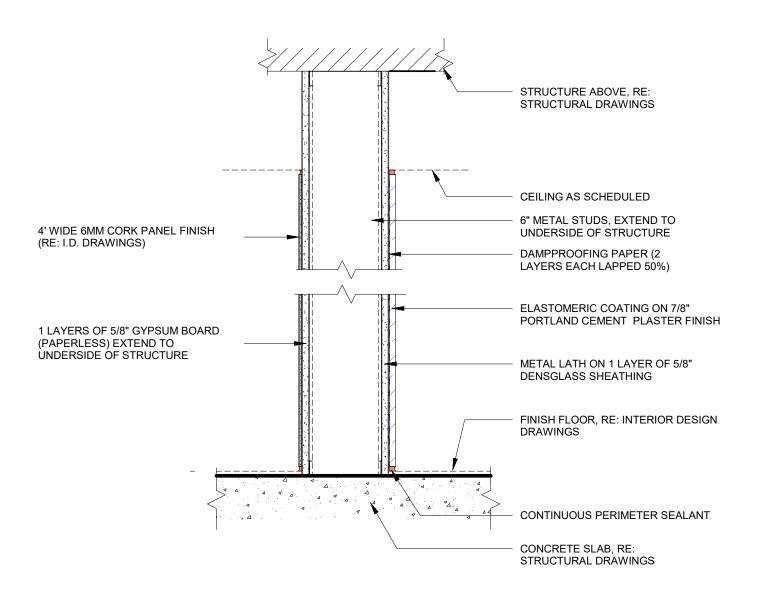
No. Description Date

3 Addendum 03.22.
#1 2024

Comm: Date: 22-061 11.01.2023

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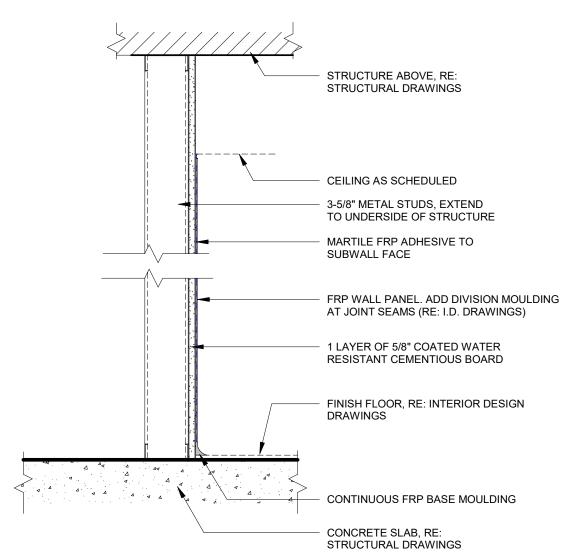


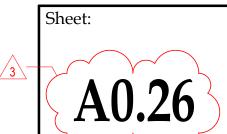

NOTES: ".#" SUFFIX INDICATES LGMF WIDTH: <u>.0875</u> = 7/8" HAT CHANNEL, <u>.1</u>= 1-5/8" STUD, <u>.3</u>= 3-5/8" STUD, <u>.6</u> = 6" STUD,

NOTE: USG MOISTURE RESISTANT BOARD, FOR ALL BATHROOM WALLS ,UNLESS OTHERWISE NOTED


P10.# parition cork_plaster finish			
PARTITION TYPE	STUD WIDTH	PARTITION WIDTH	REMARKS
P10 <u>.6</u>	6"	8"	



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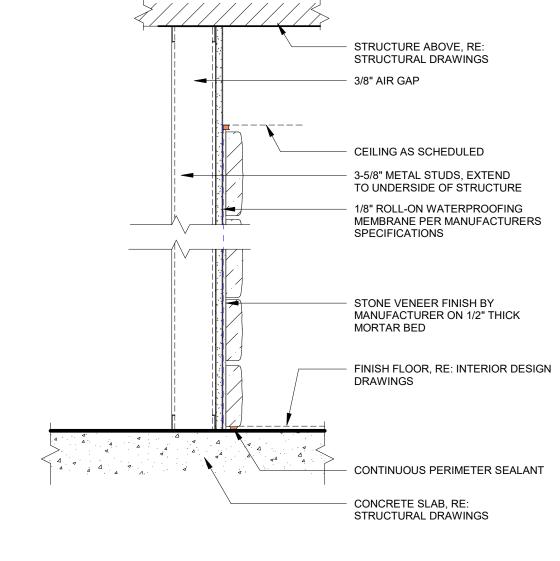
P9.#	SINGLE SID	E PARTITION W	ITH FRP FINISH
PARTITION TYPE	STUD WIDTH	PARTITION WIDTH	REMARKS
P9 <u>.3</u>	3-5/8"	4-1/2"	



NOTES: ".#" SUFFIX INDICATES LGMF WIDTH: <u>.0875</u> = 7/8" HAT CHANNEL, <u>.1</u> = 1-5/8" STUD, <u>.3</u> = 3-5/8" STUD, <u>.6</u> = 6" STUD,

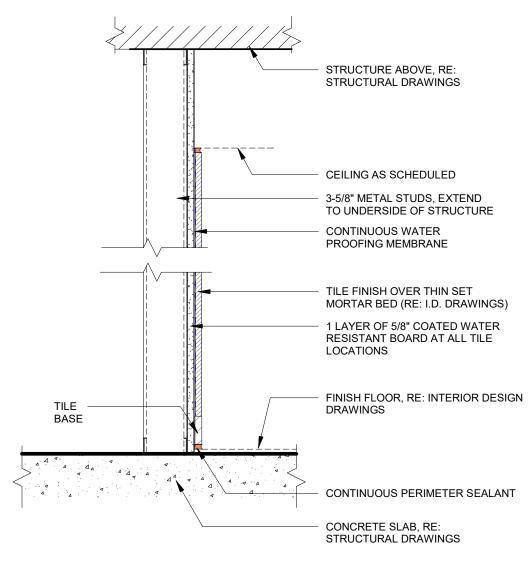NOTE: USG MOISTURE RESISTANT BOARD, FOR ALL BATHROOM WALLS, UNLESS OTHERWISE NOTED


P8.#	SINGLE SID	E PARTITION WI	ITH TILE FINISH
PARTITION TYPE	STUD WIDTH	PARTITION WIDTH	REMARKS
P8 <u>.3</u>	3-5/8"	4-3/4"	



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USG MOISTURE RESISTANT BOARD, FOR ALL BATHROOM WALLS ,UNLESS


OTHERWISE NOTED						
P7.#	SINGLE SID	E PARTITION WI	TH STONE VENEER FINISH			
PARTITION TYPE	STUD WIDTH	PARTITION WIDTH	REMARKS			
P7 <u>.3</u>	3-5/8"	5-1/2"				

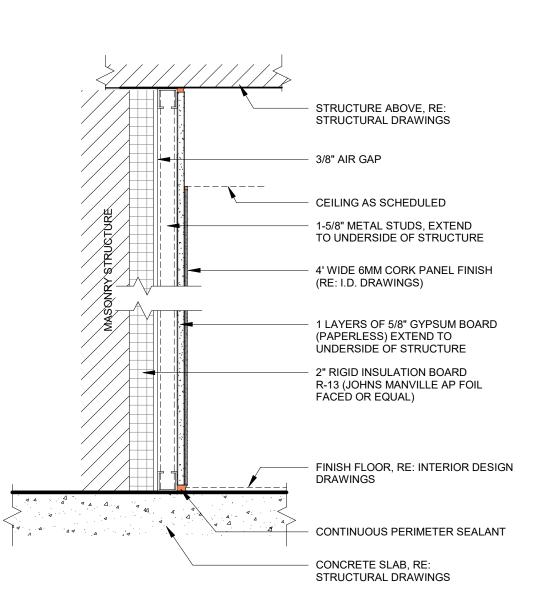

NOTES: ".#" SUFFIX INDICATES LGMF WIDTH: <u>.0875</u> = 7/8" HAT CHANNEL, <u>.1</u>= 1-5/8" STUD, <u>.3</u>= 3-5/8" STUD, <u>.6</u> = 6" STUD,

NOTE: USG MOISTURE RESISTANT BOARD, FOR ALL BATHROOM WALLS ,UNLESS


OTHERWISE	OTHERWISE NOTED					
P2.# FURRING PARTITION WITH CORK FINISH						
PARTITION TYPE	STUD WIDTH	PARTITION WIDTH	REMARKS			
P2 <u>.1</u>	1-5/8"	5"				

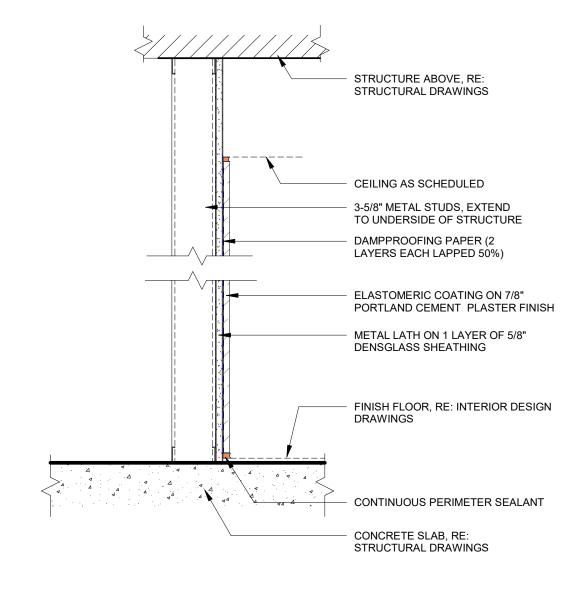

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USG MOISTURE RESISTANT BOARD, FOR ALL BATHROOM WALLS ,UNLESS


OTHERWISE NOTED				
P6.#	SINGLE SID	E PARTITION WI	ITH PLASTER FINISH	
PARTITION TYPE	STUD WIDTH	PARTITION WIDTH	REMARKS	
P6 <u>.3</u>	3-5/8"	4-3/4"		

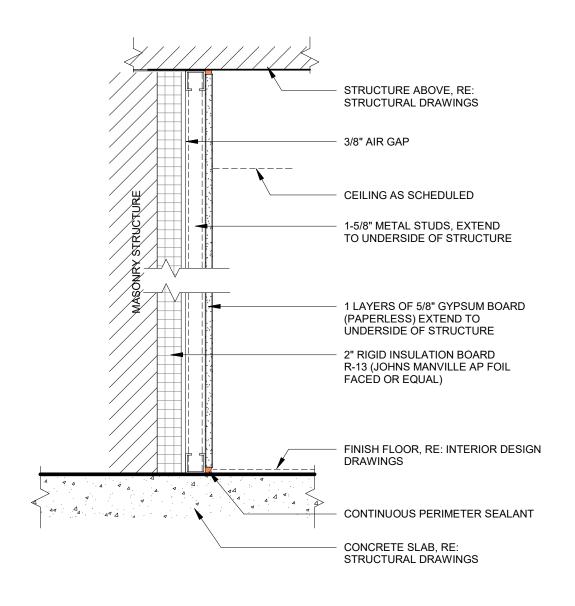

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USG MOISTURE RESISTANT BOARD, FOR ALL BATHROOM WALLS ,UNLESS


OTHERWISE	THERWISE NOTED				
P1.#	P1.# FURRING PARTITION WITH GYP BOARD				
PARTITION TYPE	STUD WIDTH	PARTITION WIDTH	REMARKS		
P1 <u>.1</u>	1-5/8"	4-5/8"	PARTITION WITH GYPSUM BOARD (PAPERLESS)		
P1 <u>.1A</u>	1-5/8"	5"	PARTITION WITH GYPSUM BOARD (MOISTURE RESISTENT)		

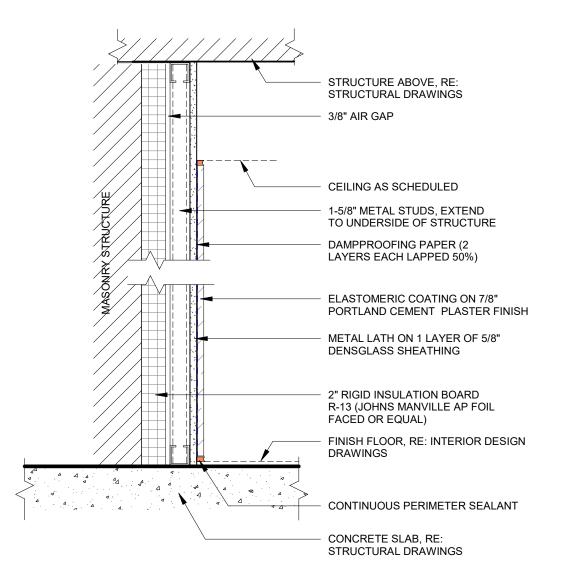

NOTES: ".#" SUFFIX INDICATES LGMF WIDTH: <u>.0875</u> = 7/8" HAT CHANNEL, <u>.1</u>= 1-5/8" STUD, <u>.3</u>= 3-5/8" STUD, <u>.6</u> = 6" STUD,

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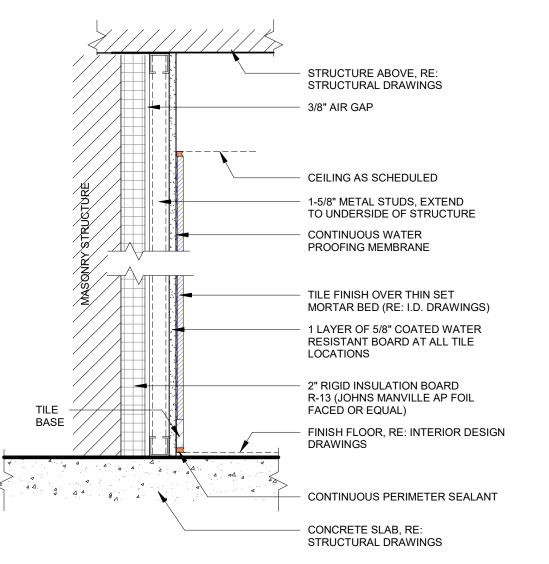
OTHERWISE NOTED					
P5.#	FURRING P	ARTITION WITH	PLASTER FINISH		
PARTITION TYPE	STUD WIDTH	PARTITION WIDTH	REMARKS		
P5.1	1-5/8"	4-5/8"			

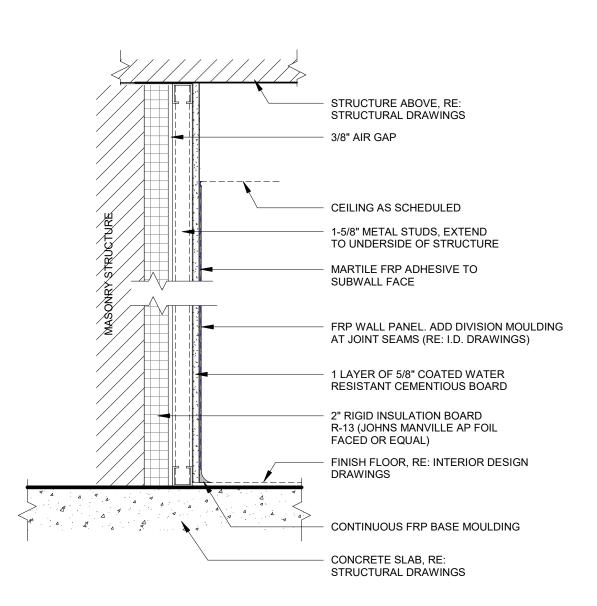

NOTES: ".#" SUFFIX INDICATES LGMF WIDTH: <u>.0875</u> = 7/8" HAT CHANNEL, <u>.1</u>= 1-5/8" STUD, <u>.3</u>= 3-5/8" STUD, <u>.6</u> = 6" STUD,

USG MOISTURE RESISTANT BOARD, FOR ALL BATHROOM WALLS ,UNLESS OTHERWISE NOTED

P4.#	FURRING P	ARTITION WITH	FRP FINISH
PARTITION TYPE	STUD WIDTH	PARTITION WIDTH	REMARKS
P4 <u>.1</u>	1-5/8"	4-5/8"	



NOTES: ".#" SUFFIX INDICATES LGMF WIDTH: <u>.0875</u> = 7/8" HAT CHANNEL, <u>.1</u> = 1-5/8" STUD, <u>.3</u> = 3-5/8" STUD, <u>.6</u> = 6" STUD,

NOTE: USG MOISTURE RESISTANT BOARD, FOR ALL BATHROOM WALLS ,UNLESS OTHERWISE NOTED

P3.#	FURRING P	ARTITION WITH	TILE FINISH
PARTITION TYPE	STUD WIDTH	PARTITION WIDTH	REMARKS
P3 <u>.1</u>	1-5/8"	5-1/4"	

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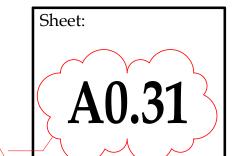
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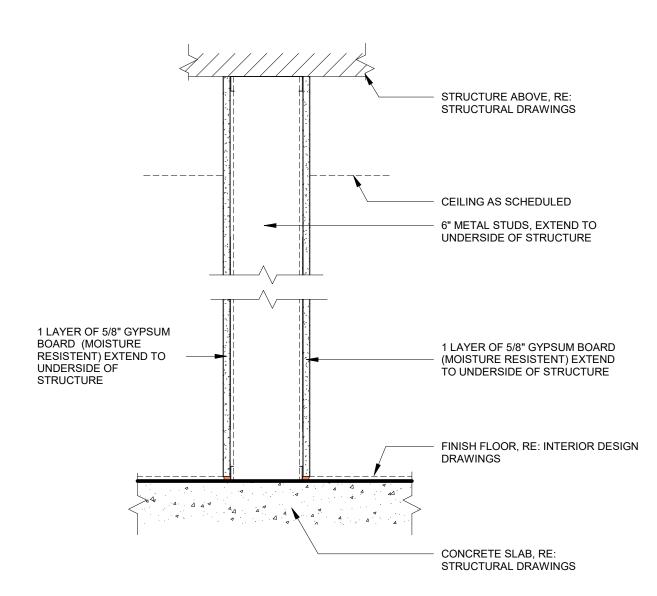
ASSEMBLIES -WALLS AND **PARTITIONS**

Rev	visions:	
No.	Description	Date
3	Addendum #1	03.22.2024

22-061 11.01.2023 Checked: Drawn By: Author Checker








NOTE: USG MOISTURE RESISTANT BOARD, FOR ALL BATHROOM WALLS ,UNLESS OTHERWISE NOTED


	OTHERWISE NOTED					
P18.#	PARITIC	N GYP (MOISTU	RE BD)_GYP (MOISTURE BD) FINISH			
PARTITION TYPE	STUD WIDTH	PARTITION WIDTH	REMARKS			
P18 <u>.6</u>	6"	7-1/2"				

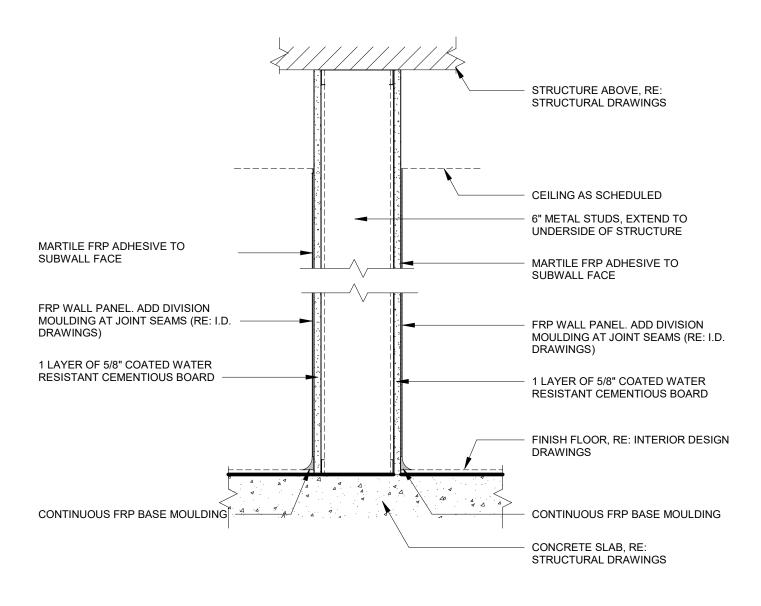

NOTES: ".#" SUFFIX INDICATES LGMF WIDTH: $\underline{.0875}$ = 7/8" HAT CHANNEL, $\underline{.1}$ = 1-5/8" STUD, $\underline{.3}$ = 3-5/8" STUD, $\underline{.6}$ = 6" STUD,


SILE. SIG MOISTURE RESISTANT BOARD, FOR ALL BATHROOM WALLS ,UNLESS

P14.#	PARITIC	N FRP_FRP FINI	SH
PARTITION TYPE	STUD WIDTH	PARTITION WIDTH	REMARKS
P14 <u>.6</u>	6"	7-1/2"	
P14 <u>.6A</u>	6"	7-1/2"	WALL HEIGHT TO BE 54"

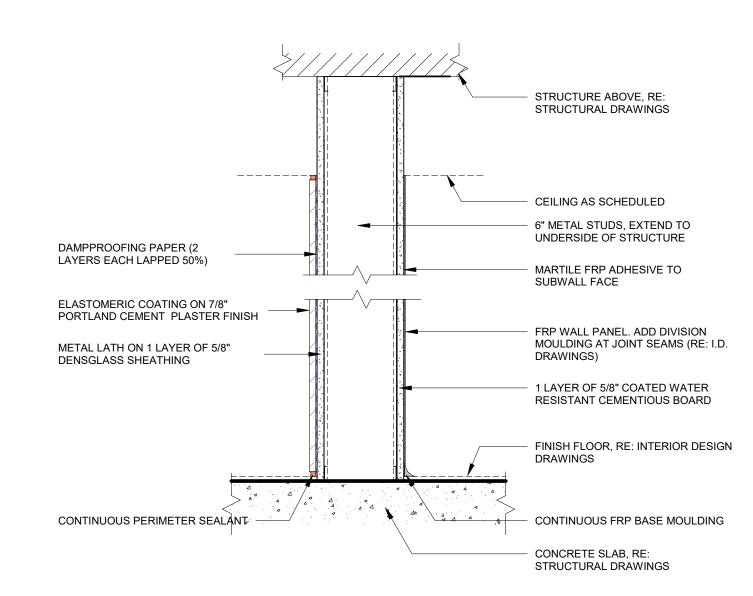

NOTE: USG MOISTURE RESISTANT BOARD, FOR ALL BATHROOM WALLS ,UNLESS OTHERWISE NOTED


OTHERWISE NOTED						
P17.#	PARITIC	N PLASTER_FR	PFINISH			
PARTITION TYPE	STUD WIDTH	PARTITION WIDTH	REMARKS			
P17 <u>.6</u>	6"	8"				

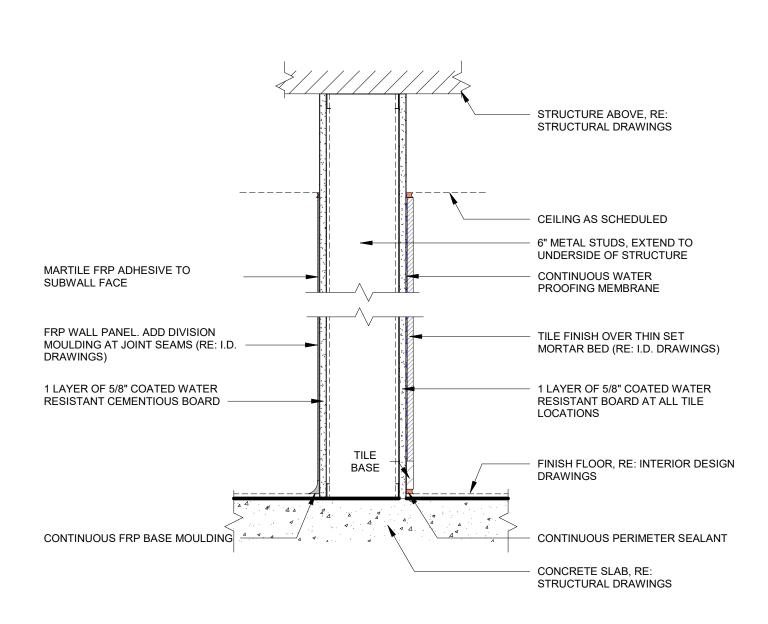

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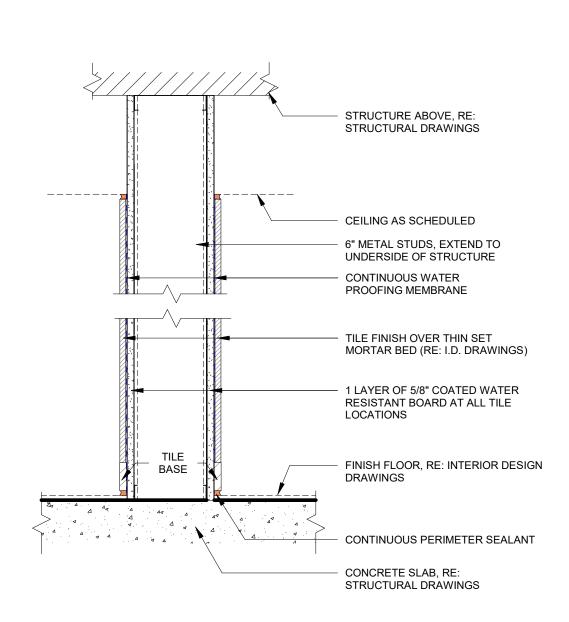
NOTE: USG MOISTURE RESISTANT BOARD, FOR ALL BATHROOM WALLS ,UNLESS

OTHERWISE	OTHERWISE NOTED					
P13.#	P13.# FURRING PARTITION WITH GYP BOARD					
PARTITION TYPE	STUD WIDTH	PARTITION WIDTH	REMARKS			
P13.6	6"	8"				

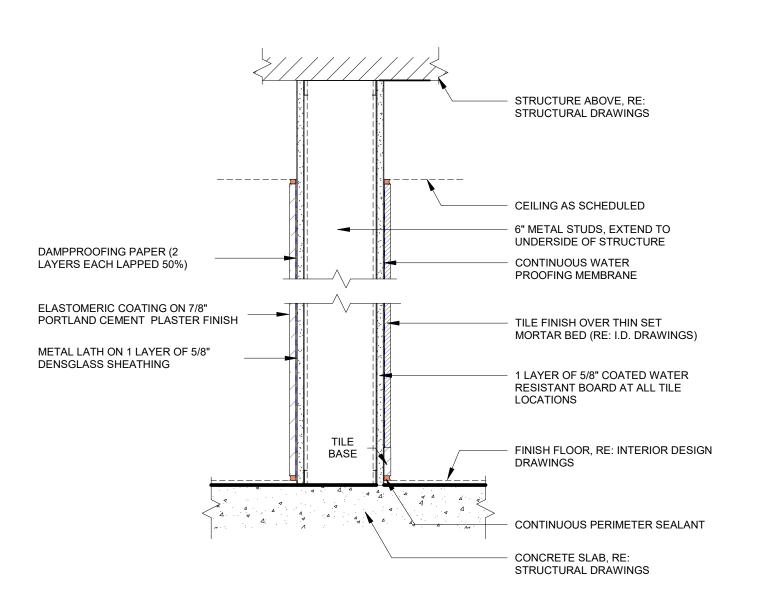


NOTE: USG MOISTURE RESISTANT BOARD, FOR ALL BATHROOM WALLS ,UNLESS

OTHERWISE NOTED						
P16.#	PARITIC	ON PLASTER_TIL	E FINISH			
PARTITION TYPE	STUD WIDTH	PARTITION WIDTH	REMARKS			
P16 <u>.6</u>	6"	8-1/2"				



USG MOISTURE RESISTANT BOARD, FOR ALL BATHROOM WALLS ,UNLES


P12.# parition tile_tile finish					
STUD WIDTH	PARTITION WIDTH	REMARKS			
3-5/8"	5-1/2"				
6"	8-1/2"				
	STUD WIDTH 3-5/8"	STUD PARTITION WIDTH 3-5/8" 5-1/2"			

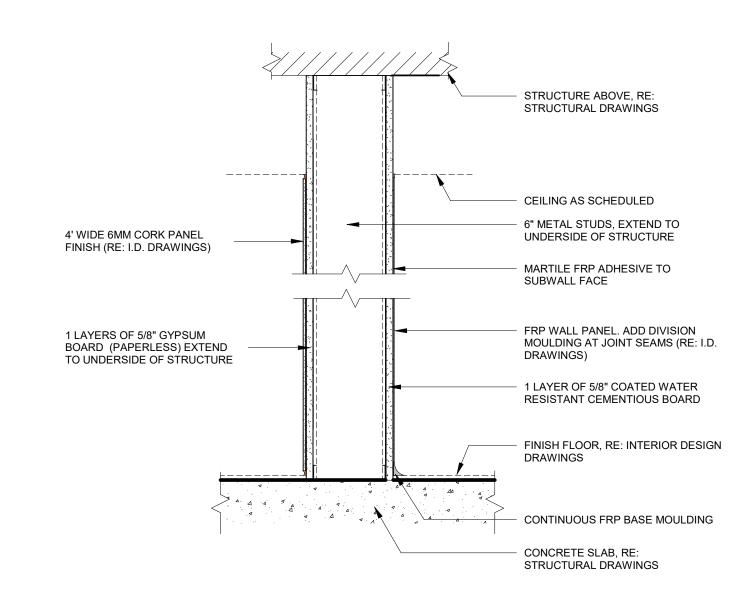

NOTES: ".#" SUFFIX INDICATES LGMF WIDTH: <u>.0875</u> = 7/8" HAT CHANNEL, <u>.1</u>= 1-5/8" STUD, <u>.3</u>= 3-5/8" STUD, <u>.6</u> = 6" STUD,

NOTE: USG MOISTURE RESISTANT BOARD, FOR ALL BATHROOM WALLS ,UNLESS OTHERWISE NOTED

OTHERWISE	OTHERWISE NOTED					
P15.#	PARITIC	N CORK_FRP FI	NISH			
PARTITION TYPE	STUD WIDTH	PARTITION WIDTH	REMARKS			
P15.6	6"	7-1/2"				

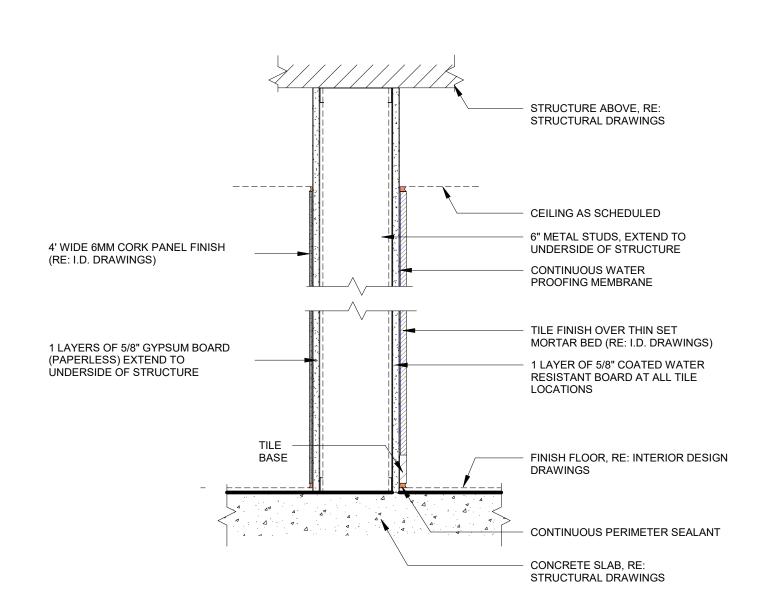

NOTES: "#" SUFFIX INDICATES LGMF WIDTH:
__0875 = 7/8" HAT CHANNEL, _1 = 1-5/8" STUD, _3 = 3-5/8" STUD, _6 = 6" STUD,

NOTE: USG MOISTURE RESISTANT BOARD, FOR ALL BATHROOM WALLS ,UNLESS

P11.#	PARITIC	ON CORK_TILE FI	NISH
PARTITION TYPE	STUD WIDTH	PARTITION WIDTH	REMARKS
P11 <u>.6</u>	6"	8"	



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DESIGN ARCHITECT Olson Kundig

159 South Jackson St, Suite 600 Seattle, WA 98104



ATLANTIC FIELDS -GOLF HOUSE

PERMIT SET

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ASSEMBLIES -WALLS AND PARTITIONS


Revisions:

No. Description Date

3 Addendum #1 03.22.2024

Comm: Date: 11.01.2023
Drawn By: Checked: Author Checker


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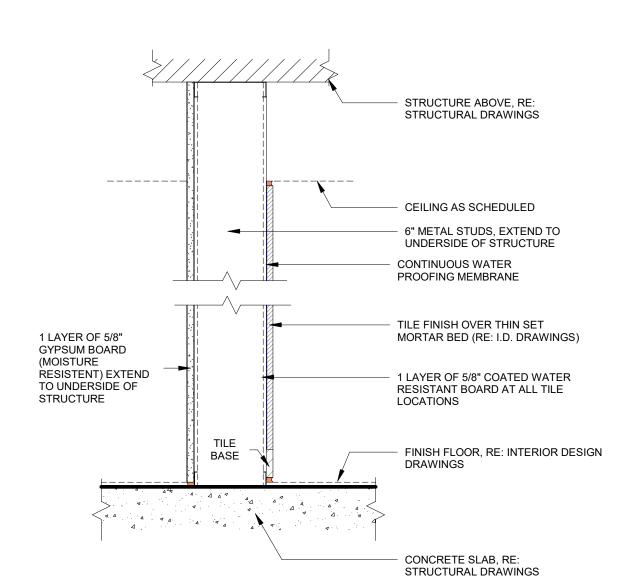
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NOTE: USG MOISTURE RESISTANT BOARD, FOR ALL BATHROOM WALLS ,UNLESS

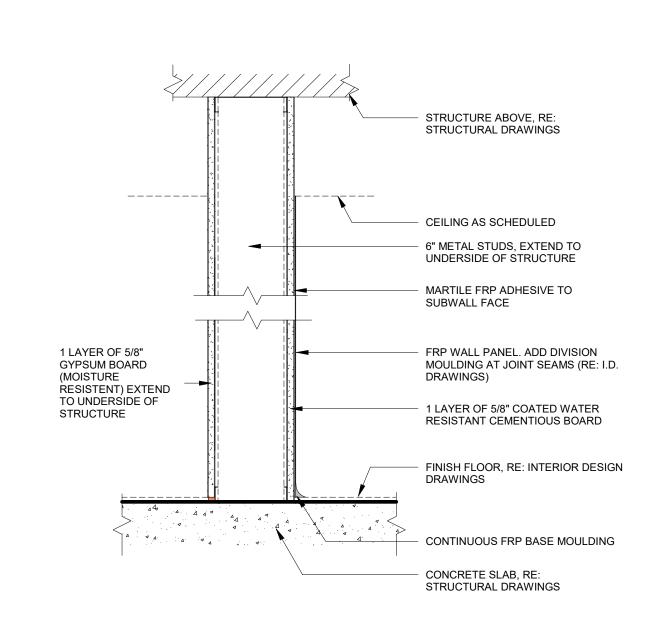OTHERWISE NOTED						
P20.#	PARITIC	N GYP (MOISTU	RE BD)_FRP FINISH			
PARTITION TYPE	STUD WIDTH	PARTITION WIDTH	REMARKS			
P20 <u>.6</u>	6"	7-1/2"				




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W	ALL - W2				

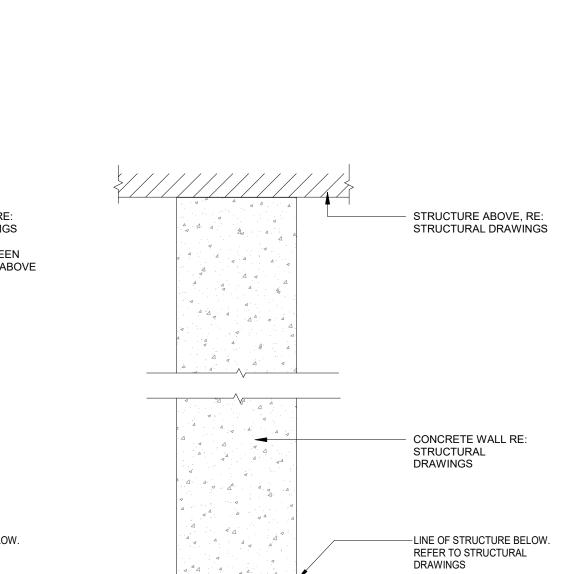

NOTES: ".#" SUFFIX INDICATES LGMF WIDTH: <u>.0875</u> = 7/8" HAT CHANNEL, <u>.1</u>= 1-5/8" STUD, <u>.3</u>= 3-5/8" STUD, <u>.6</u> = 6" STUD,

NOTE: USG MOISTURE RESISTANT BOARD, FOR ALL BATHROOM WALLS, UNLESS

OTHERWISE NOTED						
P19.#	PARITIC	N GYP (MOISTUI	RE BD)_TILE FINISH			
PARTITION TYPE	STUD WIDTH	PARTITION WIDTH	REMARKS			
P19 <u>.6</u>	6"	7-1/4"				

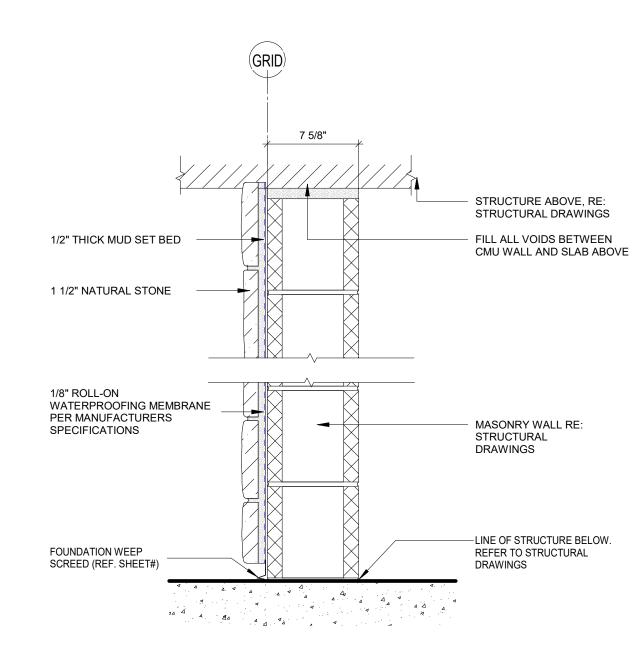

WALL - W1 SCALE: 1 1/2" = 1'-0"



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DESIGN ARCHITECT Olson Kundig

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ATLANTIC FIELDS **GOLF HOUSE**

PERMIT SET

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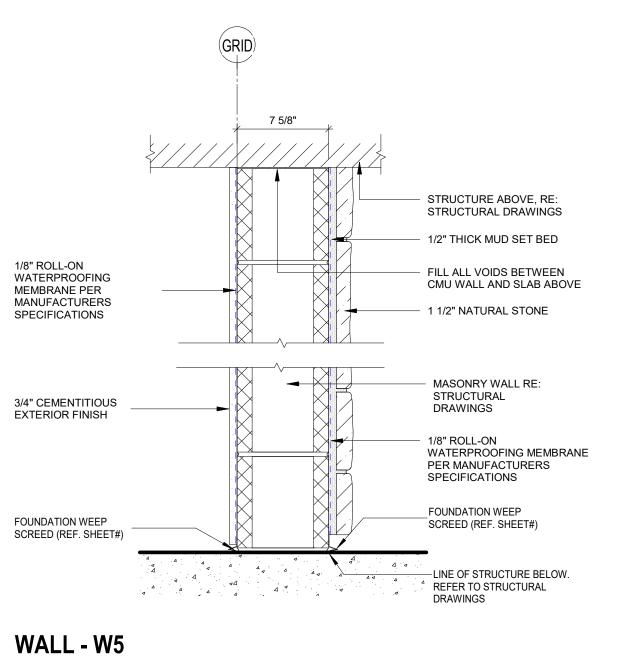
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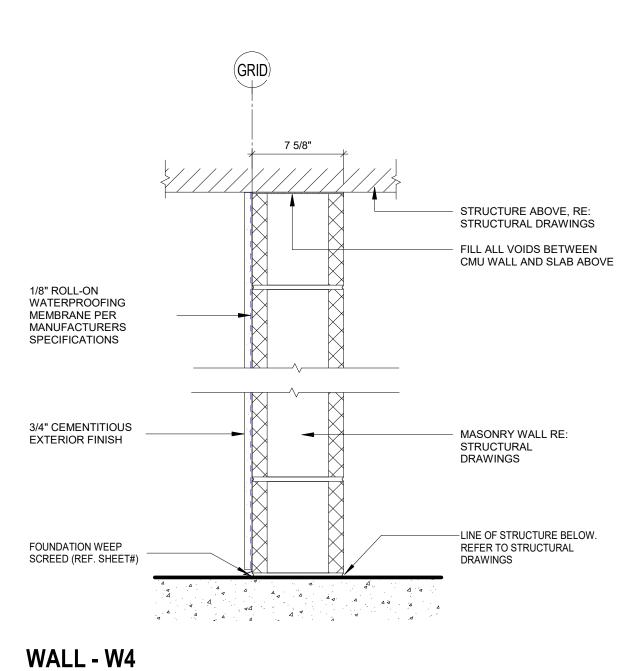
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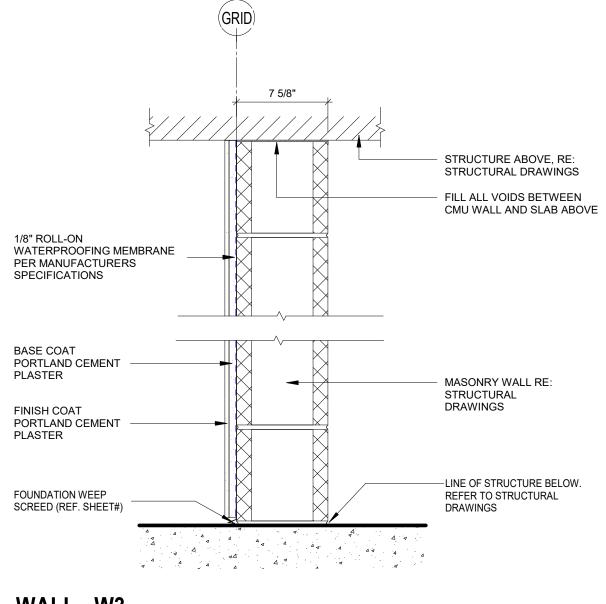
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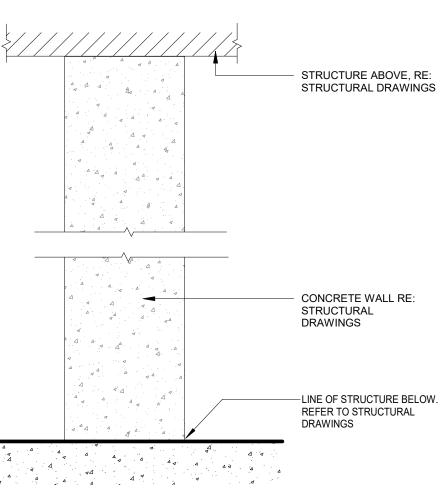
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SCALE: 1 1/2" = 1'-0"







SCALE: 1 1/2" = 1'-0"

WALL - W3 SCALE: 1 1/2" = 1'-0"

SCALE: 1 1/2" = 1'-0"

SITE PLAN NOTES

THIS SITE PLAN IS FOR REFERENCE PURPOSES ONLY, PLEASE REFER TO SITE PLAN PREPARED BY THE LANDSCAPE ARCHITECT AND CIVIL ENGINEER DRAWINGS FOR ADDITIONAL SITE INFORMATION.



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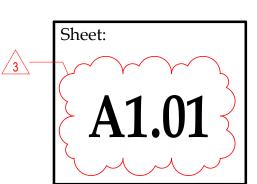
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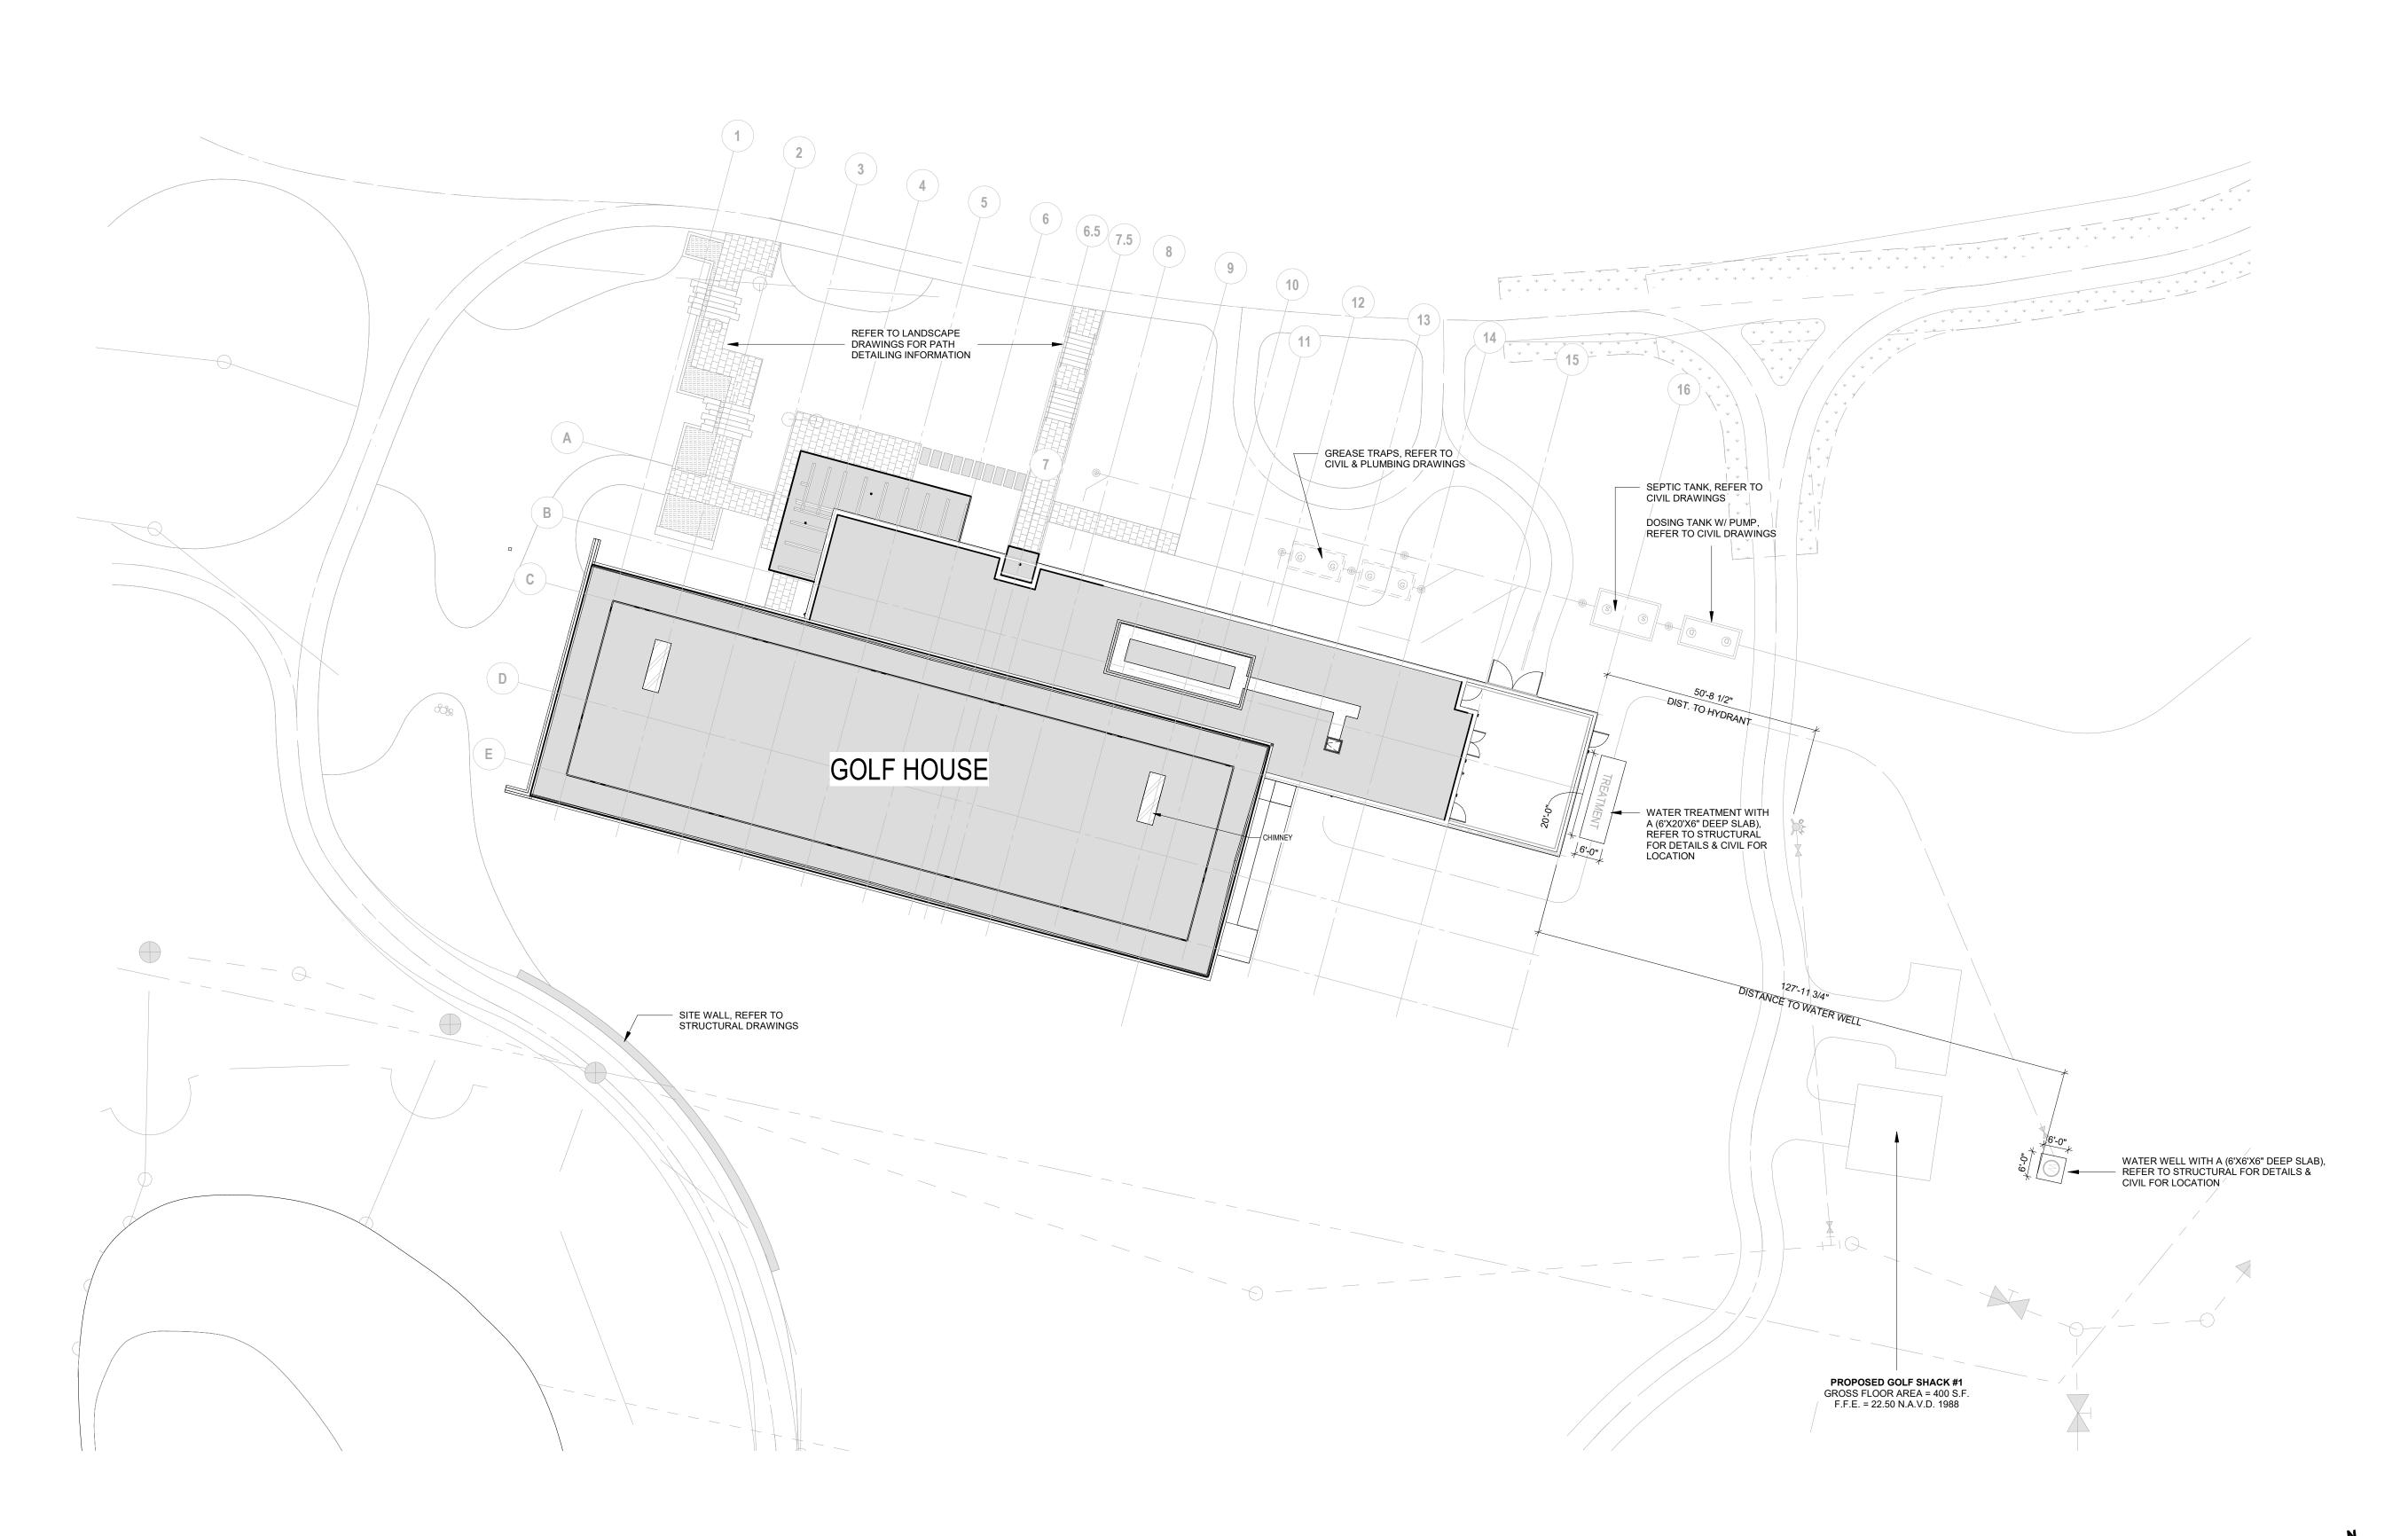
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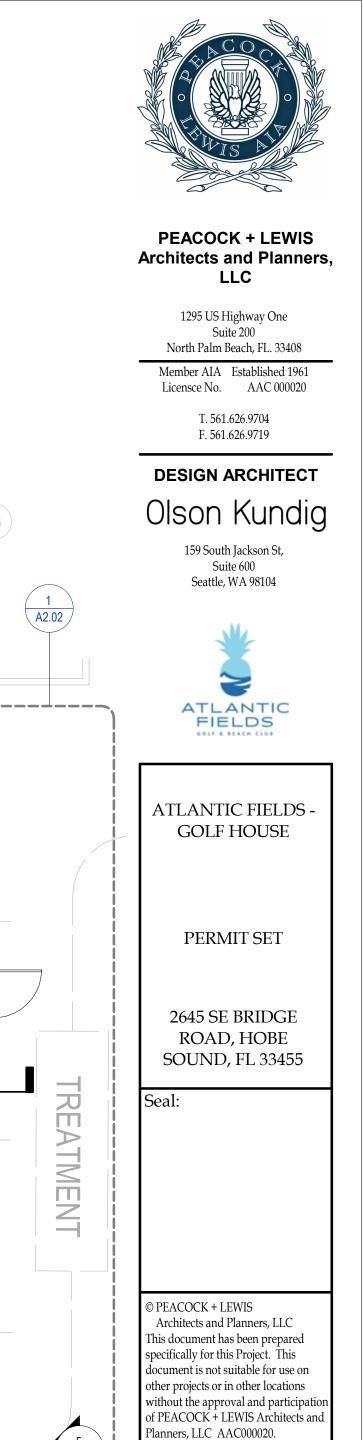
SITE PLAN

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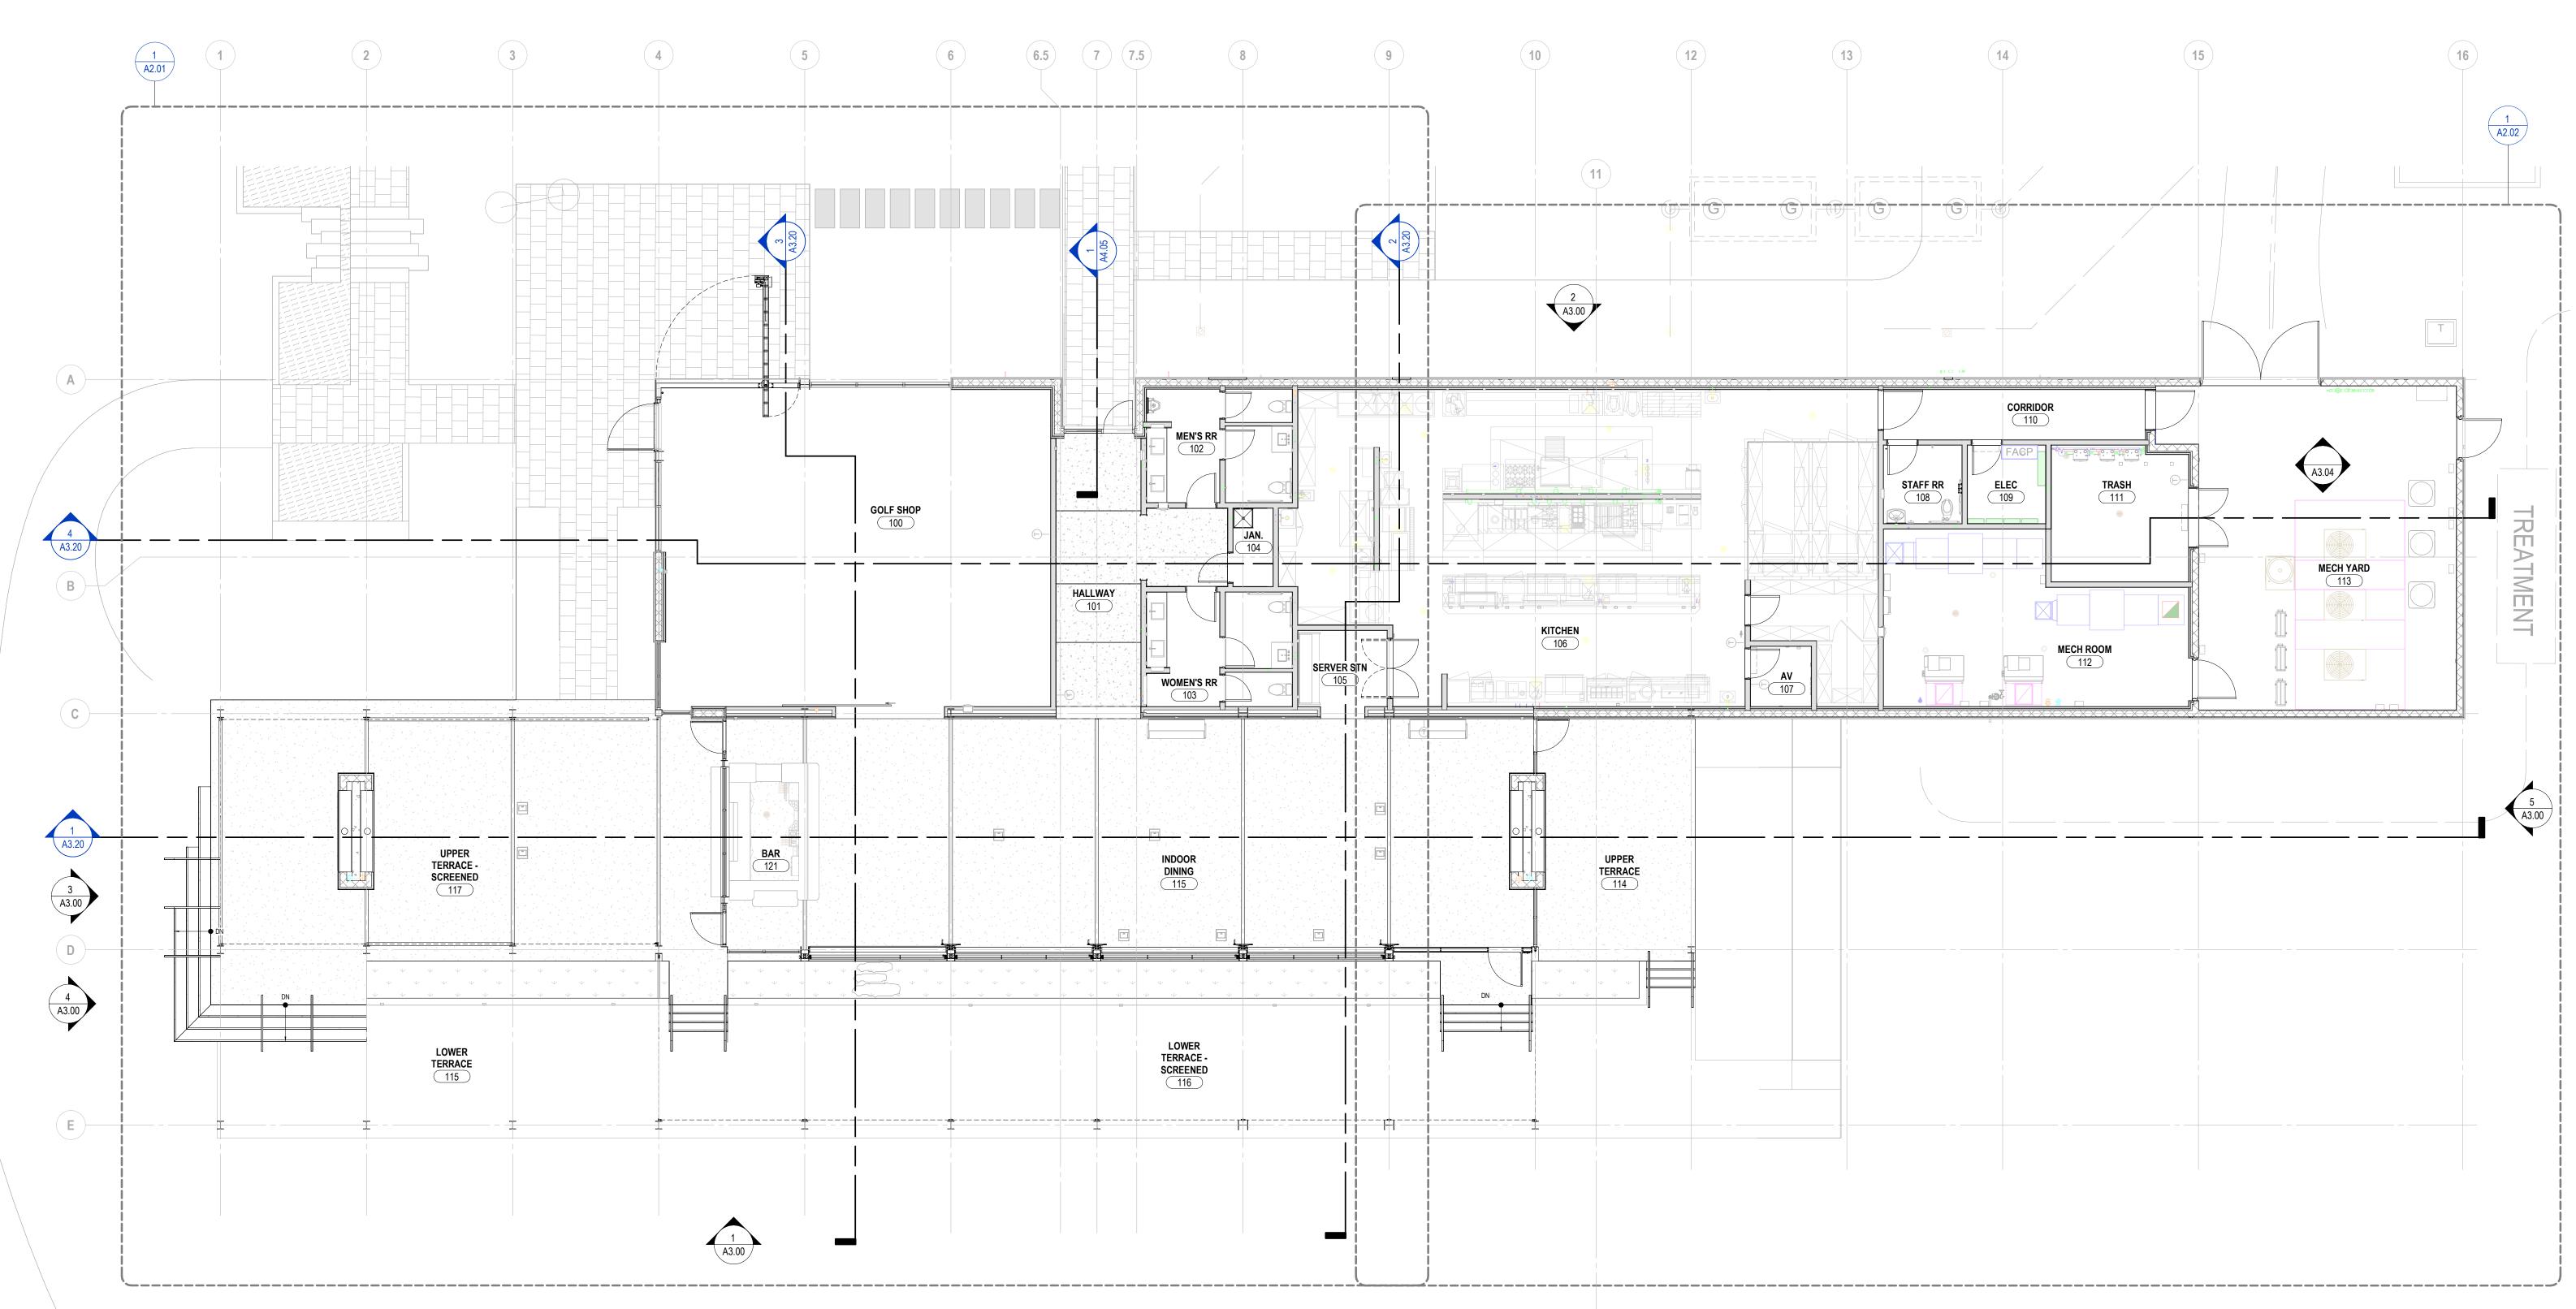



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OVERALL MAIN LEVEL FLOOR PLAN

No.DescriptionDate3Addendum #103.22.2024 Comm: 22-061

Checked: Drawn By:



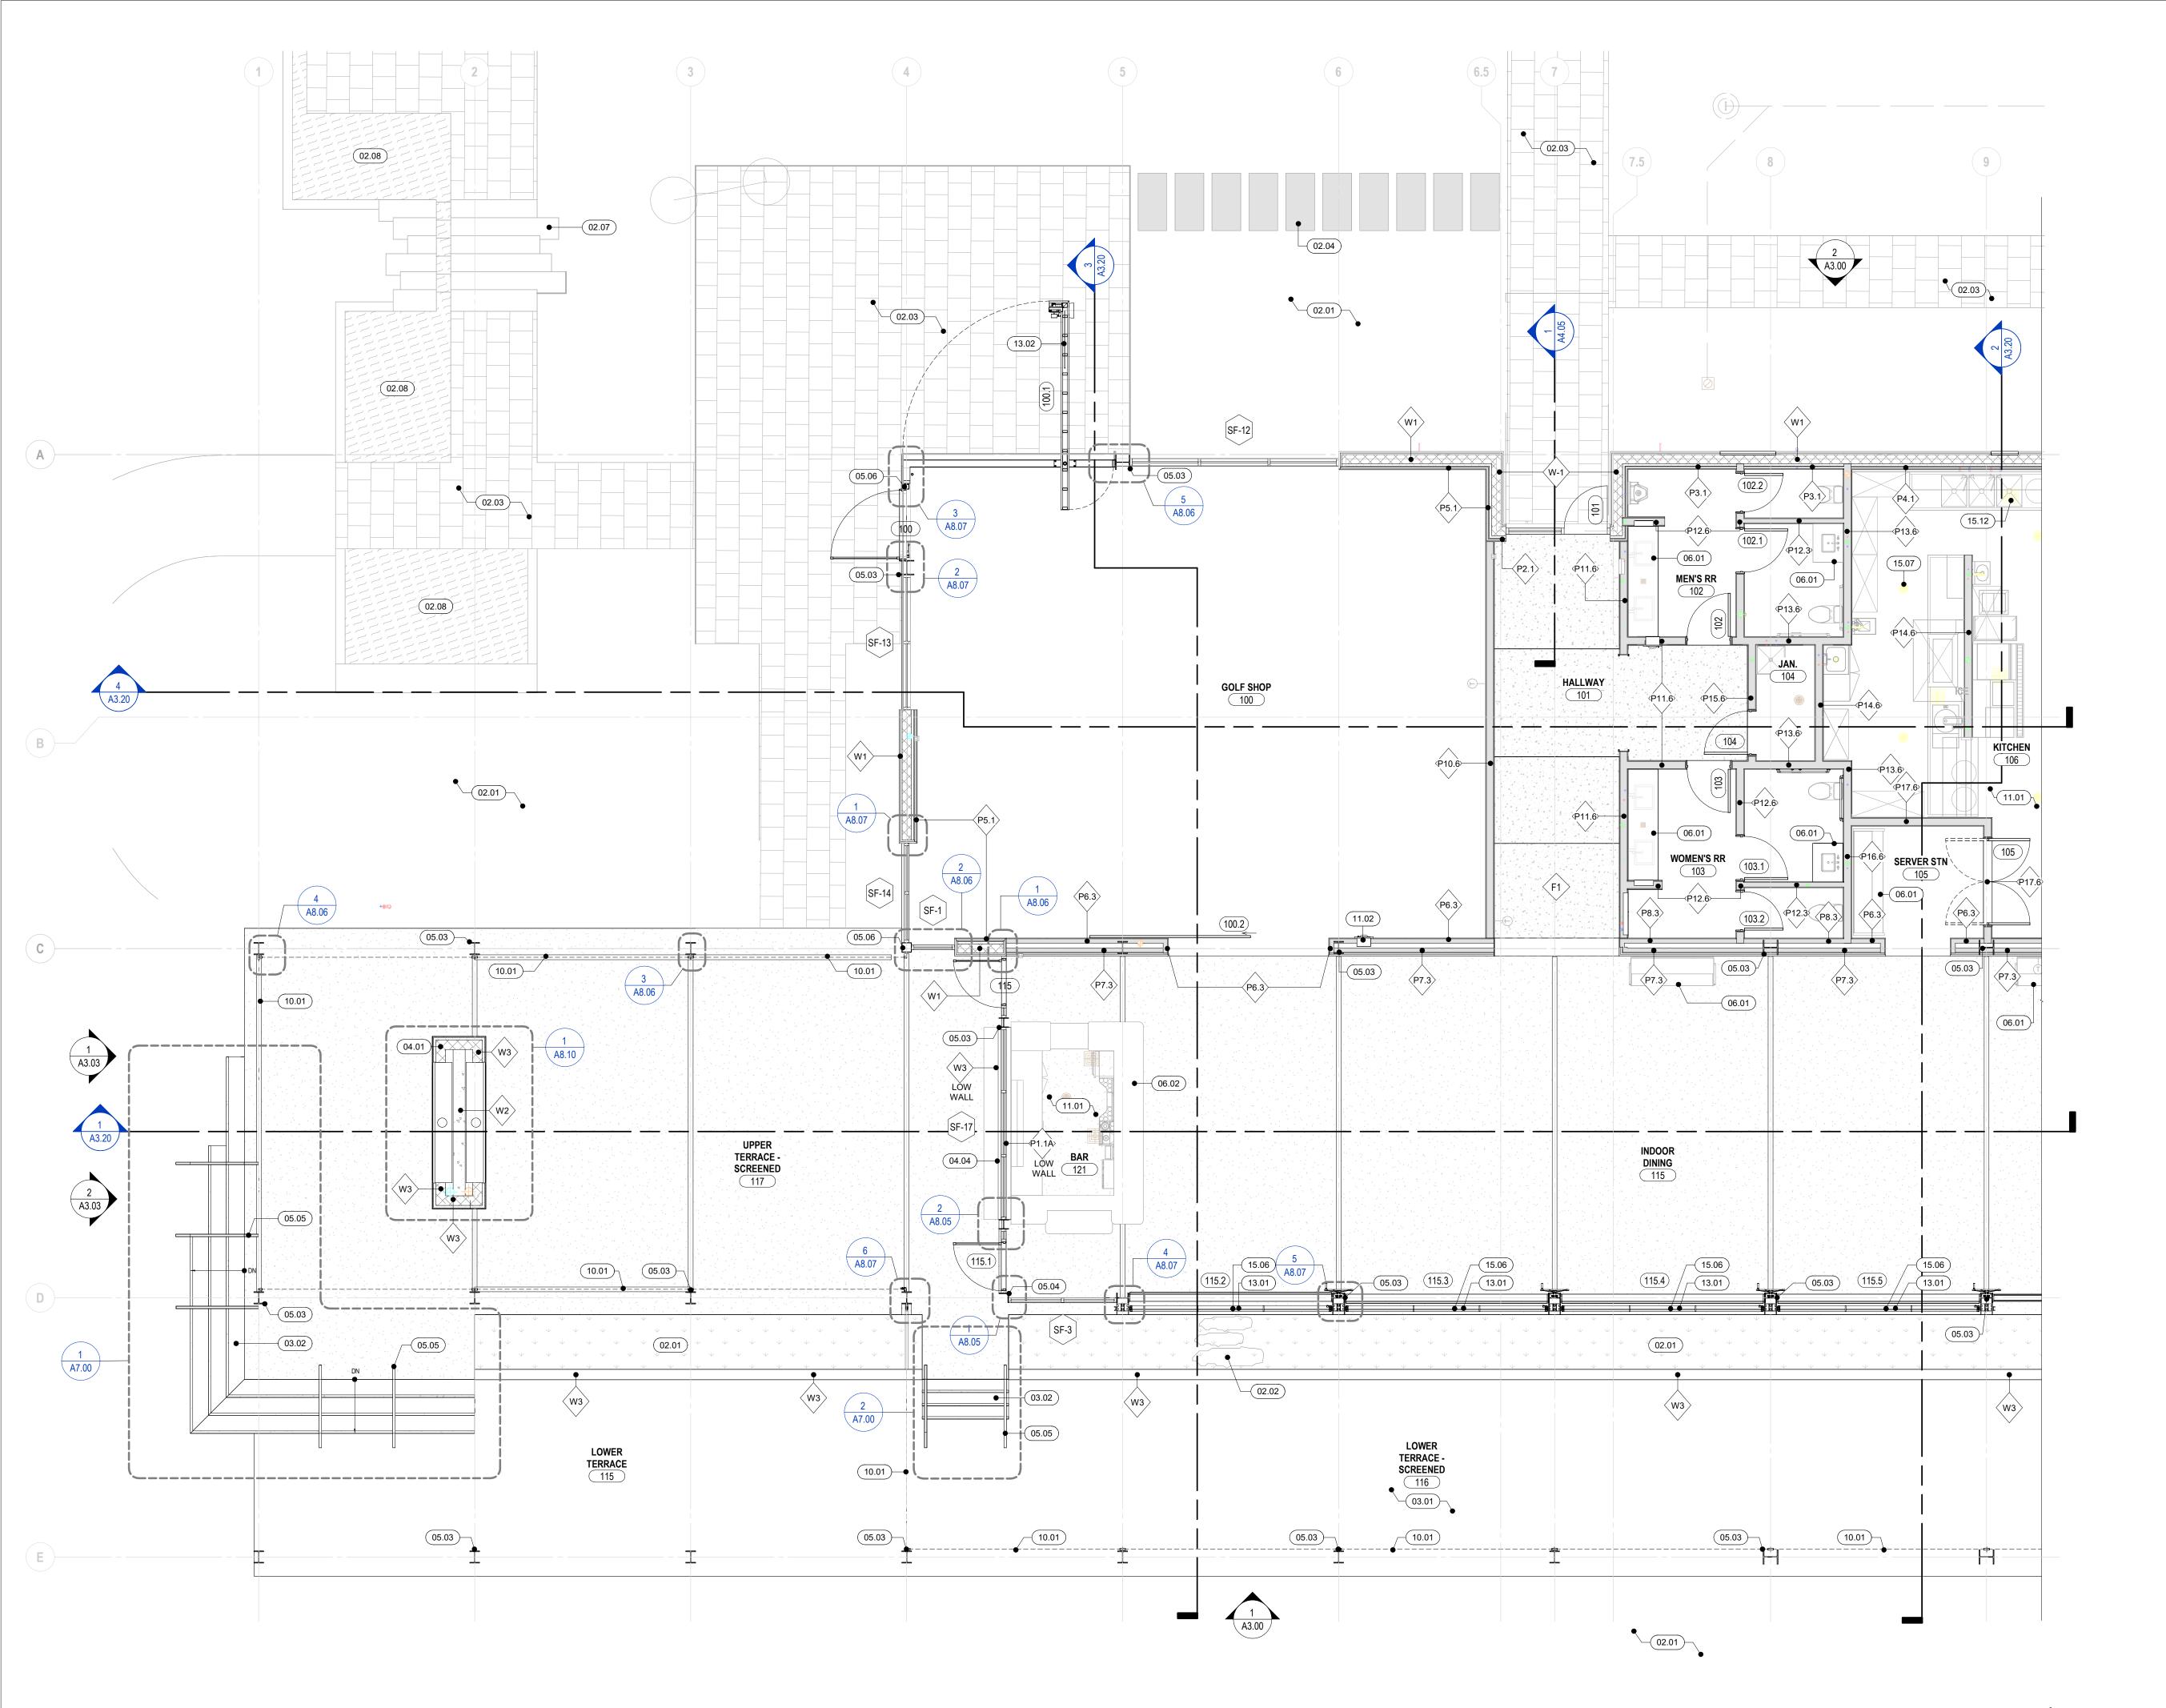

MAIN LEVEL PARTIAL PLAN A SCALE: 3/16" = 1'-0"



FLOOR PLAN NOTES

A. GENERAL CONTRACTOR TO PROVIDE BLOCKING MATERIAL.

B. PROVIDE JAMB EXTENSIONS WHERE REQUIRED.

C. ALL WINDOW SIZES SHOWN ARE NOMINAL. CONTRACTOR SHALL FIELD VERIFY ALL ROUGH OPENINGS, PRIOR TO ORDERING.

D. CONTRACTOR SHALL MEET ALL STATE & LOCAL CODES FOR WIND LOADS & ATTACHMENT REQUIREMENTS.

E. VERIFY & COORDINATE INTERIOR DOOR SELECTIONS WITH INTERIOR DESIGNER/OWNER.

F. CONTRACTOR SHALL PROVIDE WINDOW SHOP DRAWINGS TO ARCHITECT FOR APPROVAL PRIOR TO PROCEEDING W/ WORK AND ORDERING OF WINDOWS.

G. CONTRACTOR SHALL PROVIDE DOOR/ WINDOW HARDWARE SCHEDULE TO ARCHITECT/OWNER FOR APPROVAL PRIOR TO PROCEEDING W/ WORK.

H. PROVIDE STRUCTURAL MULLIONS FOR LARGE OPENINGS.

I. ALL DOORS & HARDWARE SHALL COMPLY WITH SECTION 11 OF FBC 2020.

J. ALL FOOD SERVING AND STORAGE AREAS SHALL HAVE CEMENTITIOUS URETHANE EPOXY

K. ALL INTERIOR CONCRETE SLAB ON GRADE SHALL RECIEVE VB-250 VAPOR BARRIER (BARRIER-BAC) OR BETTER

FLOOR PLAN KEY NOTES

DIVISION 2 - SITE CONSTRUCTION

02.01 LANDSCAPING/PLANTING, SEE LANDSCAPE DRAWINGS
02.02 STONE FEATURE, SEE LANDSCAPE DRAWINGS
02.03 12"x24"x3/4" THICK STONE PLANKS MORTARED OVER 2" MORTAR SETTING BED OVER CRACK SUPPRESSION OVER CONCRETE SLAB OVER AGGREGATE BASE OVER COMPACTED OR UNDISTURBED SUBRAGE (RE: SEE LANDSCAPES DRAWINGS DETAILS 2/L3.01)

02.04 2" THICK LIMESTONE TOP OF STONE 1" ABOVE FINISHED GRADE OVER 2 1/2" COMPACTED SAND BASE OVER COMPACTED OR UNDISTURBED SUBGRADE. (RE: SEE LANDSCAPE DRAWINGS DETAIL

02.05 LIMESTONE STAIR TREAD, TYP. (RE; SEE LANDSCAPE DRAWINGS DETAIL 1/L3.02) 02.06 HANDRAIL (RE: LANDSCAPE DRAWINGS DETAIL 2/L3.02)

02.07 WATER FEATURE STAIR TREADS (RE: SEE LANDSCAPE DRAWINGS)

02.08 WATER FEATURE (RE: SEE LANDSCAPE DRAWINGS DETAILS 5/L3.01, 6/L3.01, & 4/L3.02)

DIVISION 3 - CONCRETE

03.01 4" CONCRETE SLAB-ON-GRADE ON 10MIL VAPOR BARRIER BAC (VB-240 OR EQUAL) ON COMPACTED TREATED SUB SOIL TYP. (RE: STRUCTURAL DRAWINGS) (RE: INTERIOR DESIGN DRAWINGS FOR FINISH SPECIFICATIONS)

03.02 CONCRETE STAIRS W/ RAILINGS, SEE STRUCTURAL DRAWINGS & ARCH SHEET A7.00 FOR DETAILED INFORMATION (RE: STRUCTURAL DRAWINGS) (RE: INTERIOR DESIGN DRAWINGS FO

FINISH SPECIFICATIONS) 03.03 CONCRETE RAMP (RE: STRUCTURAL DRAWINGS & ARCH SHEET A7.01 FOR DETAILED

INFORMATION) (RE: INTERIOR DESIGN DRAWINGS FOR FINISH SPECIFICATIONS)

04.01 MASONRY WALL UNIT (RE: STRUCTURAL DRAWINGS) (RE: ARCH WALL TYPES & PARTIAL PLAN FOR MORE INFORMATION)

04.02 LOW WALL (RE: STRUCTURAL DRAWINGS) (RE: ARCH DETAIL 1/A8.11) 04.03 SHEAR WALL (RE: STRUCTURAL DRAWINGS)

04.04 PILASTER SYSTEM OVER MASONRY WALL UNIT UNDER BAR COUNTERTOP (RE: STRUCTURAL

DIVISION 5 - METALS

DIVISION 4 - MANSONRY

05.01 MTL STUDS (RE: WAL TYPES), EXTEND FROM FINISH FLOOR & UP TO UNDERSIDE OF STRUCTURE ABOVE, TYP.

05.02 METAL ROOF ACCESS LADDER O'KEEFFE'S STANDARD 500 SERIES

05.03 STEEL WIDE FLANGE COLUMN (RE: STRUCTURAL DRAWINGS) 05.04 STEEL L COLUMN (RE: STRUCTÙRAL DRAWINGS)

05.05 STEEL HANDRAIL (RE ARCH A7.00 SHEET) 05.06 STEEL TUBE COLUMN (RE: STRUCTURAL DRAWINGS)

DIVISION 6 - WOODS AND PLASTICS

06.01 MILLWORK (RE: INTERIOR DESIGN DRAWINGS) 06.02 BAR (RE: INTERIOR DRAWINGS)

DIVISION 7 - THERMALS AND MOISTURE PROTECTION NOT USED.

DIVISION 8 - DOOR AND WINDOWS

08.01 NOT USED

08.02 NOT USED 08.03 NOT USED

08.04 NOT USED 08.05 IMPACT RATED SERVER SLIDING DOOR SYSTEM

08.06 SPECALITY MEDIUM DUTY RESTAURANT DOOR 08.07 IMPACT RATED YARD GATE BY CITYSCAPES TOUGHGATES METAL INFILL SERIES PLANAR COLOR TO MATCH STEEL

DIVISION 9 - FINISHES

DIVISION 10 - SPECIALTIES

10.01 MAGNATRACK W/ PROGRESSIVE BUG SCREEN SYSTEM, SEE ELECTRICAL FOR FOR MOTOR AND POWER DETAILS

DIVISION 11 - EQUIPMENT

11.01 FOOD SERVICE EQUIPMENT (RE: FOOD SERVICE & ENGINEERING DOCUMENTS) 11.02 FIRE EXTINGUISHER, SEE LIFE SAFETY PLAN

DIVISION 12 - FURNISHINGS

NOT USED

DIVISION 13 - SPECIAL CONSTRUCTION

13.01 SITE SPECIFIC DELEGATED ENGINEERED IMPACT RATED GUILLOTINE DOOR SYSTEM (RE: KINETICS & STRUCTURAL DRAWINGS) 13.02 SITE SPECIFIC DELEGATED ENGINEERED IMPACT PIVOT DOOR SYSTEM (RE: KINETICS & STRUCTURAL DRAWINGS)

DIVISION 14 - CONVEYING SYSTEMS

NOT USED

DIVISION 15 - MECHANICAL / PLUMBING

15.01 ABOVE DOOR HVAC INDOOR WALL MOUNTED SPLIT SYSTEM, SEE MECHANICAL DRAWINGS

15.02 MAKE UP AIR UNIT, SEE MECHANICAL DRAWINGS 15.03 AIR HANDLER UNIT SYSTEM, SEE MECHANICAL DRAWINGS

15.04 SPLIT SYSTEM OUTDOOR CONDENSING UNIT, SEE MECHANICAL DRAWINGS 15.05 SPLIT SYSTEM HEAT PUMP UNIT, SEE MECHANICAL DRAWINGS 15.06 REMOVABLE LONG ZURN ZA880-300B TRENCH DRAIN FOR CLEANING, FASTEN TO FLOOR

STAINLESS STEEL @ EA KINETIC DOOR SILL, DRAIN INTO PLANTER BELOW (RE: STRUCTURAI PLUMBING. & KINETIC DRAWINGS)

15.07 FLOOR DRAIN, SEE PLUMBING DRAWINGS 15.08 HEAVY DUTY FLOOR DRAINS, SEE PLUMBING & KITCHEN DRAWINGS

15.09 HOSE BIB, SEE PLUMBING DRAWINGS

15.10 WALL MOUNTED HOT WATER HEATER, SEE PLUMBING DRAWINGS 15.11 NOT USED

15.12 NOT USED **DIVISION 16 - ELECTRICAL**

16.01 ELECTRICAL PANEL BOARD SURFACE MOUNTED, SEE ELECTRICAL DRAWINGS 16.02 ELECTRICAL I-LINE PANEL BOARD SURFACE MOUNTED, DEE ELECTRICAL DRAWINGS 16.03 FIRE ALARM CONTROL PANEL SURFACE MOUNTED, SEE ELECTRICAL DRAWINGS

16.04 DISCONNECT SWITCHES, SEE ELECTRICAL DRAWINGS 16.05 NOT USED

16.06 NOT USED 16.07 NOT USED

16.08 NOT USED

DIVISION 21 - ELECTRICAL 21.01 4" FIRE SPRINKLER RISER, SEE FIRE PROTECTION DRAWINGS



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DESIGN ARCHITECT Olson Kundig



ATLANTIC FIELDS -**GOLF HOUSE**

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orohibited. MAIN LEVEL PARTIAL PLAN

Io. Description Date

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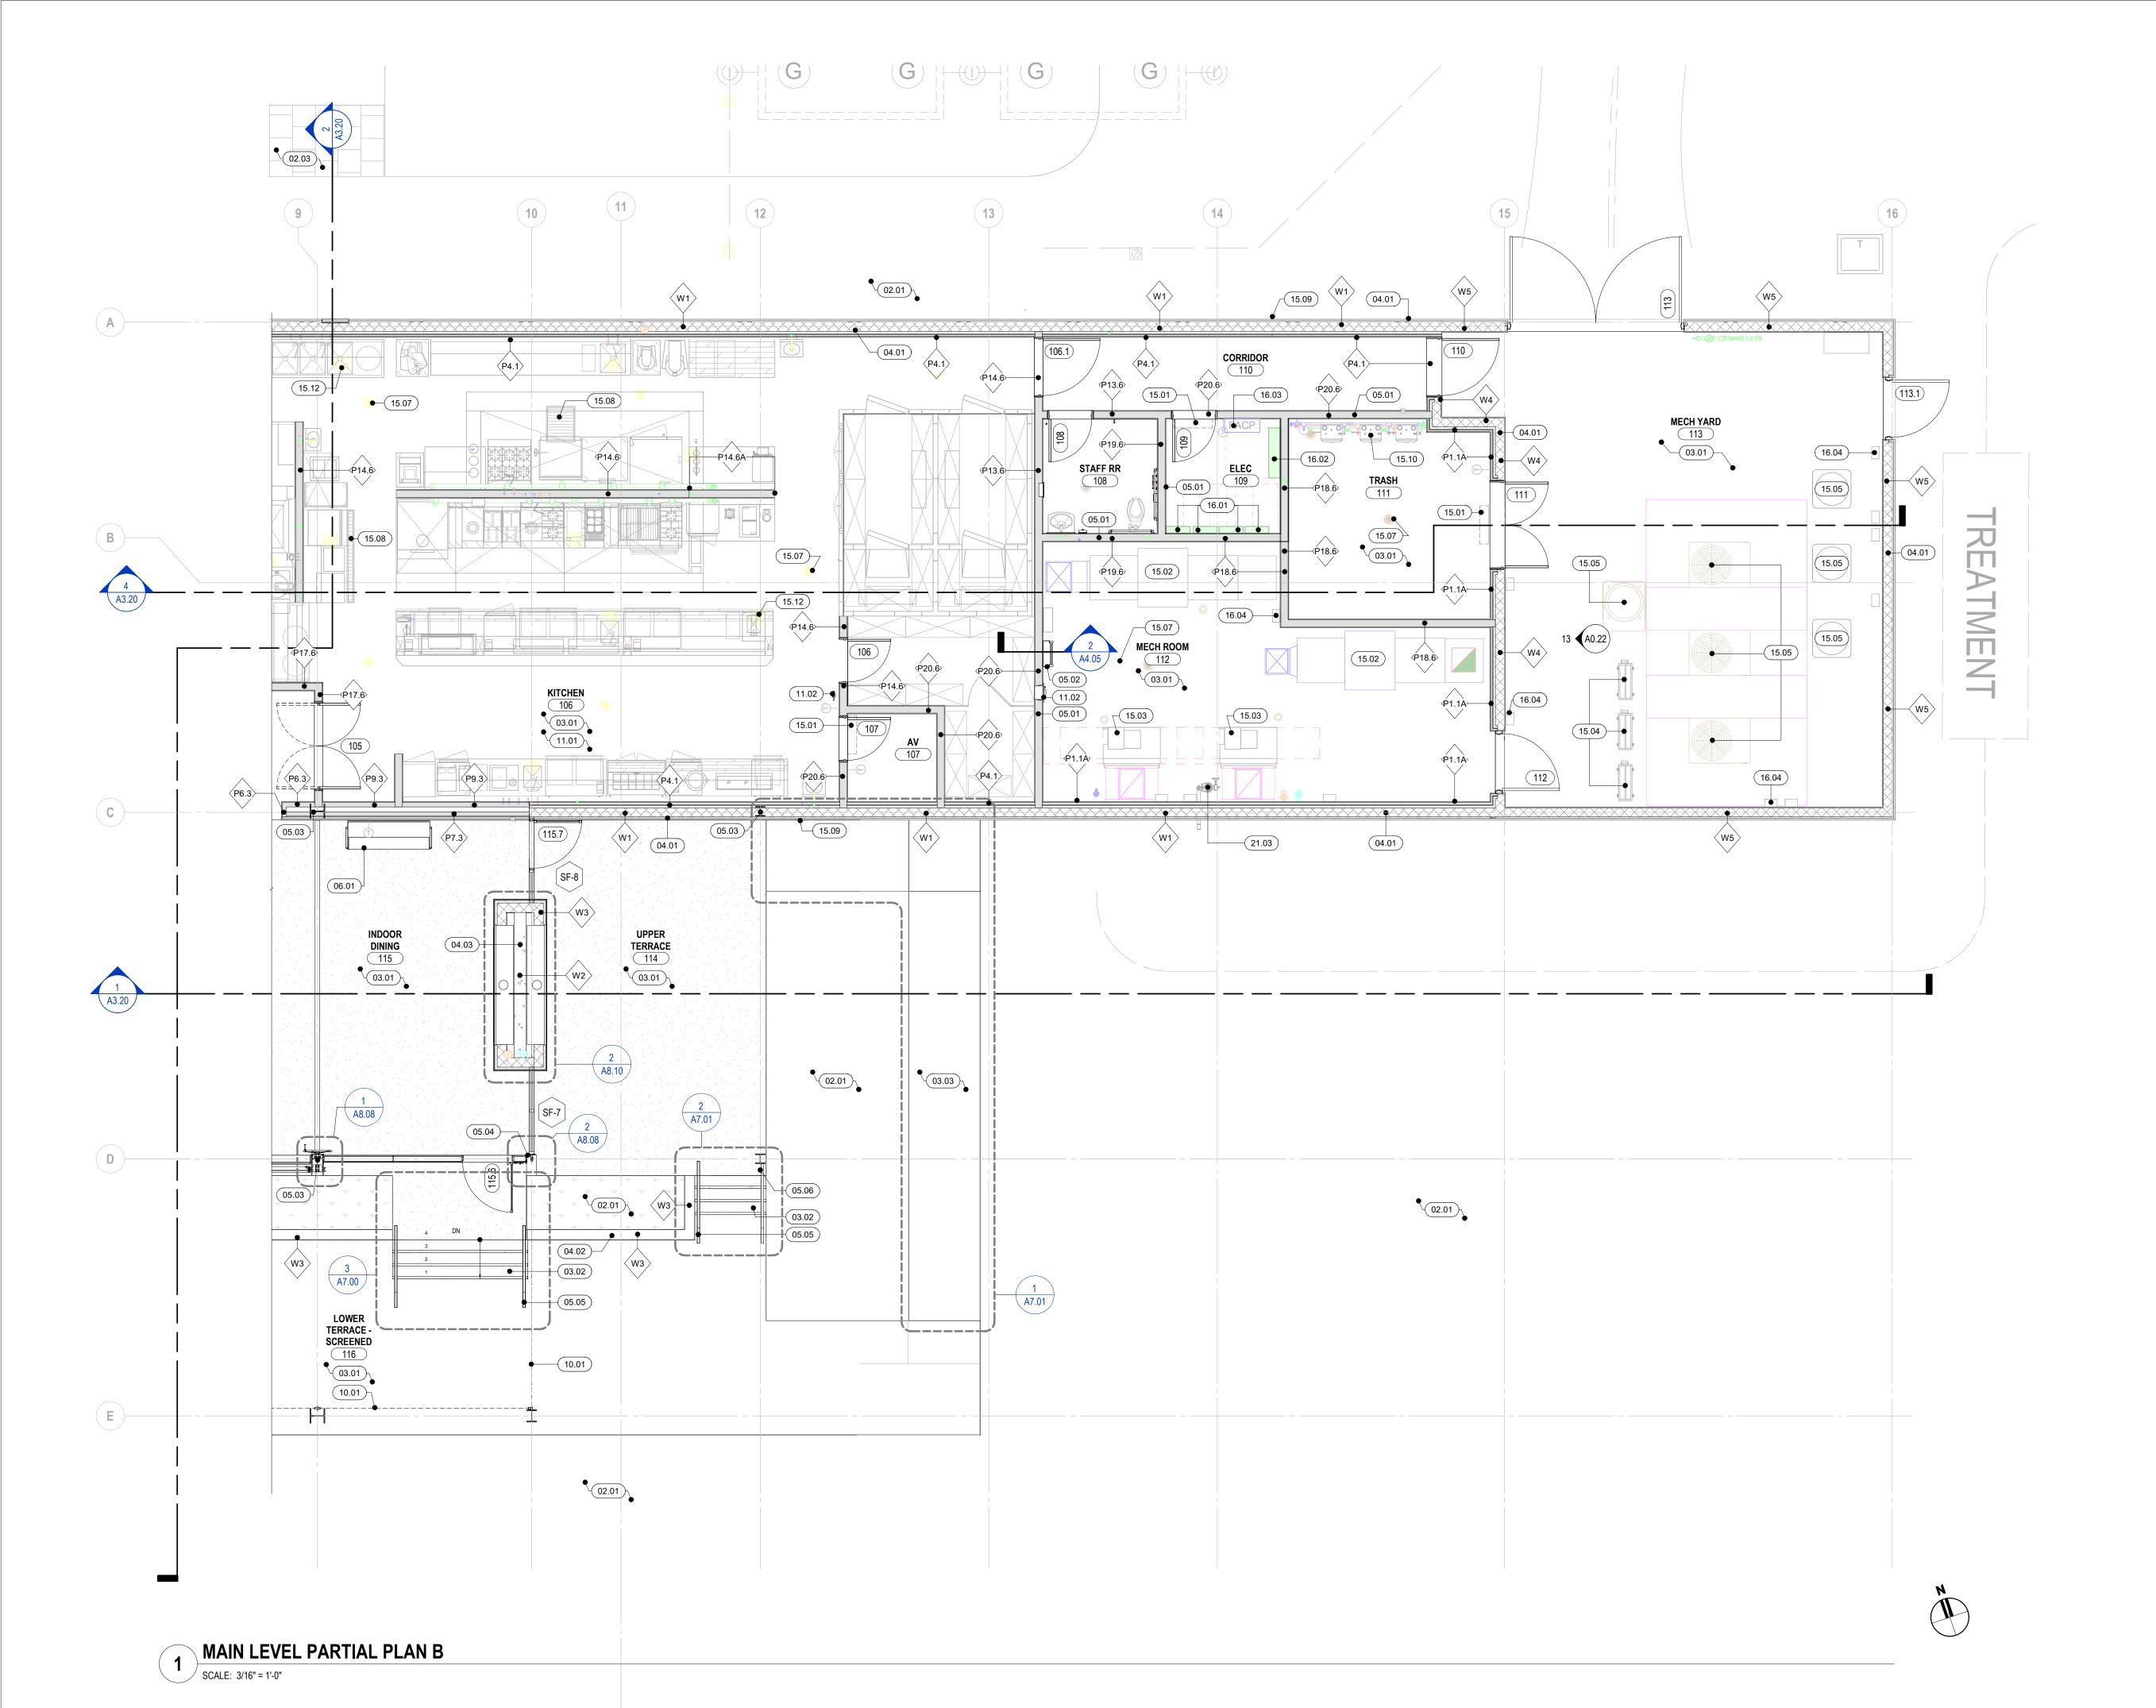
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11.01.2023





FLOOR PLAN NOTES

A. GENERAL CONTRACTOR TO PROVIDE BLOCKING MATERIAL.

B. PROVIDE JAMB EXTENSIONS WHERE REQUIRED.

C. ALL WINDOW SIZES SHOWN ARE NOMINAL. CONTRACTOR SHALL FIELD VERIFY ALL ROUGH OPENINGS, PRIOR TO ORDERING.

D. CONTRACTOR SHALL MEET ALL STATE & LOCAL CODES FOR WIND LOADS & ATTACHMENT REQUIREMENTS.

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G. CONTRACTOR SHALL PROVIDE DOOR/ WINDOW HARDWARE SCHEDULE TO ARCHITECT/OWNER FOR APPROVAL PRIOR TO PROCEEDING W/ WORK.

H. PROVIDE STRUCTURAL MULLIONS FOR LARGE OPENINGS.

I. ALL DOORS & HARDWARE SHALL COMPLY WITH SECTION 11 OF FBC 2020.

J. ALL FOOD SERVING AND STORAGE AREAS SHALL HAVE CEMENTITIOUS URETHANE EPOXY $\,$

K. ALL INTERIOR CONCRETE SLAB ON GRADE SHALL RECIEVE VB-250 VAPOR BARRIER (BARRIER-BAC) OR BETTER

FLOOR PLAN KEY NOTES

DIVISION 2 - SITE CONSTRUCTION

02.01 LANDSCAPING/PLANTING, SEE LANDSCAPE DRAWINGS
02.02 STONE FEATURE, SEE LANDSCAPE DRAWINGS
02.03 12"x24"x3/4" THICK STONE PLANKS MORTARED OVER 2" MORTAR SETTING BED OVER CRACK SUPPRESSION OVER CONCRETE SLAB OVER AGGREGATE BASE OVER COMPACTED OR

UNDISTURBED SUBRAGE (RE: SEE LANDSCAPES DRAWINGS DETAILS 2/L3.01)
02.04 2" THICK LIMESTONE TOP OF STONE 1" ABOVE FINISHED GRADE OVER 2 1/2" COMPACTED SAND BASE OVER COMPACTED OR UNDISTURBED SUBGRADE. (RE: SEE LANDSCAPE DRAWINGS DETAIL

02.05 LIMESTONE STAIR TREAD, TYP. (RE; SEE LANDSCAPE DRAWINGS DETAIL 1/L3.02) 02.06 HANDRAIL (RE: LANDSCAPE DRAWINGS DETAIL 2/L3.02)

02.07 WATER FEATURE STAIR TREADS (RE: SEE LANDSCAPE DRAWINGS

02.08 WATER FEATURE (RE: SEE LANDSCAPE DRAWINGS DETAILS 5/L3.01, 6/L3.01, & 4/L3.02)

03.01 4" CONCRETE SLAB-ON-GRADE ON 10MIL VAPOR BARRIER BAC (VB-240 OR EQUAL) ON COMPACTED TREATED SUB SOIL TYP. (RE: STRUCTURAL DRAWINGS) (RE: INTERIOR DESIGN DRAWINGS FOR FINISH SPECIFICATIONS)
03.02 CONCRETE STAIRS W/ RAILINGS, SEE STRUCTURAL DRAWINGS & ARCH SHEET A7.00 FOR

DETAILED INFORMATION (RE: STRUCTURAL DRAWINGS) (RE: INTERIOR DESIGN DRAWINGS FO FINISH SPECIFICATIONS)

03.03 CONCRETE RAMP (RE: STRUCTURAL DRAWINGS & ARCH SHEET A7.01 FOR DETAILED

INFORMATION) (RE: INTERIOR DESIGN DRAWINGS FOR FINISH SPECIFICATIONS)

DIVISION 4 - MANSONRY

04.01 MASONRY WALL UNIT (RE: STRUCTURAL DRAWINGS) (RE: ARCH WALL TYPES & PARTIAL PLANS FOR MORE INFORMATION)

04.02 LOW WALL (RE: STRUCTURAL DRAWINGS) (RE: ARCH DETAIL 1/A8.11)

04.03 SHEAR WALL (RE: STRUCTURAL DRAWINGS)
04.04 PILASTER SYSTEM OVER MASONRY WALL UNIT UNDER BAR COUNTERTOP (RE: STRUCTURAL

DIVISION 5 - METALS

05.01 MTL STUDS (RE: WAL TYPES), EXTEND FROM FINISH FLOOR & UP TO UNDERSIDE OF

05.02 METAL ROOF ACCESS LADDER O'KEEFFE'S STANDARD 500 SERIES 05.03 STEEL WIDE FLANGE COLUMN (RE: STRUCTURAL DRAWINGS)

05.04 STEEL L COLUMN (RE: STRUCTURAL DRAWINGS) 05.05 STEEL HANDRAIL (RE ARCH A7.00 SHEET)

05.06 STEEL TUBE COLUMN (RE: STRUCTURAL DRAWINGS)

DIVISION 6 - WOODS AND PLASTICS

06.01 MILLWORK (RE: INTERIOR DESIGN DRAWINGS) 06.02 BAR (RE: INTERIOR DRAWINGS)

DIVISION 7 - THERMALS AND MOISTURE PROTECTION

DIVISION 8 - DOOR AND WINDOWS

08.01 NOT USED

08.02 NOT USED 08.03 NOT USED

08.04 NOT USED 08.05 IMPACT RATED SERVER SLIDING DOOR SYSTEM 08.06 SPECALITY MEDIUM DUTY RESTAURANT DOOR

08.07 IMPACT RATED YARD GATE BY CITYSCAPES TOUGHGATES METAL INFILL SERIES PLANAR COLOR TO MATCH STEEL

DIVISION 9 - FINISHES

DIVISION 10 - SPECIALTIES

10.01 MAGNATRACK W/ PROGRESSIVE BUG SCREEN SYSTEM, SEE ELECTRICAL FOR FOR MOTOR AND without the approval and participation POWER DETAILS

DIVISION 11 - EQUIPMENT

11.01 FOOD SERVICE EQUIPMENT (RE: FOOD SERVICE & ENGINEERING DOCUMENTS) 11.02 FIRE EXTINGUISHER, SEE LIFE SAFETY PLAN

DIVISION 12 - FURNISHINGS

NOT USED

DIVISION 13 - SPECIAL CONSTRUCTION

13.01 SITE SPECIFIC DELEGATED ENGINEERED IMPACT RATED GUILLOTINE DOOR SYSTEM (RE: KINETICS & STRUCTURAL DRAWINGS) 13.02 SITE SPECIFIC DELEGATED ENGINEERED IMPACT PIVOT DOOR SYSTEM (RE: KINETICS & STRUCTURAL DRAWINGS)

DIVISION 14 - CONVEYING SYSTEMS

NOT USED

DIVISION 15 - MECHANICAL / PLUMBING

15.01 ABOVE DOOR HVAC INDOOR WALL MOUNTED SPLIT SYSTEM, SEE MECHANICAL DRAWINGS 15.02 MAKE UP AIR UNIT, SEE MECHANICAL DRAWINGS

15.03 AIR HANDLER UNIT SYSTEM, SEE MECHANICAL DRAWINGS 15.04 SPLIT SYSTEM OUTDOOR CONDENSING UNIT, SEE MECHANICAL DRAWINGS

15.05 SPLIT SYSTEM HEAT PUMP UNIT, SEE MECHANICAL DRAWINGS 15.06 REMOVABLE LONG ZURN ZA880-300B TRENCH DRAIN FOR CLEANING, FASTEN TO FLOOR STAINLESS STEEL @ EA KINETIC DOOR SILL, DRAIN INTO PLANTER BELOW (RE: STRUCTURAL,

PLUMBING, & KINETIC DRAWINGS) 15.07 FLOOR DRAIN, SEE PLUMBING DRAWINGS

15.08 HEAVY DUTY FLOOR DRAINS, SEE PLUMBING & KITCHEN DRAWINGS 15.09 HOSE BIB, SEE PLUMBING DRAWINGS

15.10 WALL MOUNTED HOT WATER HEATER, SEE PLUMBING DRAWINGS 15.11 NOT USED

15.12 NOT USED **DIVISION 16 - ELECTRICAL**

16.01 ELECTRICAL PANEL BOARD SURFACE MOUNTED, SEE ELECTRICAL DRAWINGS 16.02 ELECTRICAL I-LINE PANEL BOARD SURFACE MOUNTED, DEE ELECTRICAL DRAWINGS 16.03 FIRE ALARM CONTROL PANEL SURFACE MOUNTED, SEE ELECTRICAL DRAWINGS 16.04 DISCONNECT SWITCHES, SEE ELECTRICAL DRAWINGS


16.06 NOT USED

16.07 NOT USED

16.08 NOT USED

DIVISION 21 - ELECTRICAL


21.01 4" FIRE SPRINKLER RISER, SEE FIRE PROTECTION DRAWINGS

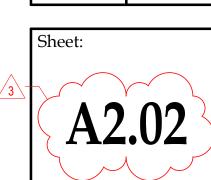

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22-061

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ATLANTIC

FIELDS

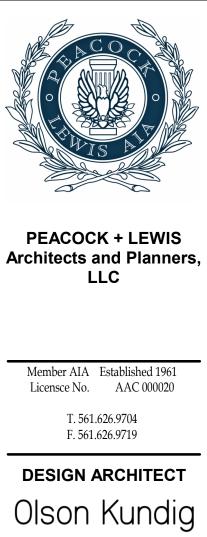ATLANTIC FIELDS -

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PARTIAL PLAN B

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Date:

11.01.2023

Checked:

MAIN LEVEL

Revisions:

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DIMENSION PLAN NOTES

- 1. ALL DIMENSIONS FOR CMU WALL ASSEMBLIES ARE FROM FACE OF CMU TO FACE OF CMU UNLESS NOTED OTHERWISE.
- 2. ALL DIMENSIONS TO METAL STUD ASSEMBLIES ARE TO FACE OF STUD TO FACE OF STUD UNLESS NOTED OTHERWISE.
- 3. FIELD VERIFY ALL DIMENSIONS, NOTIFY ARCHITECT OF ANY DISCREPANCIES PRIOR TO ANY CONSTRUCTION.



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ATLANTIC FIELDS **GOLF HOUSE**


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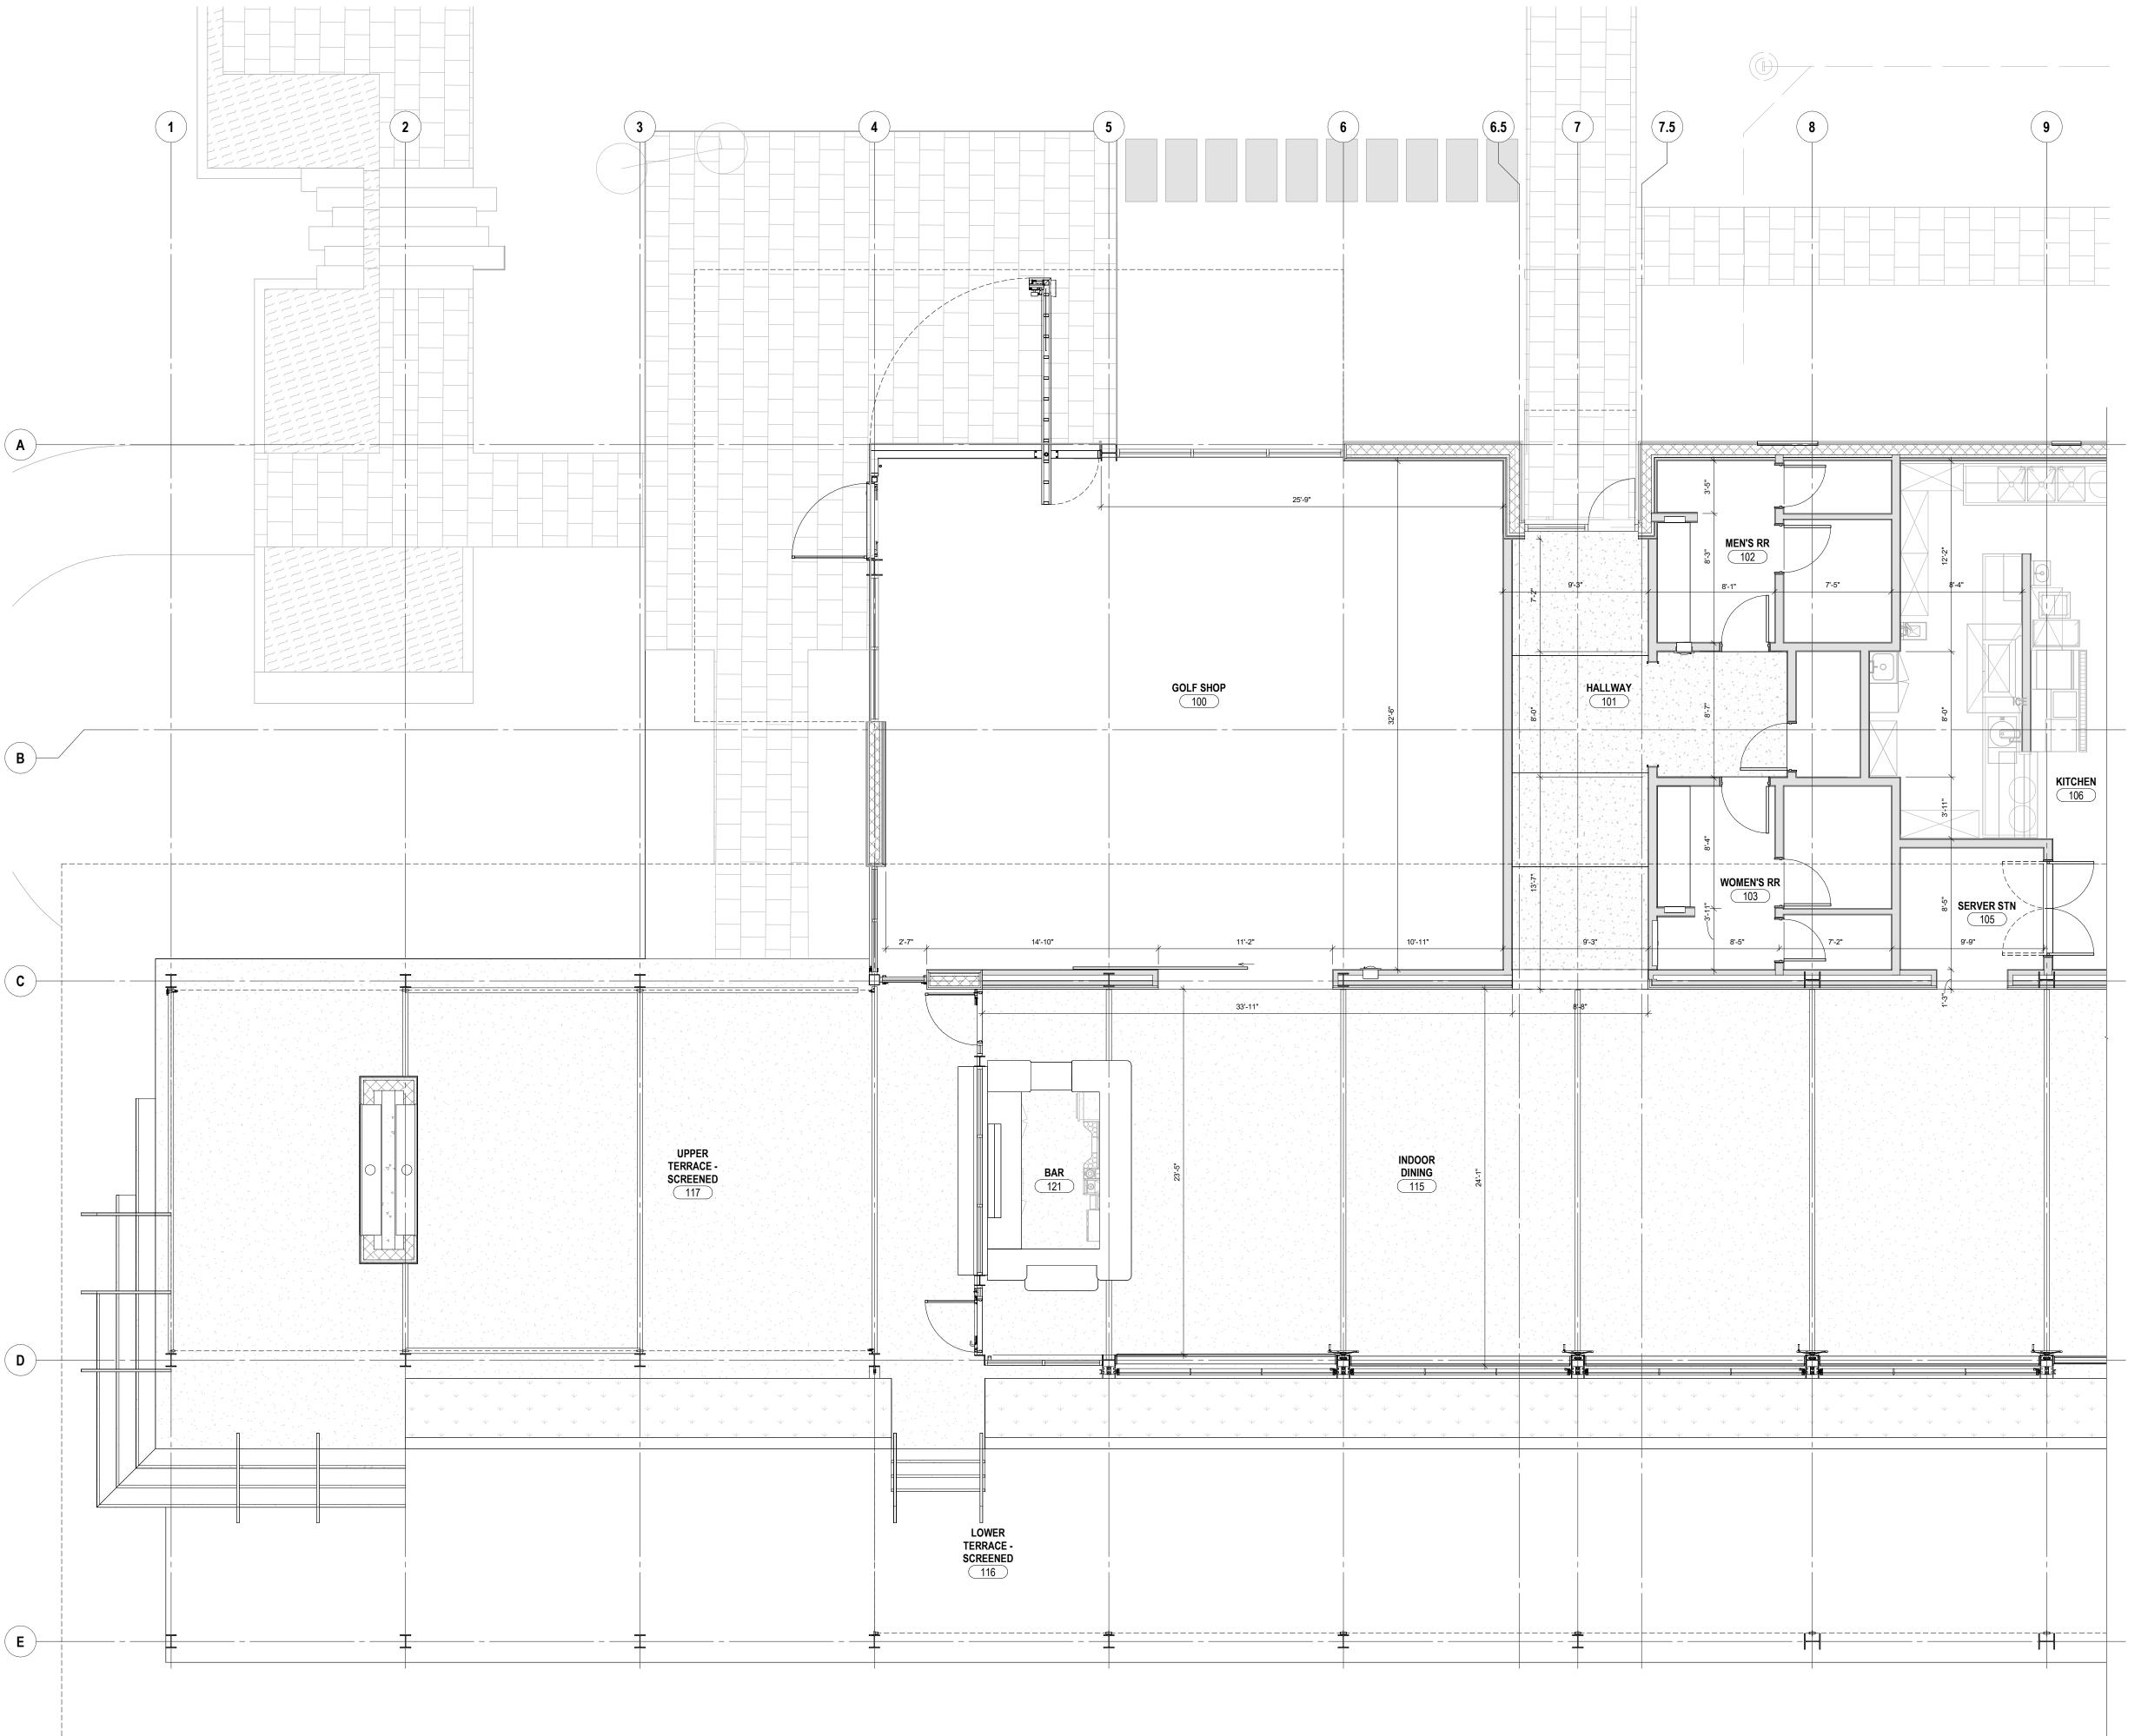
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OVERALL MAIN DIMENSION

Checked: Drawn By:





DIMENSION PLAN NOTES

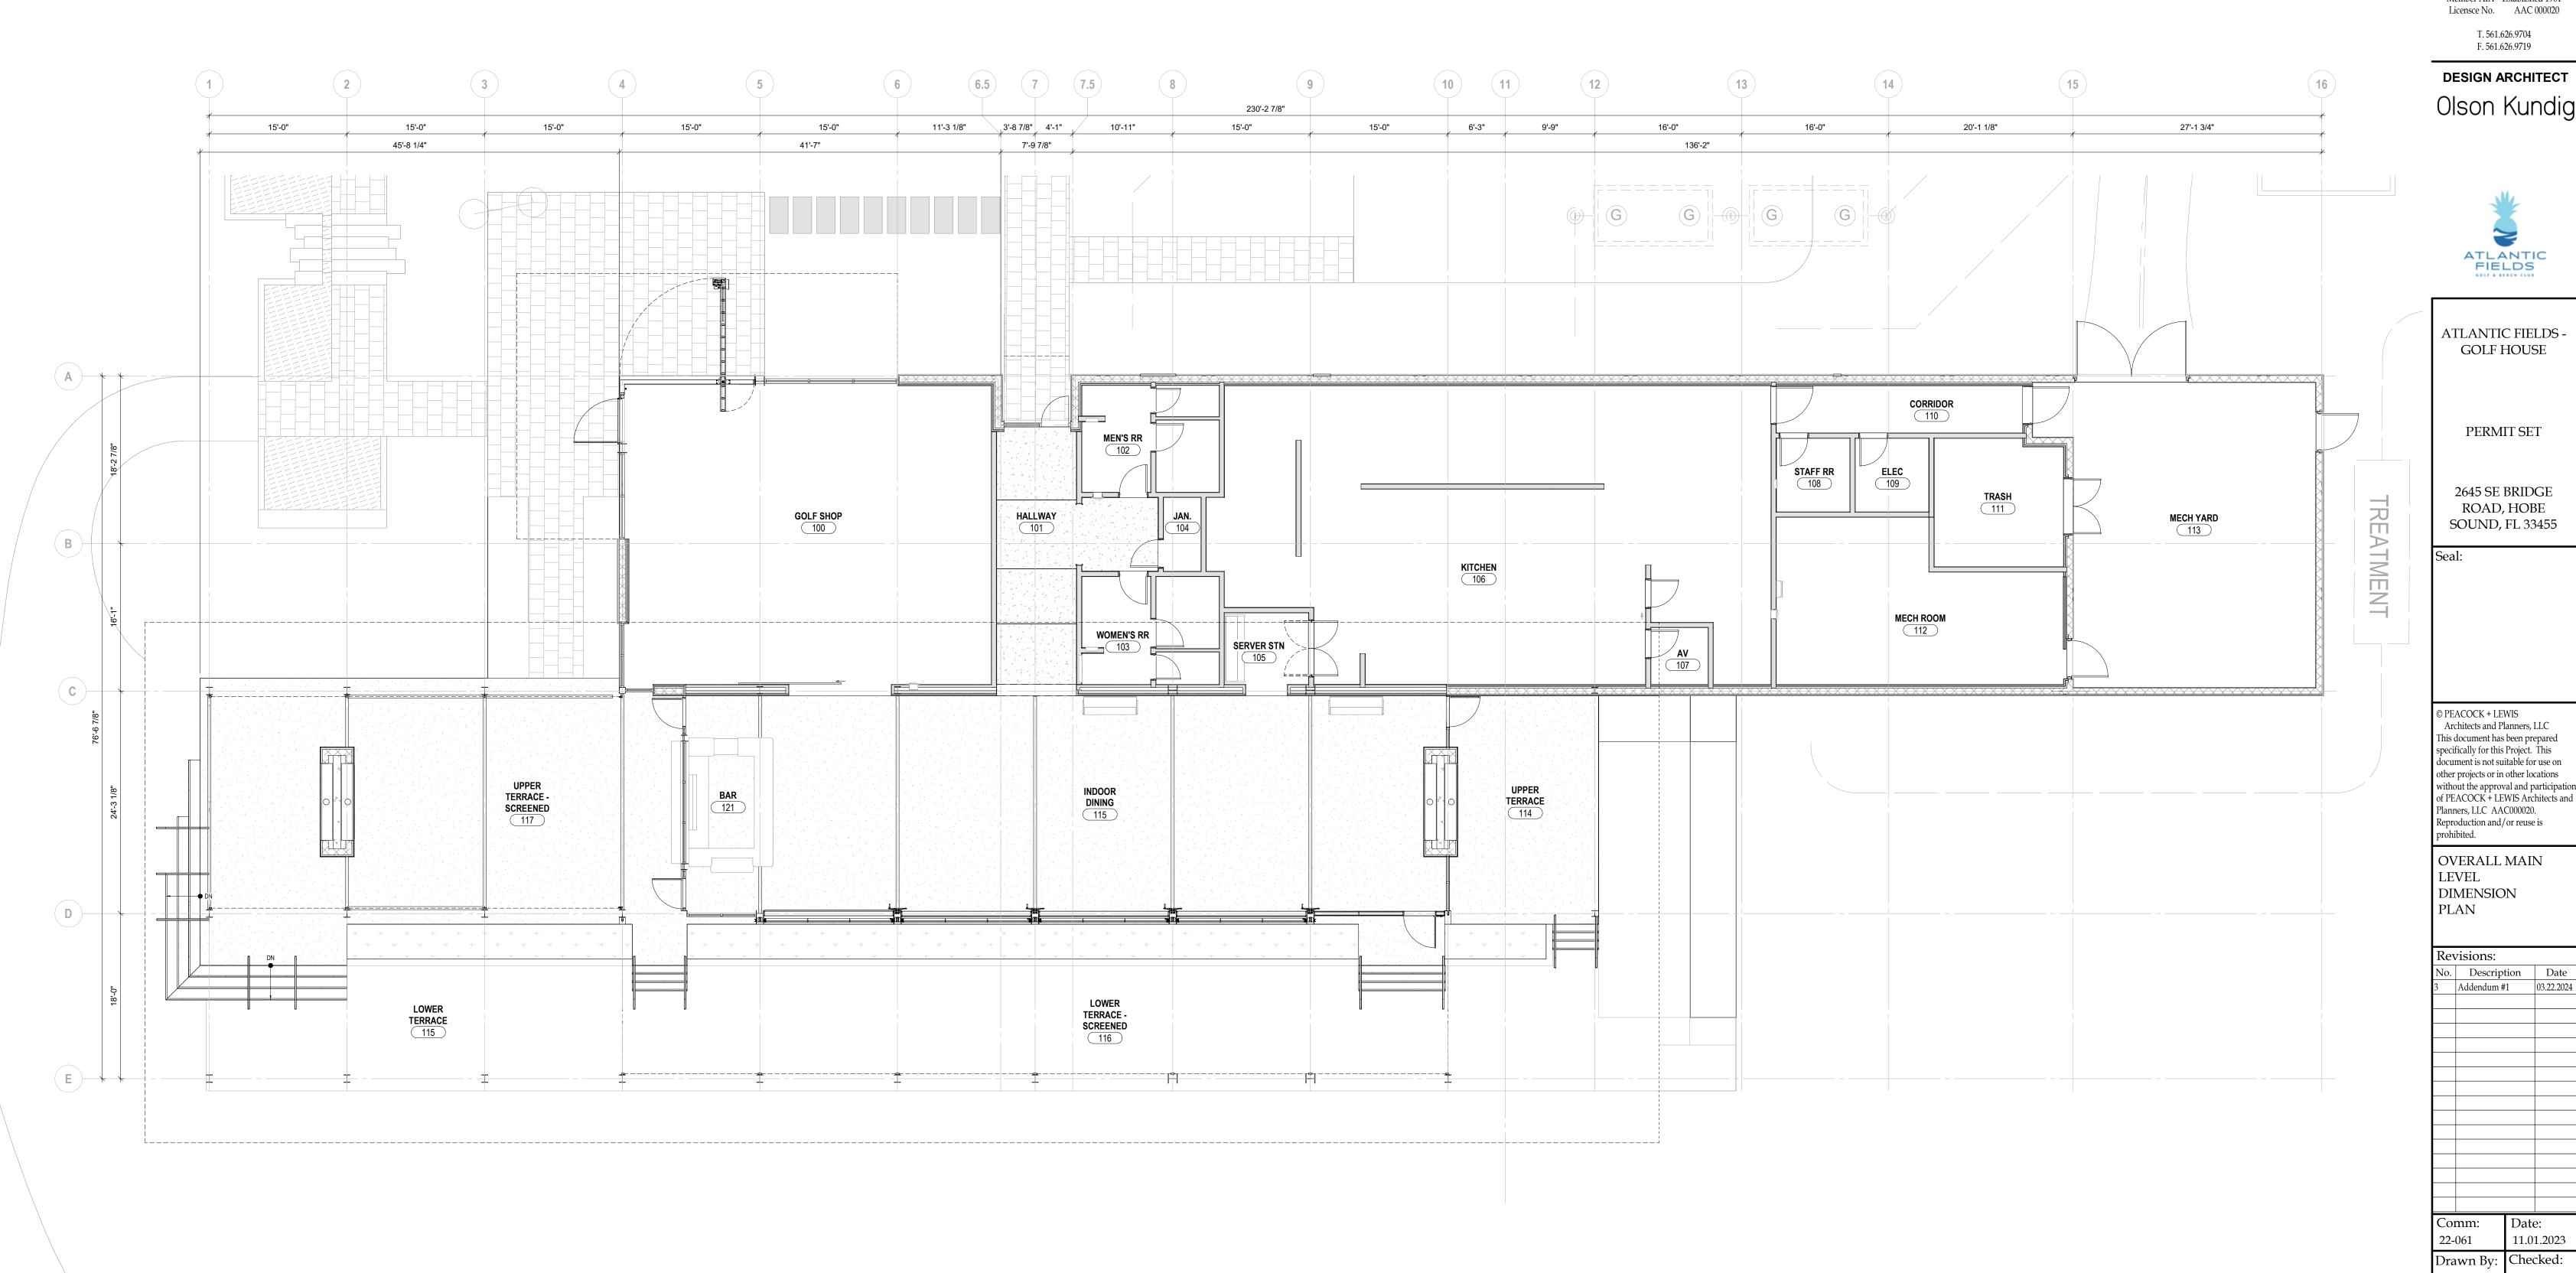- 1. ALL DIMENSIONS FOR CMU WALL ASSEMBLIES ARE FROM FACE OF CMU TO FACE OF CMU UNLESS NOTED OTHERWISE.
- 2. ALL DIMENSIONS TO METAL STUD ASSEMBLIES ARE TO FACE OF STUD TO FACE OF STUD UNLESS NOTED OTHERWISE.
- 3. FIELD VERIFY ALL DIMENSIONS, NOTIFY ARCHITECT OF ANY DISCREPANCIES PRIOR TO ANY CONSTRUCTION.



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DESIGN ARCHITECT Olson Kundig



ATLANTIC FIELDS GOLF HOUSE

PERMIT SET


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MAIN LEVEL PARTIAL DIMENSION PLAN A

Revisions: No. Description Date
Addendum #1 03.22.2024

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DIMENSION PLAN NOTES

- 1. ALL DIMENSIONS FOR CMU WALL ASSEMBLIES ARE FROM FACE OF CMU TO FACE OF CMU UNLESS NOTED OTHERWISE.
- 2. ALL DIMENSIONS TO METAL STUD ASSEMBLIES ARE TO FACE OF STUD TO FACE OF STUD UNLESS NOTED OTHERWISE.
- 3. FIELD VERIFY ALL DIMENSIONS, NOTIFY ARCHITECT OF ANY DISCREPANCIES PRIOR TO ANY CONSTRUCTION.

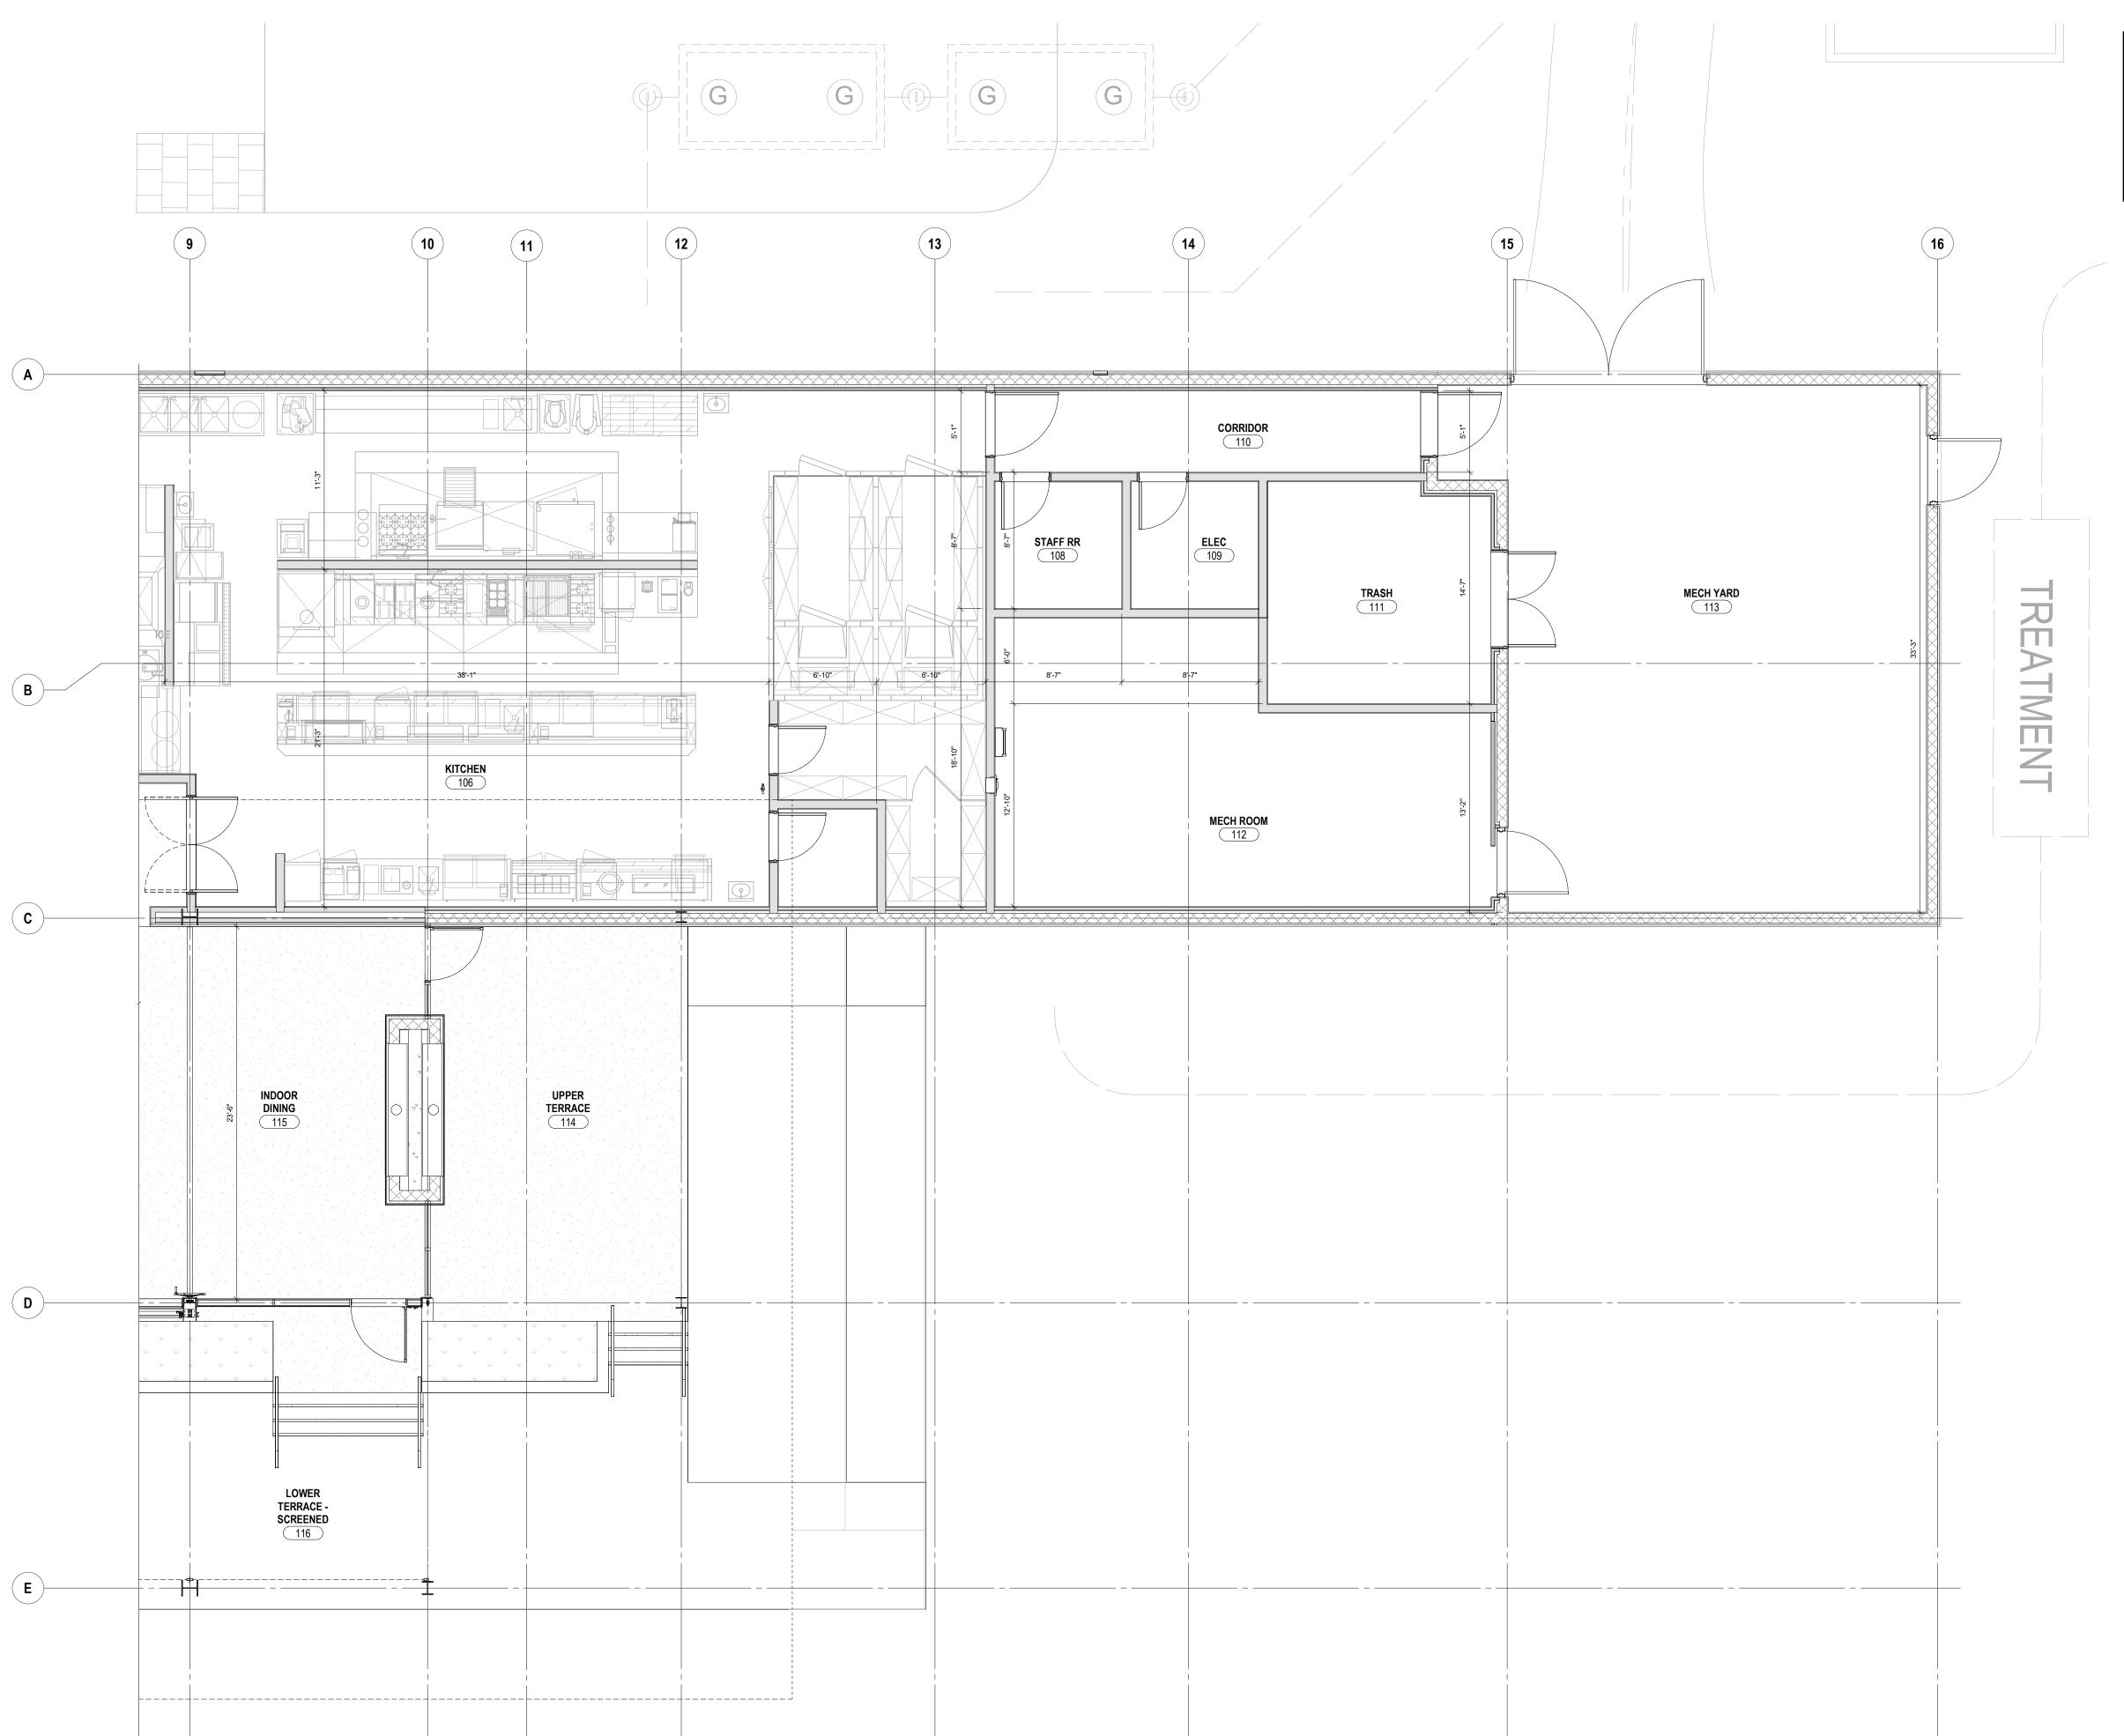

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Olson Kundig



ATLANTIC FIELDS - GOLF HOUSE

PERMIT SET

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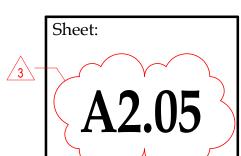
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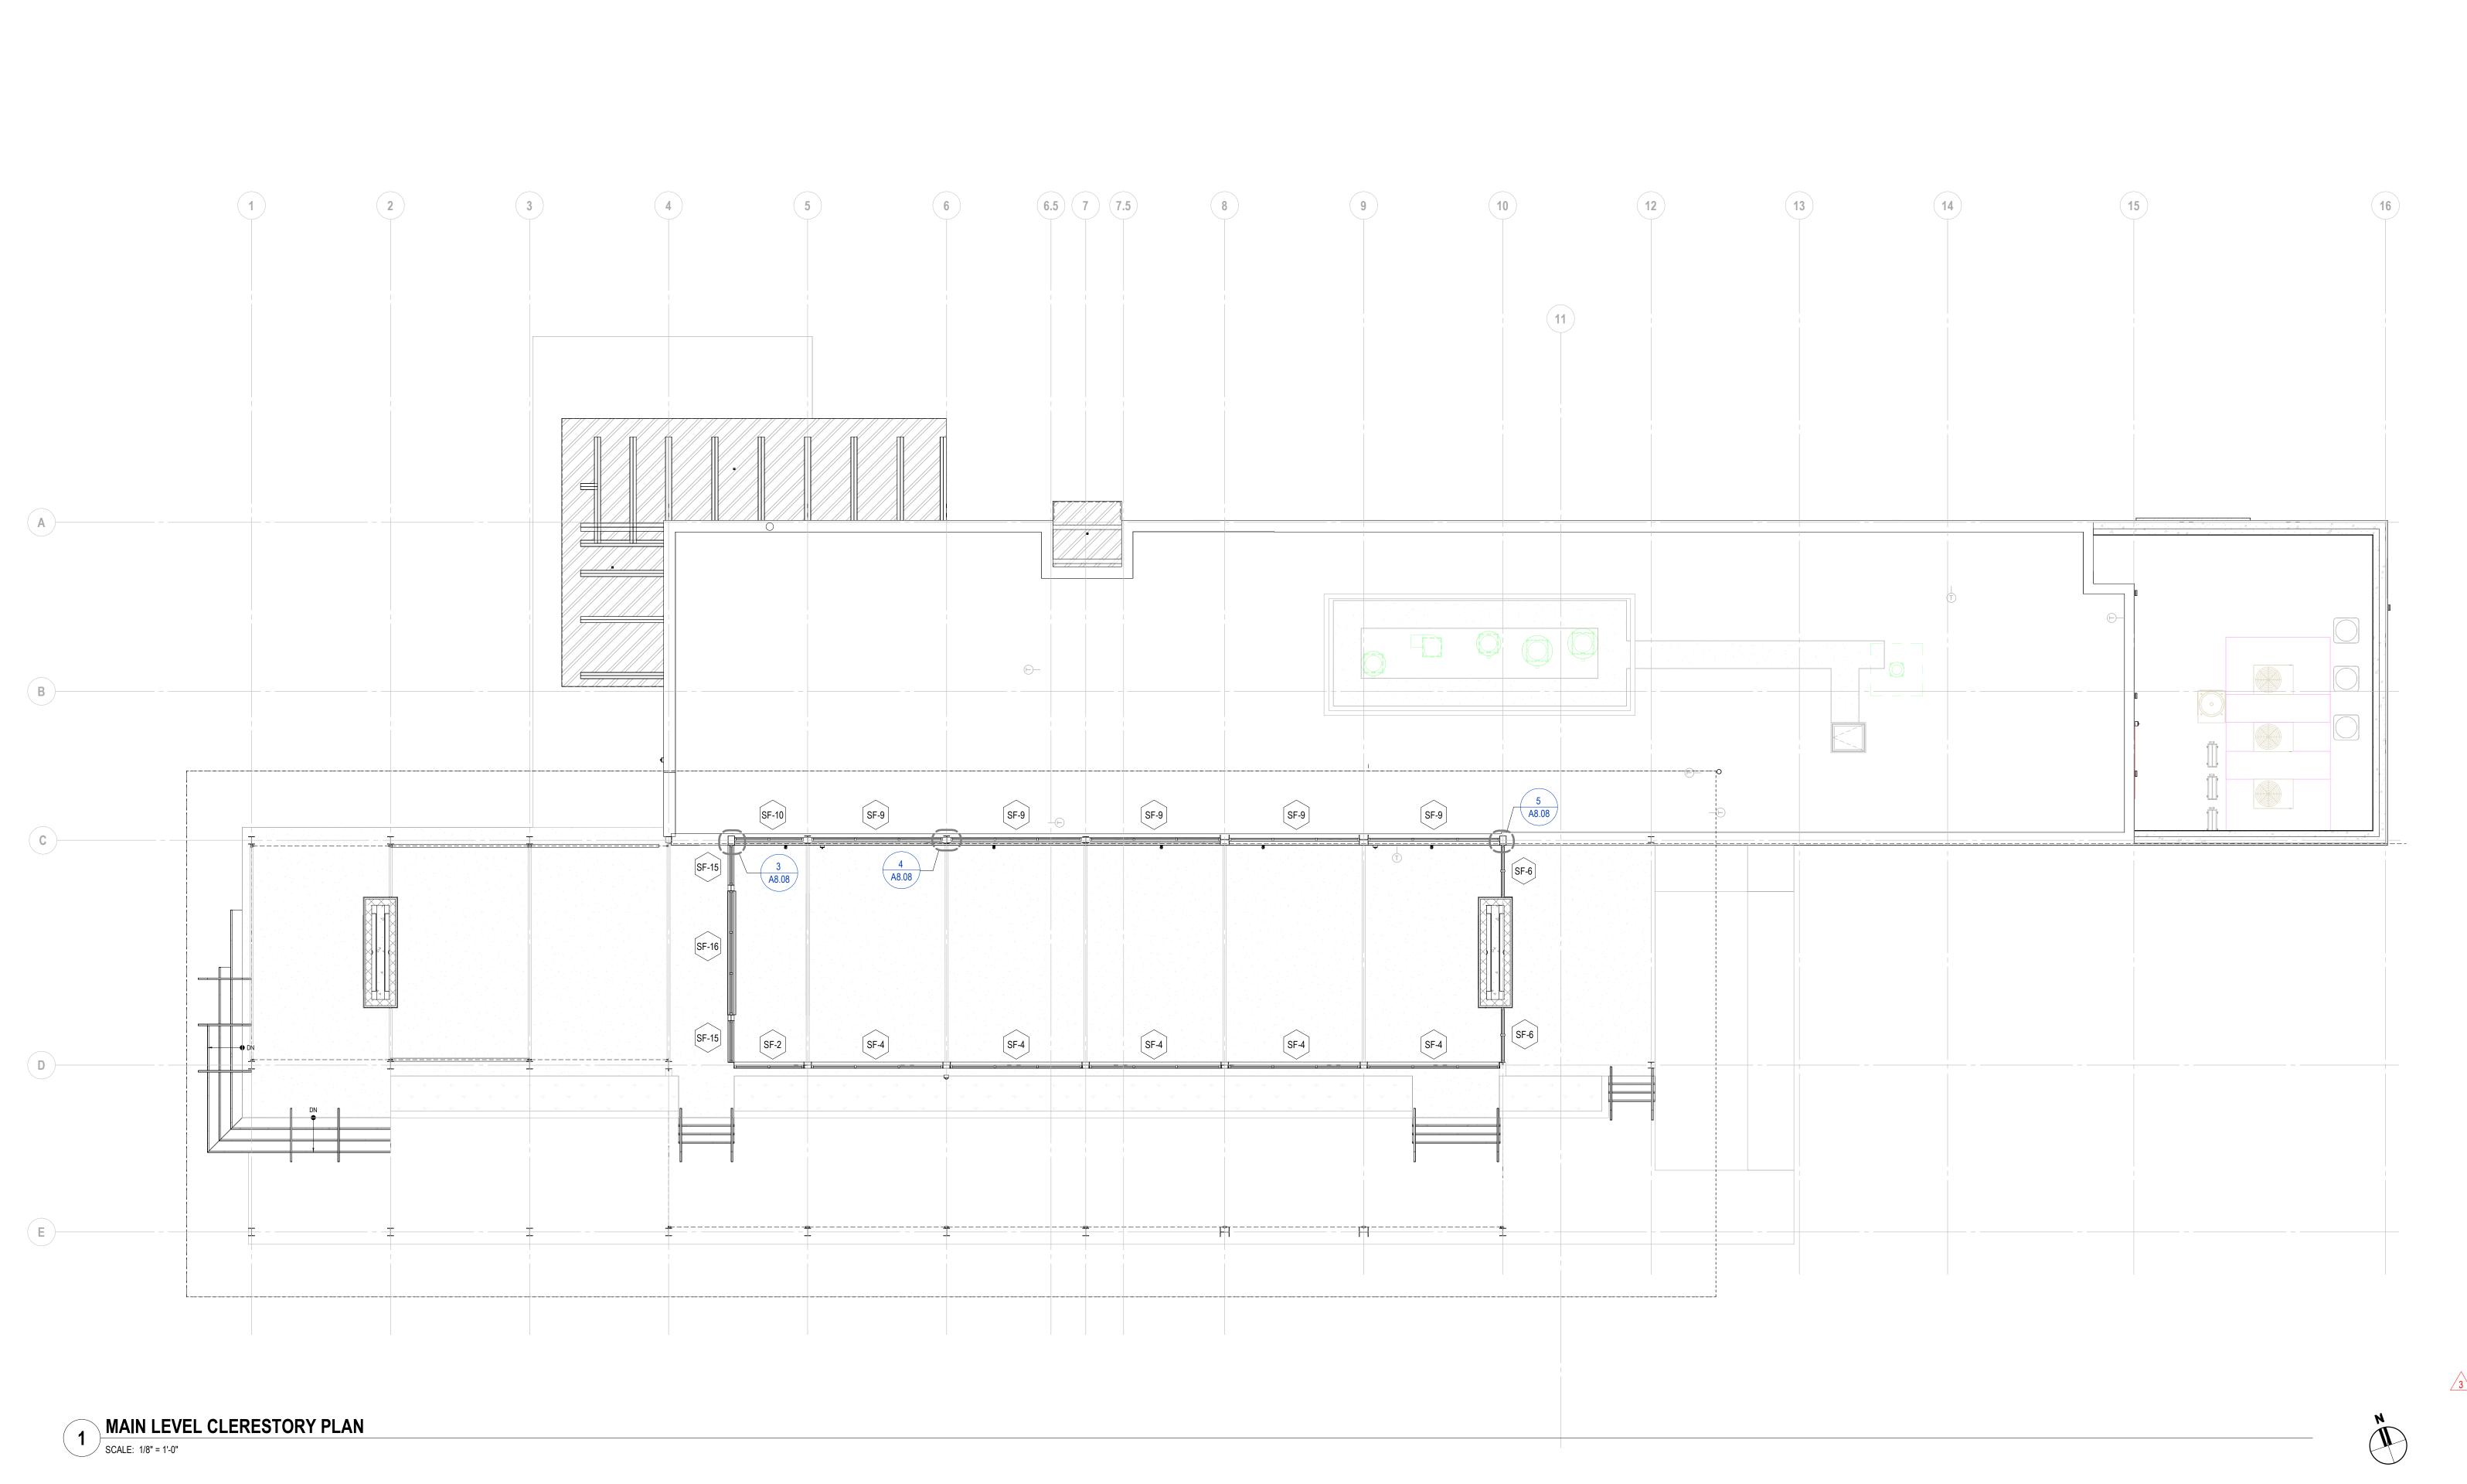
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MAIN LEVEL PARTIAL DIMENSION PLAN B

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design architect
Olson Kundig

159 South Jackson St, Suite 600 Seattle, WA 98104



ATLANTIC FIELDS -GOLF HOUSE

PERMIT SET


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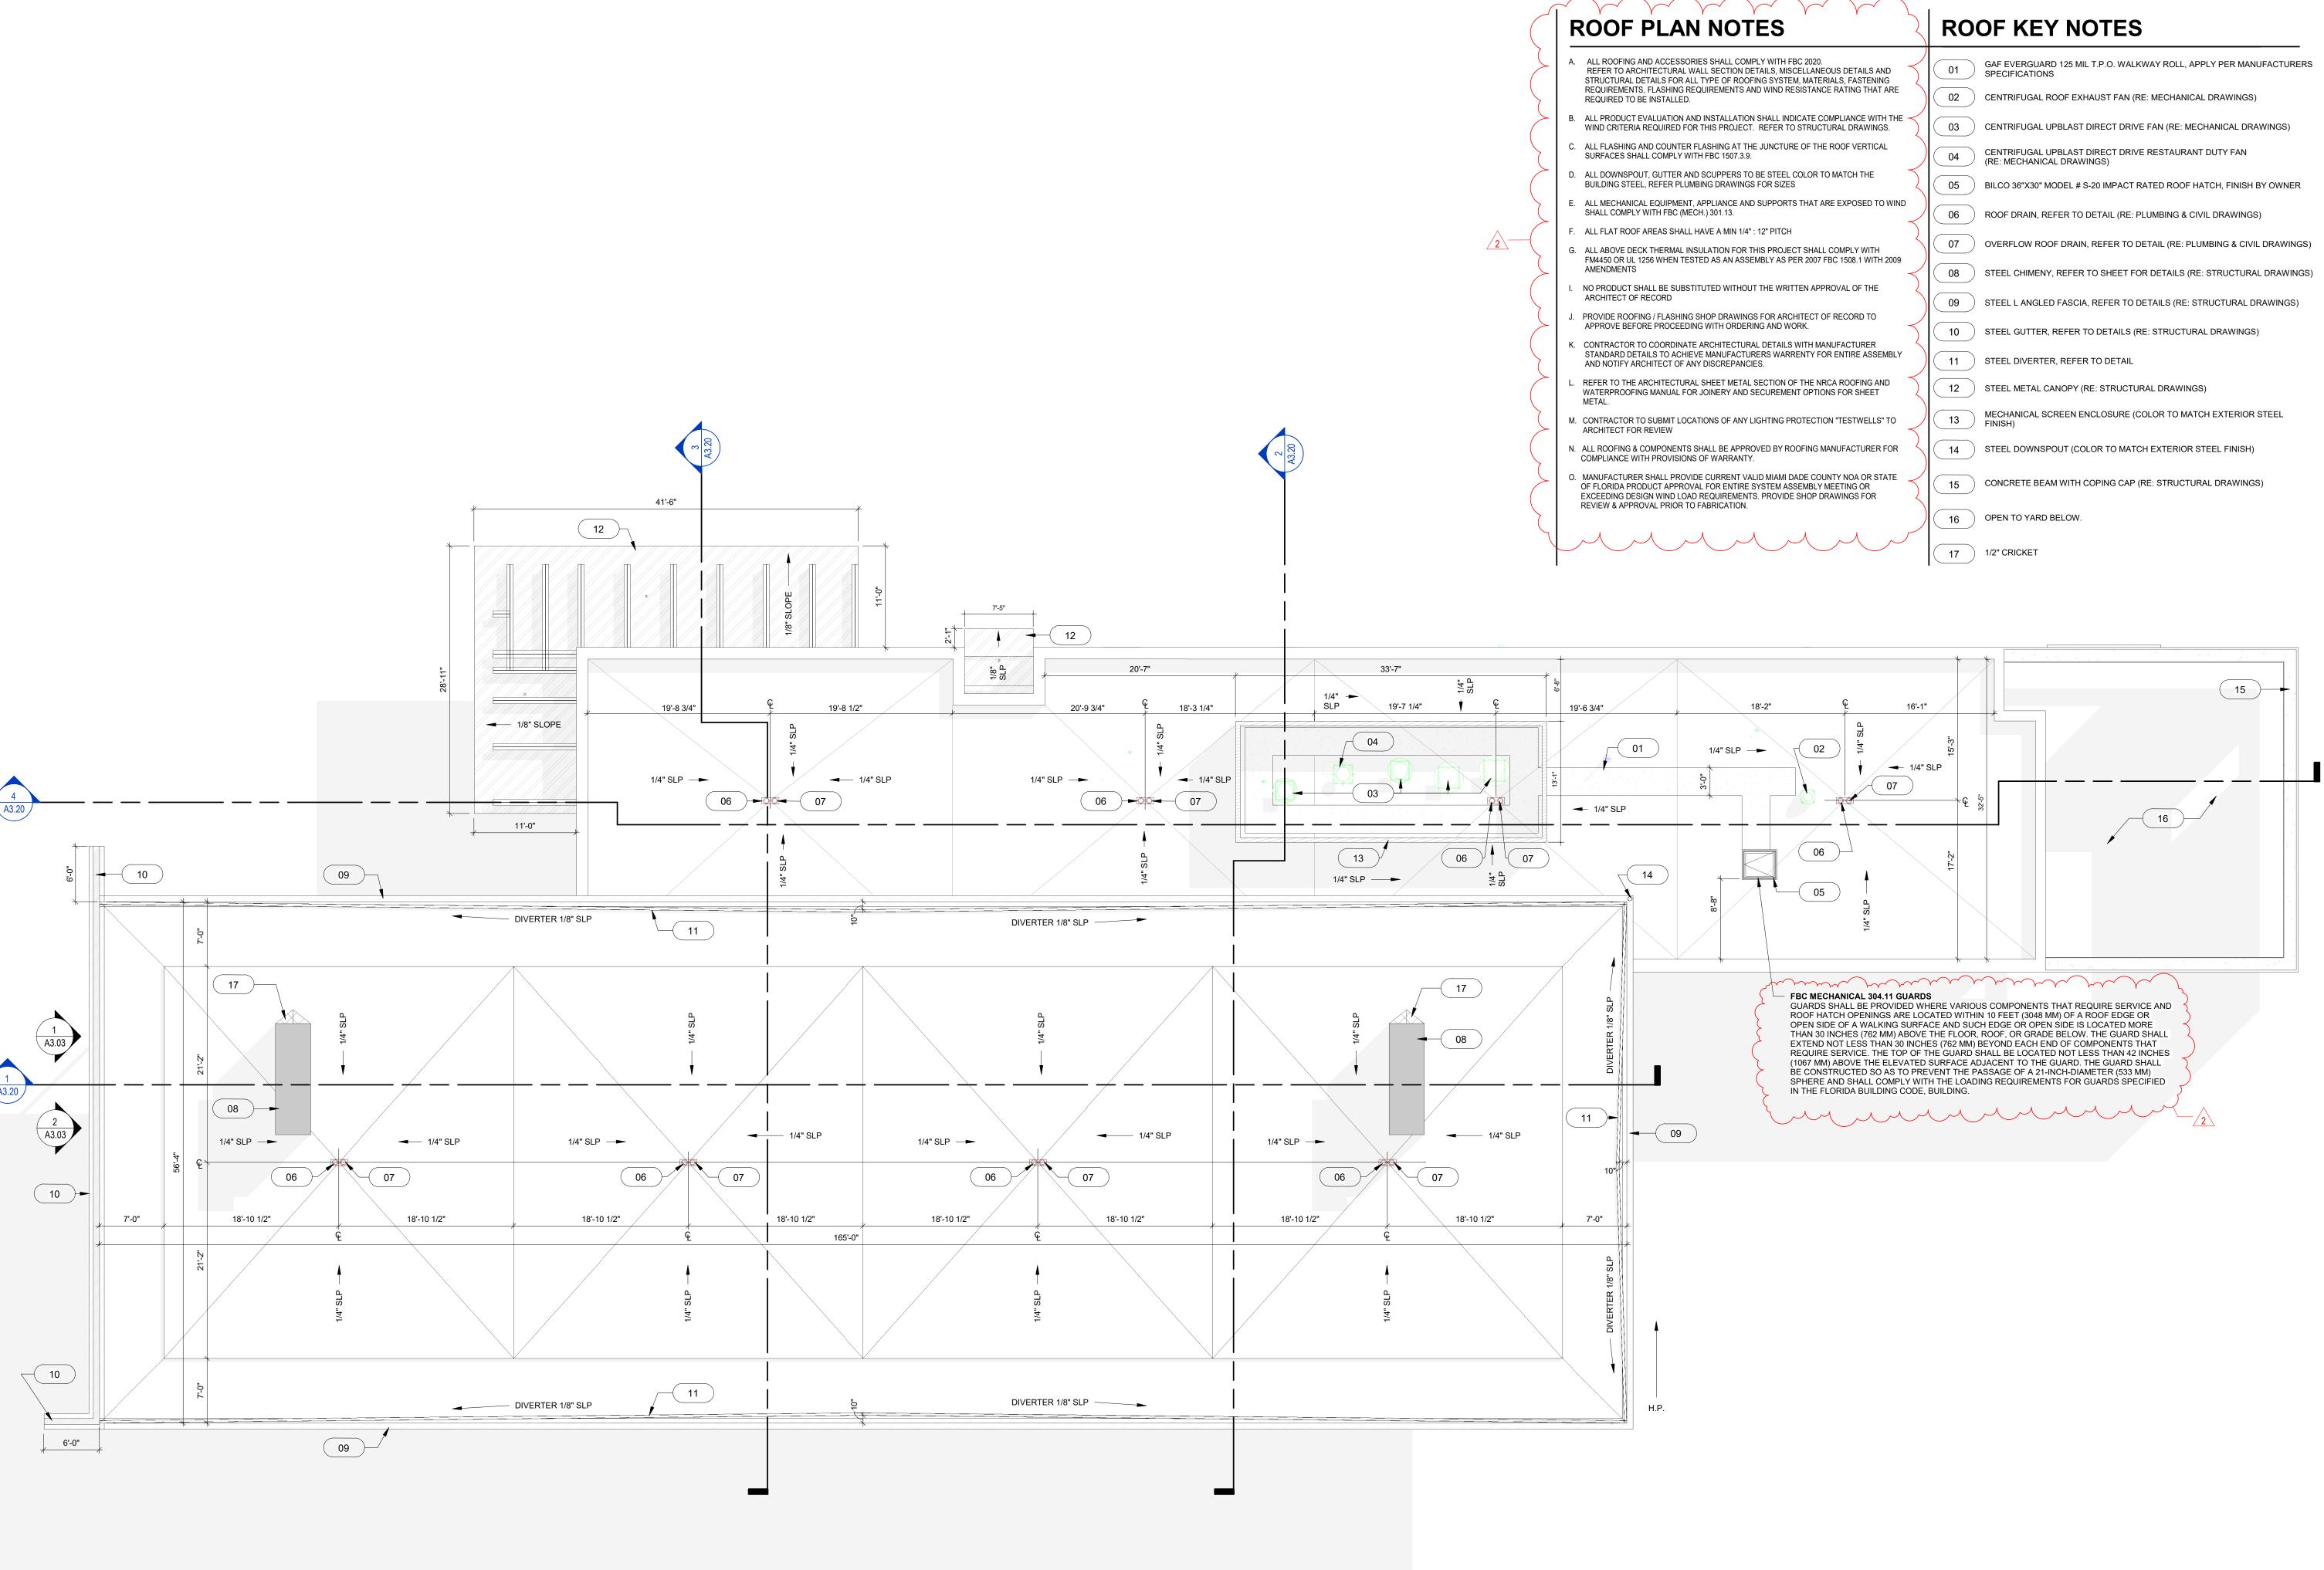
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MAIN LEVEL CLARESTORY PLAN

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DESIGN ARCHITECT

Olson Kundig

159 South Jackson St,

Suite 600

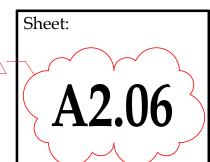Seattle, WA 98104

ATLANTIC

FIELDS

ATLANTIC FIELDS **GOLF HOUSE**

PERMIT SET

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OVERALL ROOF PLAN


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DESIGN ARCHITECT Olson Kundig

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ATLANTIC FIELDS -GOLF HOUSE

PERMIT SET


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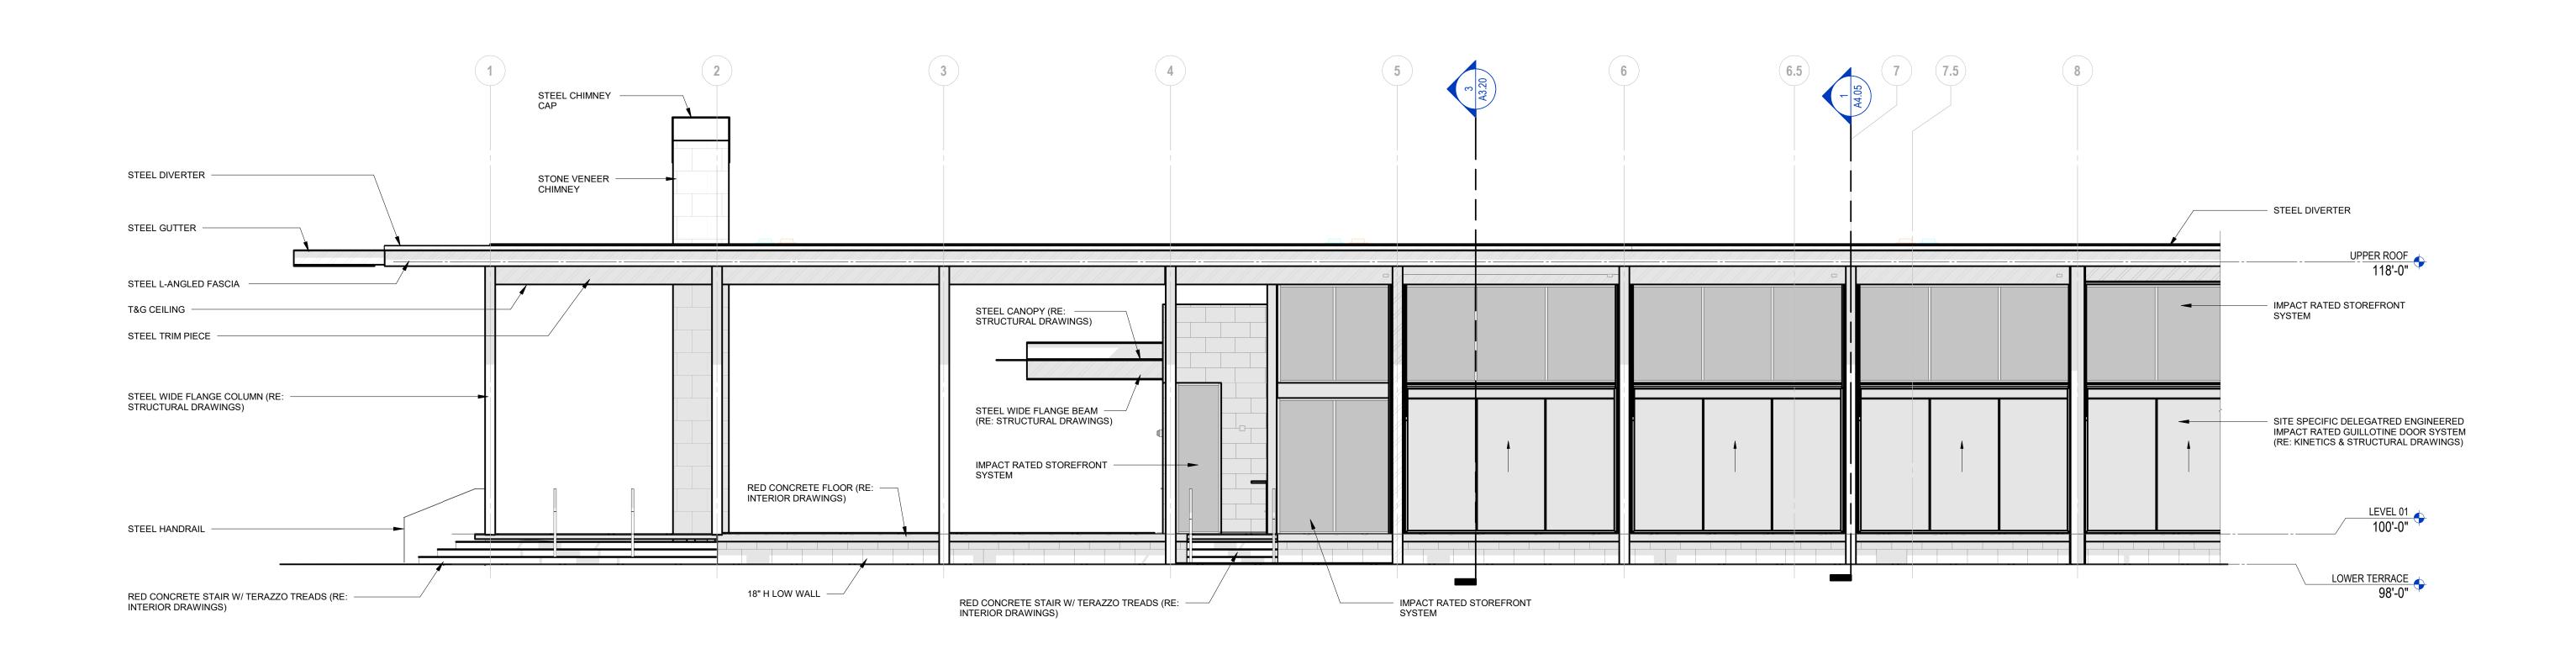
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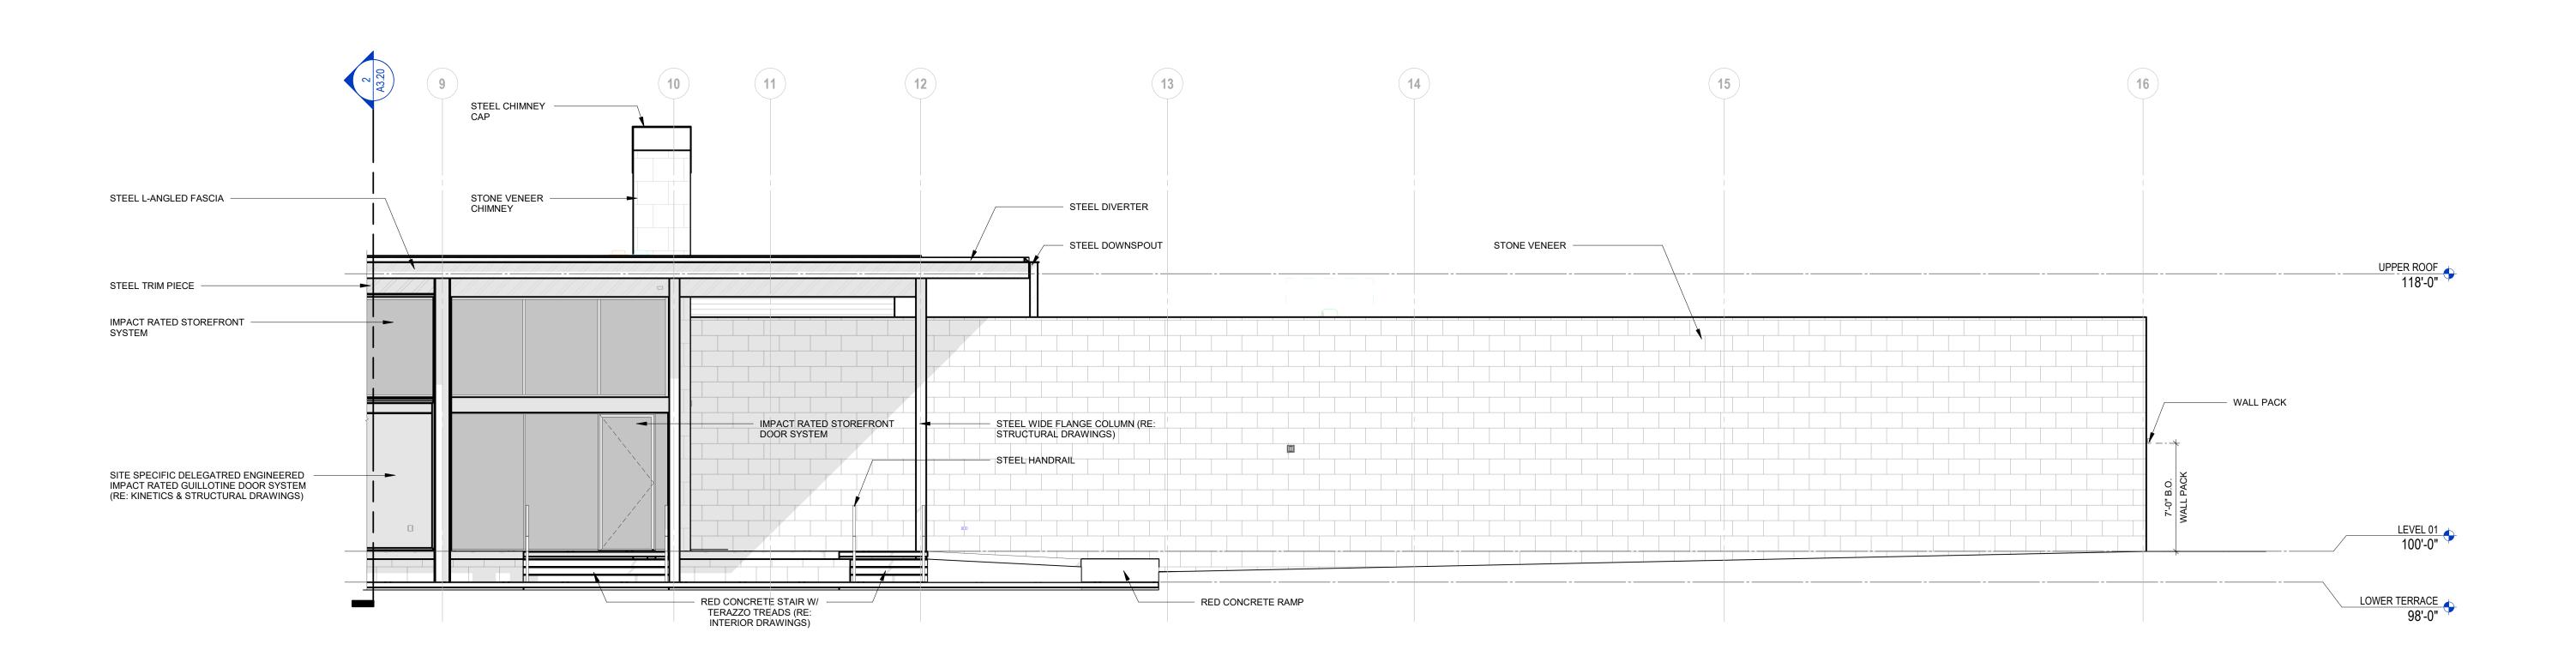
MAIN LEVEL SPECIAL CONDITION PLAN

Revisions: No. Description Date
3 Addendum #1 03.22.2024 Comm: Date: 22-061 11.01.2023 Drawn By: Checked:

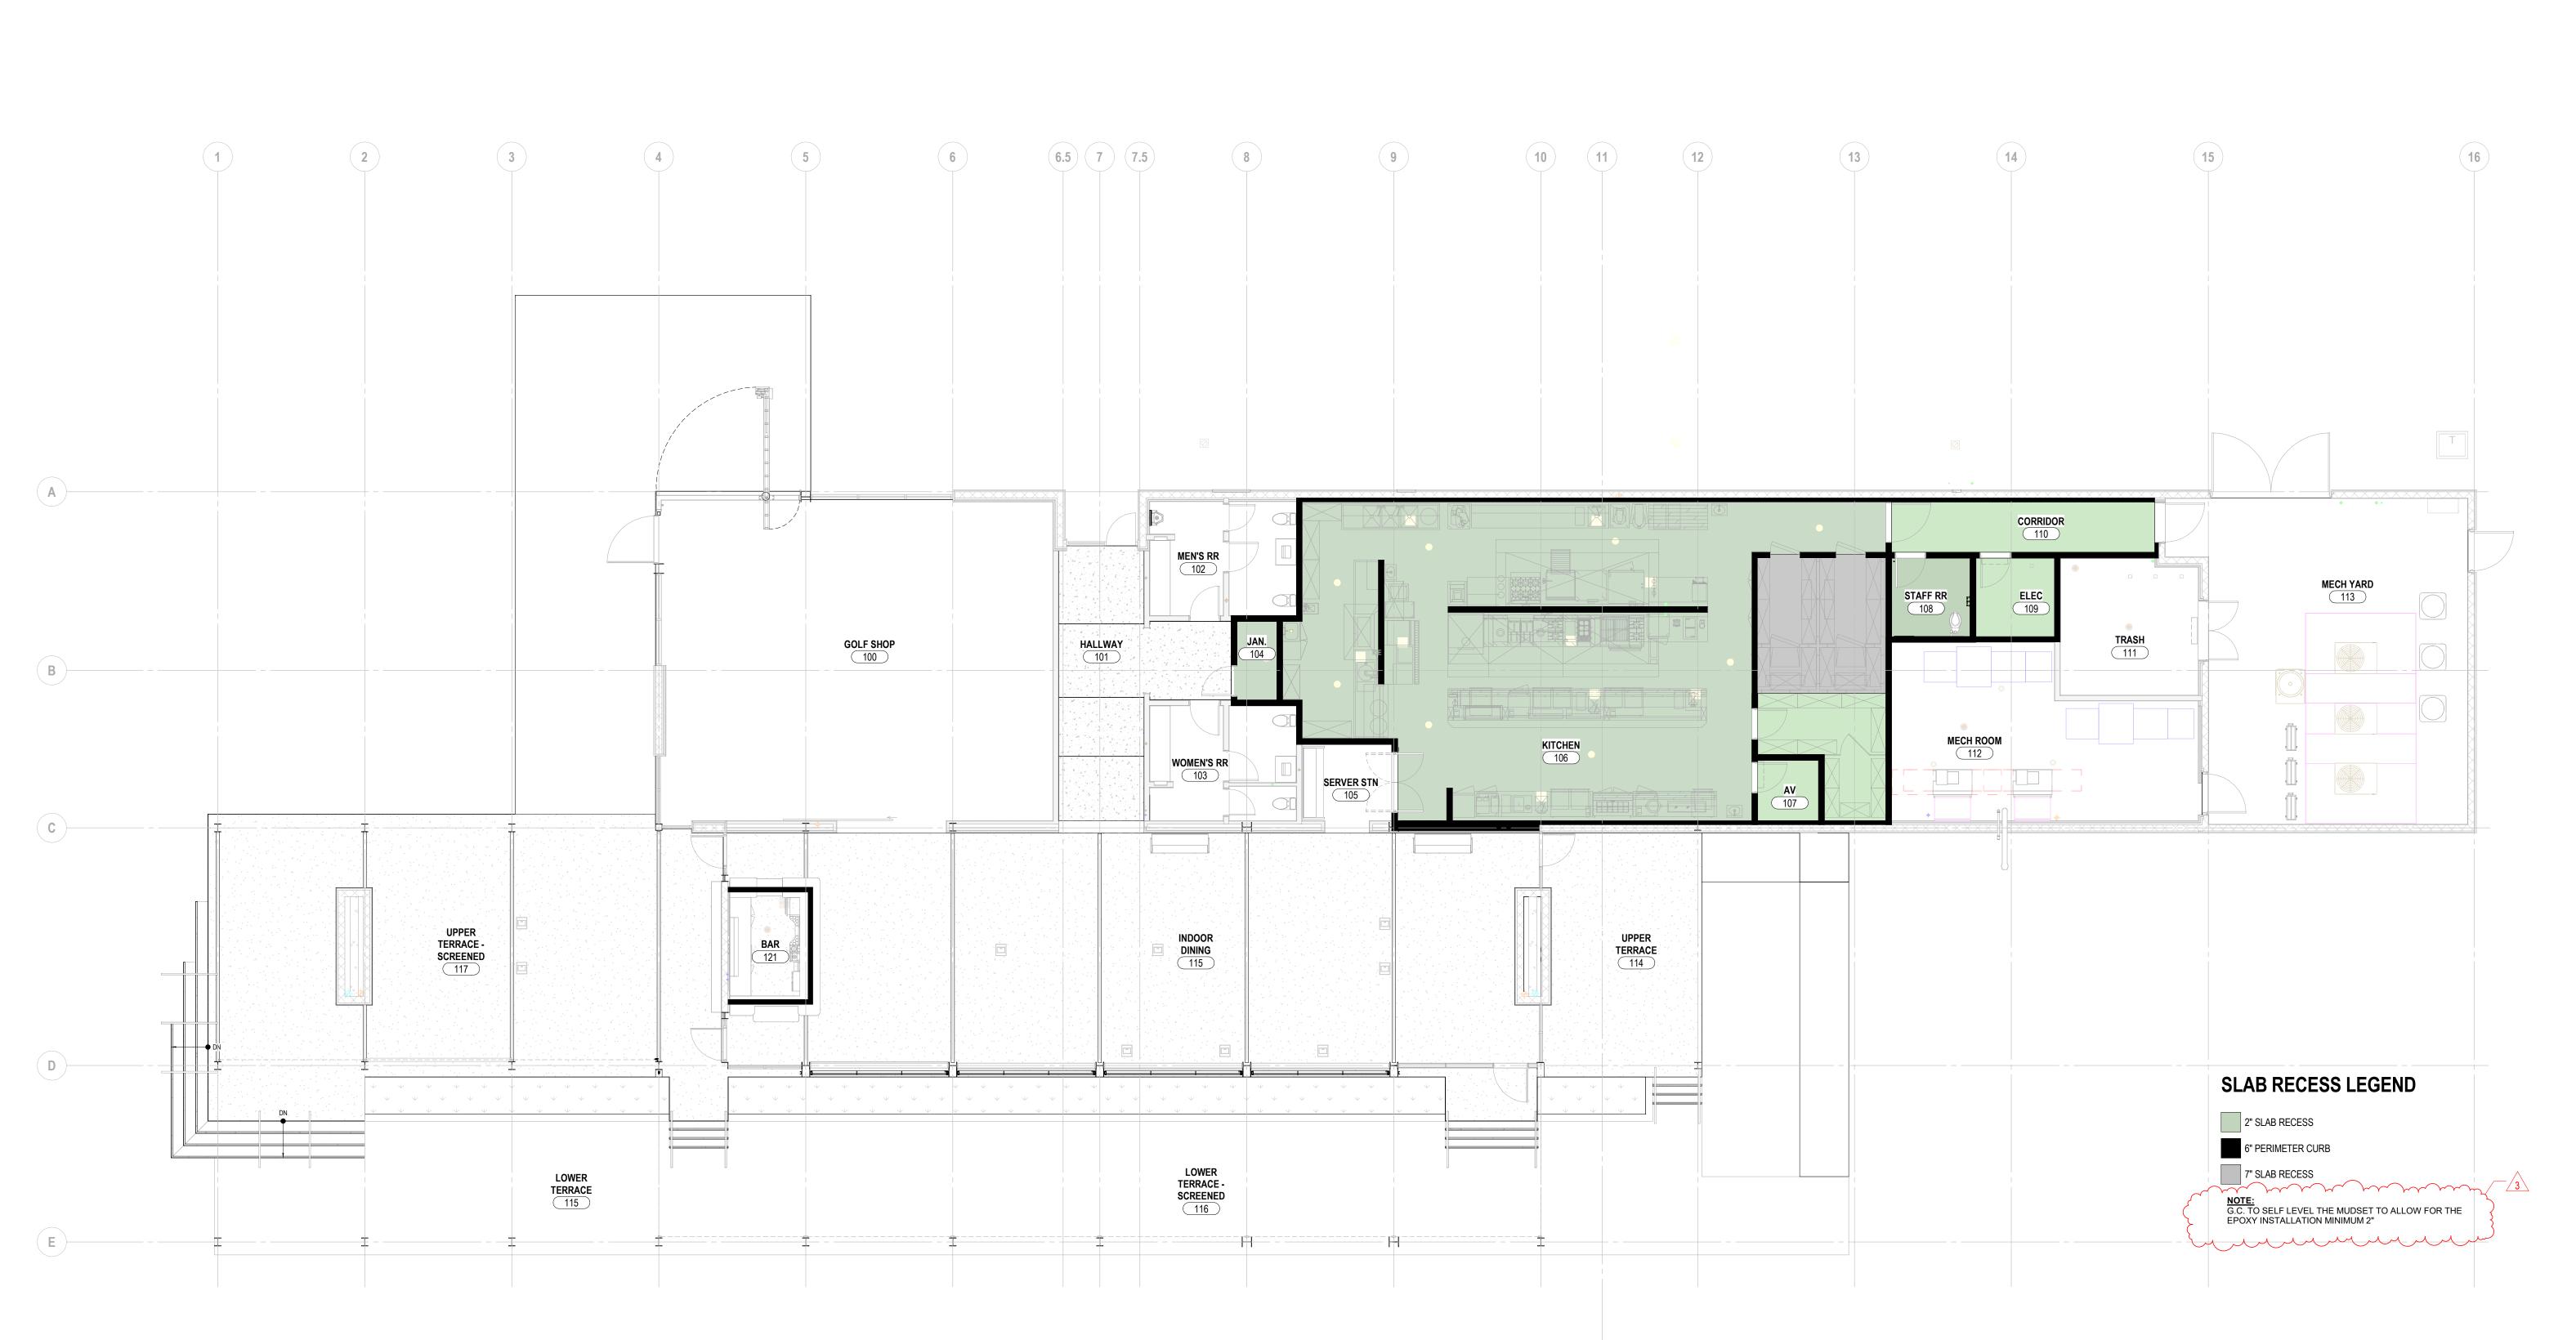



1 EXTERIOR ELEVATION - SOUTH - A ENLARGED SCALE: 3/16" = 1'-0"

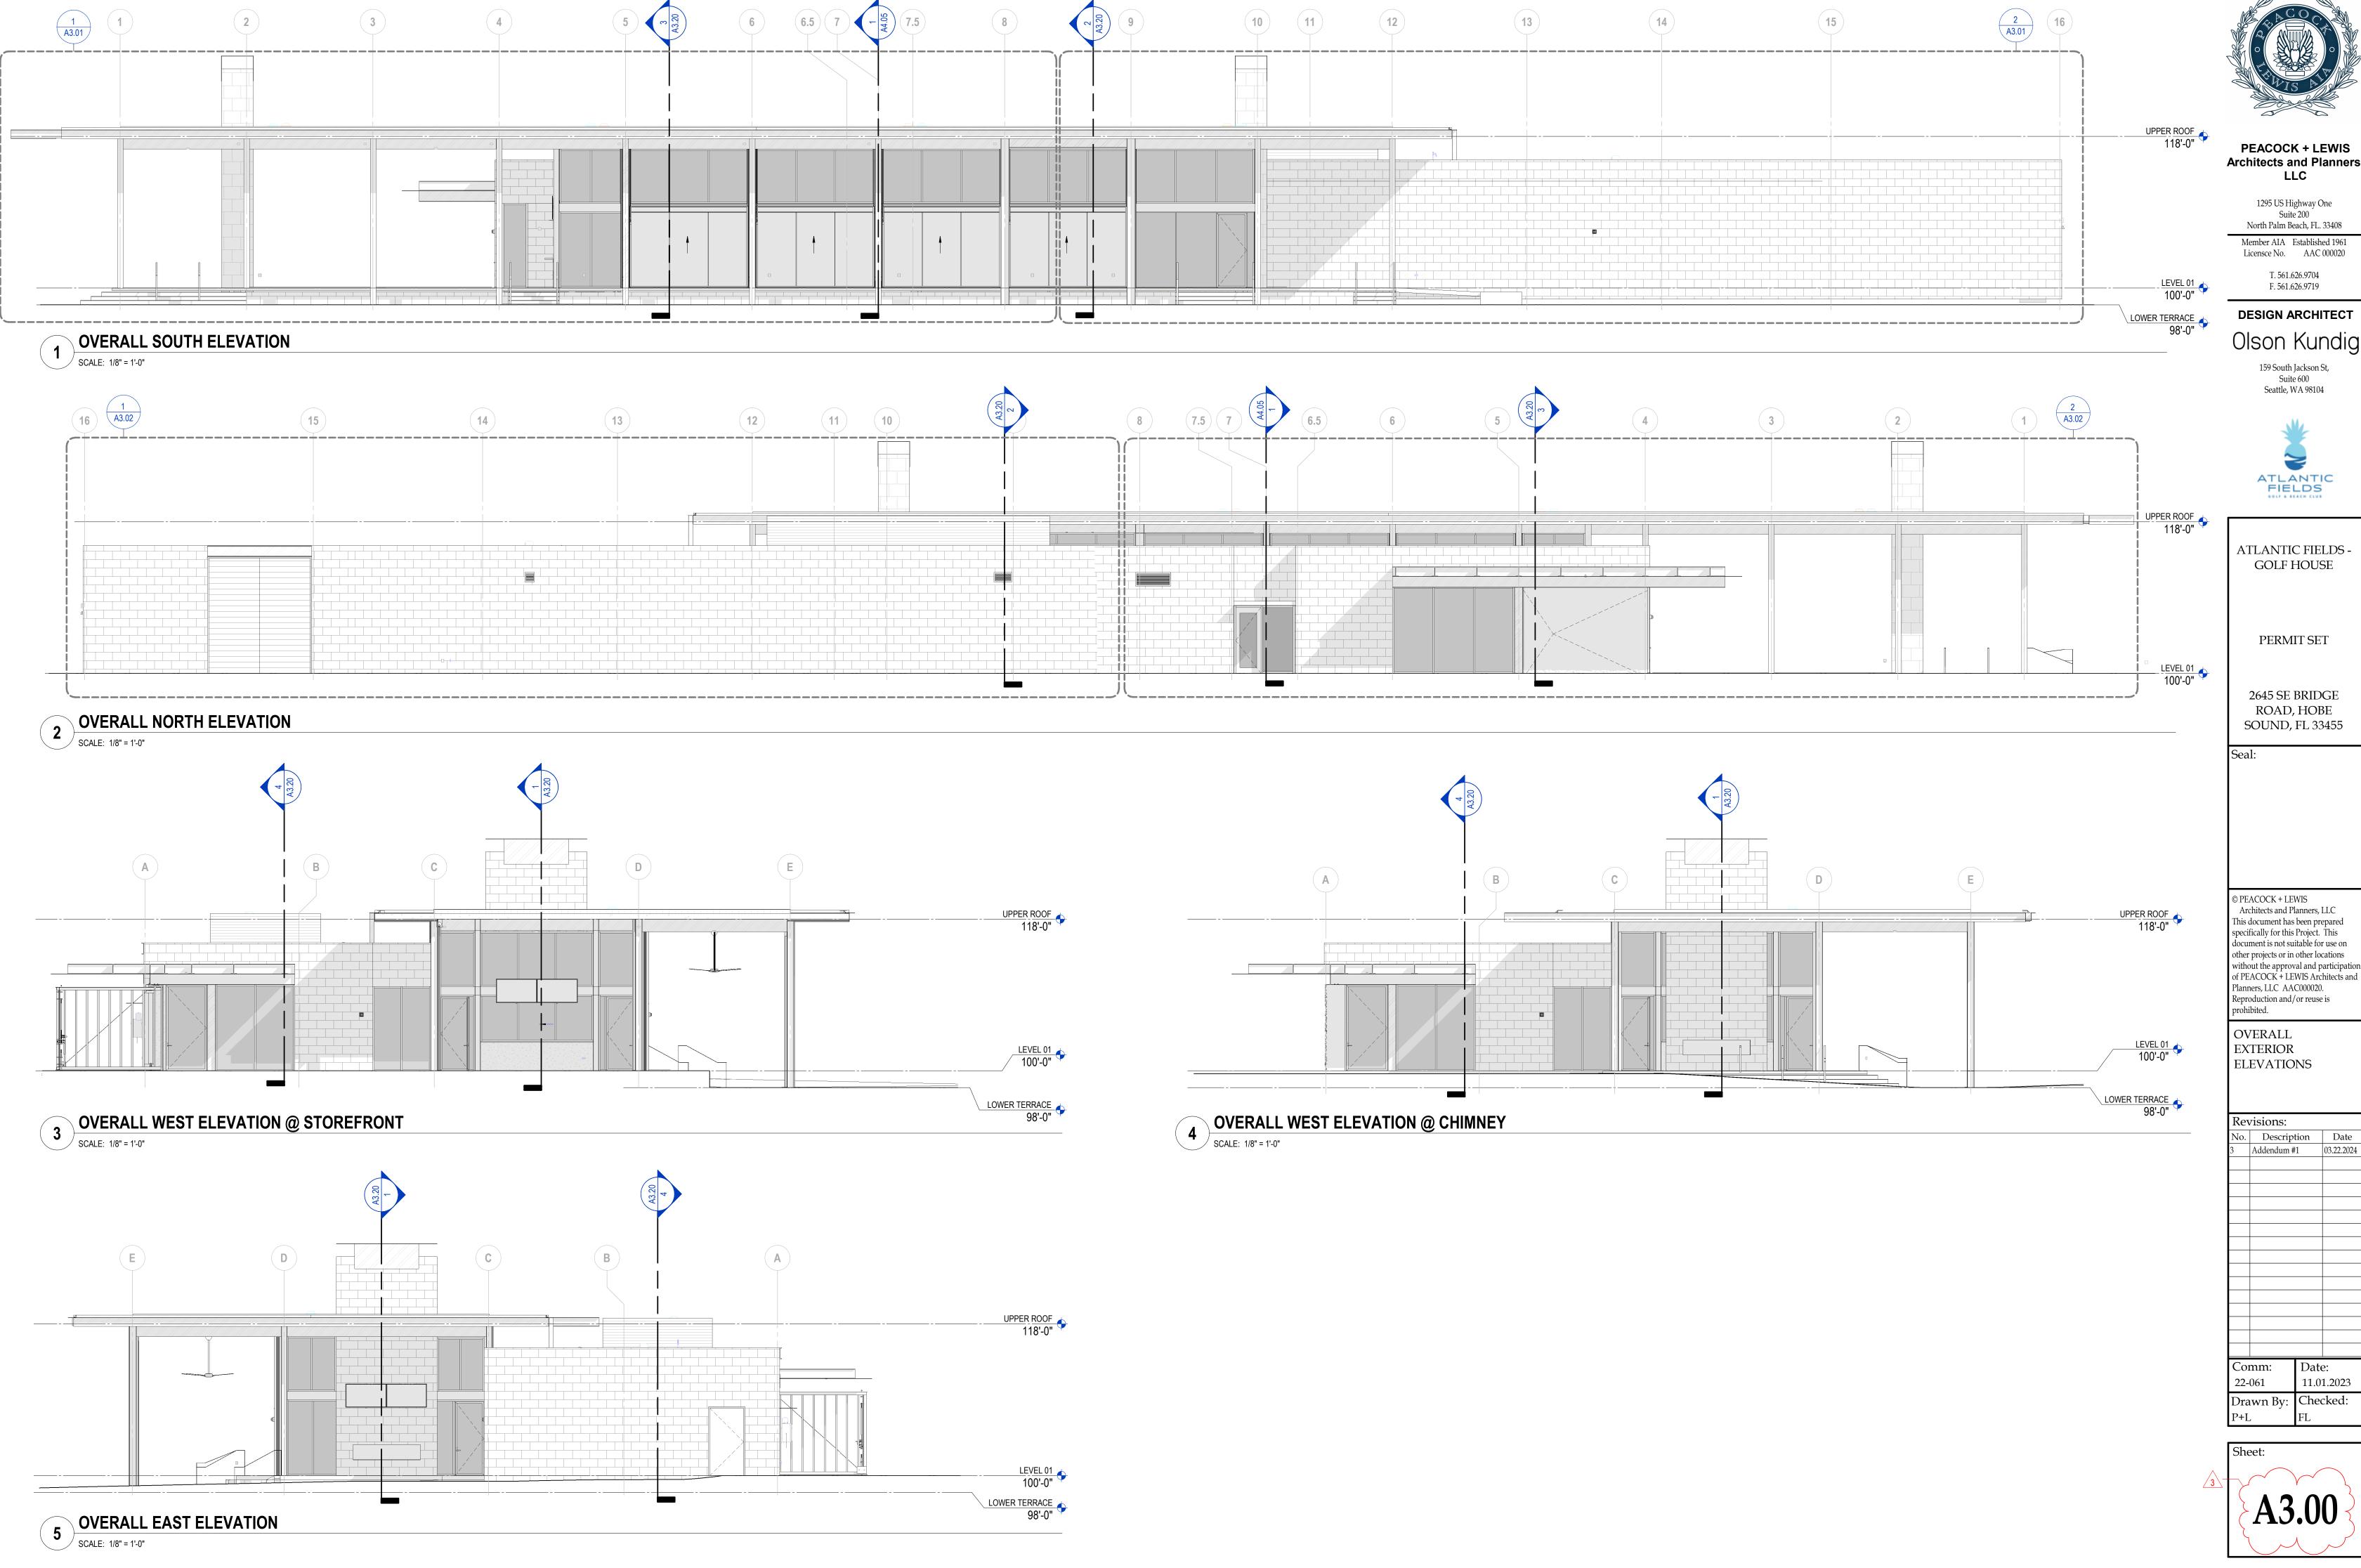





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ATLANTIC FIELDS GOLF HOUSE

PERMIT SET

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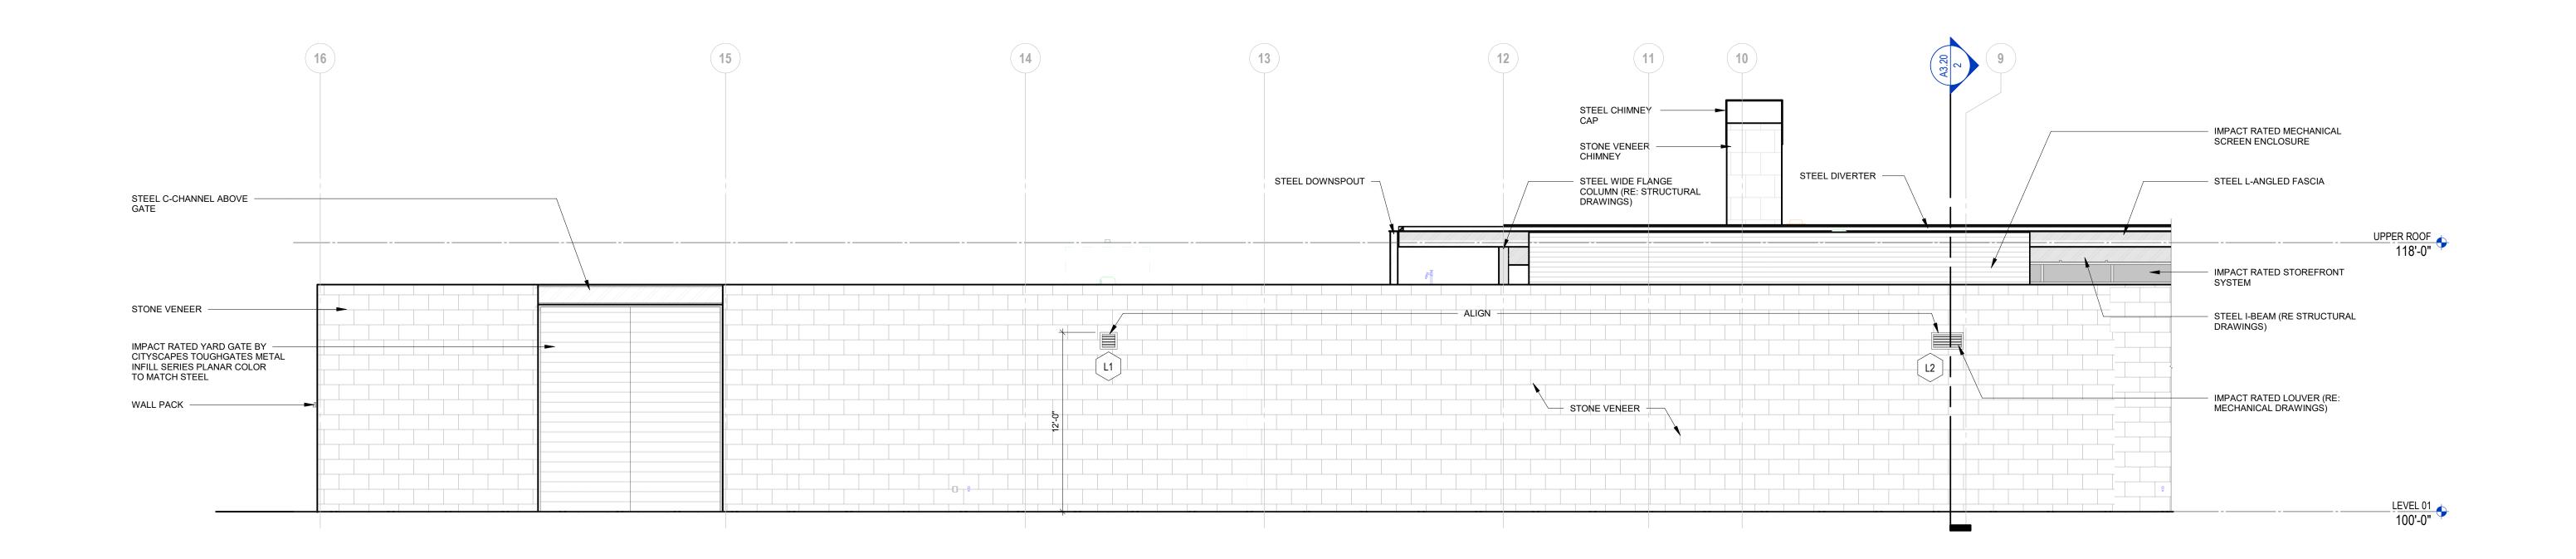
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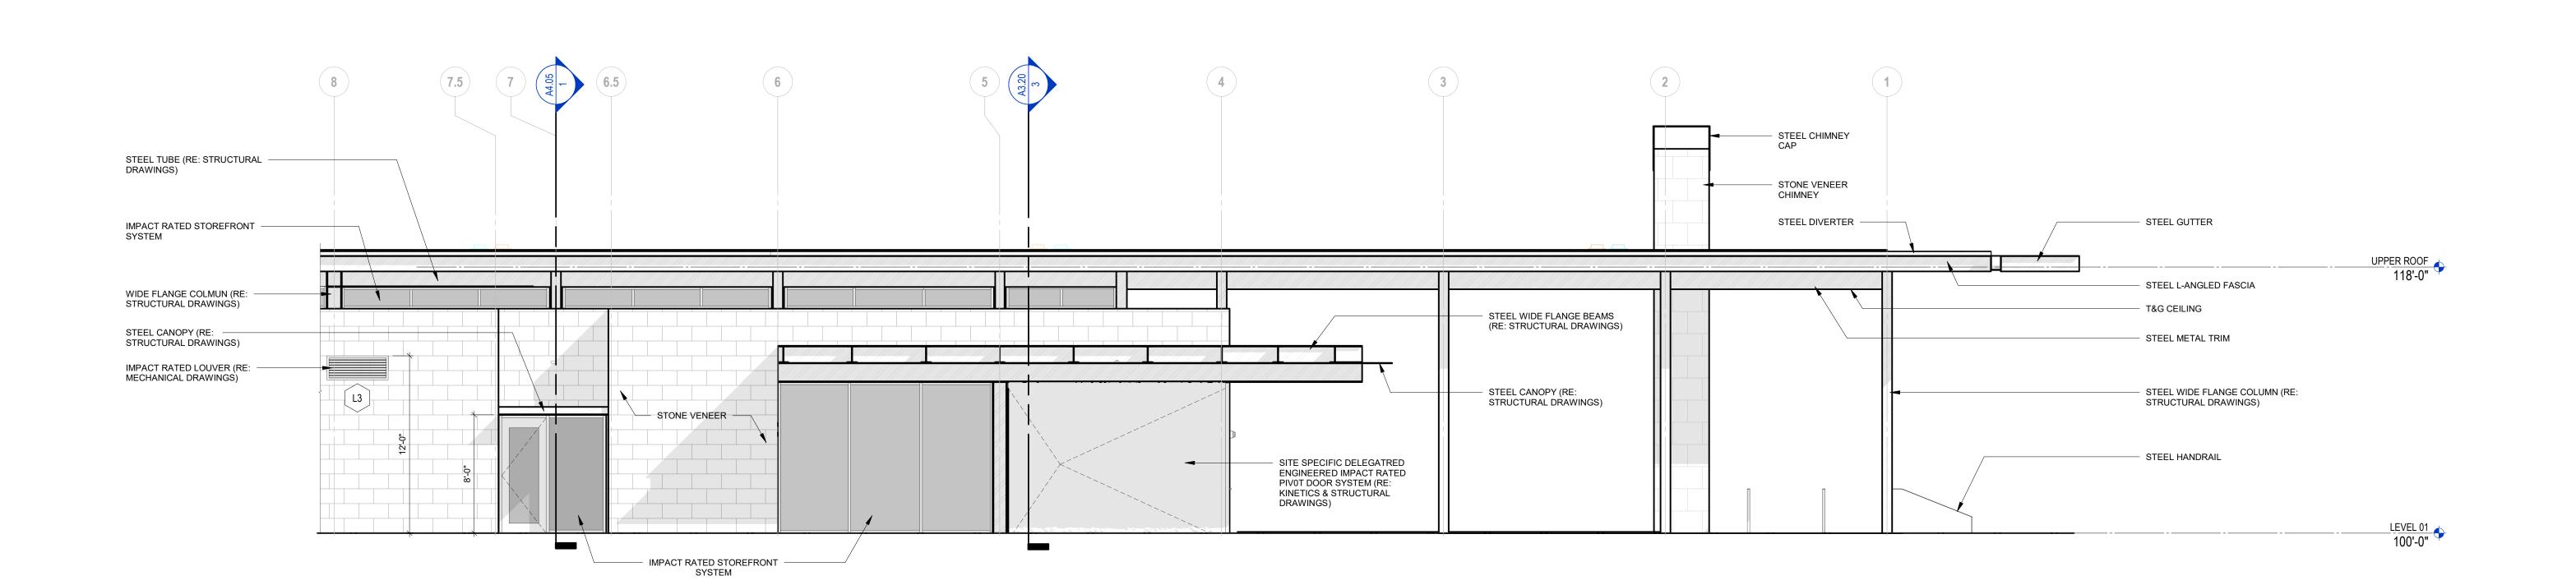
ENLARGED EXTERIOR ELEVATIONS

Revisions: No. Description Date
Addendum #1 03.22.2024

Date: Comm: 22-061 11.01.2023 Drawn By: Checked:



1 EXTERIOR ELEVATIONS - NORTH - A ENLARGED SCALE: 3/16" = 1'-0"



2 EXTERIOR ELEVATIONS - NORTH - B ENLARGED

SCALE: 3/16" = 1'-0"



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ATLANTIC FIELDS -GOLF HOUSE

PERMIT SET


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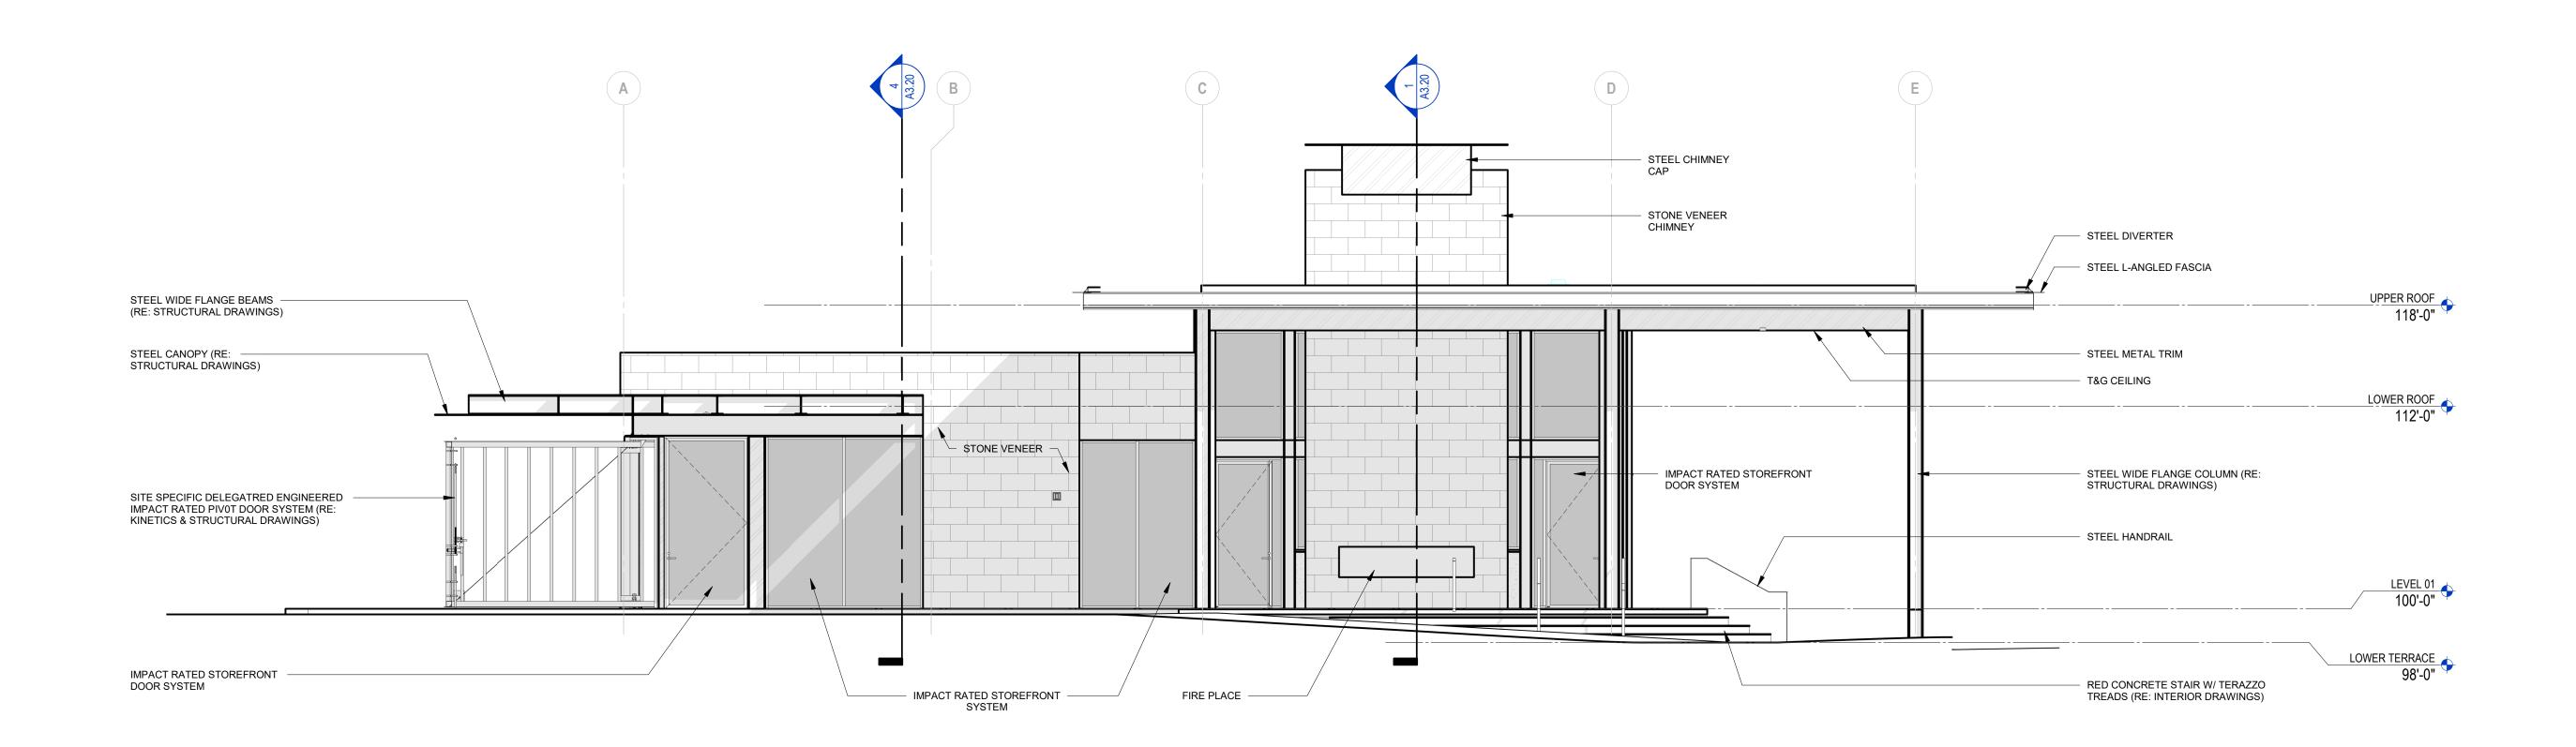
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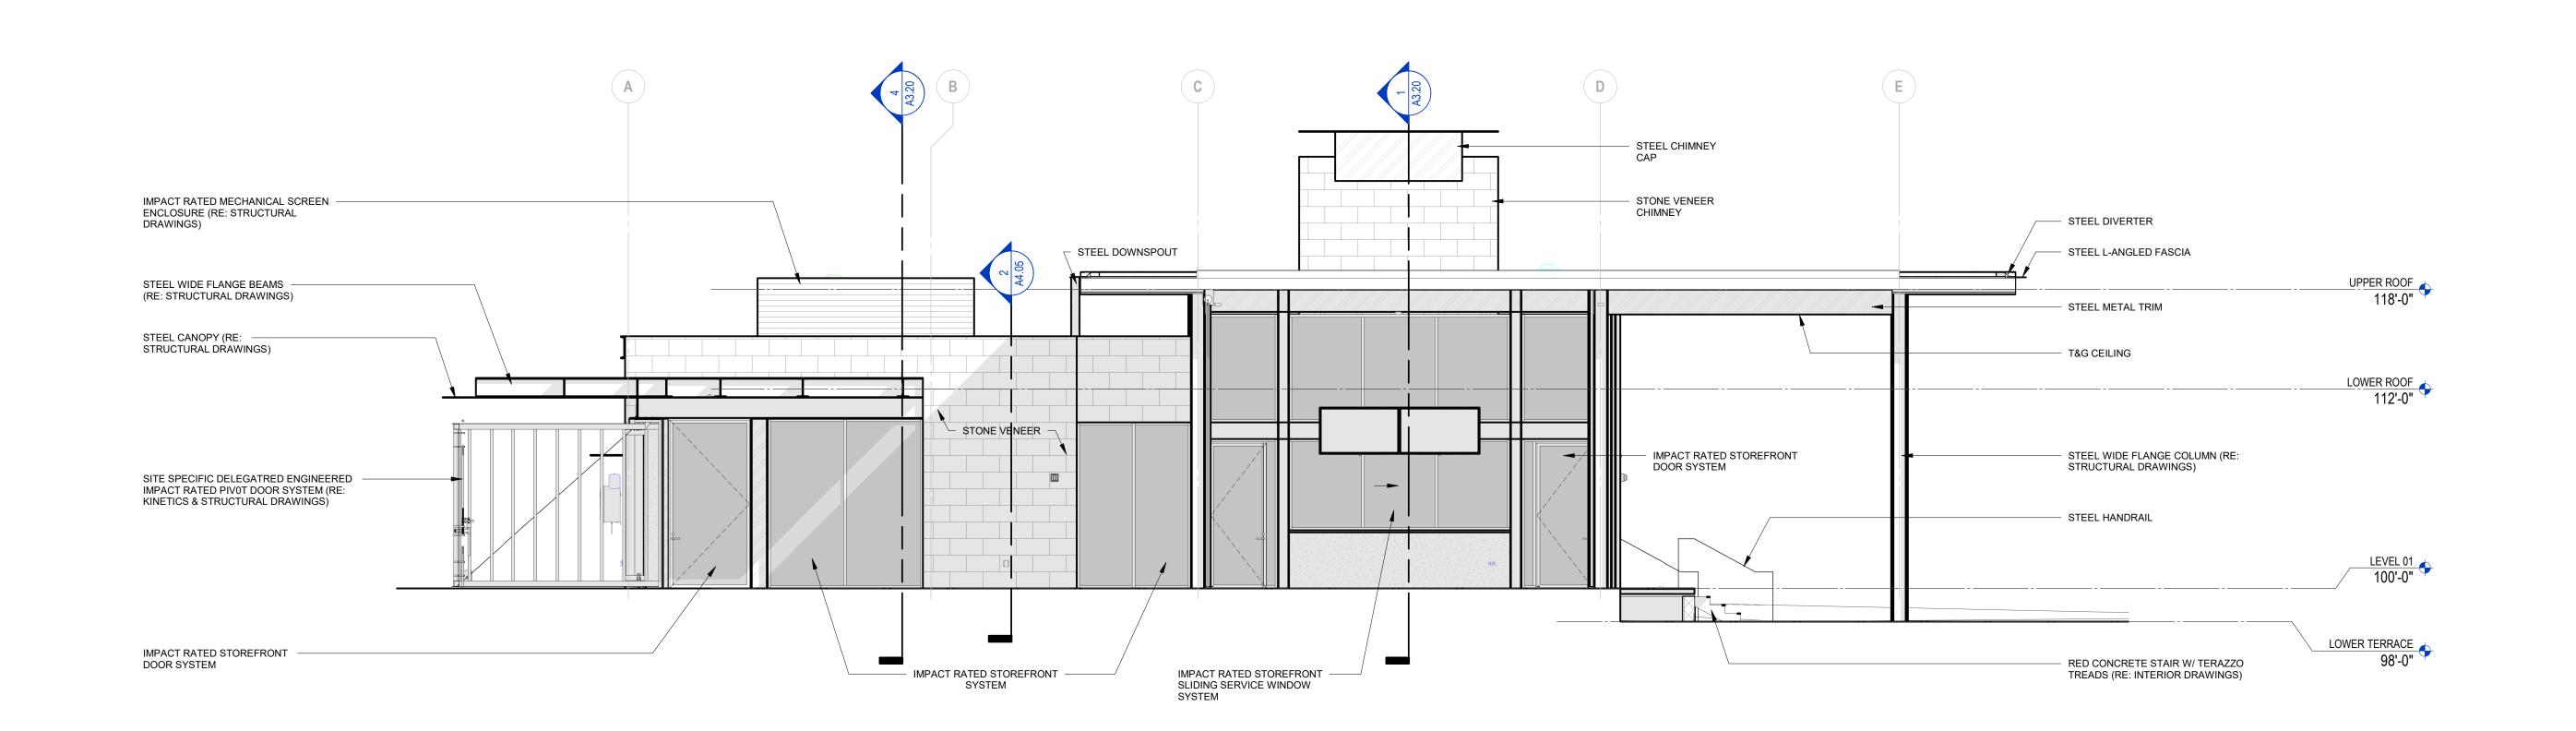
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Comm: 22-061



WEST ELEVATION @ CHIMNEY ENLARGED ELEVATION SCALE: 3/16" = 1'-0"



WEST ELEVATION @ STOREFRONT ENLARGED ELEVATION

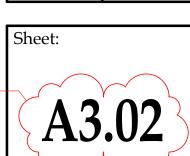

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ATLANTIC FIELDS **GOLF HOUSE**

PERMIT SET

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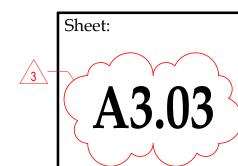
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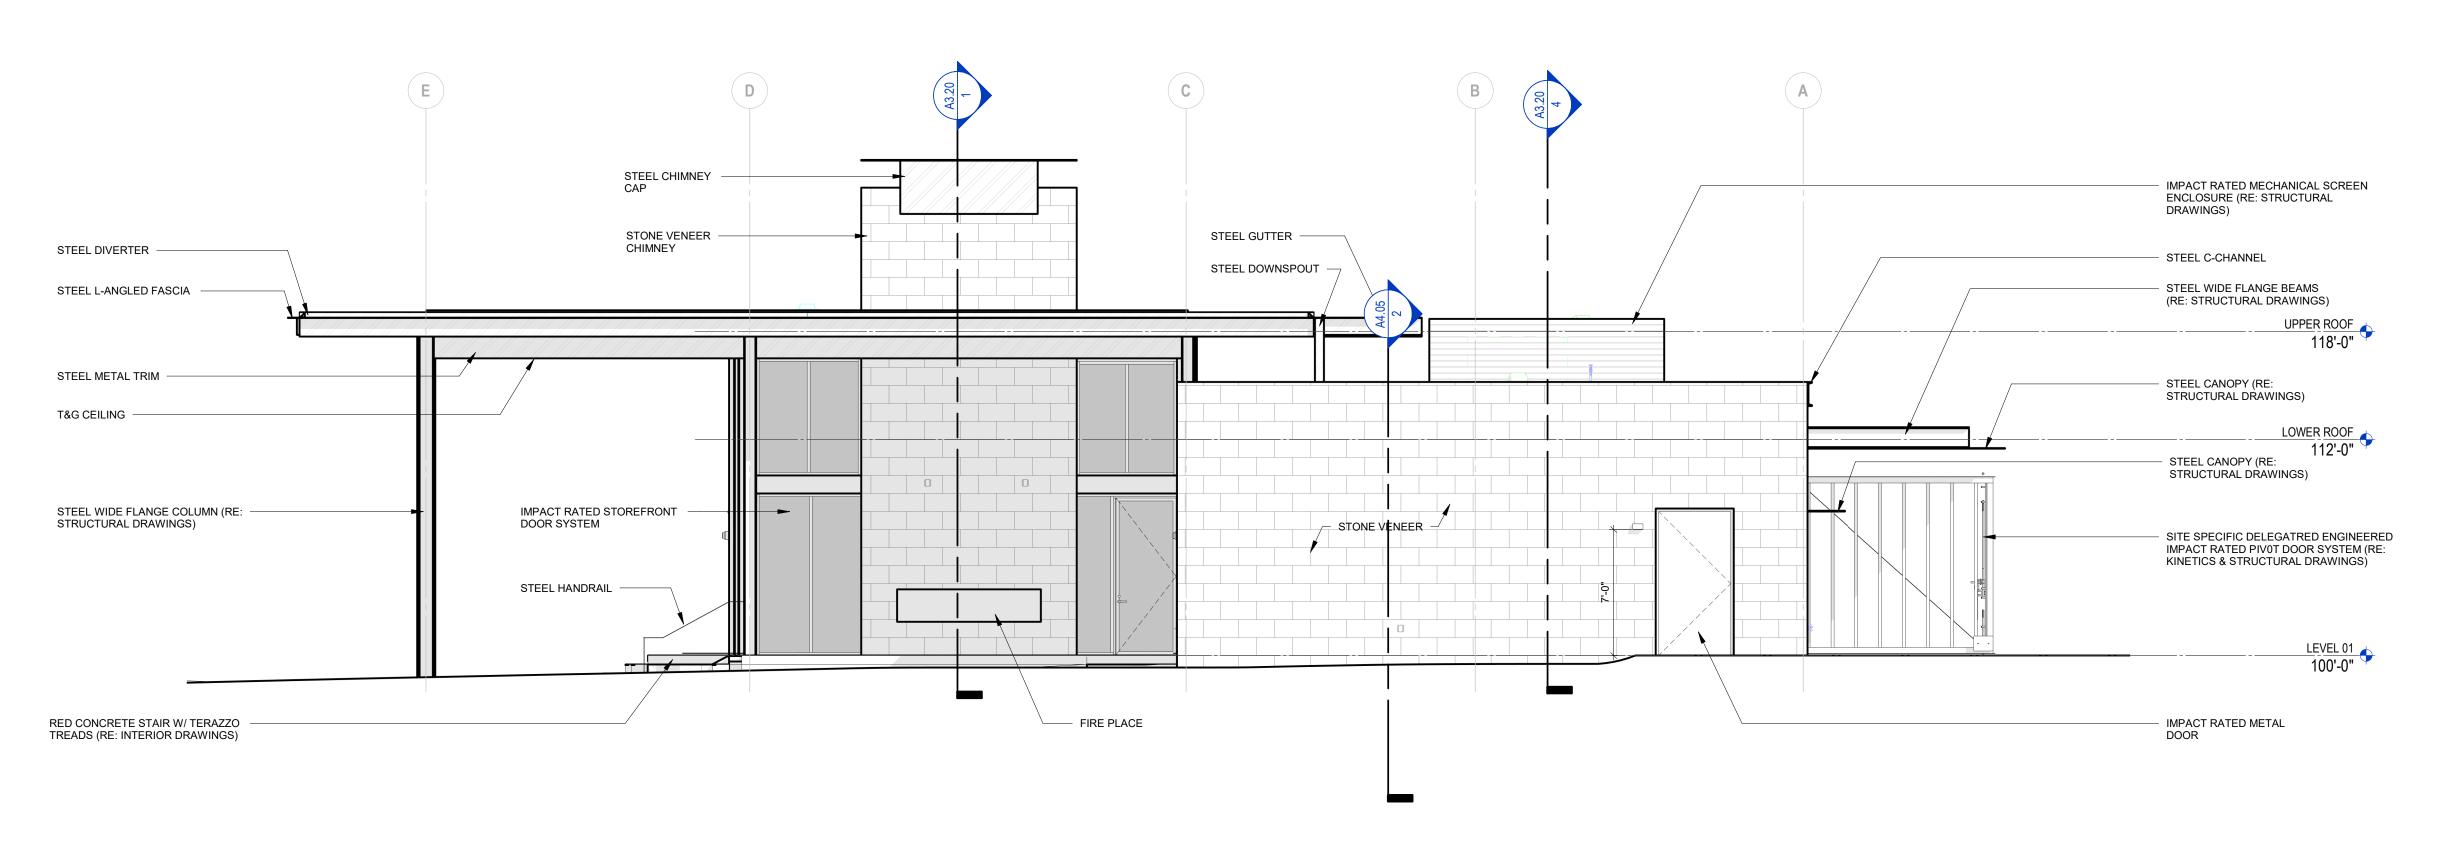
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ENLARGED EXTERIOR ELEVATIONS

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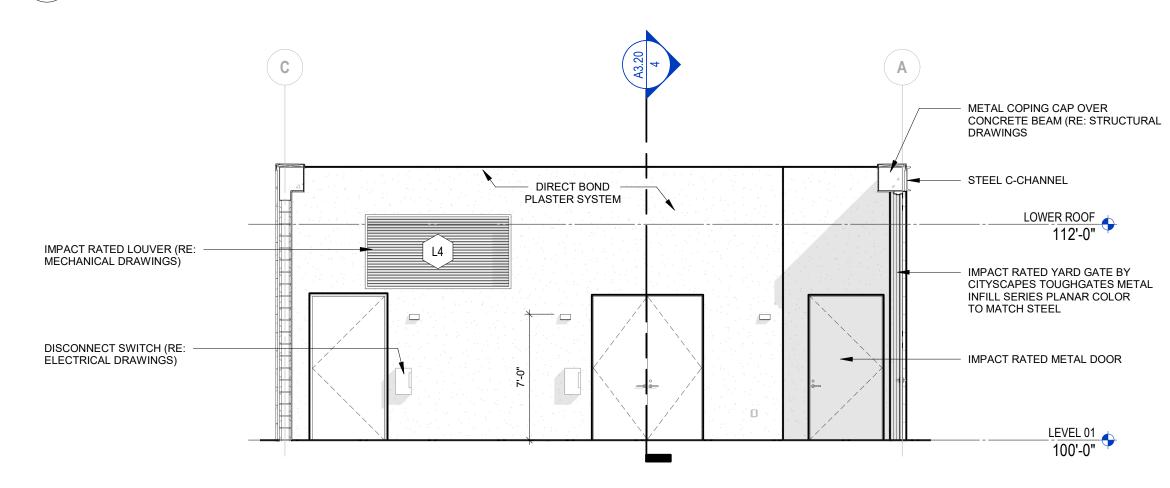
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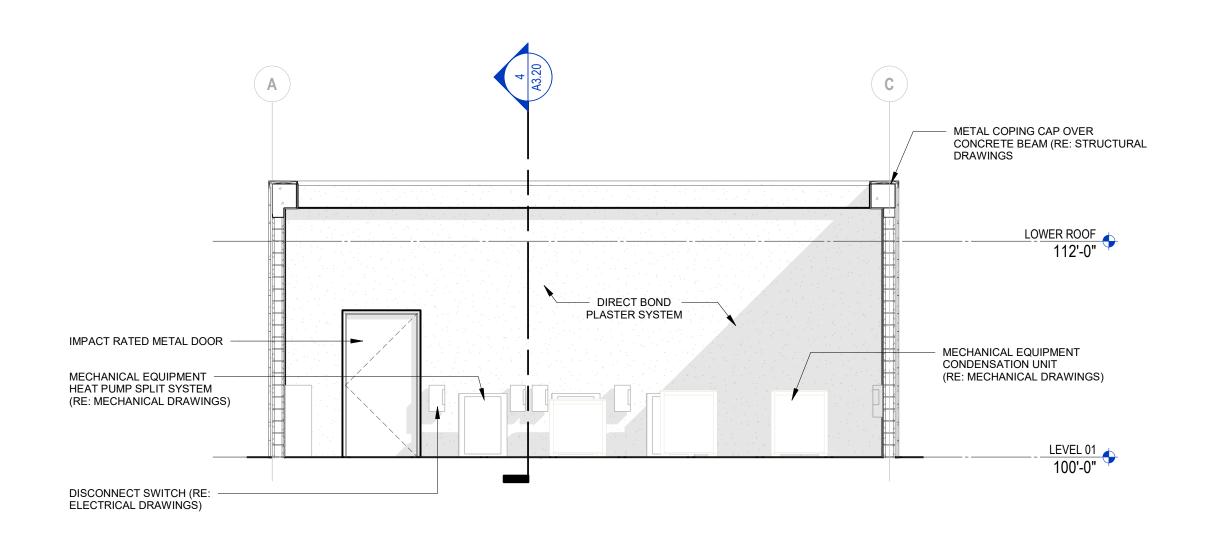





EAST ELEVATION ENLARGED

SCALE: 3/16" = 1'-0"






YARD EAST ELEVATION ENLARGED

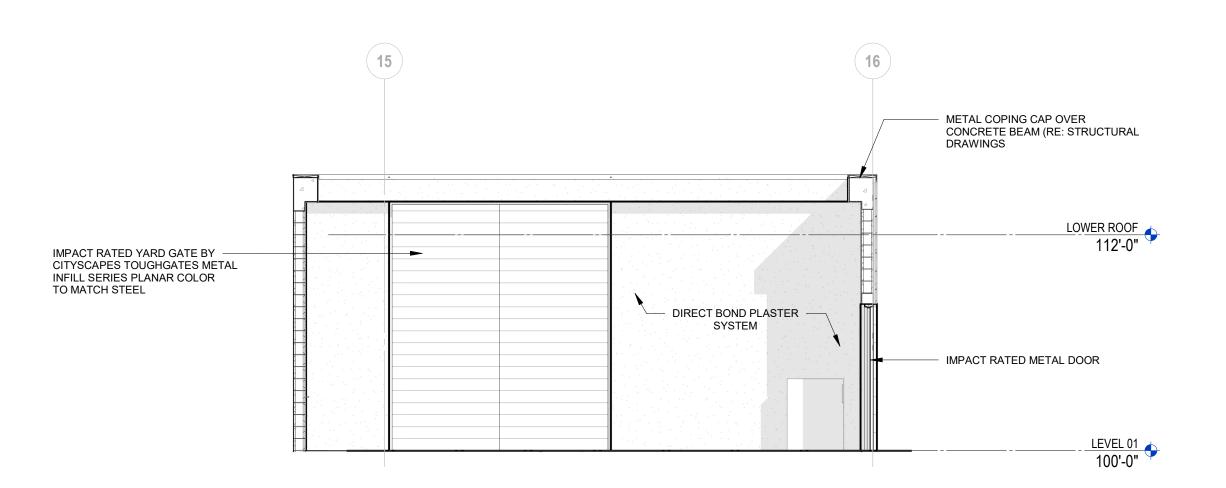

YARD WEST ELEVATION ENLARGED

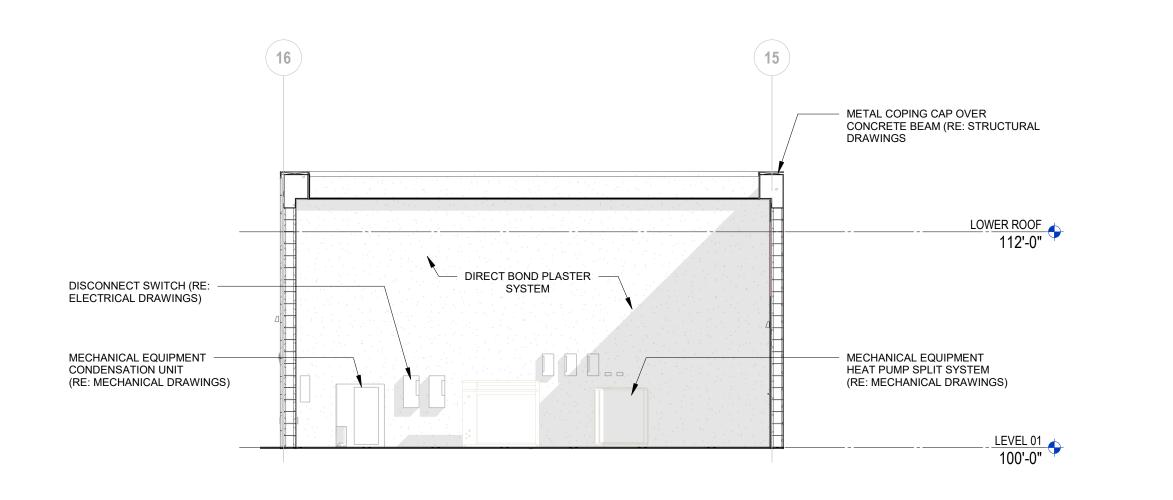

YARD NORTH ELEVATION ENLARGED SCALE: 3/16" = 1'-0"

5 YARD SOUTH ELEVATION ENLARGED



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ATLANTIC FIELDS GOLF HOUSE

PERMIT SET


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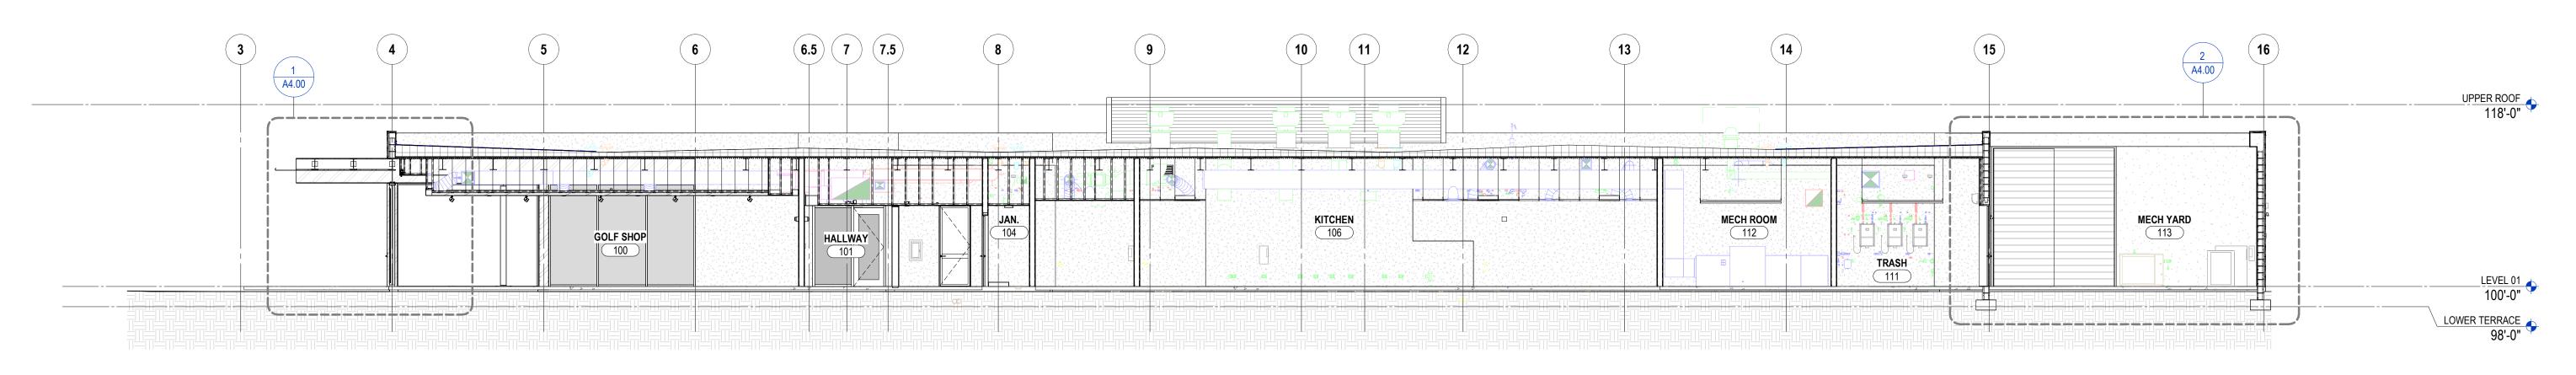
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Checked:



BUILDING SECTION - BOH - E-W

SCALE: 1/8" = 1'-0"

E D C B A

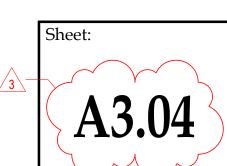1 AA.01

1 AA.02

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1 AA.02

1 DVPER ROOF
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118-0*

1 LOWER TERRACE
SCREENED
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E D C B A

UPPER ROOF
118-0*

TERRACE SCREENED DINNO 115

LOWER TERRACE SCREENED DINNO 115


LOWER TIGHT OF THE ROOF TO THE RO

BUILDING SECTION - PRO SHOP - N-S

SCALE: 1/8" = 1'-0"

BUILDING SECTION - KITCHEN - N-S1

SCALE: 1/8" = 1'-0"

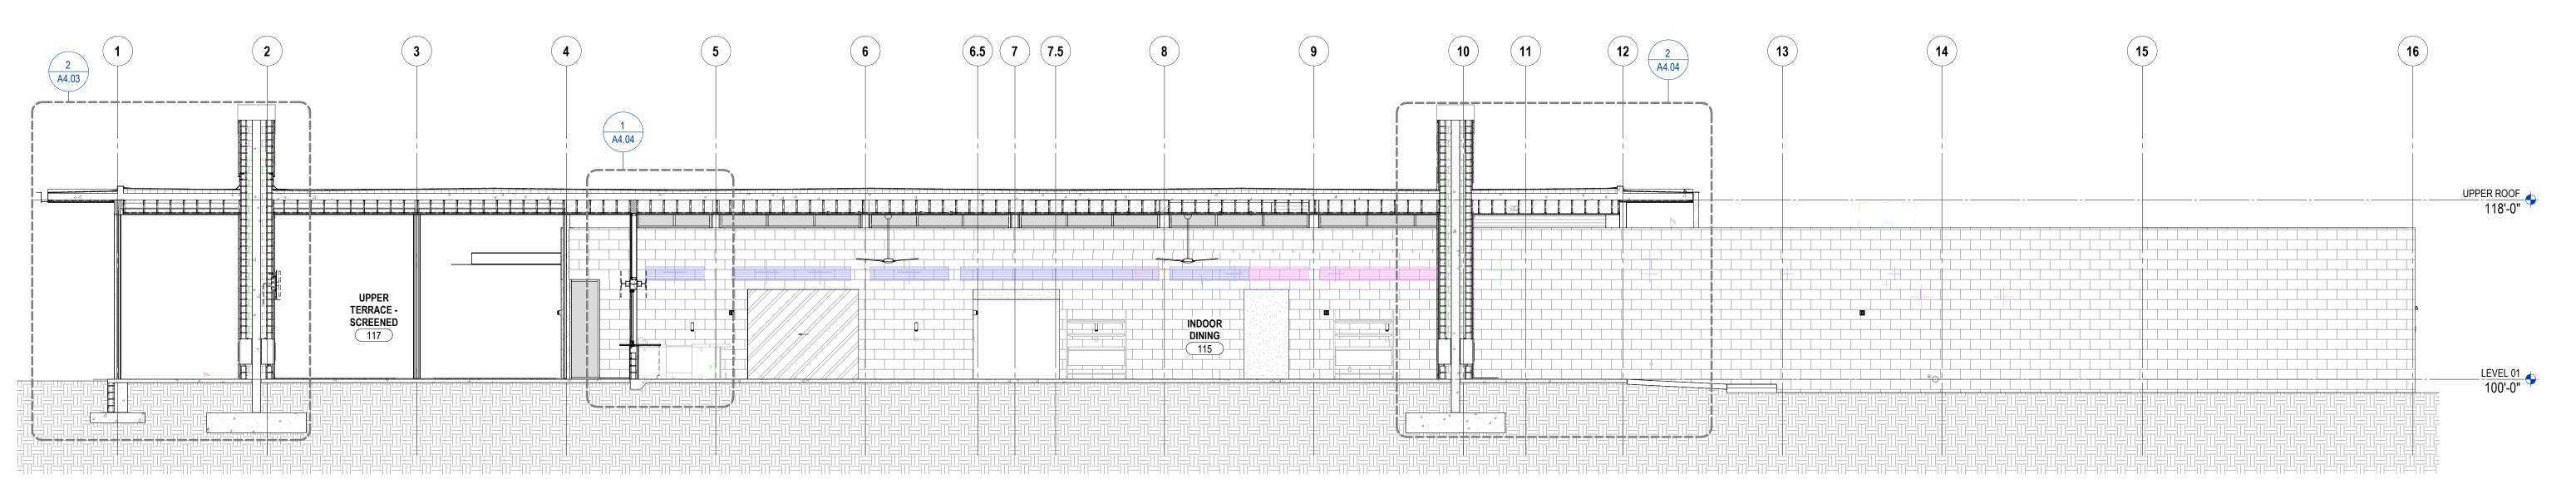

1 BUILDING SECTION - DINING - E-W

SCALE: 1/8" = 1'-0"



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DESIGN ARCHITECT

T. 561.626.9704

Olson Kundig

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Suite 600
Seattle, WA 98104



ATLANTIC FIELDS -GOLF HOUSE

PERMIT SET

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SECTIONS

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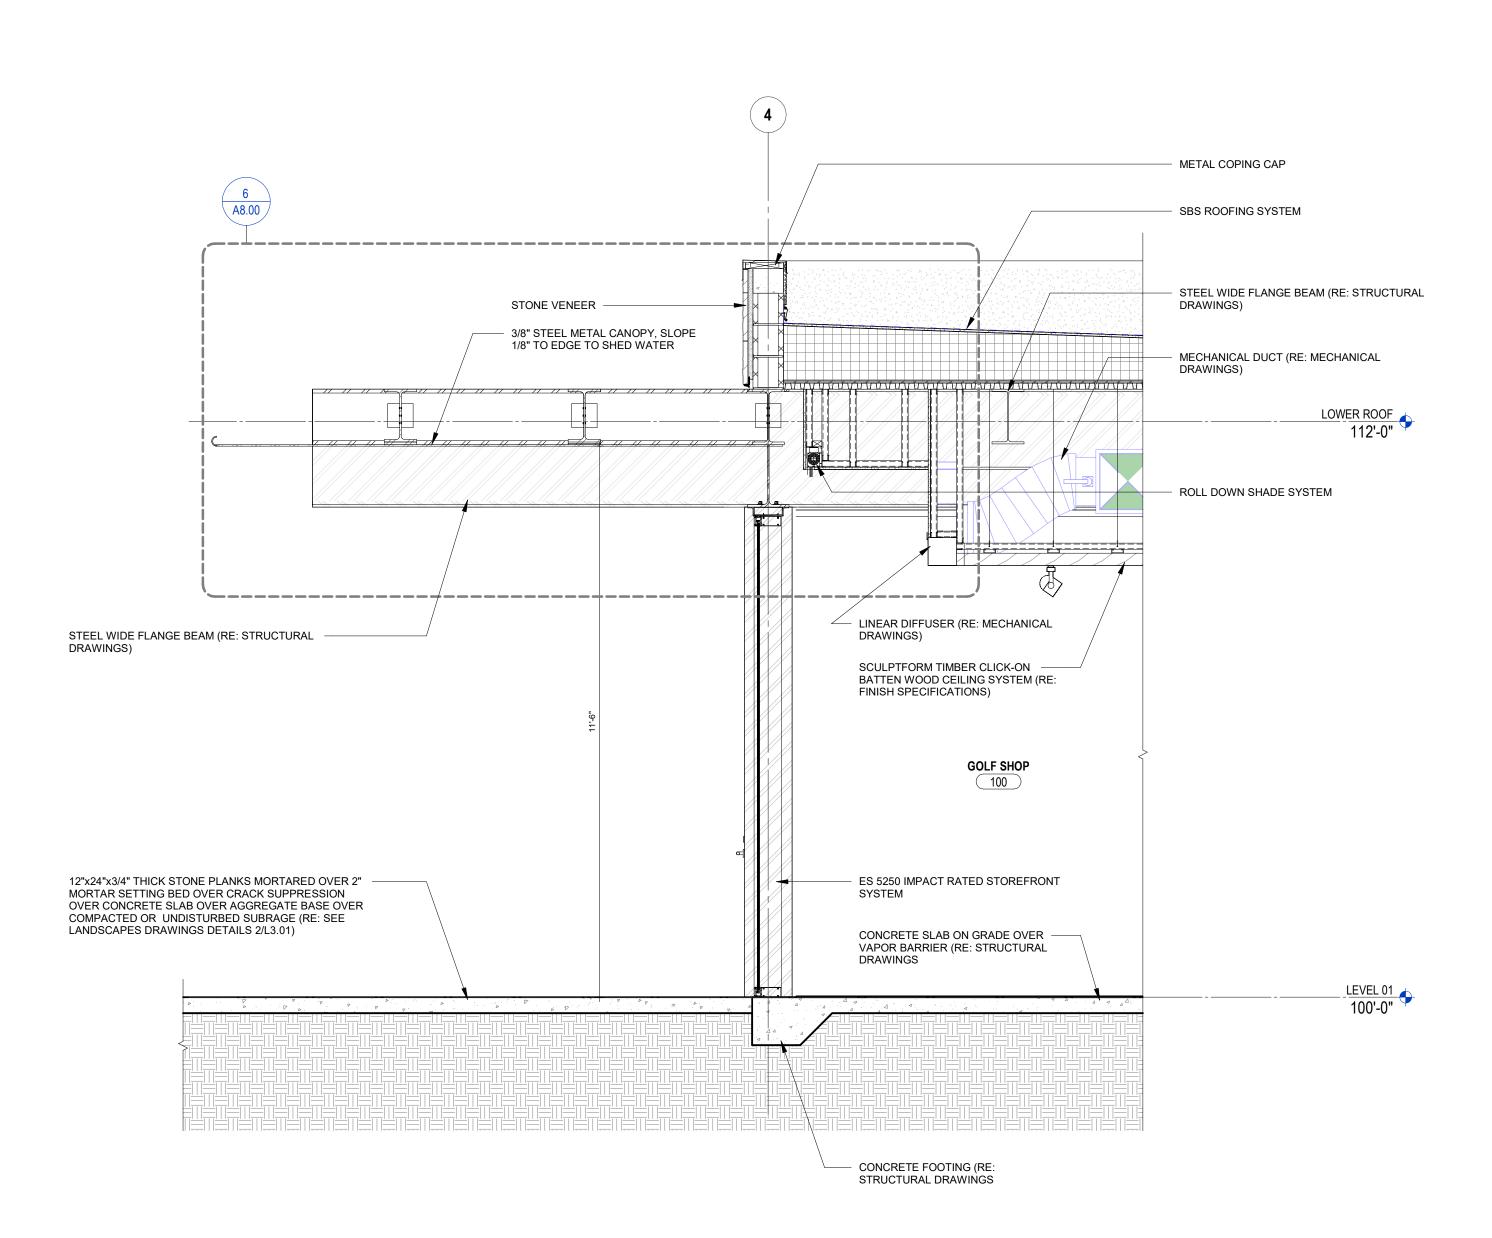
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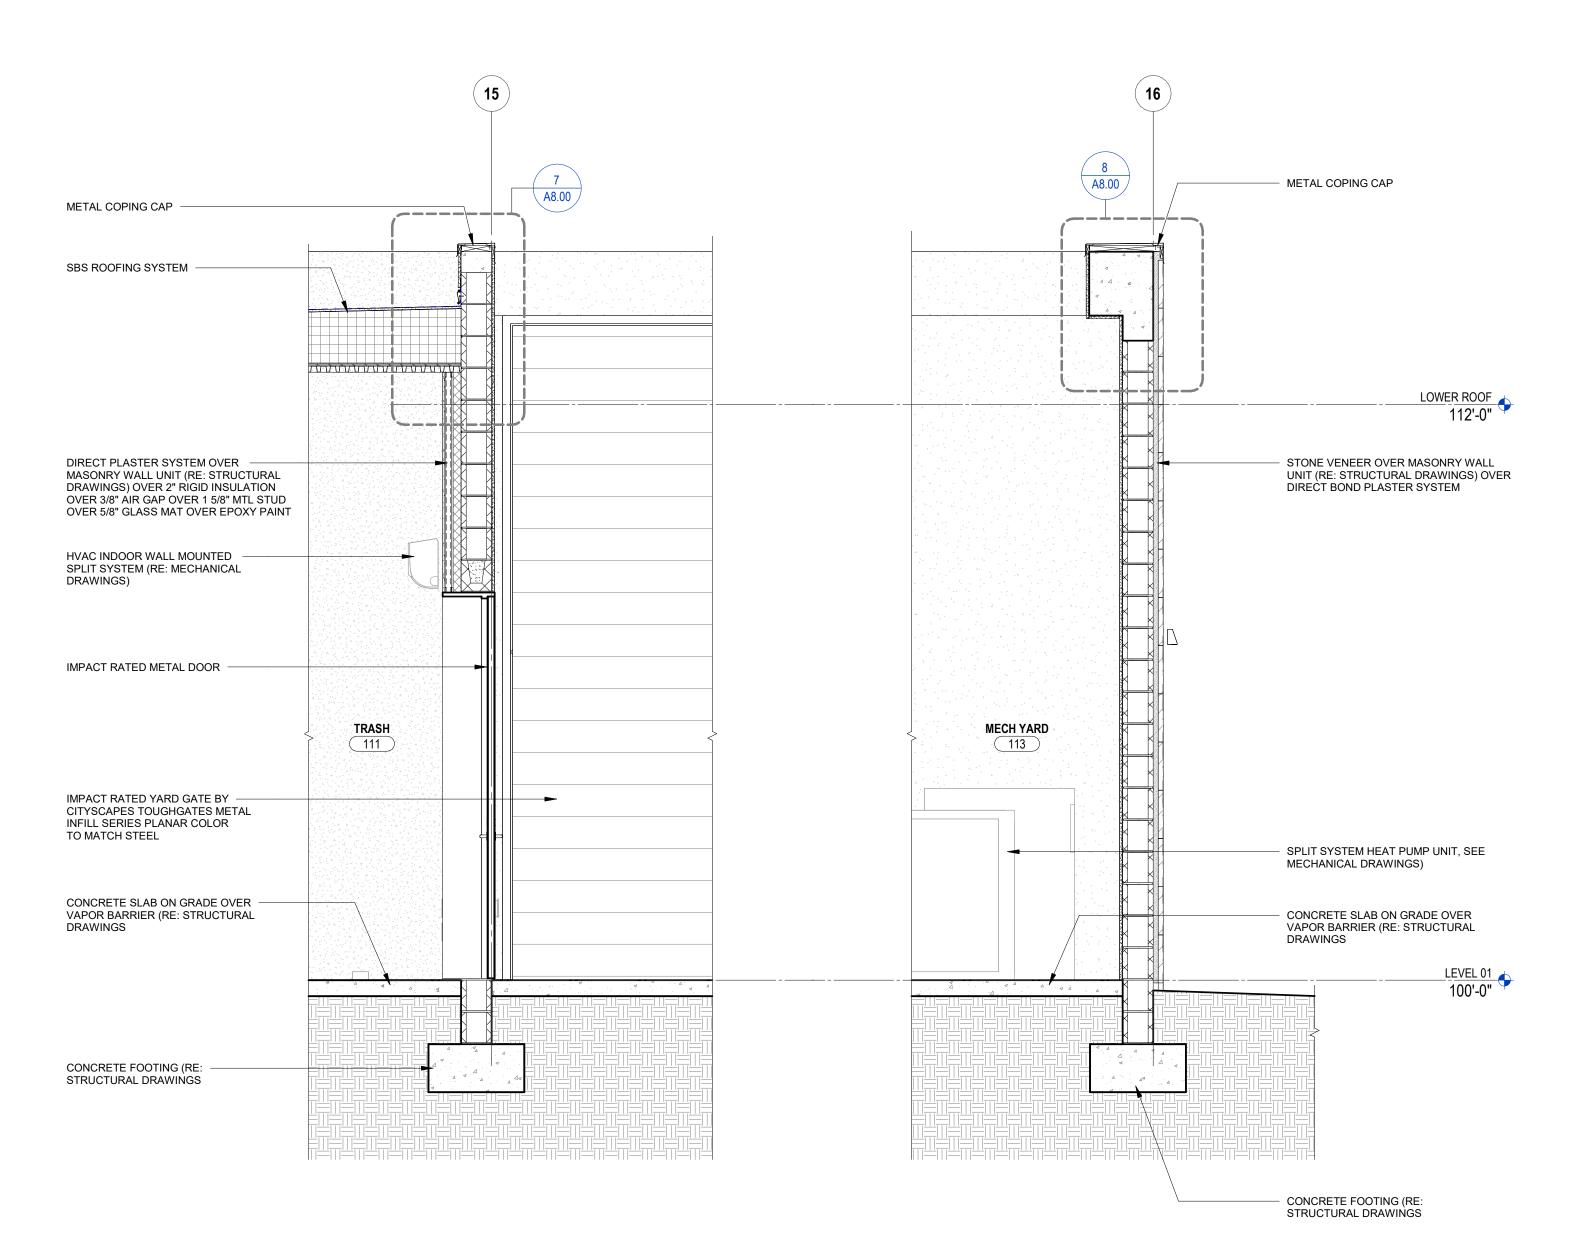
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2 WALL SECTION - BOH / MECH YARD

SCALE: 1/2" = 1'-0"



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DESIGN ARCHITECT





ATLANTIC FIELDS GOLF HOUSE

PERMIT SET

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WALL SECTIONS

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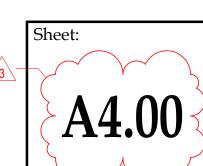
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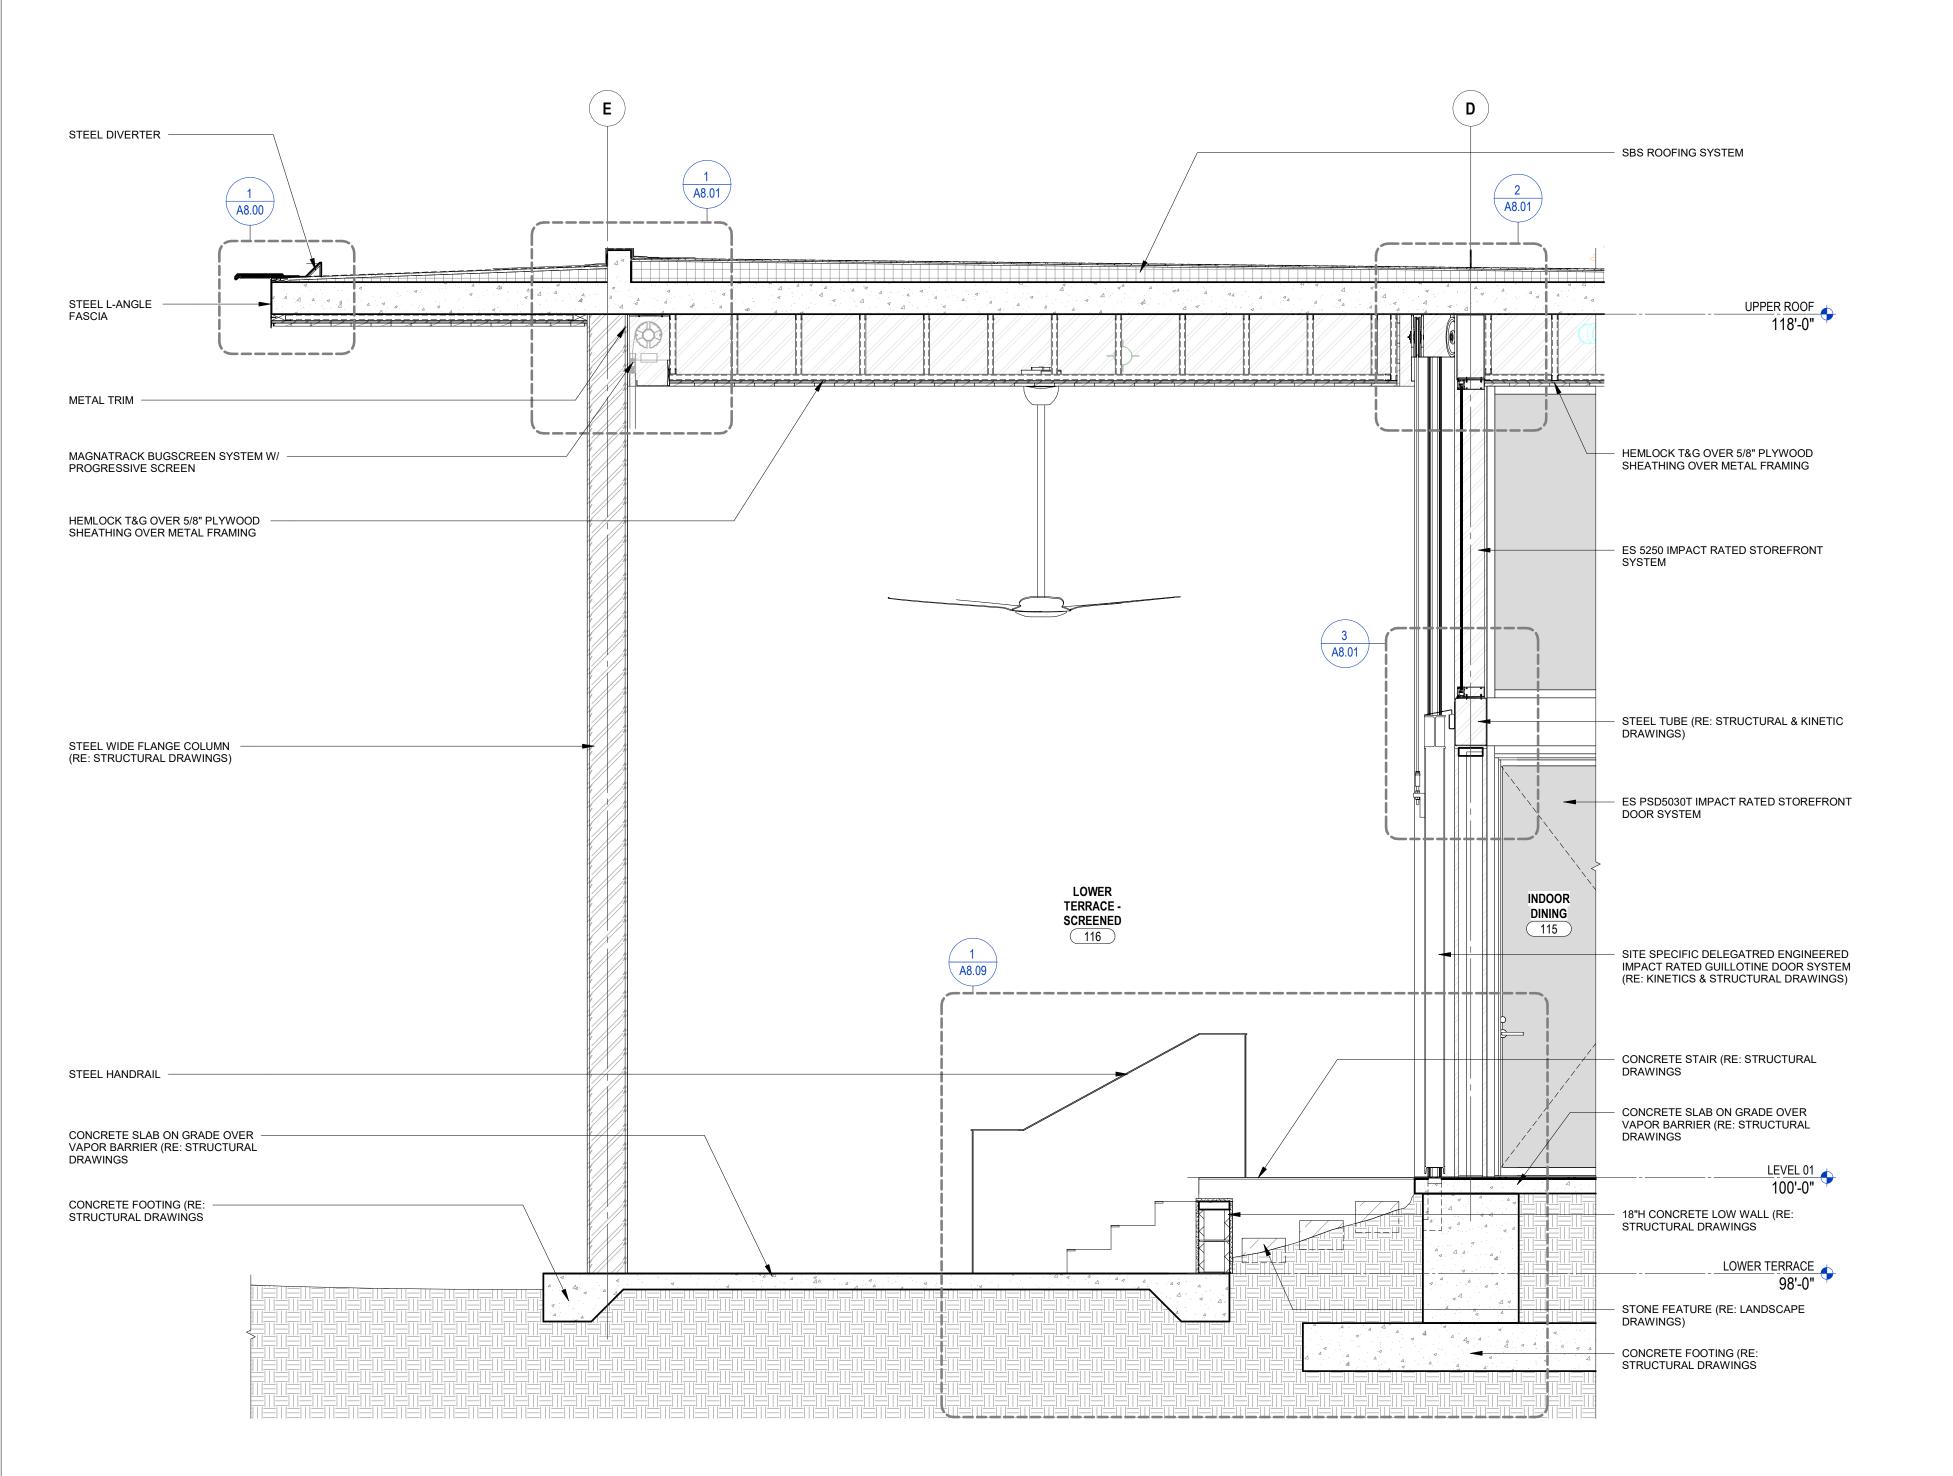
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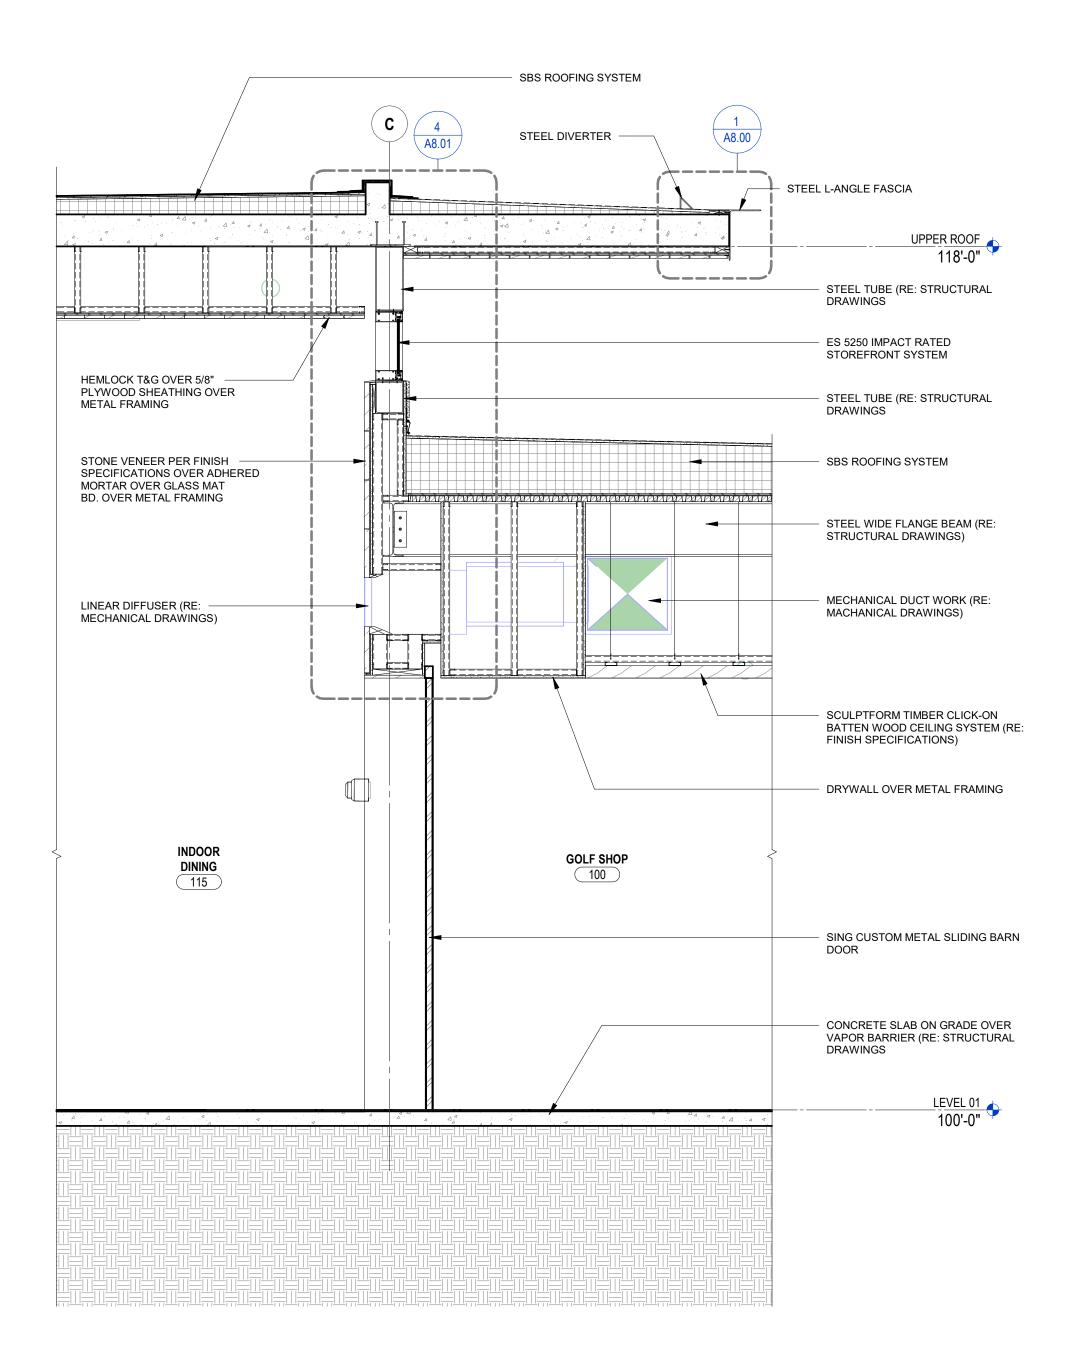
No. Description Date Addendum #1 03.22.2024

Date: Comm: 11.01.2023

22-061 Drawn By: Checked:









2 WALL SECTION INDOOR DINING & GOLF-SHOP

SCALE: 1/2" = 1'-0"





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DESIGN ARCHITECT Olson Kundig

> 159 South Jackson St, Suite 600



FIELDS

ATLANTIC FIELDS GOLF HOUSE

PERMIT SET

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WALL SECTIONS

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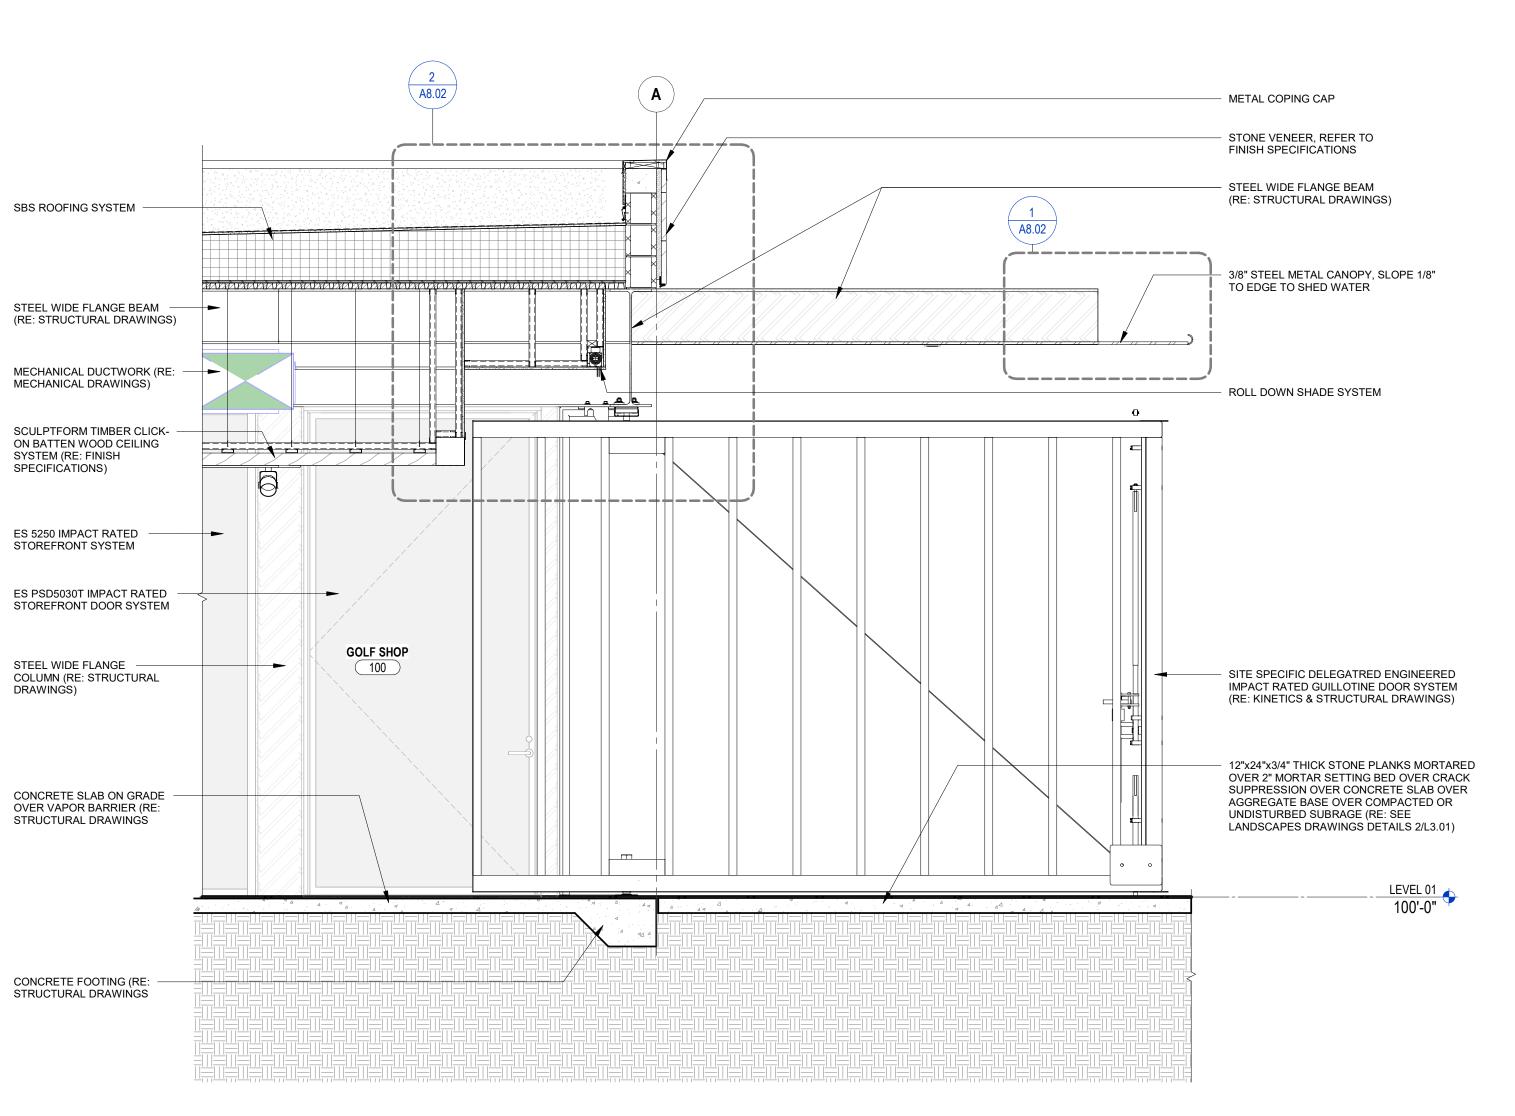
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ATLANTIC FIELDS GOLF HOUSE

SBS ROOFING SYSTEM

HEMLOCK T&G OVER 5/8"
 PLYWOOD SHEATHING OVER

METAL FRAMING

- ES 5250 IMPACT RATED

STOREFRONT SYSTEM

STEEL TUBE (RE: STRUCTURAL & KINETIC DRAWINGS)

SITE SPECIFIC DELEGATRED

ENGINEERED IMPACT RATED

GUILLOTINE DOOR SYSTEM (RE: KINETICS & STRUCTURAL

CONCRETE SLAB ON GRADE
 OVER VAPOR BARRIER (RE:
 STRUCTURAL DRAWINGS

18"H CONCRETE LOW WALL (RE: STRUCTURAL DRAWINGS

CONCRETE FOOTING (RE: STRUCTURAL DRAWINGS

LEVEL 01 100'-0"

DRAWINGS)

INDOOR DINING

A8.01

LOWER

TERRACE -

SCREENED

116

PERMIT SET

2645 SE BRIDGE ROAD, HOBE SOUND, FL 33455

Seal:

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WALL SECTIONS

of PEACOCK + LEWIS Architects and

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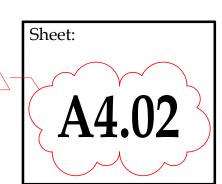
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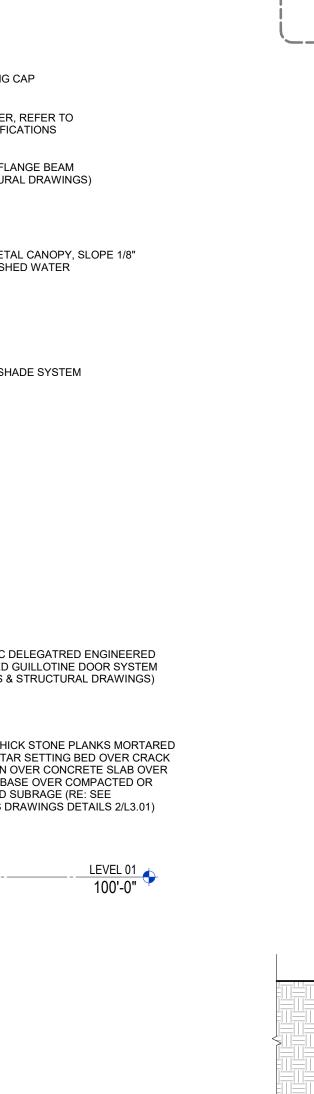
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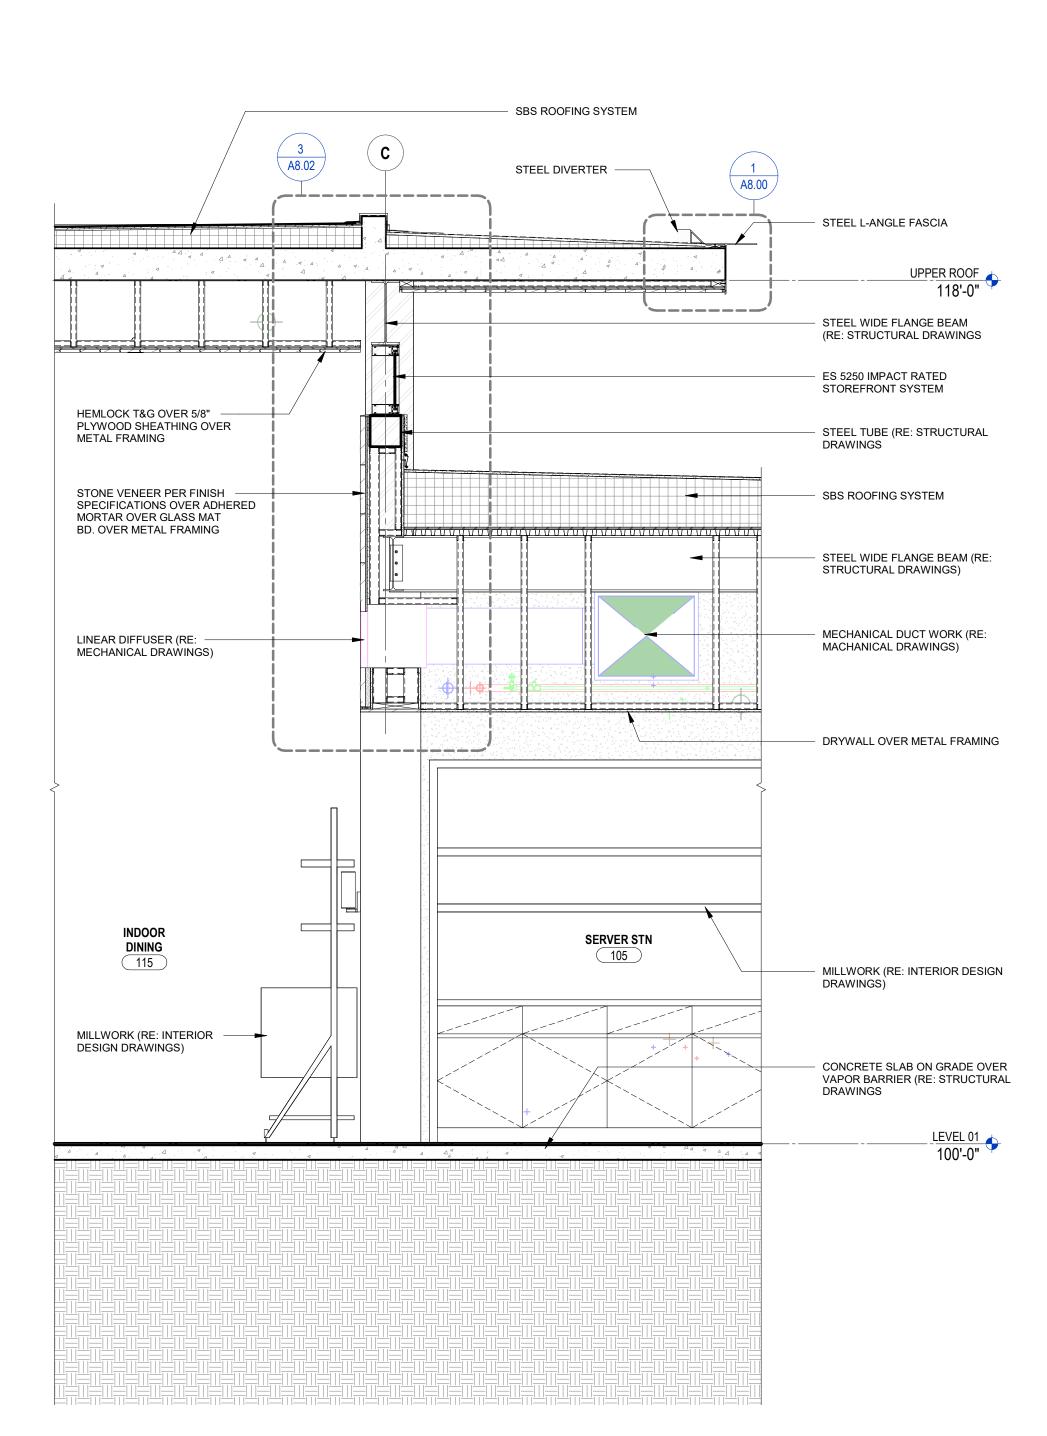




STEEL L-ANGLE FASCIA

STEEL DIVERTER


WALL SECTION @ INDOOR DINING / SERVER STATION @ CLERESTORY SCALE: 1/2" = 1'-0"





2 WALL SECTION @ UPPER TERRACE

SCALE: 1/2" = 1'-0"

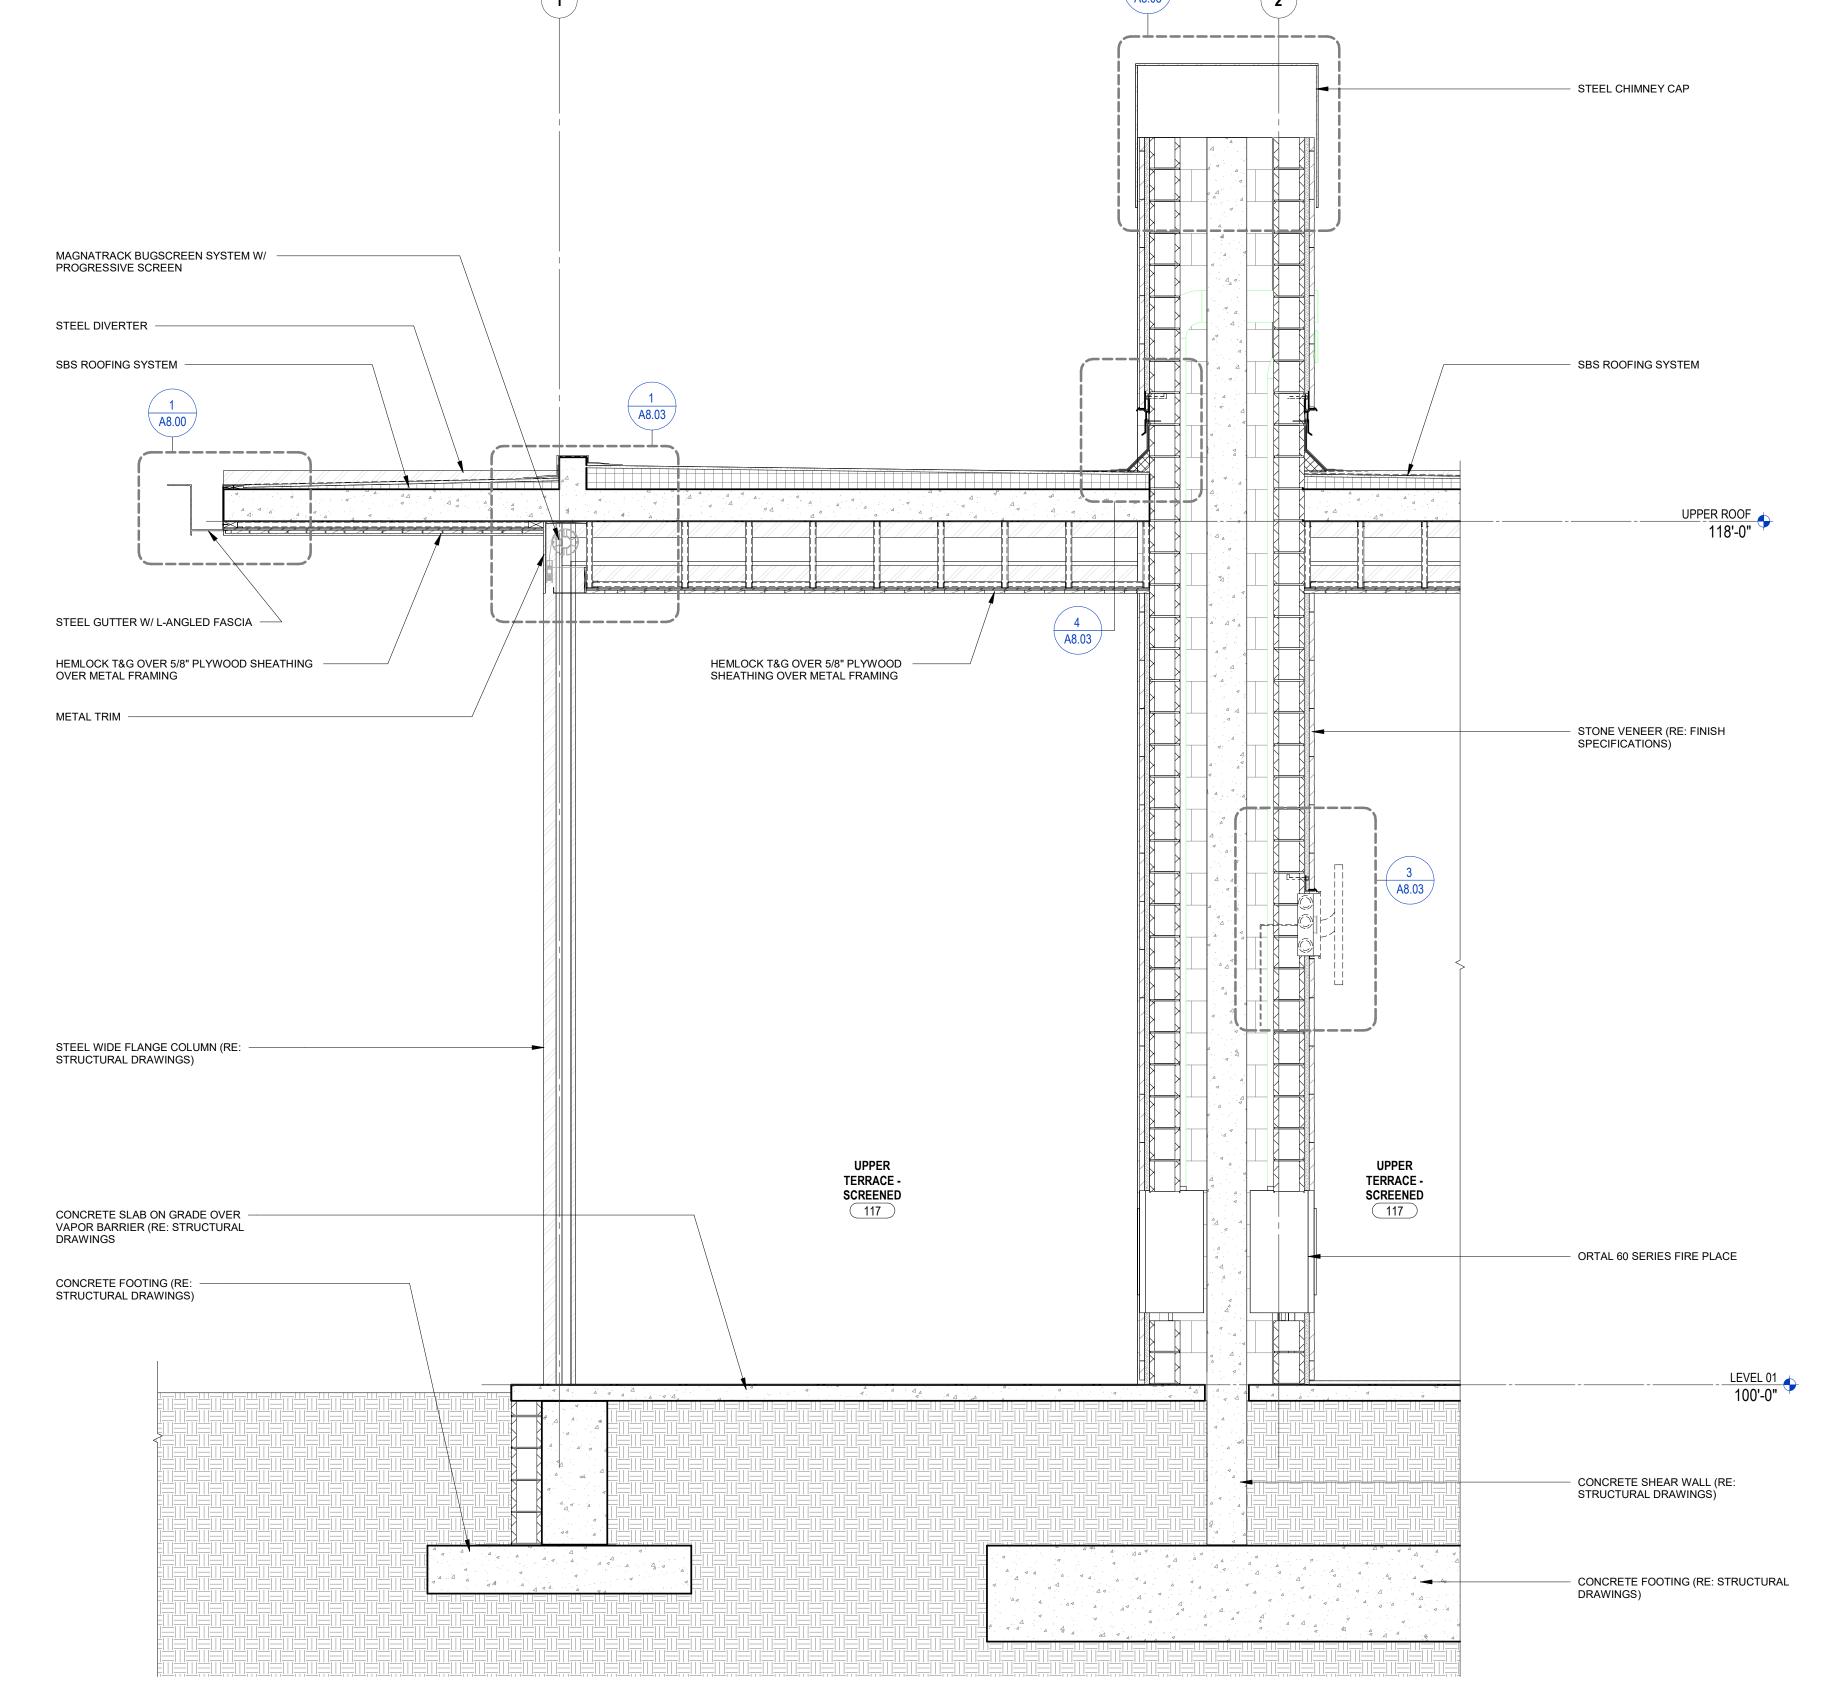



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DESIGN ARCHITECT



159 South Jackson St, Suite 600 Seattle, WA 98104







ATLANTIC FIELDS

GOLF HOUSE

PERMIT SET

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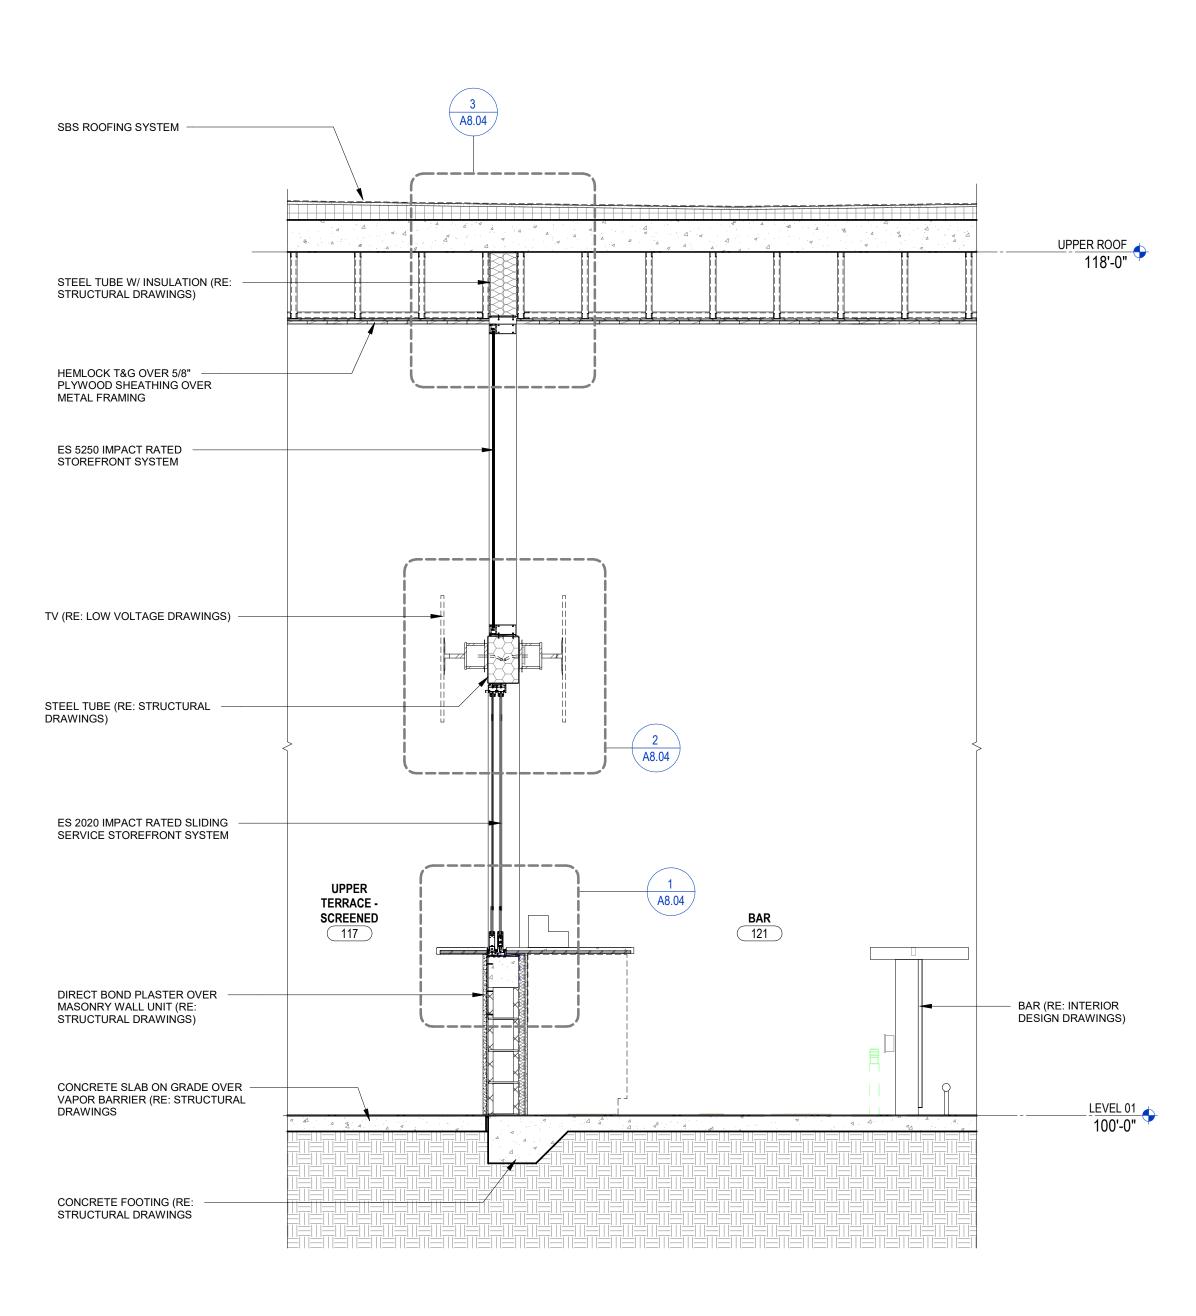
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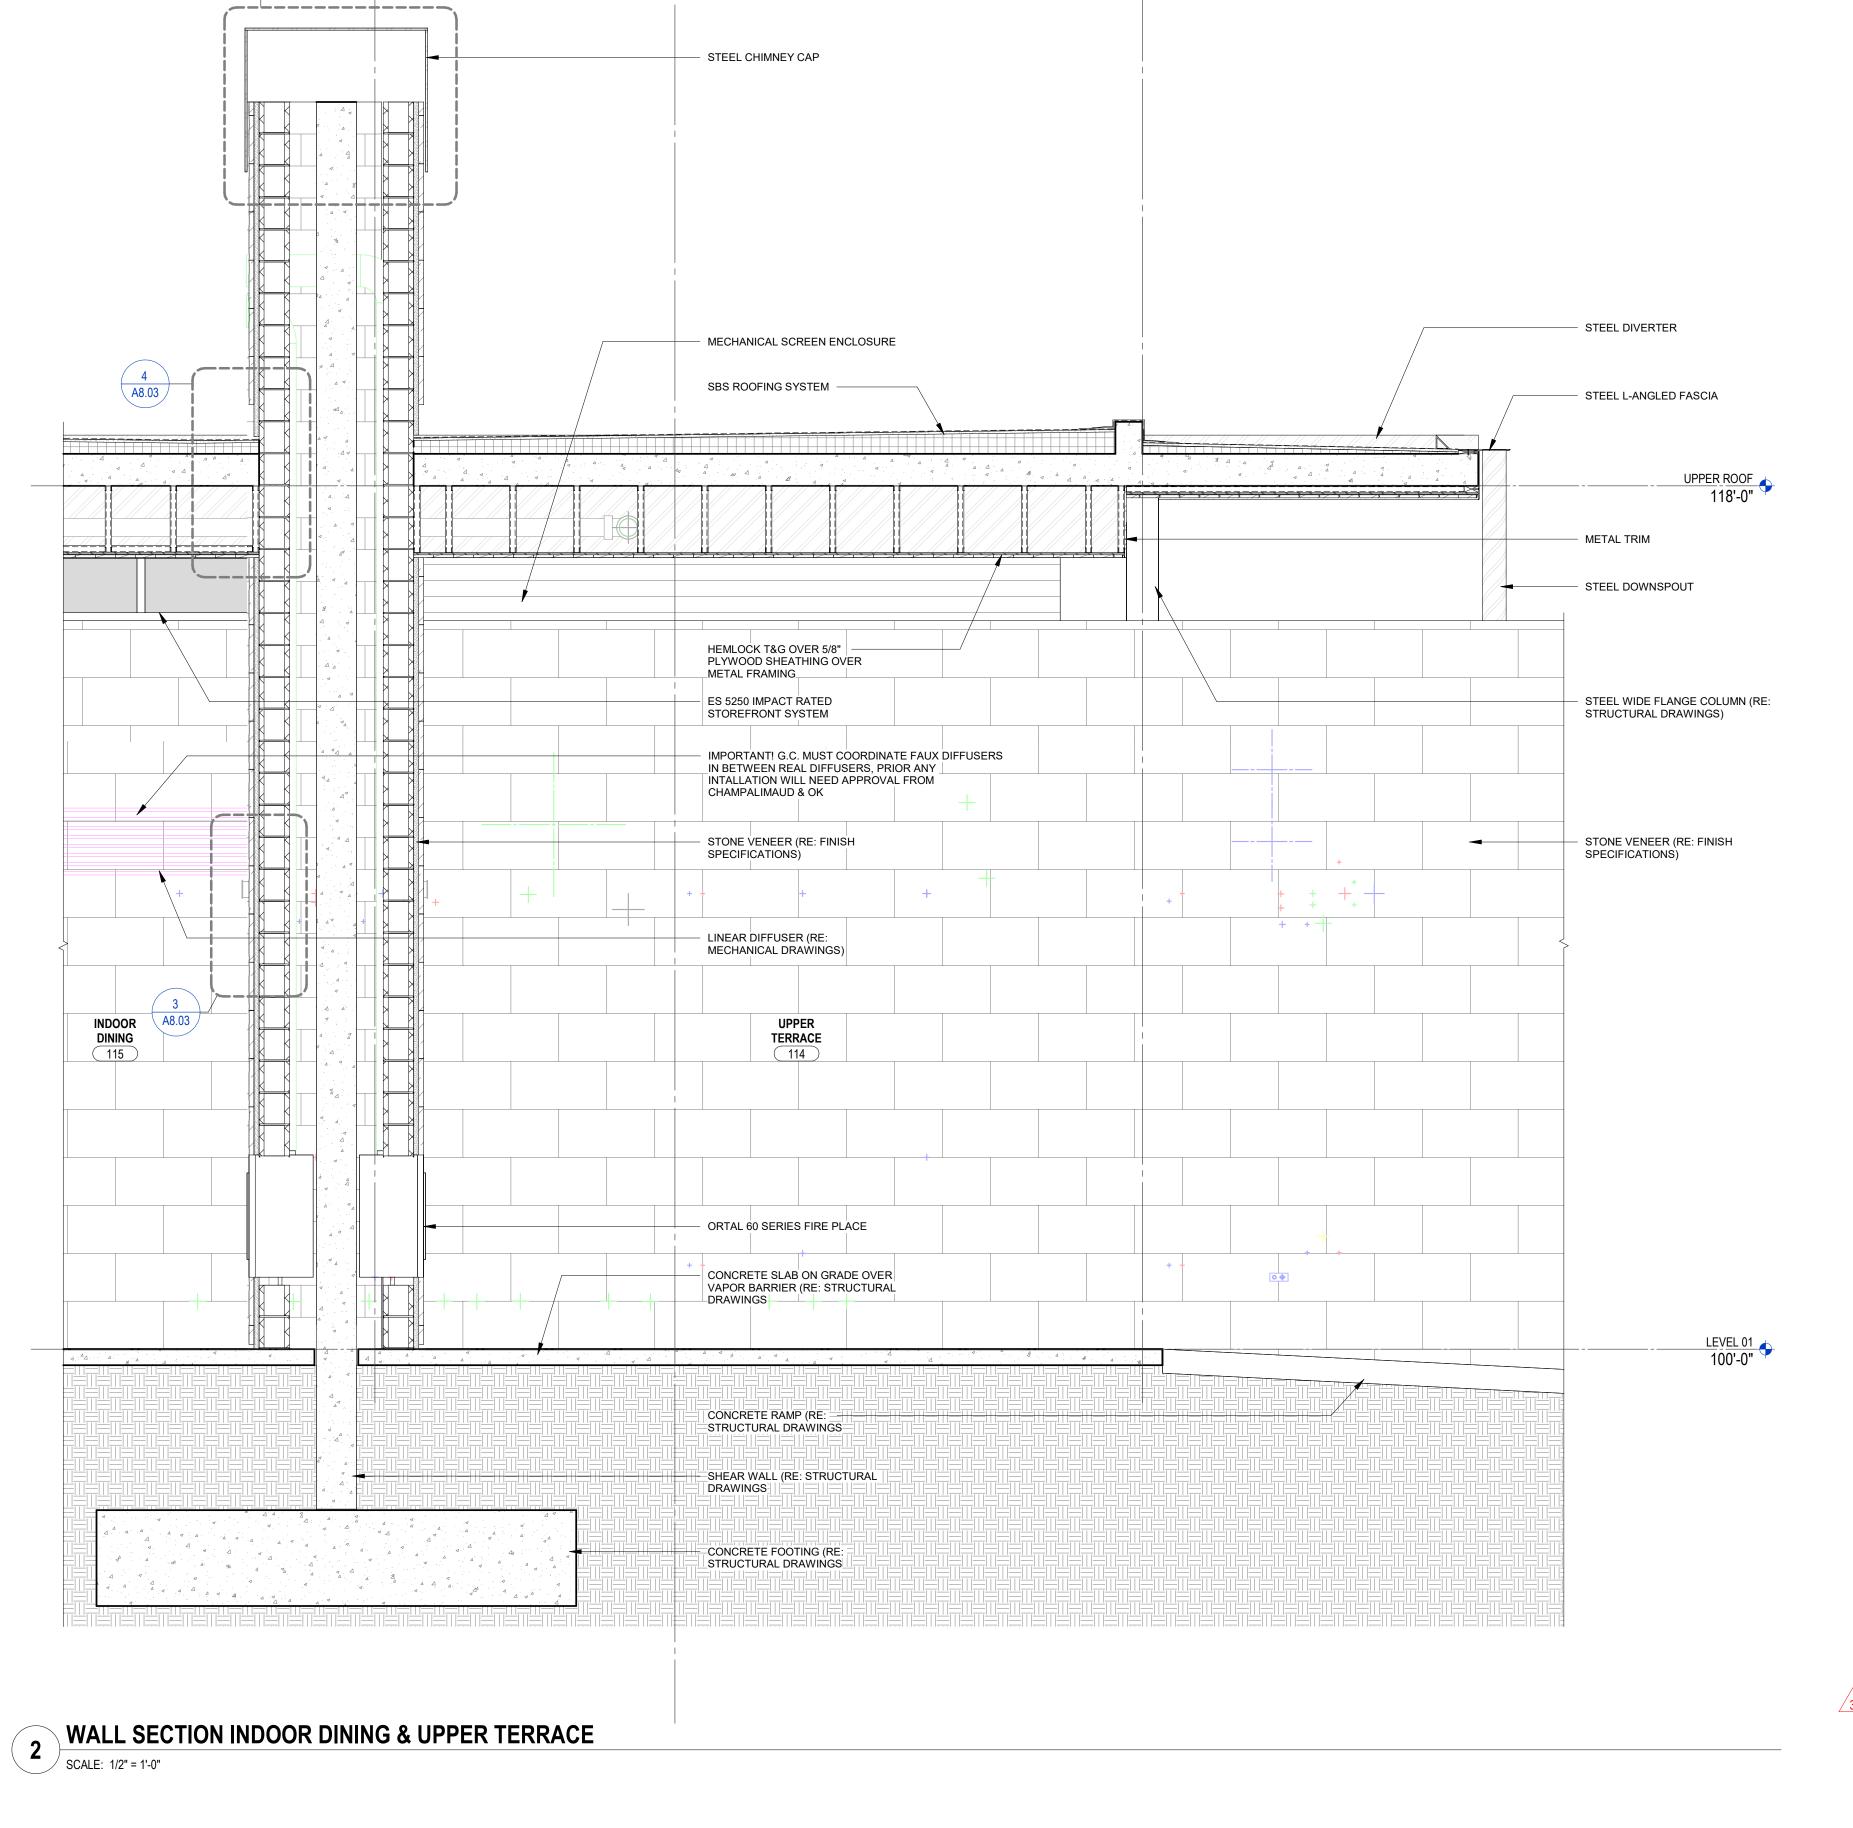
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WALL SECTIONS


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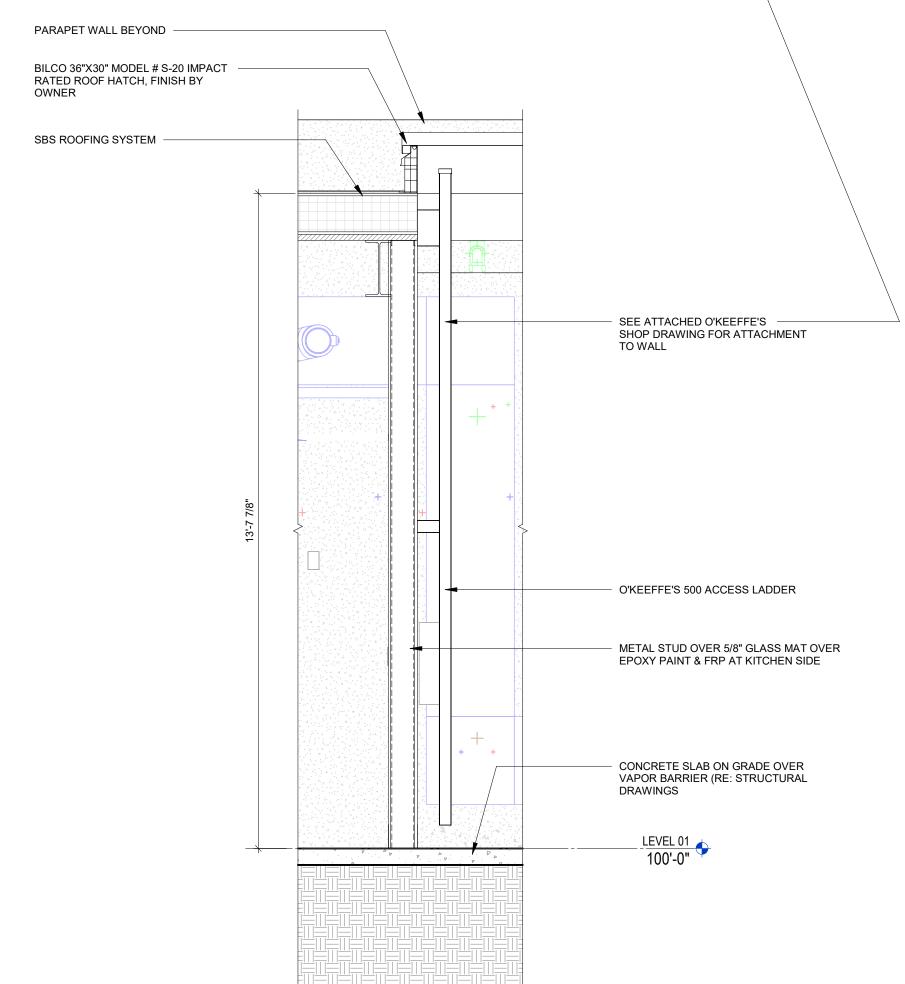
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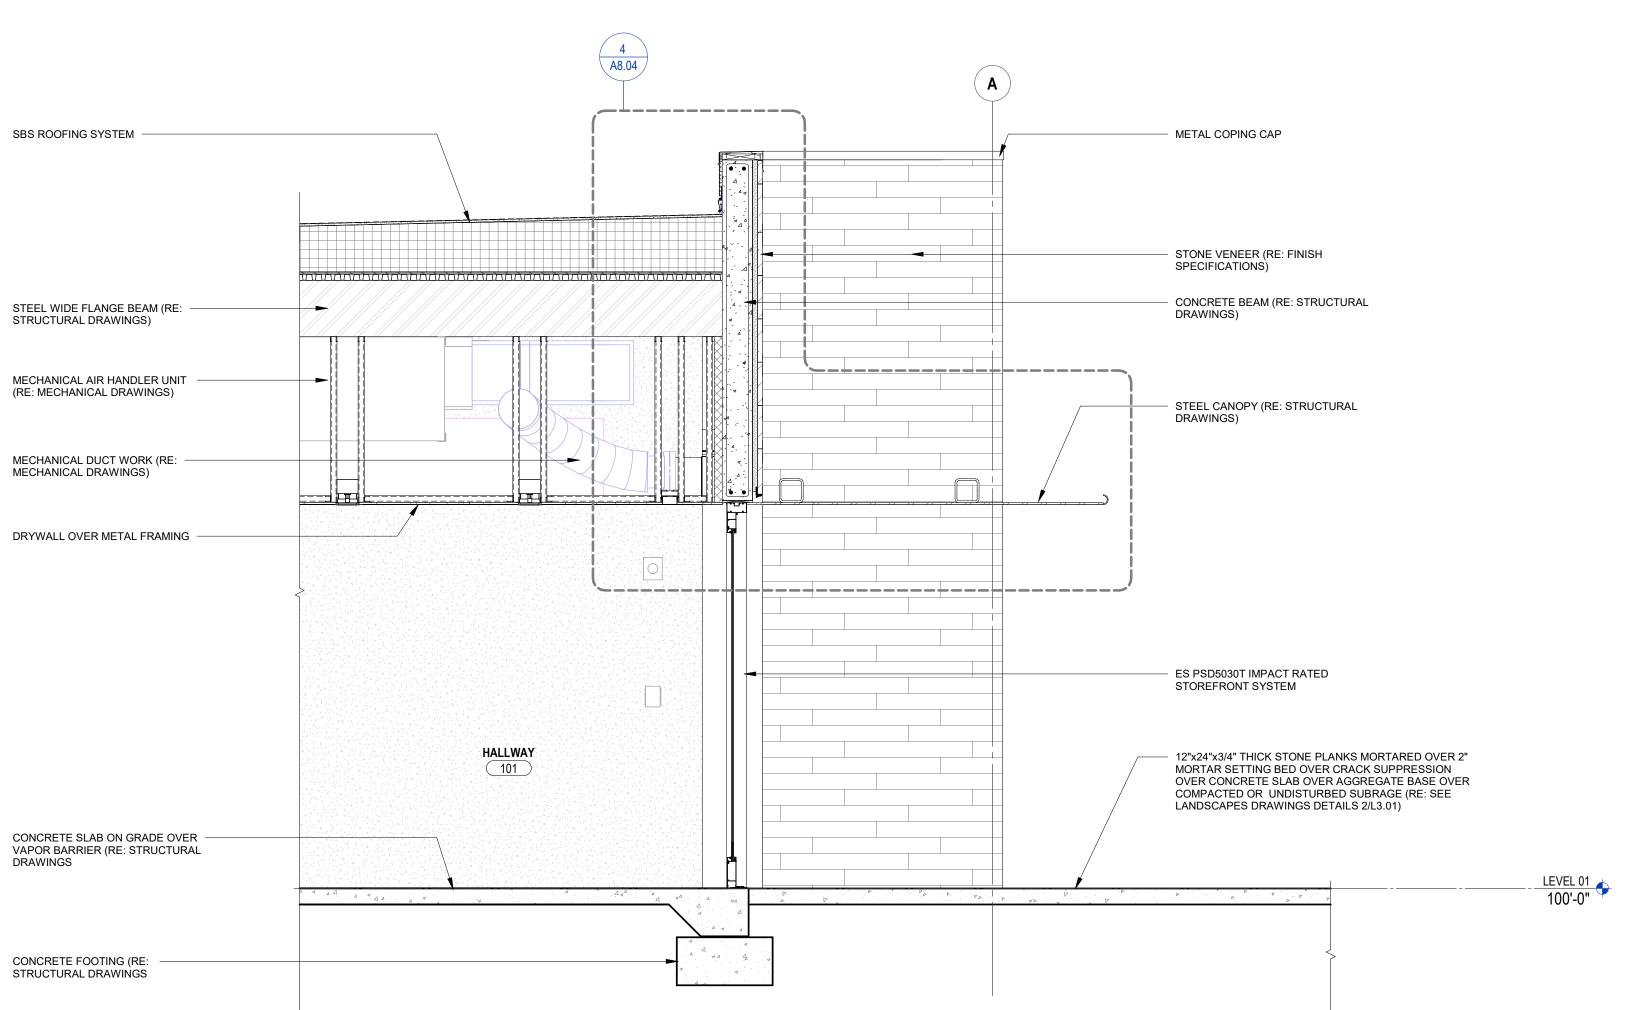
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1 WALL SECTION @ BAR SERVICE WINDOW SCALE: 1/2" = 1'-0"









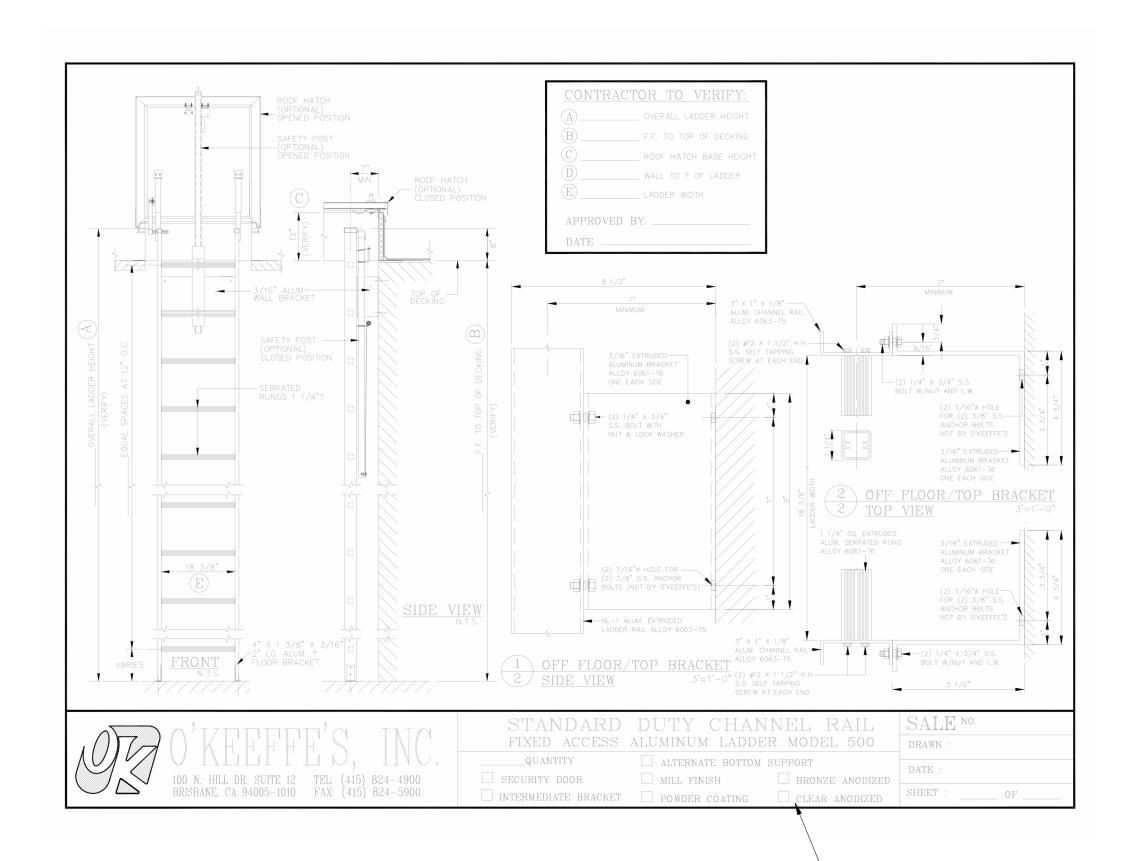

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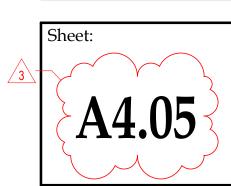
WALL SECTIONS


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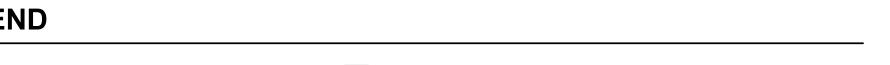
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MAIN LEVEL


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SCALE: 1/8" = 1'-0"



UPPER TERRACE -

SCREENED

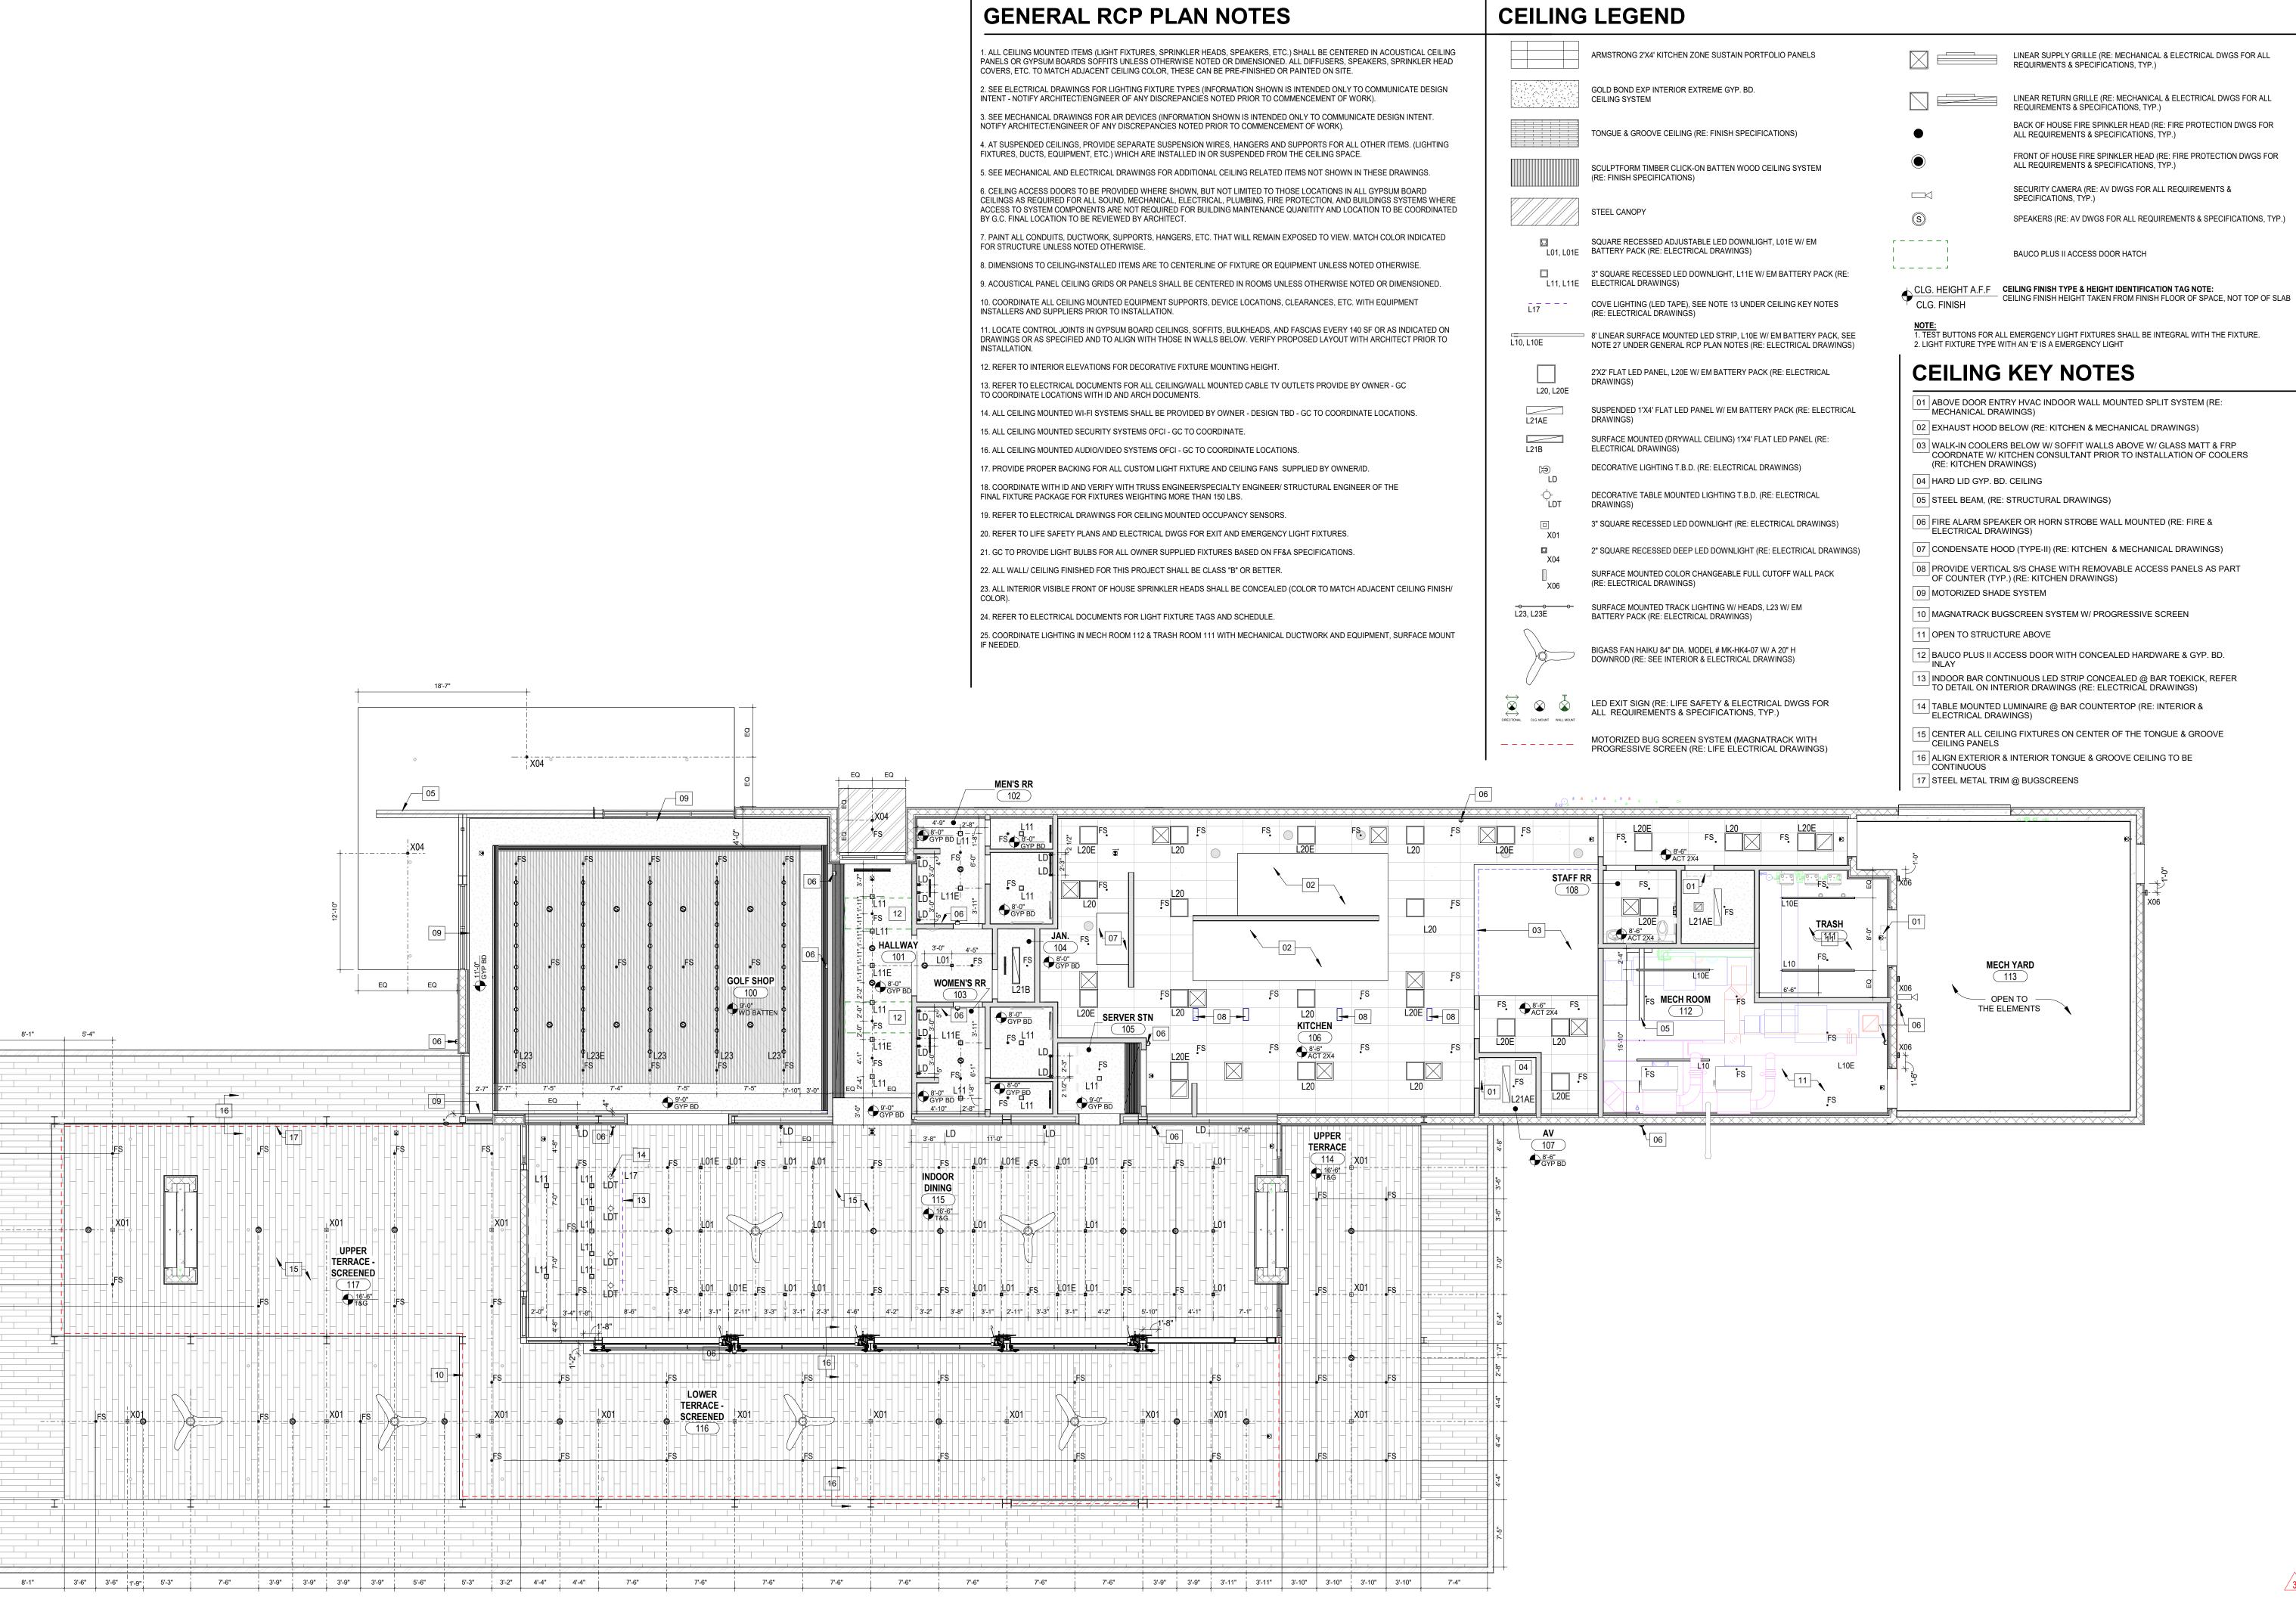117

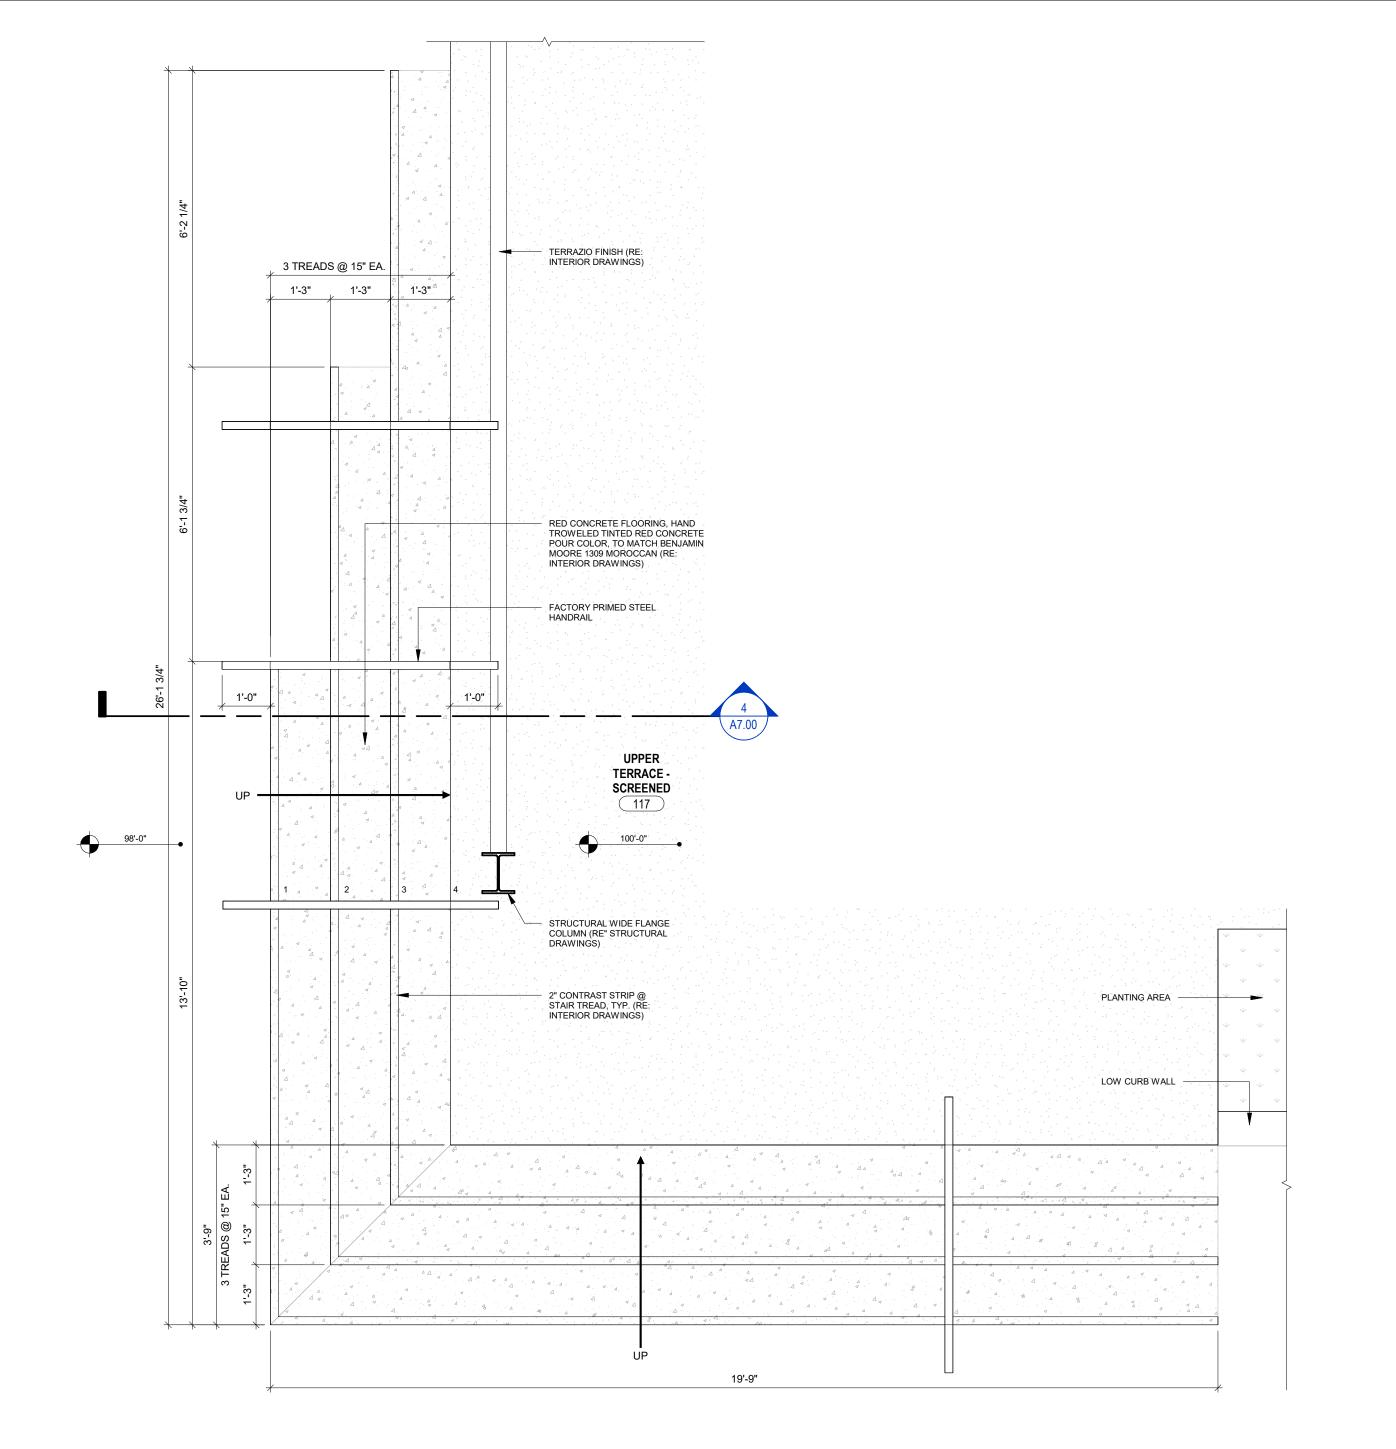100'-0"

ENLARGED STAIR PLAN A

FACTORY PRIMED STEEL

RED CONCRETE FLOORING, HAND TROWELED TINTED RED CONCRETE POUR COLOR, TO MATCH BENJAMIN MOORE

1309 MOROCCAN (RE:

INTERIOR DRAWINGS)

CONCRETE STAIR

(RE: STRUCTURAL DRAWINGS)

1/2" EXPANSION JOINT (RE: STRUSCTURAL

CONCRETE FOUNDATION AT

STAIR (RE: STRUCTURAL

DRAWINGS

STAIR SECTION A

SCALE: 1/2" = 1'-0"


DRAWINGS)

HANDRAIL

SCALE: 1/2" = 1'-0"

LOWER TERRACE -**SCREENED** RED CONCRETE FLOORING, HAND TROWELED TINTED RED CONCRETE POUR COLOR, TO MATCH 116 LOW CURB WALL MOROCCAN (RE: INTERIOR FACTORY PRIMED STEEL 2" CONTRAST STRIP @ STAIR TREAD, TYP. (RE: INTERIOR DRAWINGS) 6'-0" 98'-0"

2 ENLARGED STAIR PLAN B SCALE: 1/2" = 1'-0"

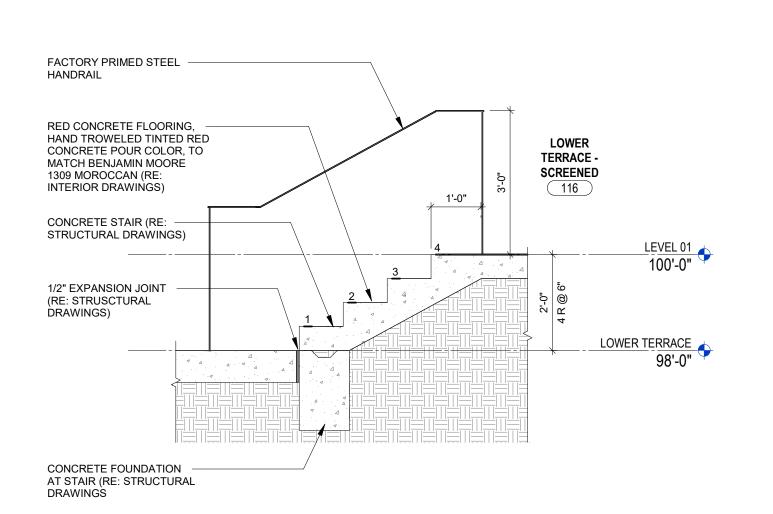

5 STAIR SECTION B

SCALE: 1/2" = 1'-0"

GENERAL STAIR & RAMP NOTES

1. GUARDRAIL SHALL BE DESIGNED AND CONSTRUCTED FOR CONCENTRATED LOAD OF 200IB APPLIED IN ANY DIRECTION AT THE TOP OF THE GUARDRAIL, A CONCENTRATED HORIZONTAL LOAD OF 200 IB APPLIED ON A 1 SQ FT AREA AT ANY POINT, AND A LINE LOAD OF 50 PFL APPLIED HORIZONTALLY AT THE REQUIRED GUARDRAIL HEIGHT W/A SIMULTANEOUS LINE LOAD OF 100 PLF APPLIED VERTICALLY DOWNWARD ON THE TOP OF THE GUARDRAIL. THESE LOADS SHALL NOT BE APPLIED SIMULTANEOUSLY BUT SHALL BE APPLIED INDIVIDUALLY TO PRODUCE MAX. STRESS IN EA. OF THE COMPONENTS OR

2. HANDRAIL SHALL COMPLY WITH THE GRASPABILITY REQUIREMENTS AS PER 2020 7TH EDITION FBC-C 1014.3.1 TYPE 1: HANDRAILS WITH A CIRCULAR CROSS SECTION SHALL HAVE AN OUTSIDE DIAMETER OF AT LEAST 1 1/4" (32MM) AND NOT GREATER THAN 2" (51MM). WHERE THE HANDRAIL IS NOT CIRCULAR, IT SHALL HAVE A PERIMETER DIMENSION OF AT LEAST 4" (102MM) AND NOT GREATER THAN 6 1/4" (160MM) WITH A MAXIMUM CROSS-SECTIONAL DIMENSION OF 2-1/4" (57MM) AND MINIMUM CROSS-SECTIONAL DIMENSION OF 1" (25MM). EDGES SHALL HAVE A MINIMUM RADIUS OF 0.01" (0.25MM)

3. GUARDS AND HANDRAILS TO COMPLY WITH NFPA 101, CHAPTER 7, 7.2.2.4

4. A 4" DIA. SPHERE SHALL NOT PASS THRU GUARDRAIL SYSTEM, TYP.

5. ALL STAIR CONNECTIONS AT PARKING RAMP SLOPE MUST HAVE NO MORE THAN 2% GROSS SLOPE.

6. ALL HANDRAILS SHALL BE FACTORY PRIMED AND PAINTED IN THE FIELD. COLOR BY OK

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ATLANTIC FIELDS **GOLF HOUSE**

PERMIT SET

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Seal:

RED CONCRETE FLOORING. HAND TROWELED TINTED RED CONCRETE POUR COLOR, TO MATCH BENJAMIN MOORE

1309 MOROCCAN (RE: INTERIOR DRAWINGS)

FACTORY PRIMED STEEL

2" CONTRAST STRIP @ STAIR TREAD, TYP. (RE: INTERIOR DRAWINGS)

- PLANTING AREA

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3	Addendum #1	03.22. 2024				

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STAIR SECTION C


9'-6" 98'-0"

TERRACE -

SCREENED


ENLARGED STAIR PLAN C SCALE: 1/2" = 1'-0"


LOW CURB WALL

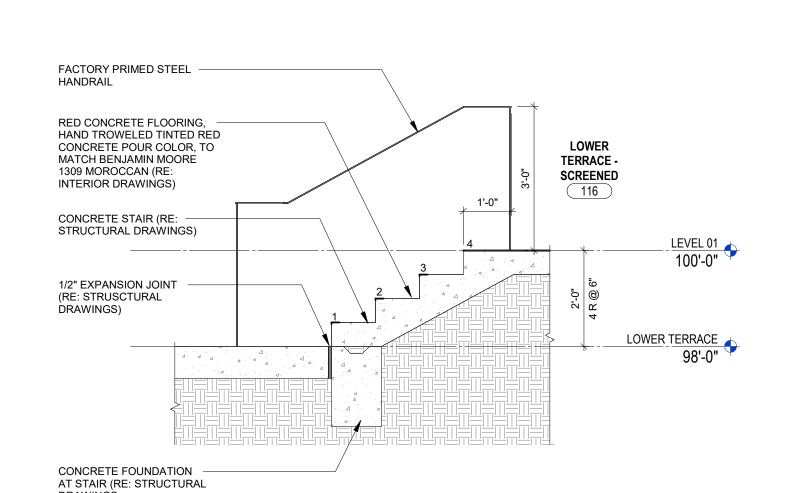

SCALE: 1/2" = 1'-0"

DRAWINGS

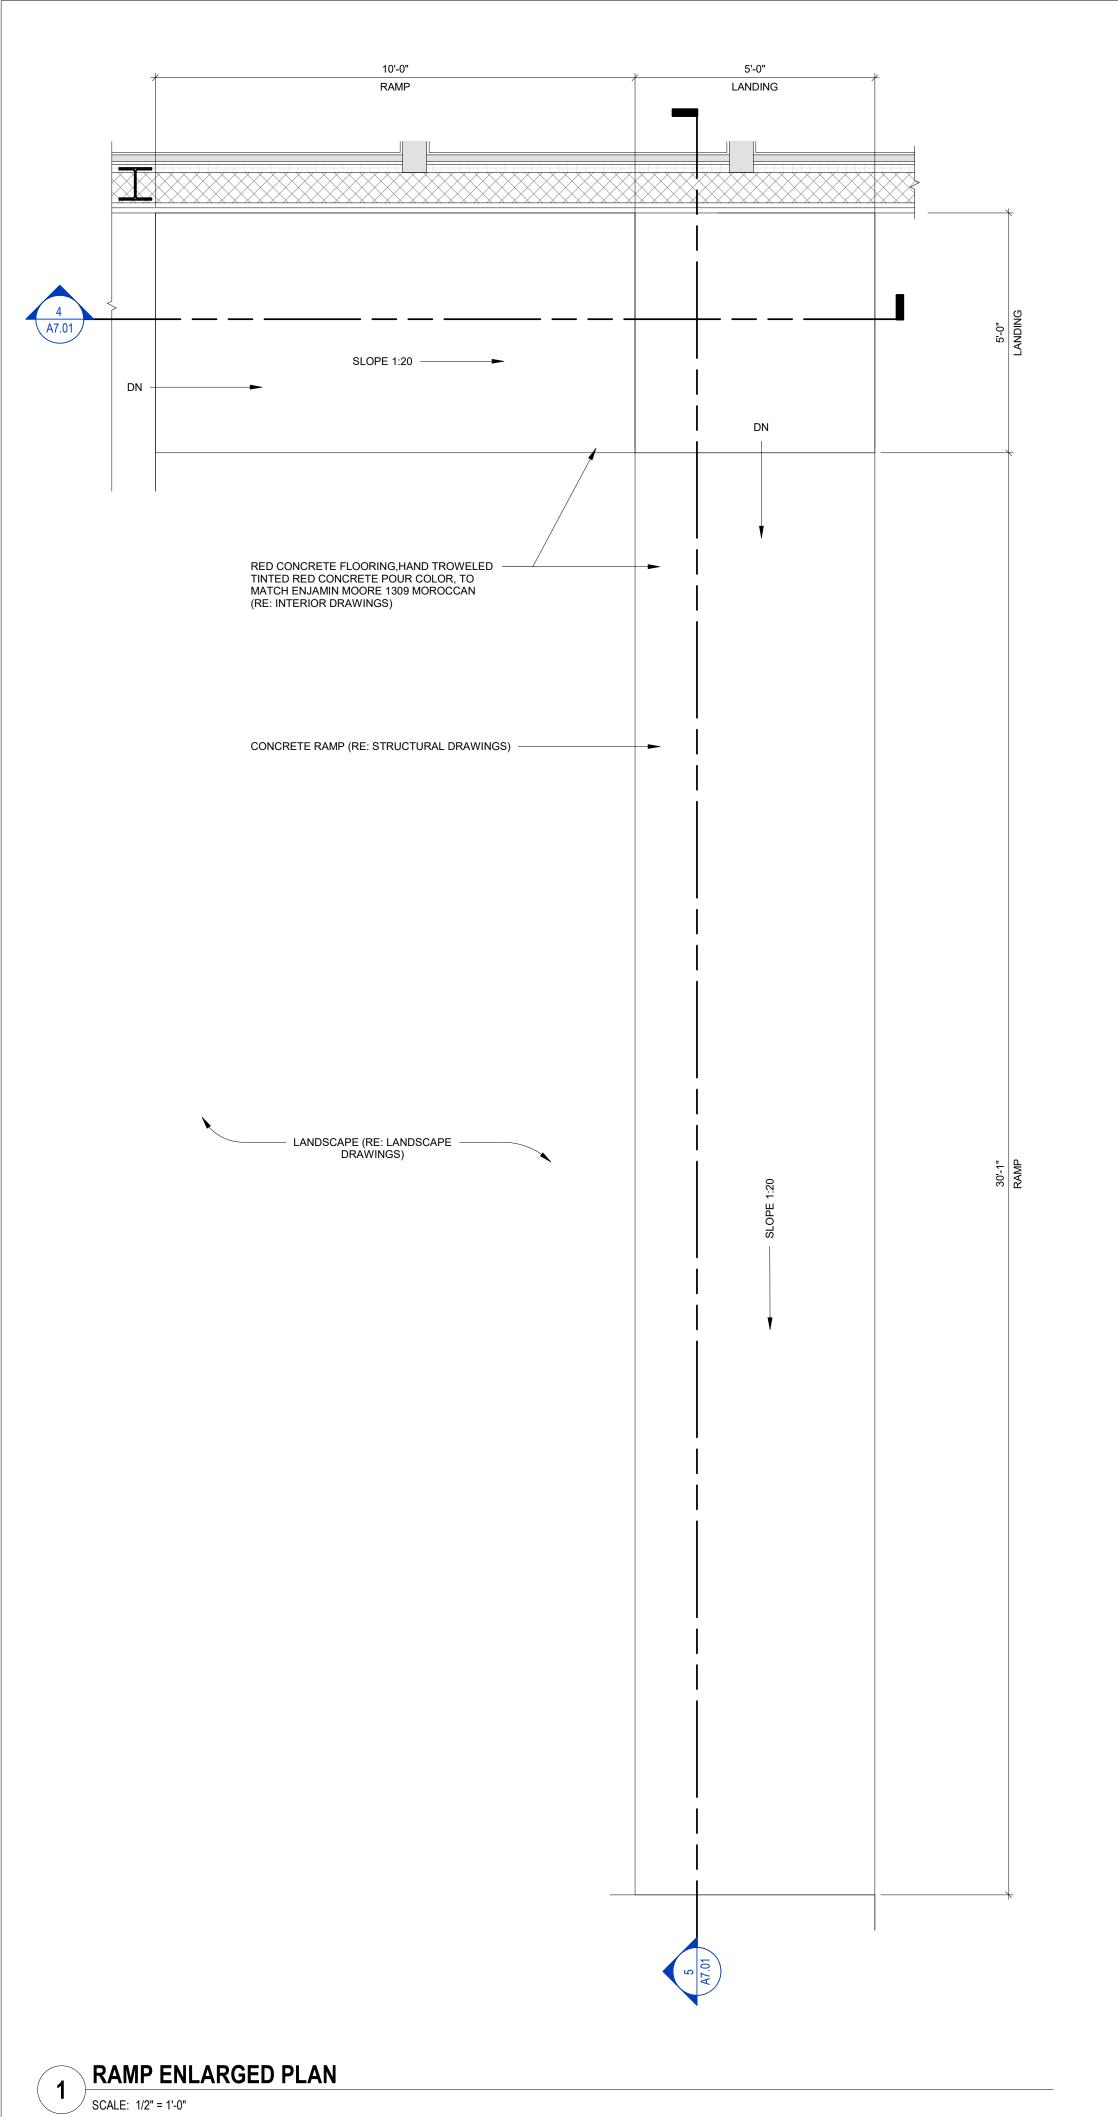

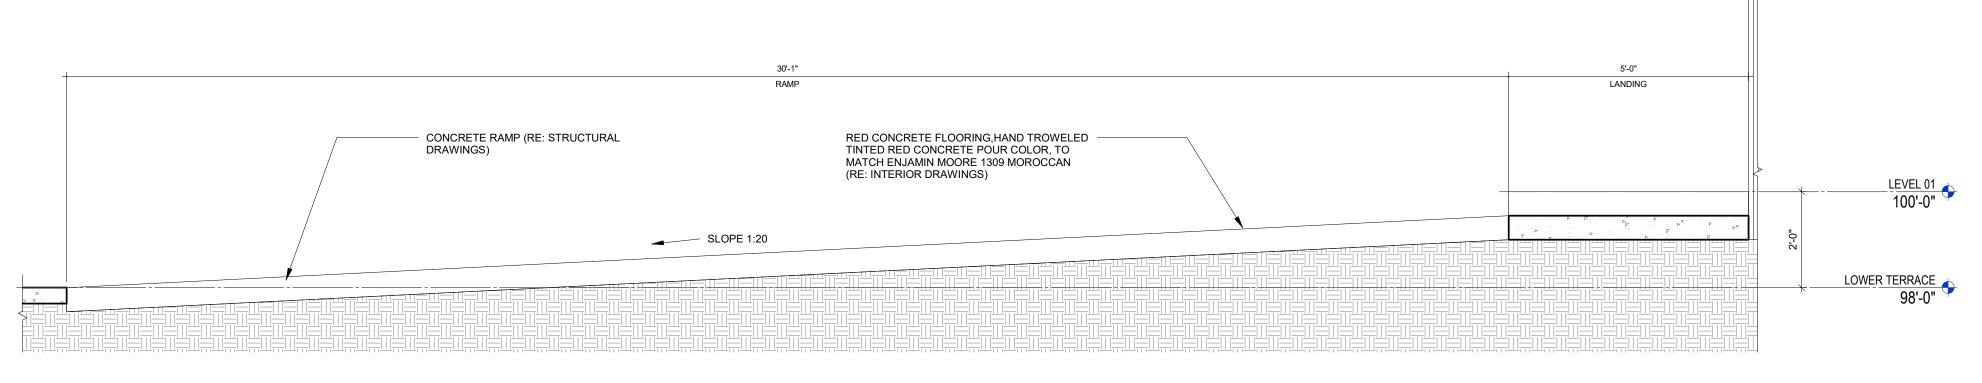

RAMP SECTION A

SCALE: 1/2" = 1'-0"

RED CONCRETE FLOORING, HAND TROWELED
TINTED RED CONCRETE POUR COLOR, TO
MATCH ENJAMIN MOORE 1309 MOROCCAN
(RE: INTERIOR DRAWINGS)

SLOPE 1:20

CONCRETE RAMP (RE: STRUCTURAL DRAWINGS)

4 RAMP SECTION B
SCALE: 1/2" = 1'-0"

GENERAL STAIR & RAMP NOTES

1. GUARDRAIL SHALL BE DESIGNED AND CONSTRUCTED FOR CONCENTRATED LOAD OF 2001B APPLIED IN ANY DIRECTION AT THE TOP OF THE GUARDRAIL, A CONCENTRATED HORIZONTAL LOAD OF 200 IB APPLIED ON A 1 SQ FT AREA AT ANY POINT, AND A LINE LOAD OF 50 PFL APPLIED HORIZONTALLY AT THE REQUIRED GUARDRAIL HEIGHT W/A SIMULTANEOUS LINE LOAD OF 100 PLF APPLIED VERTICALLY DOWNWARD ON THE TOP OF THE GUARDRAIL. THESE LOADS SHALL NOT BE APPLIED SIMULTANEOUSLY BUT SHALL BE APPLIED INDIVIDUALLY TO PRODUCE MAX. STRESS IN EA. OF THE COMPONENTS OR SUPPORTS.


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3. GUARDS AND HANDRAILS TO COMPLY WITH NFPA 101, CHAPTER 7, 7.2.2.4


4. A 4" DIA. SPHERE SHALL NOT PASS THRU GUARDRAIL SYSTEM, TYP.

5. ALL STAIR CONNECTIONS AT PARKING RAMP SLOPE MUST HAVE NO MORE THAN 2%

6. ALL HANDRAILS SHALL BE FACTORY PRIMED AND PAINTED IN THE FIELD. COLOR BY OK

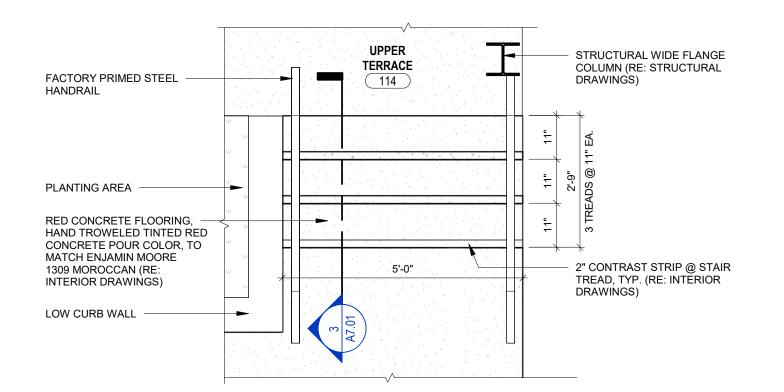

ENLARGED STAIR PLAN D

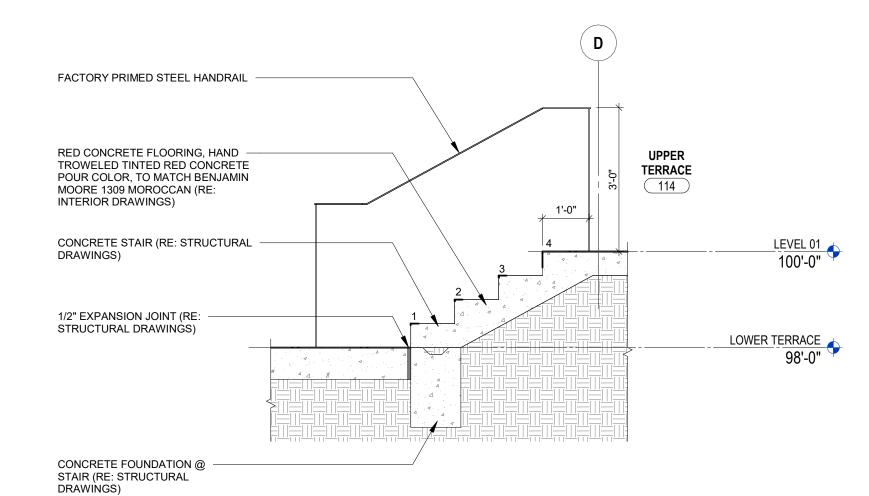

3 STAIR SECTION D
SCALE: 1/2" = 1'-0"

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F. 561.626.9719

Olson Kundia

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PERMIT SET

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VERTICAL CIRCULATION


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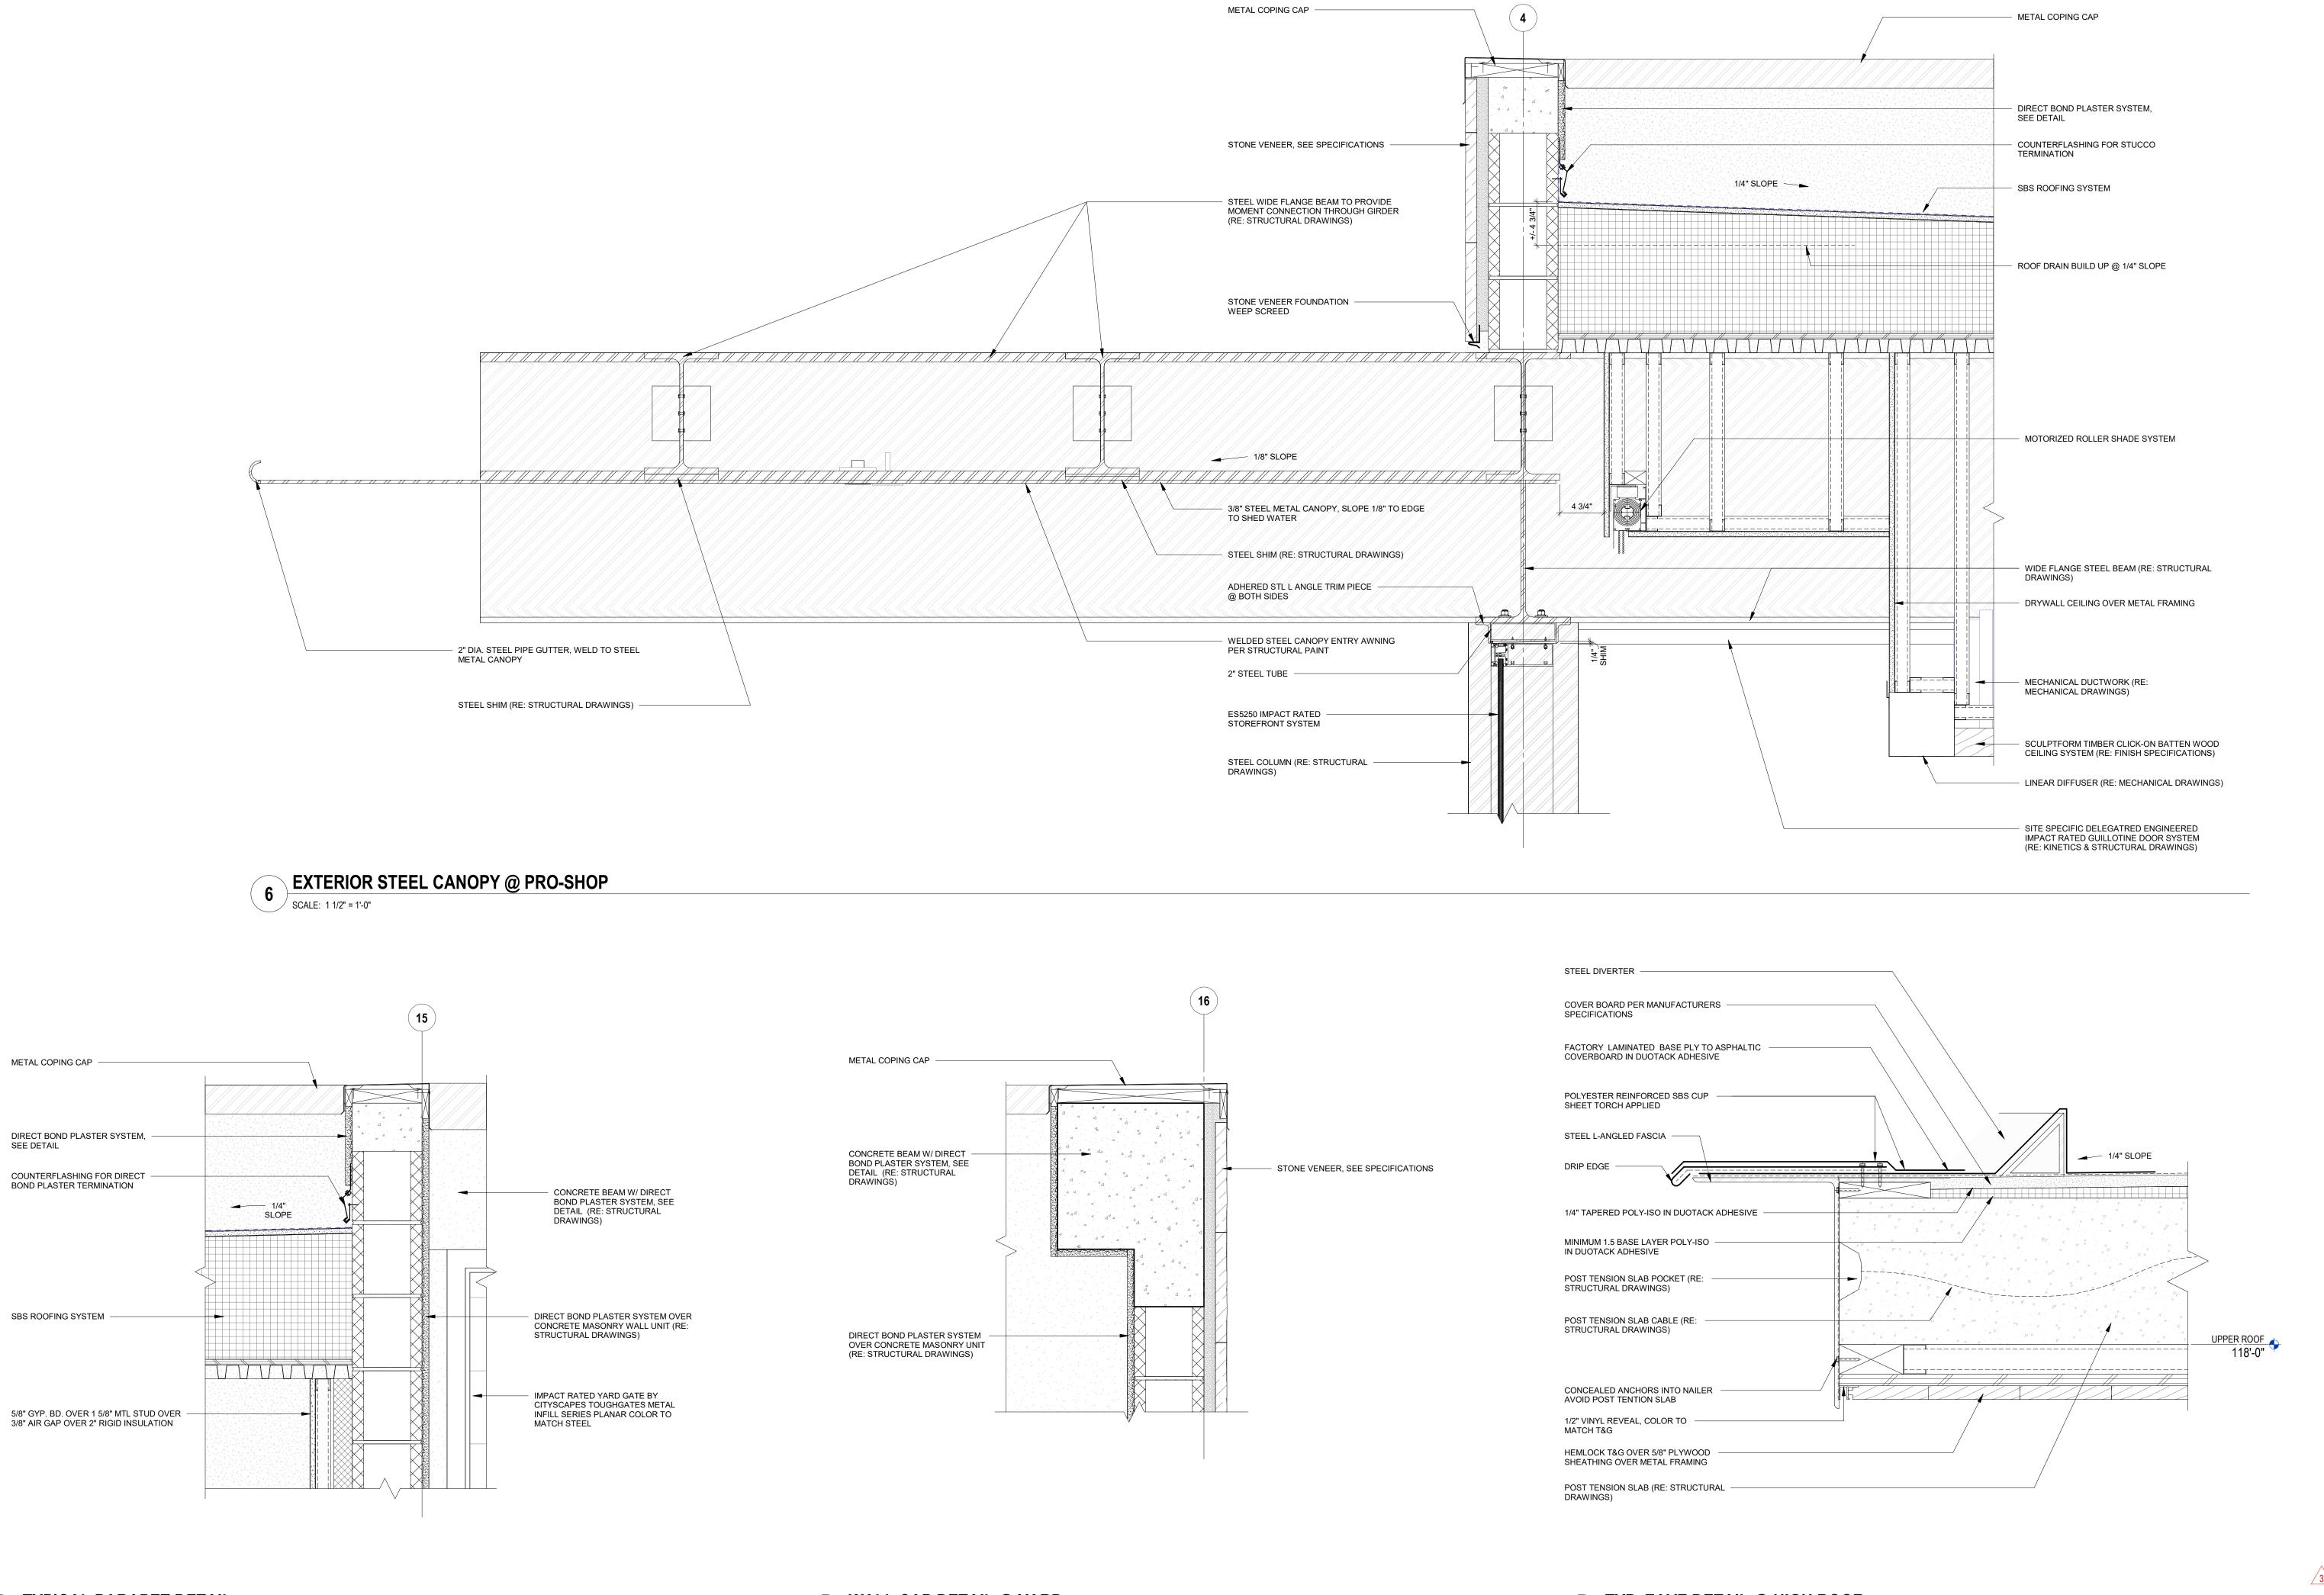
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SEE DETAIL

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ATLANTIC FIELDS

ATLANTIC FIELDS **GOLF HOUSE**

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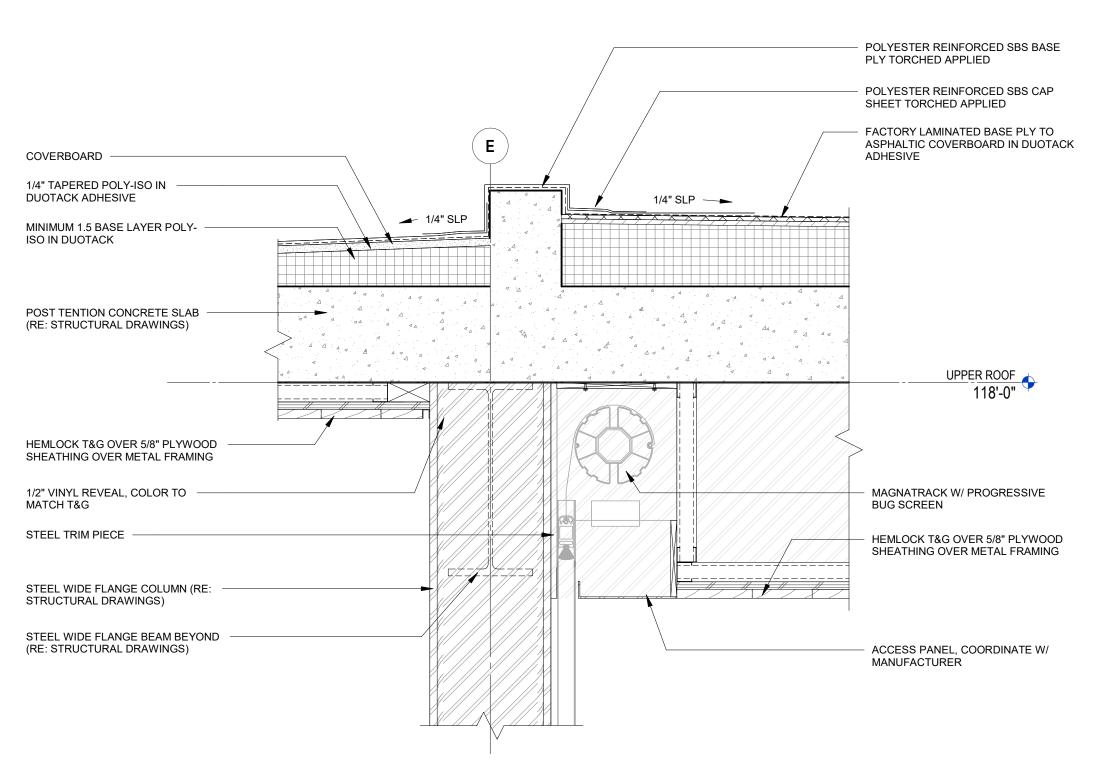
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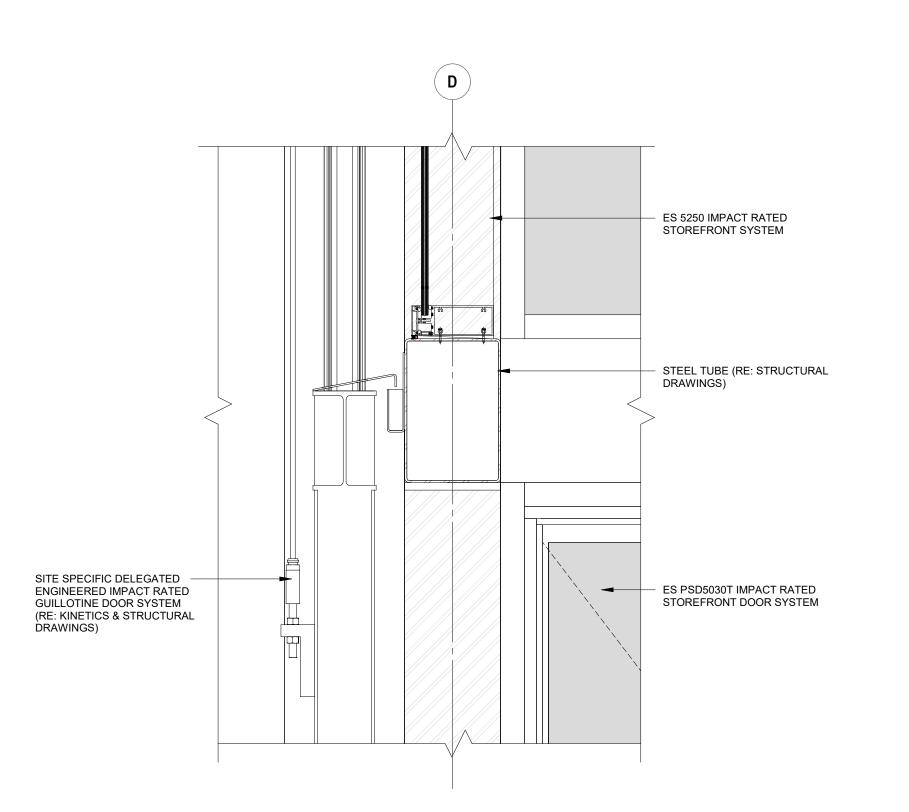
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(D POLYESTER REINFORCED SBS CAP SHEET TORCHED APPLIED 1/4" SLP -POST TENTION CONCRETE SLAB (RE: STRUCTURAL DRAWINGS) UPPER ROOF 118'-0" ◆ HEMLOCK T&G OVER 5/8" STEEL TUBE (RE: STRUCTURAL DRAWINGS) PLYWOOD SHEATHING OVER METAL FRAMING HEMLOCK T&G OVER 5/8" PLYWOOD SHEATHING OVER METAL FRAMING SITE SPECIFIC DELEGATED ENGINEERED IMPACT RATED ES 5250 IMPACT RATED STOREFRONT GUILLOTINE DOOR SYSTEM SYSTEM (RE: KINETICS & STRUCTURAL DRAWINGS)

1 TYP. HEAD DETAIL @ BUG SCREEN

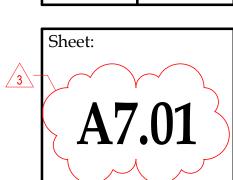SCALE: 1 1/2" = 1'-0"



KINETIC DETAIL @ INTERMEDIATE CONNECTION

4 DETAIL @ CLERESTORY @ STEEL TUBE

POLYESTER REINFORCED SBS BASE

PLY TORCHED APPLIED

STEEL PLATE (RE: -

STRUCTURAL DRAWINGS)

HEMLOCK T&G OVER PLYWOOD —— SHEATHING OVER METAL FRAMING

FINISH MORTAR TIGHT TO STOREFRONT SEALANT, SLOPE AWAY FROM STOREFRONT

STONE VENEER PER FINISH SPECIFICATIONS OVER ADHERED MORTAR OVER GLASS MAT BD. OVER METAL FRAMING

BLOCKING AS REQ'D

DRAWINGS)

VENEER

CEILING

LINEAR SUPPLY GRILLE (RE: MECHANICAL

STONE VENEER PER FINISH SPECIFICATIONS

OVER ADHERED MORTAR OVER GLASS MAT

1/2" FRY REGLET TERMINATION FOR STONE

WOOD TRIM TO ALIGN W/ GYP. BD.

BD. OVER METAL FRAMING



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POLYESTER REINFORCED SBS CAP

POST TENTION CONCRETE SLAB

<u>UPPER ROOF</u> 118'-0" ◆

(RE: STRUCTURAL DRAWINGS)

HEMLOCK T&G OVER PLYWOOD

STEEL TUBE (RE: STRUCTURAL

DRAWINGS)

TERMINATION

SHEATHING OVER METAL FRAMING

1/2" VINYL REVEAL, PAINT TO MATCH

ES5250 IMPACT RATED STOREFRONT SYSTEM

SLOPE PLASTER AWAY FROM STOREFRONT

DIRECT BOND PLASTER SYSTEM OVER DENSE GLASS OVER WATERPROOFING MEMBRANE OVER STEEL TUBE (RE: STRUCTURAL DRAWINGS)

COUNTERFLASHING FOR DIRECT BOND PLASTER

112'-0"

HVAC DUCTWORK (RE: MECHANICAL

GYP. BD. OVER METAL FRAMING

CEILING AS SCHEDULED, SEE REFLECTED

SING CUSTOM METAL SLIDING BARN

METAL FRAMING AS REQ'D

DRAWINGS)

CEILING PLANS

DOOR

STRUCTURAL METAL FRAMING OVER DENSE GLASS OVER WATERPROOFING MEMBRANE (RE: STRUCTURAL DRAWINGS)

W-FLANGE STEEL BEAMS (RE: STRUCTURAL DRAWINGS)

SHEET TORCHED APPLIED

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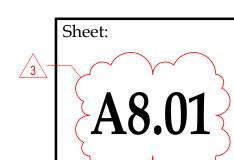
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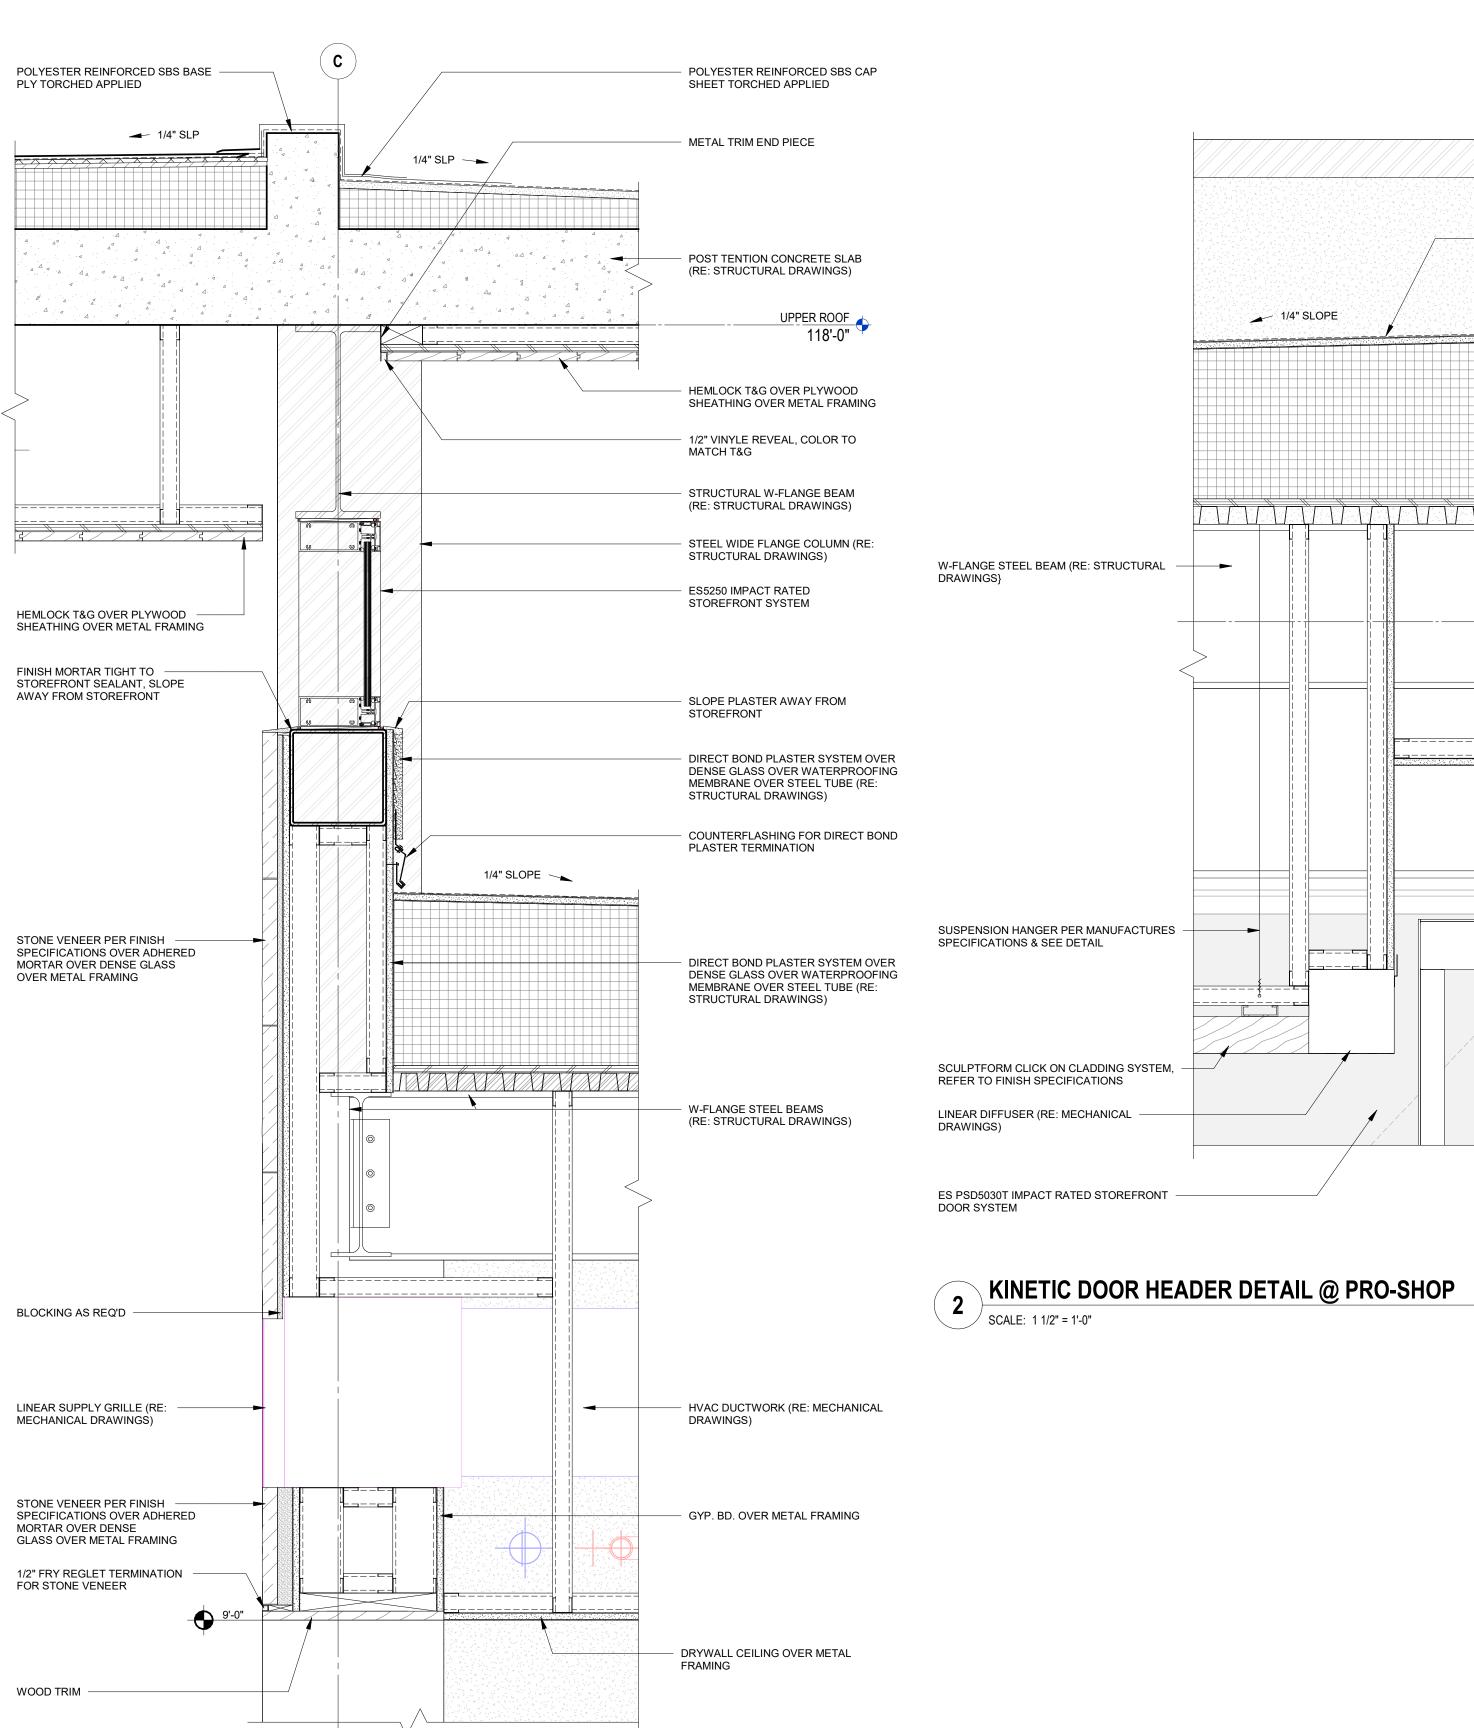
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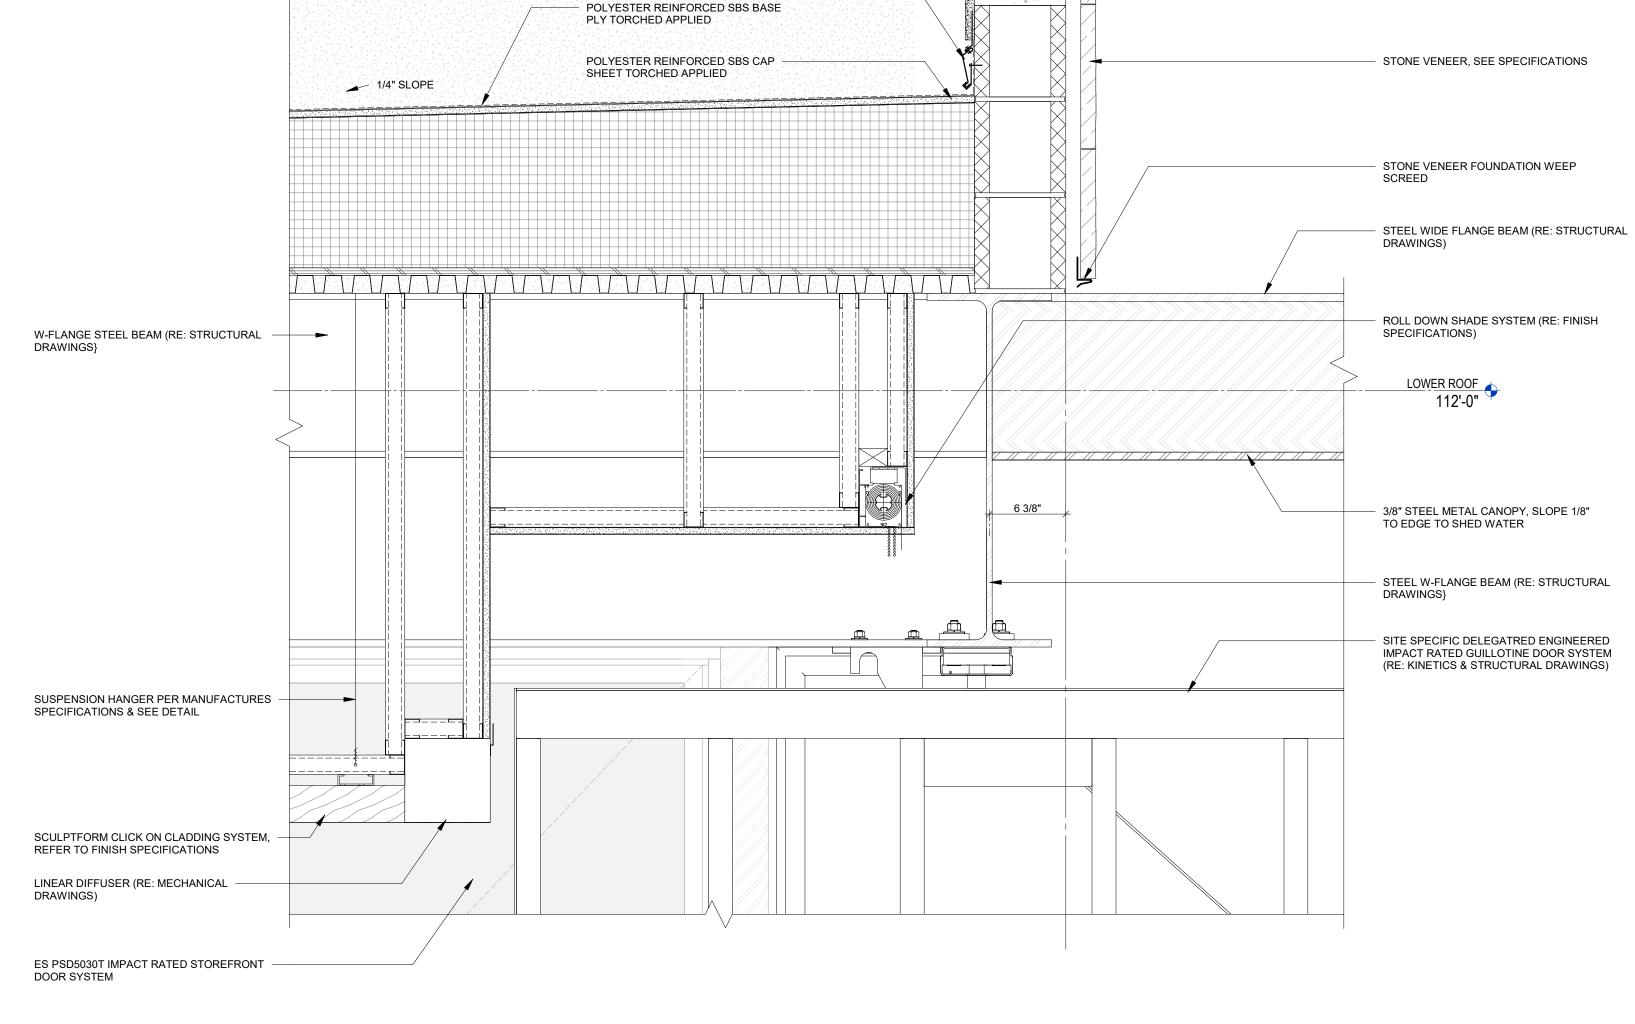
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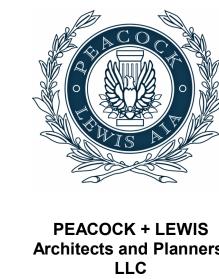




METAL COPING CAP

DIRECT BOND PLASTER SYSTEM, SEE DETAIL

COUNTERFLASHING FOR DIRECT BOND PLASTER TERMINATION



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DESIGN ARCHITECT

STEEL WIDE FLANGE BEAM (RE: STRUCTURAL

DRAWINGS)

TO SHED WATER

METAL CANOPY

METAL CANOPY EDGE DETAIL

WELDED STEEL CANOPY ENTRY AWNING -PER STRUCTURAL PAINT

- 3/8" STEEL METAL CANOPY, SLOPE 1/8" TO EDGE

2" DIA. STEEL PIPE GUTTER, WELD TO STEEL -

1/8" SLOPE

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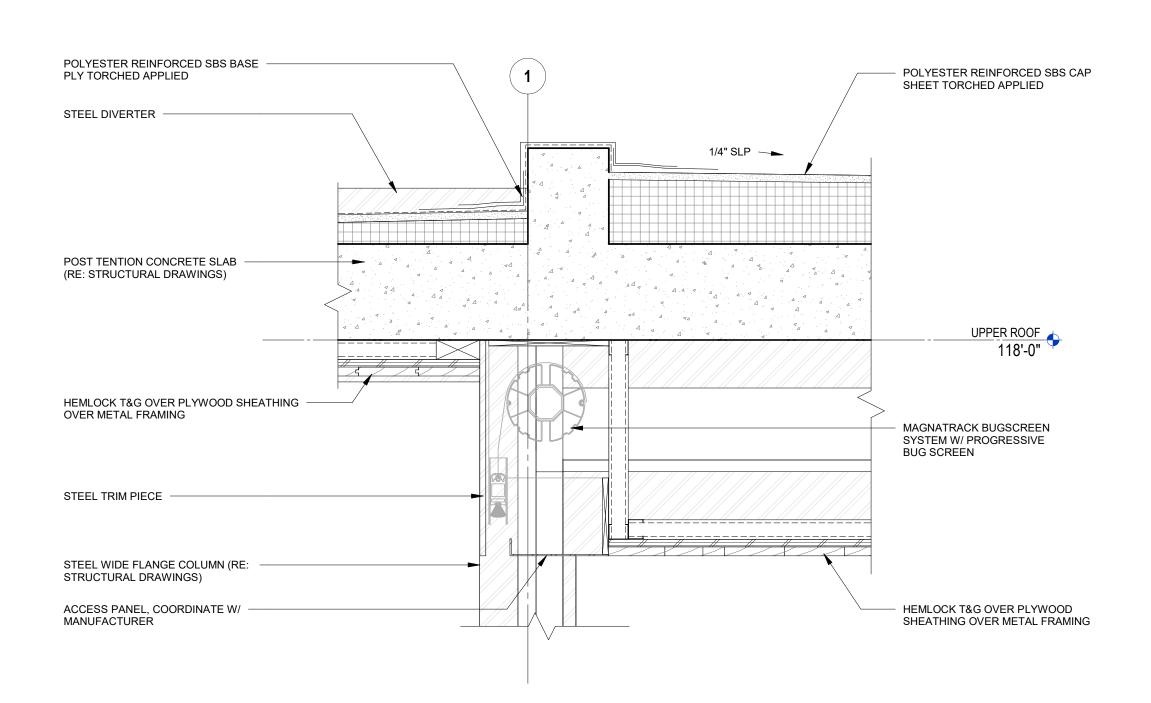
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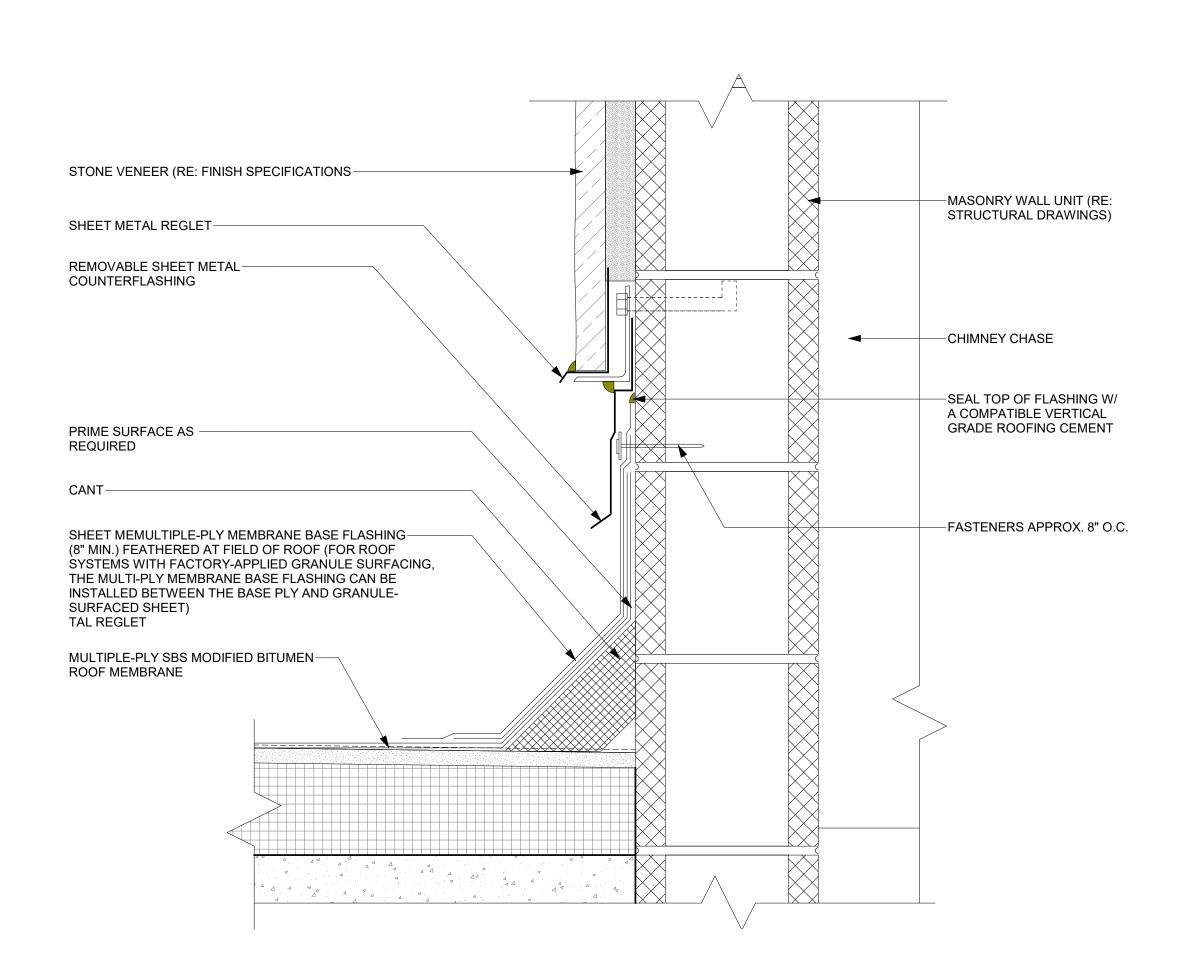
3 DETAIL @ CLERESTORY @ STEEL BEAM


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BUG SCREEN DETAIL


SCALE: 1 1/2" = 1'-0"





STEEL CHIMNEY CAP DETAIL TYP.

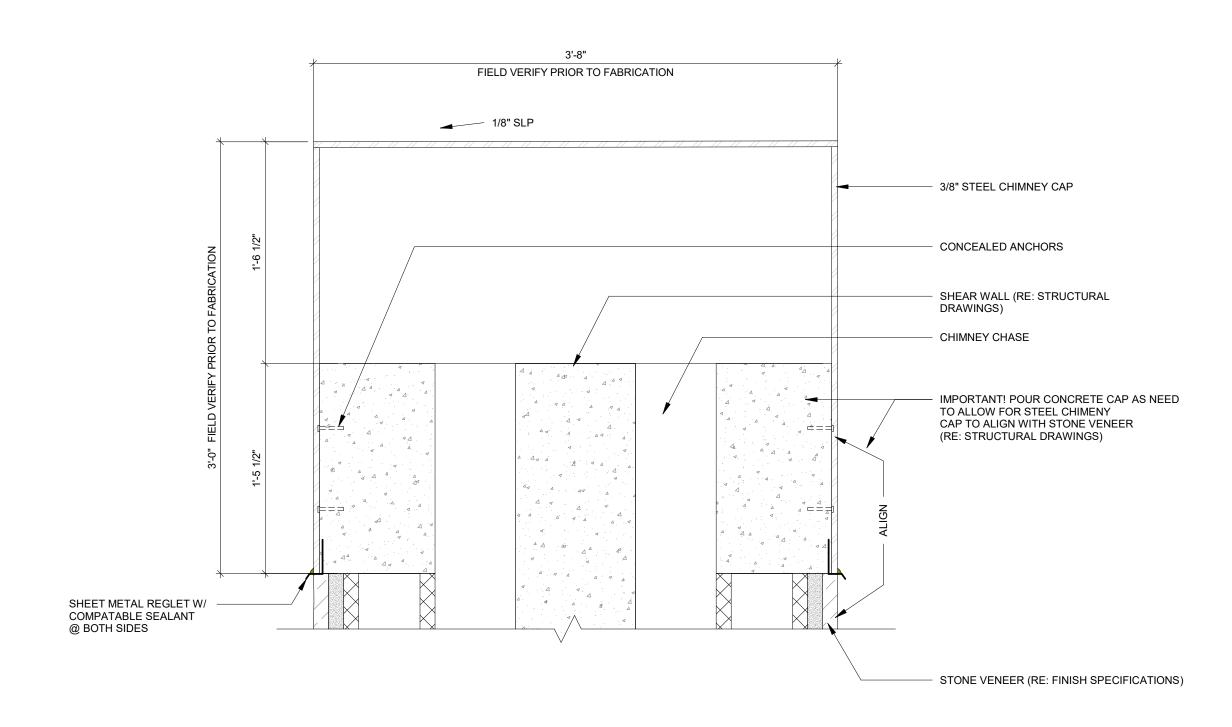5 SIEEL CHI
SCALE: 1 1/2" = 1'-0"

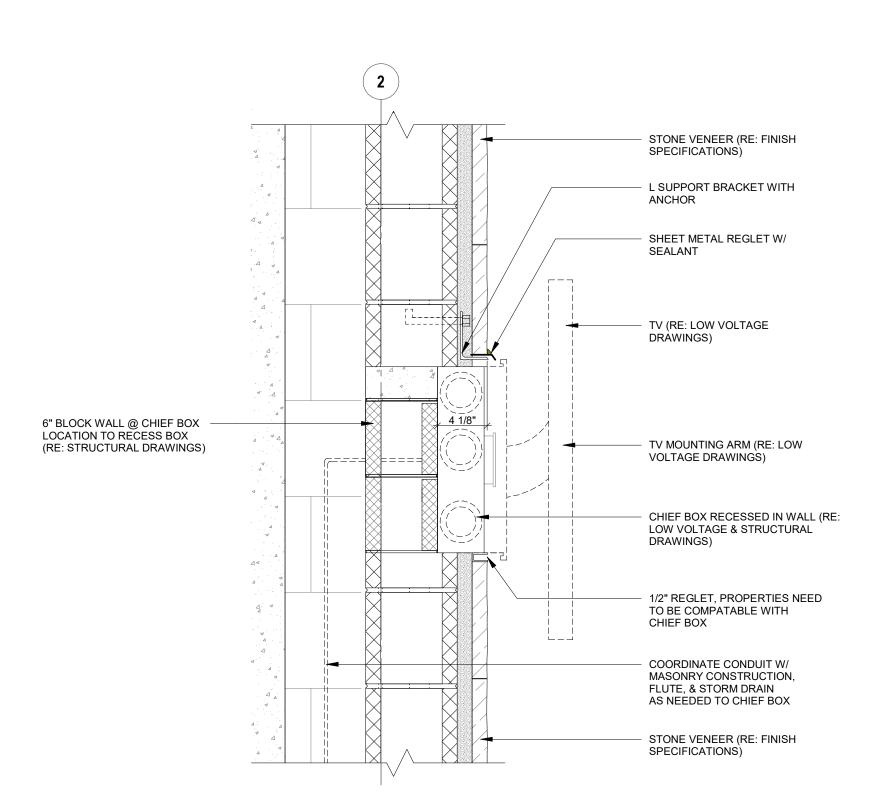



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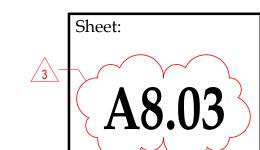
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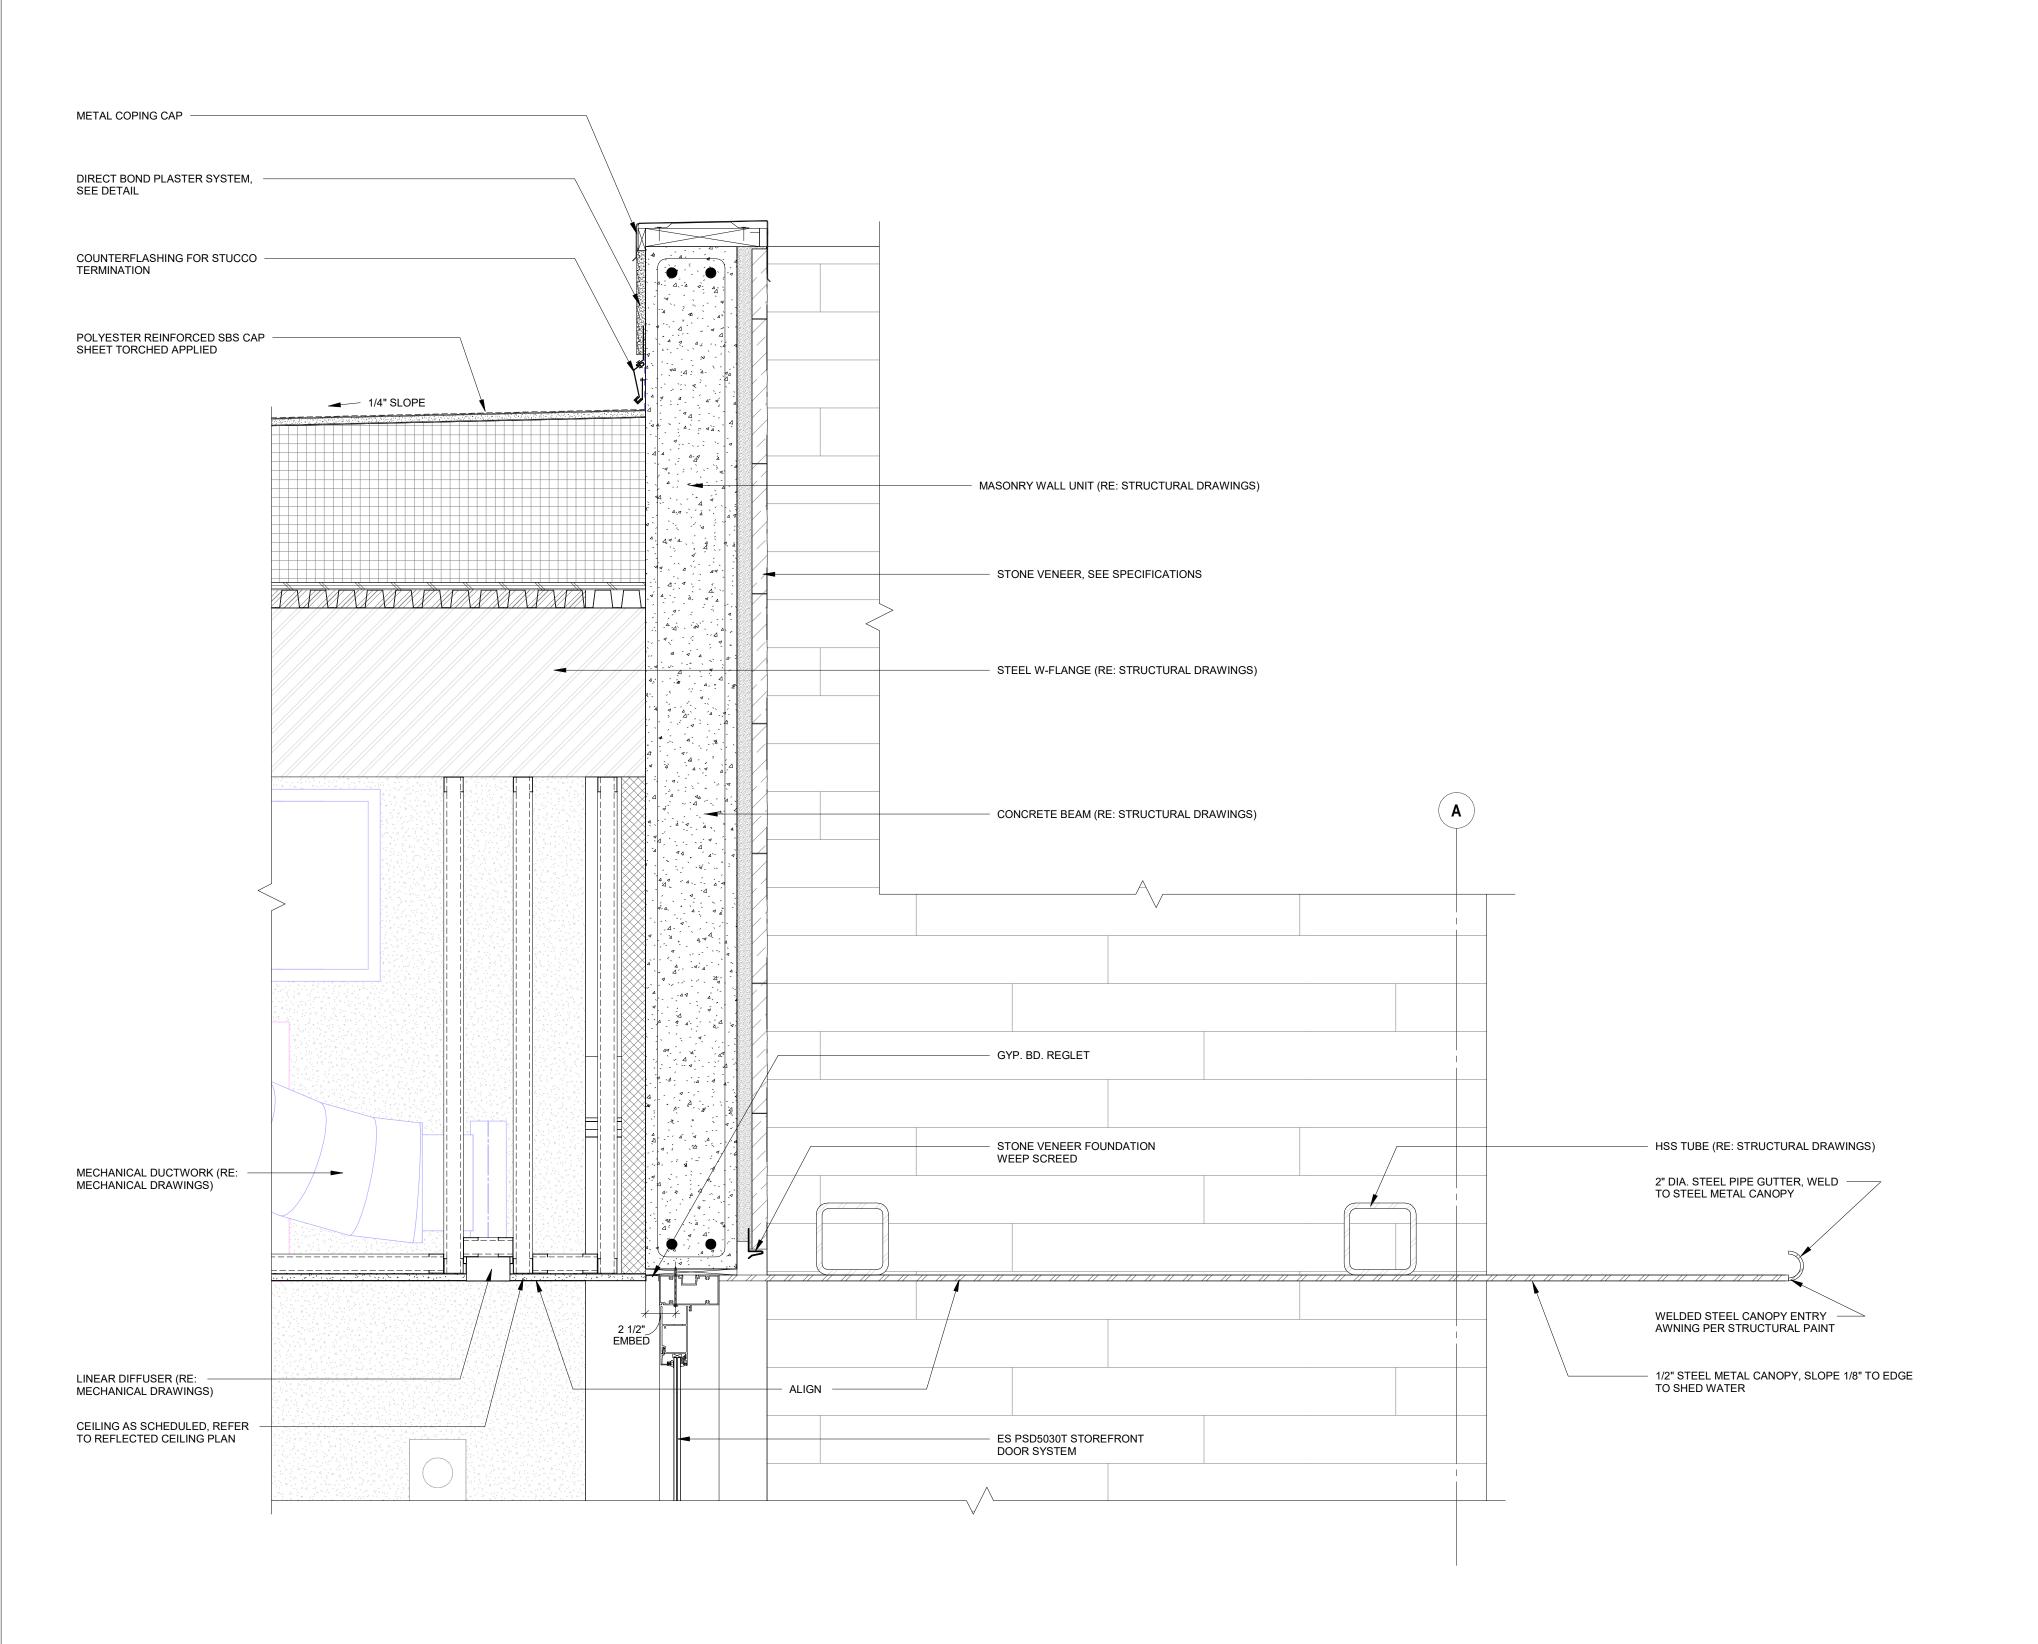
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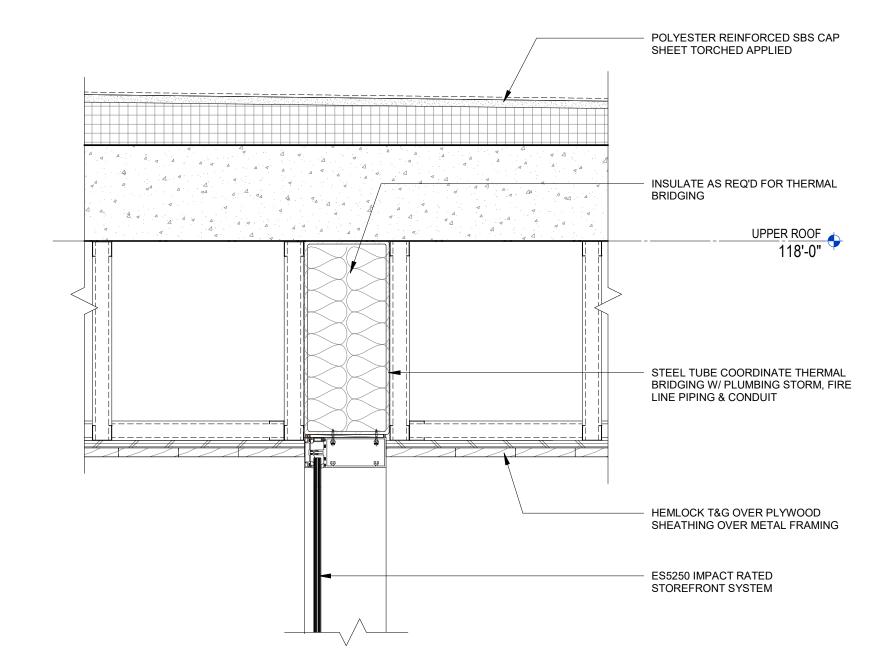
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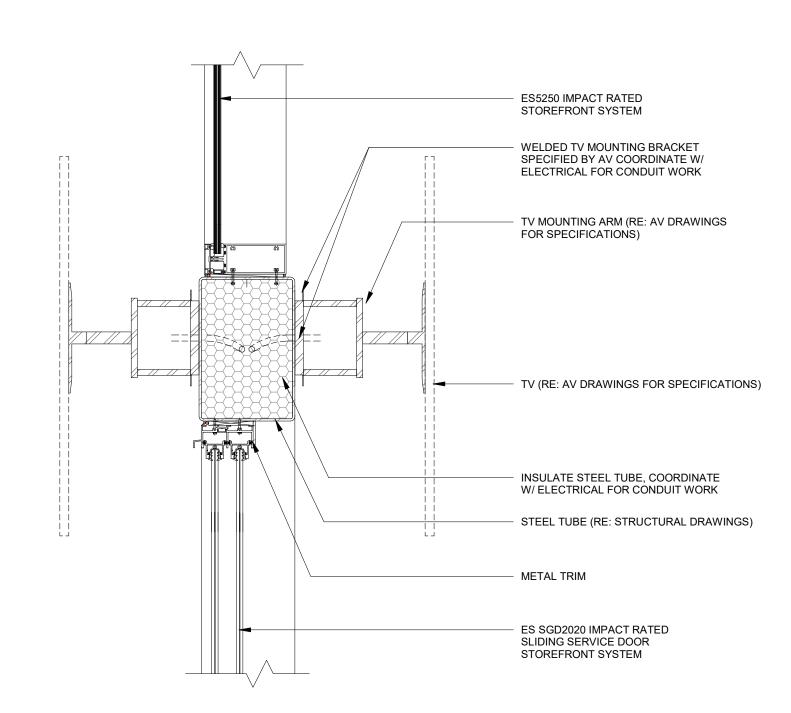







STOREFRONT HEADER DETAIL OVER BAR

SCALE: 1 1/2" = 1'-0"



INTERMEDIATE DETAIL OVER BAR

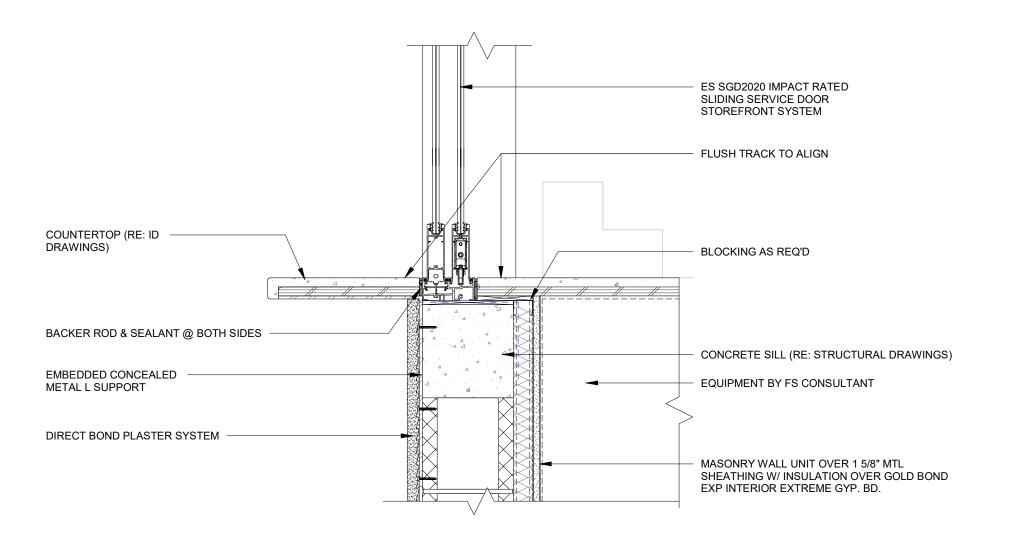





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DESIGN ARCHITECT Olson Kundig

159 South Jackson St, Suite 600 Seattle, WA 98104



ATLANTIC FIELDS **GOLF HOUSE**

PERMIT SET

2645 SE BRIDGE ROAD, HOBE SOUND, FL 33455

Seal:


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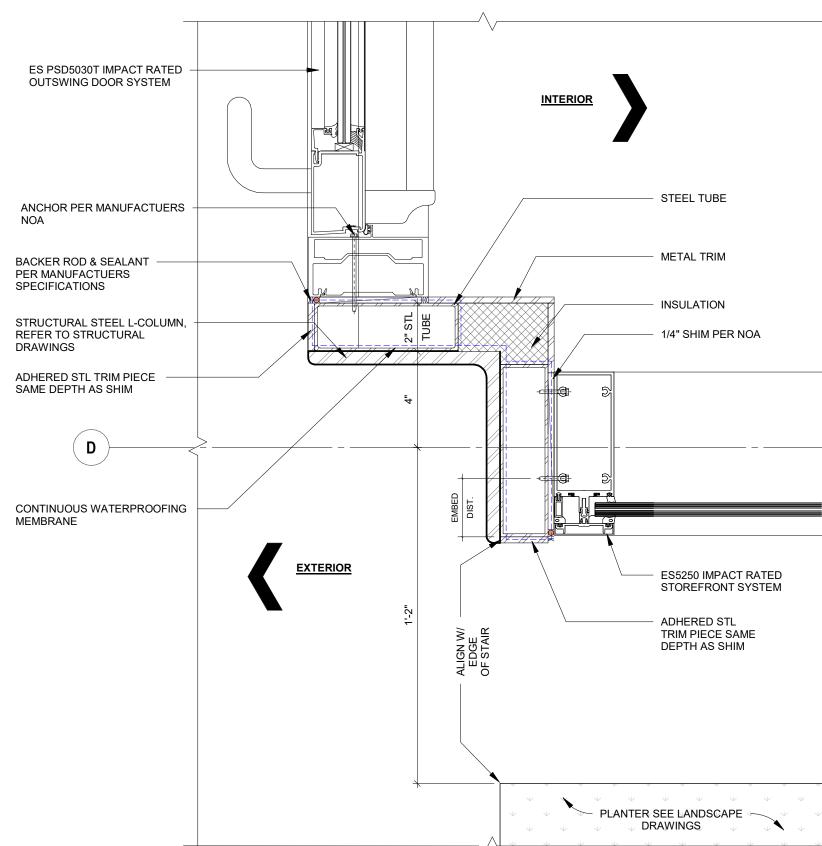
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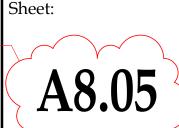
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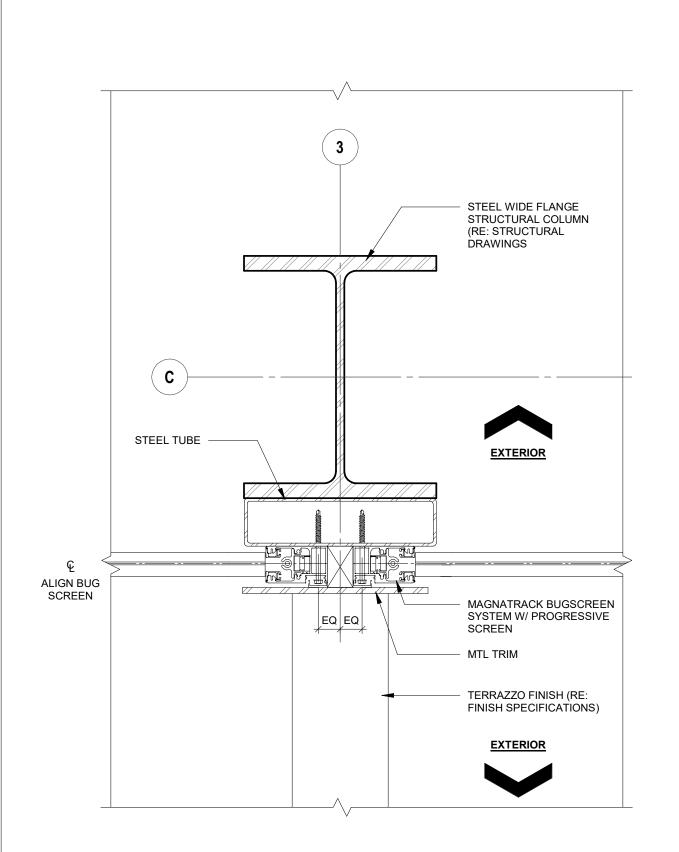
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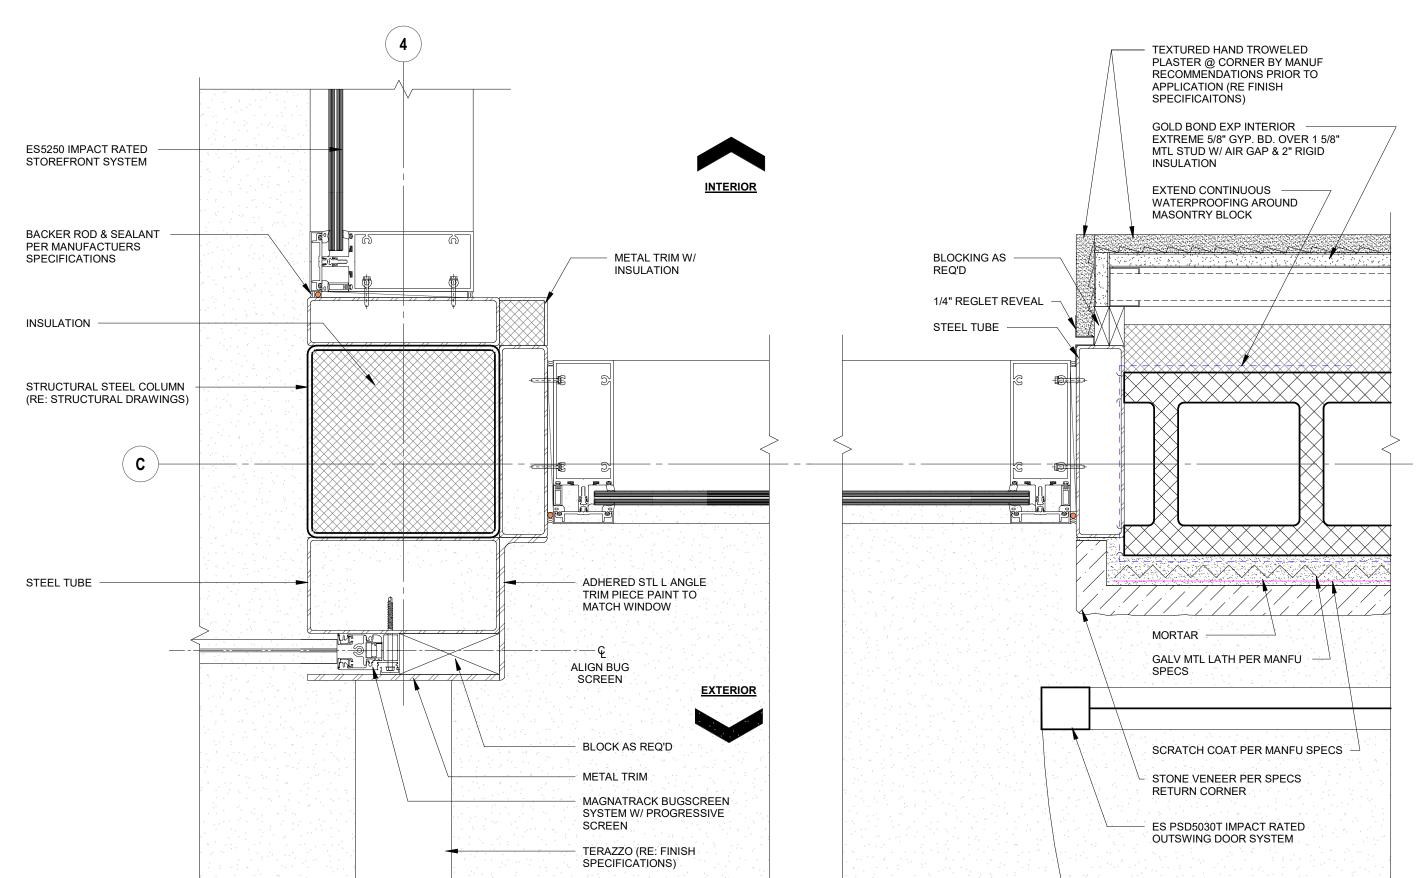
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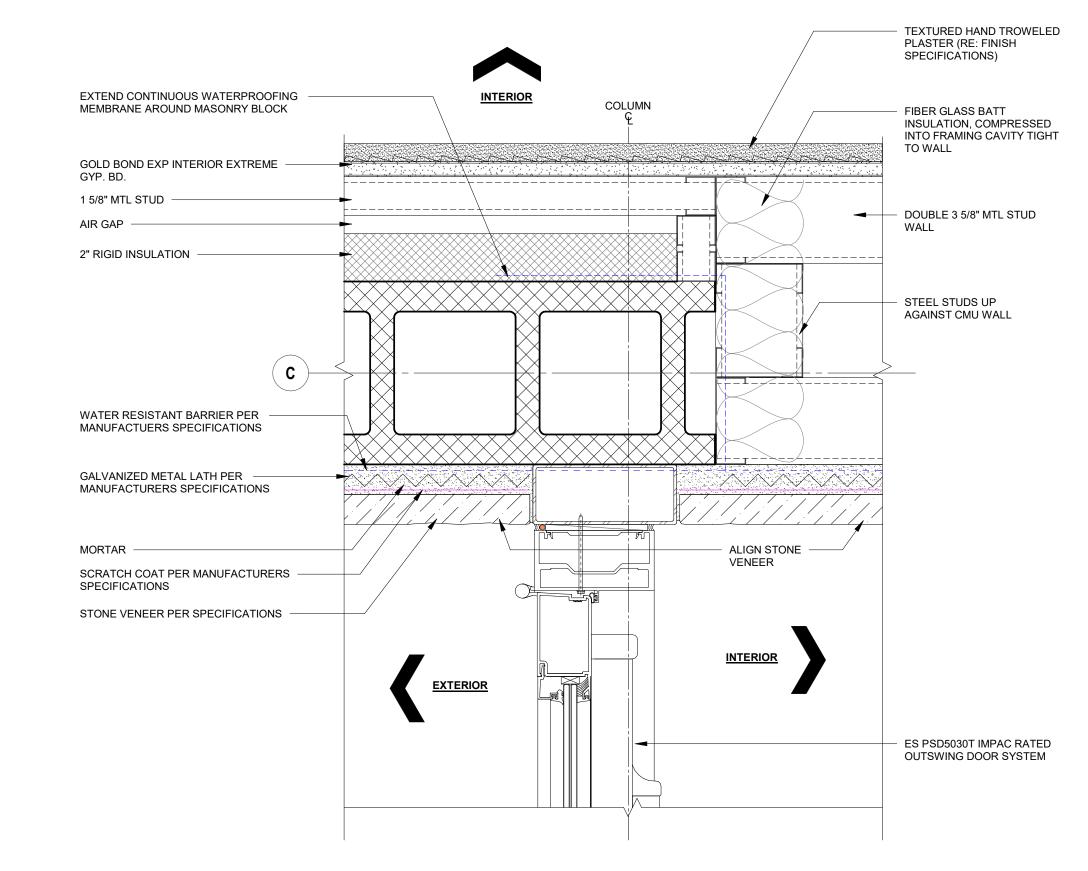
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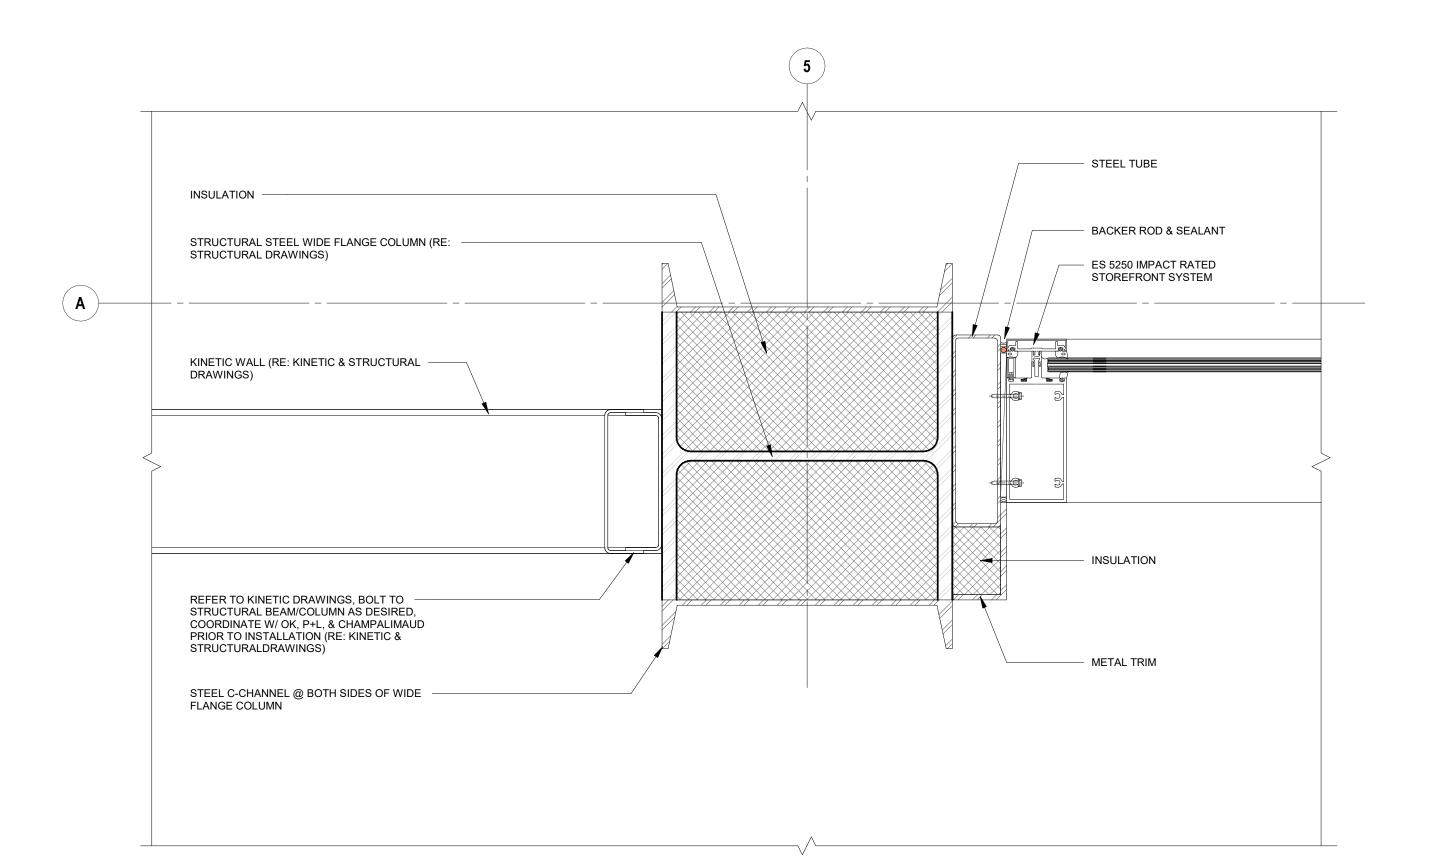







WIDE FLANG COLUMN BUG SCREEN DETAIL 3 **VVIDE FLA**SCALE: 3" = 1'-0"

CORNER STEEL TUBE DETAIL @ PRO-SHOP SCALE: 3" = 1'-0"

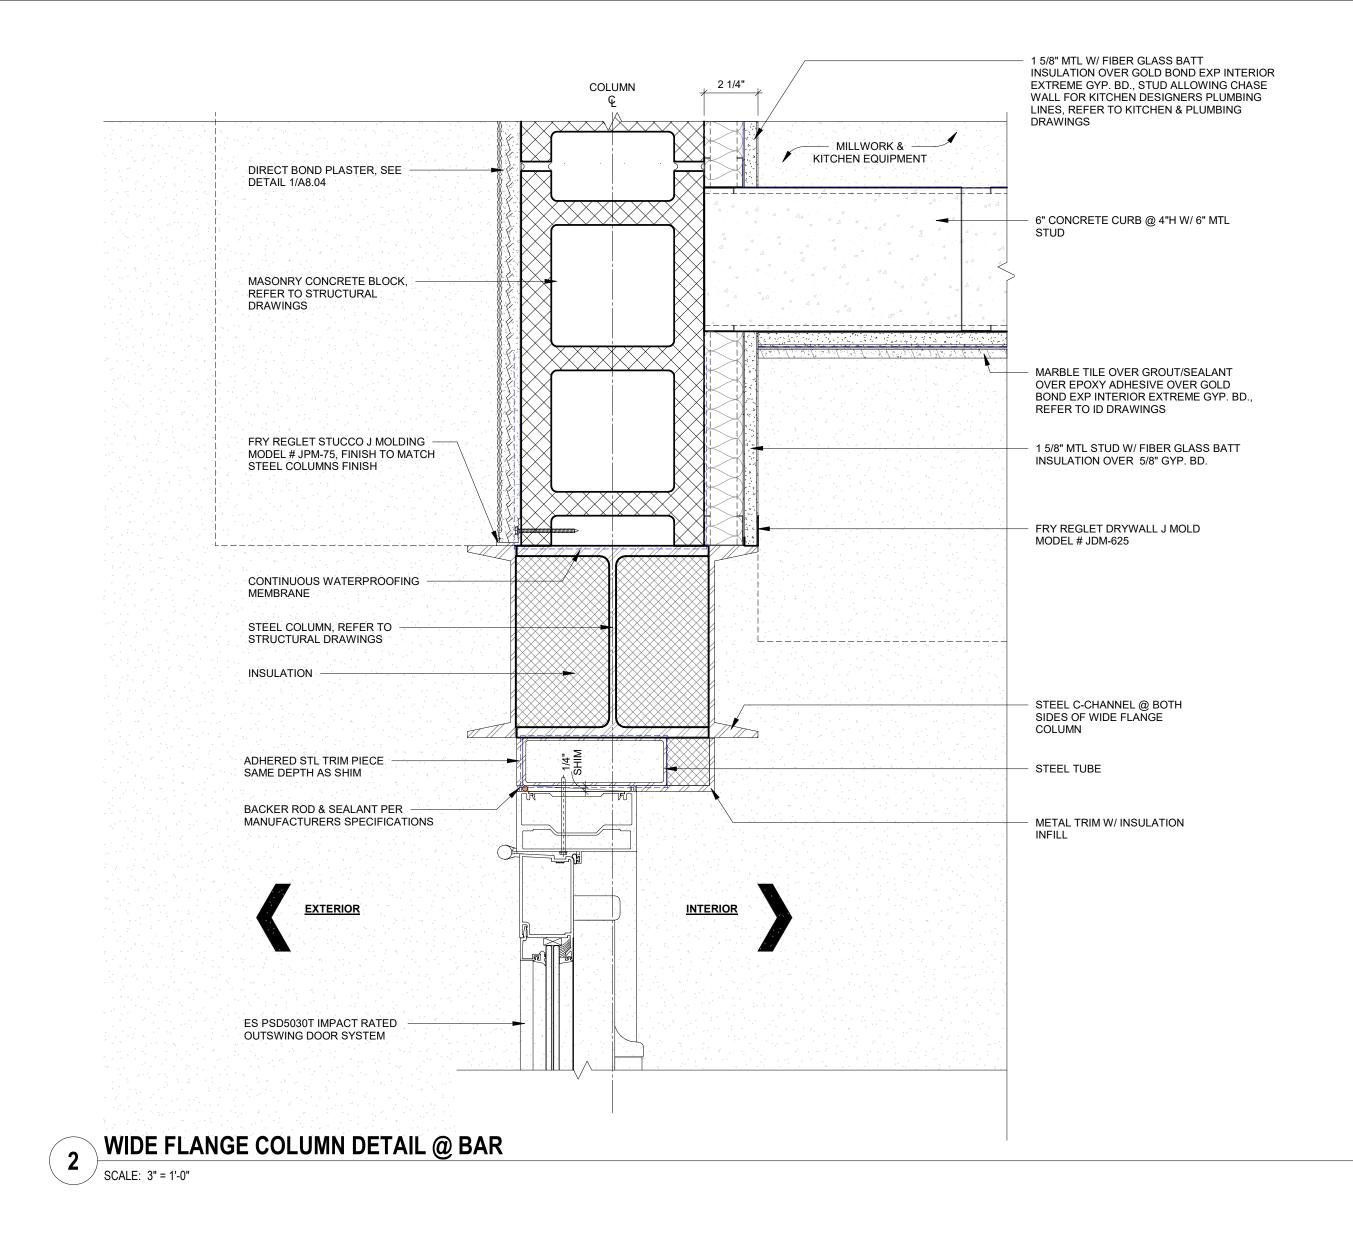

5 KINETIC PIVOT WALL JAMB DETAIL @ WIDE FLANGE COLUMN
SCALE: 3" = 1'-0"

DOOR JAMB DETAIL @ STONE VENEER EXT. TO INT.

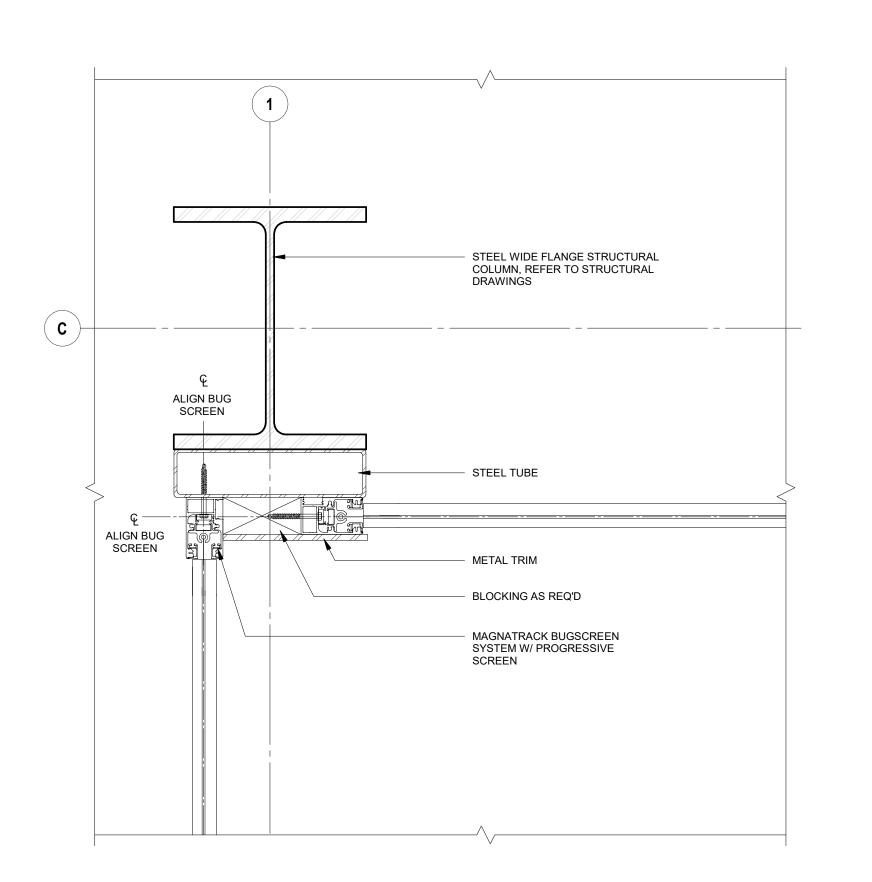

WIDE FLANGE CORNER COLUMN BUG SCREEN DETAIL

SCALE: 3" = 1'-0"



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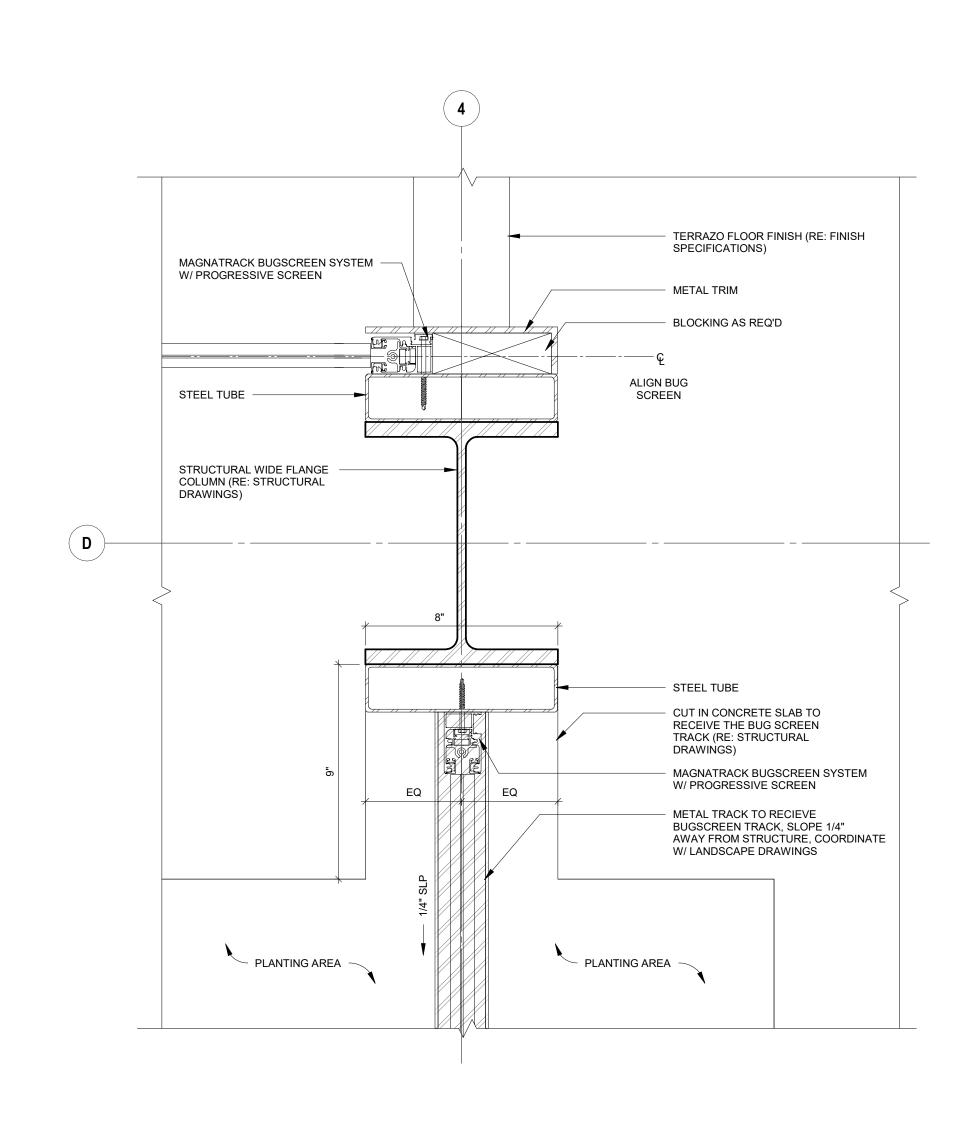
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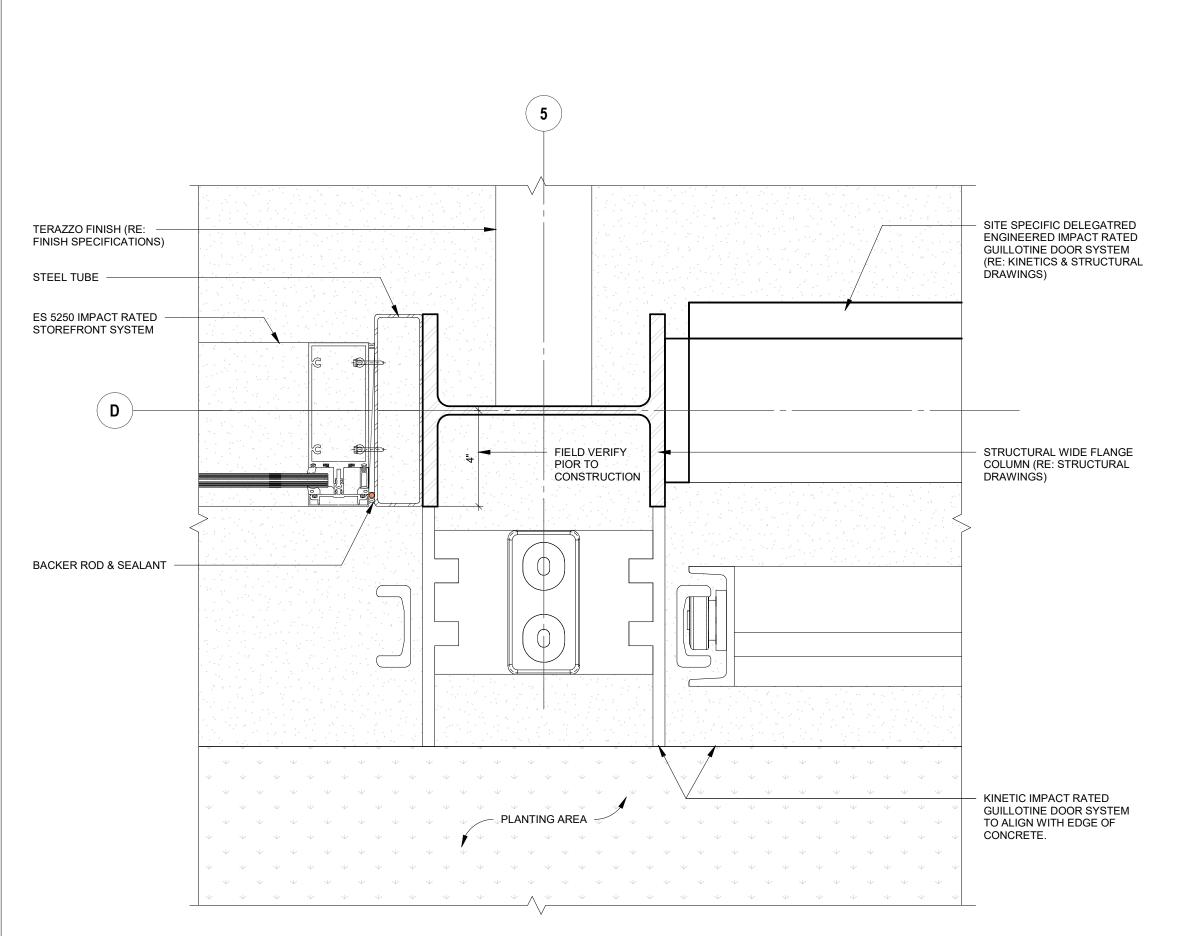
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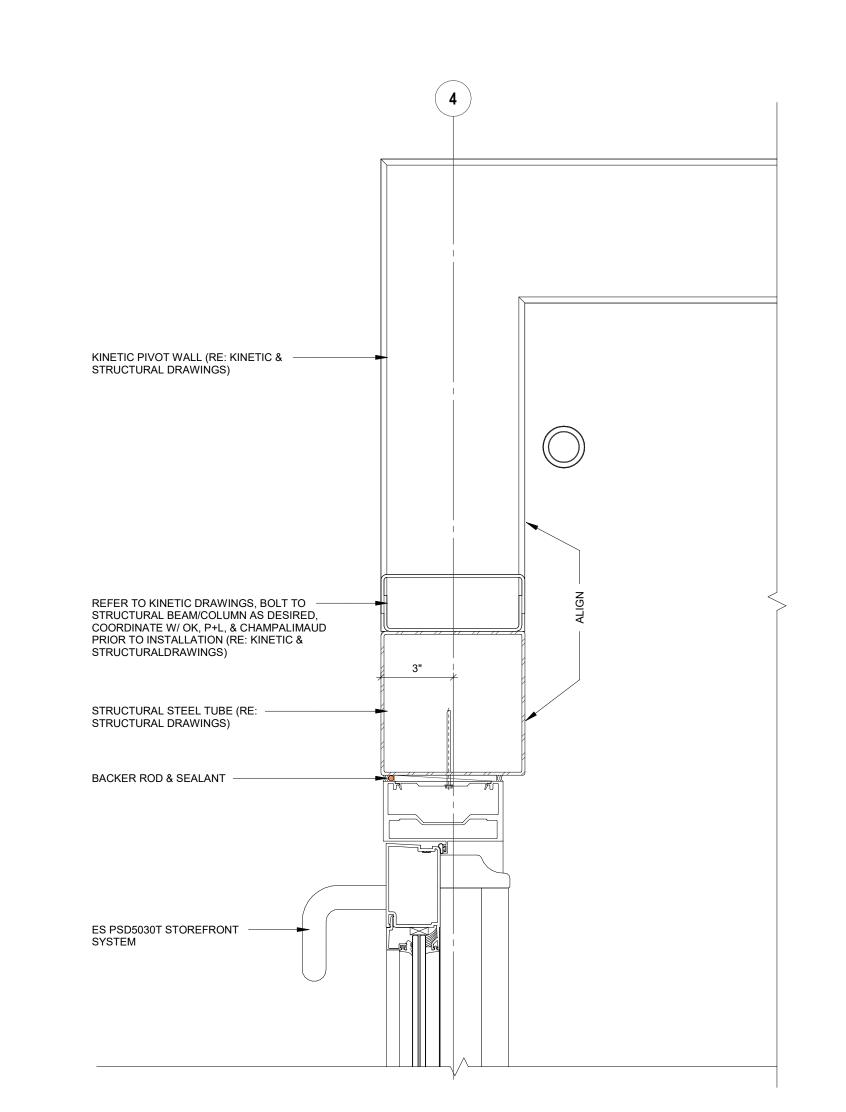







STOREFRONT TO KINETIC GUILLOTINE DOOR SYSTEM


SCALE: 3" = 1'-0"




KINETIC DOOR JAMB DETAIL @ STOREFRONT DOOR @ PRO-SHOP

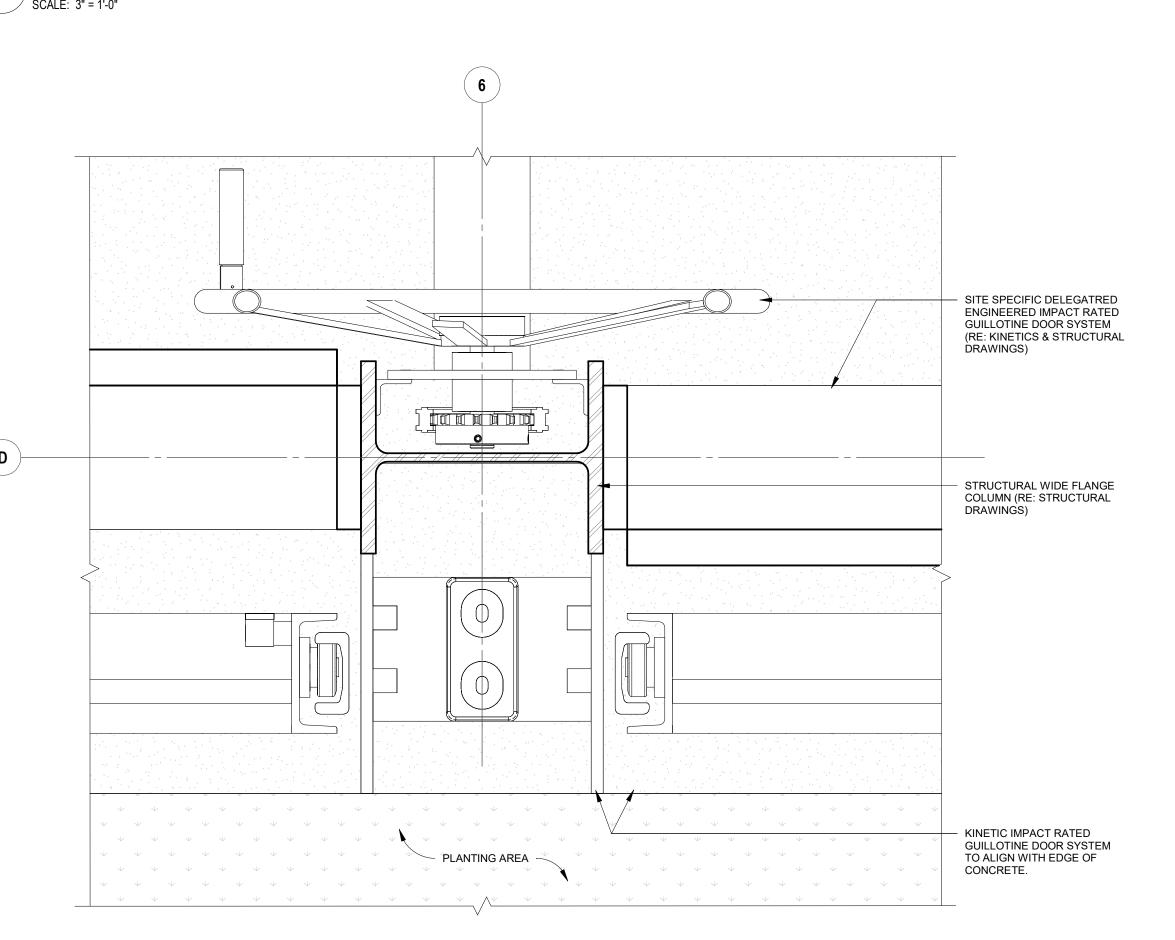



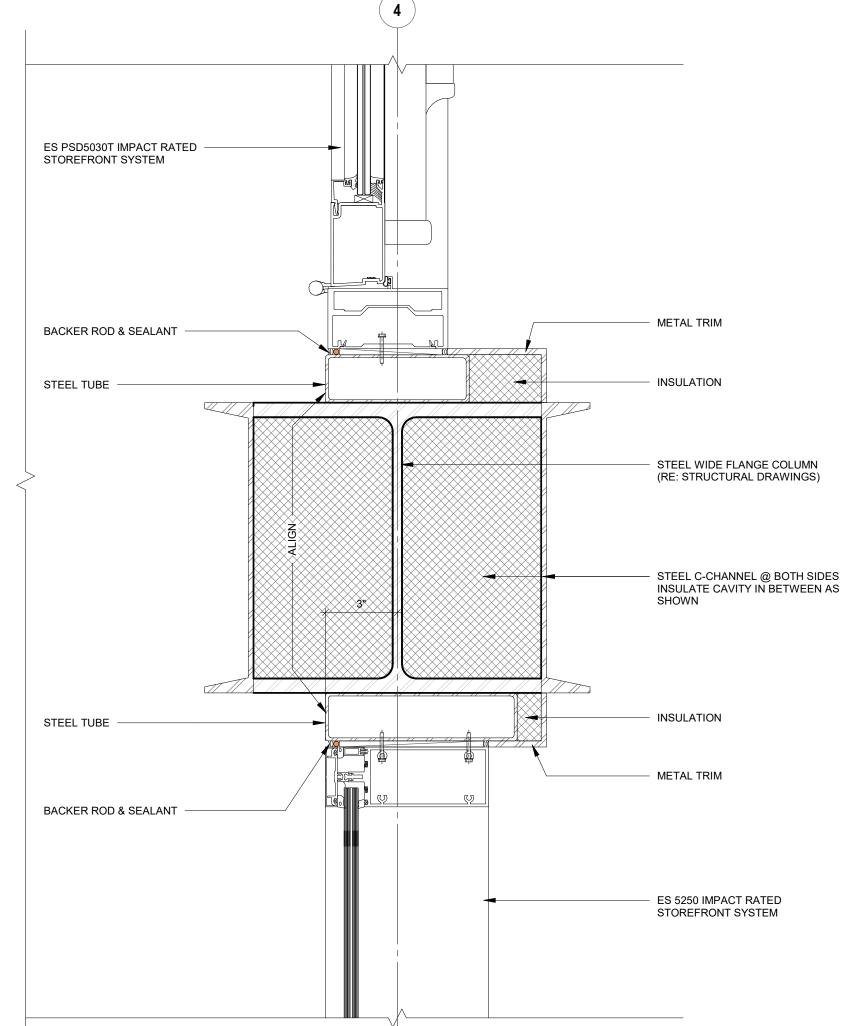

PRO-SHOP JAMB DETAIL @ WIDE FLANGE COLUMN

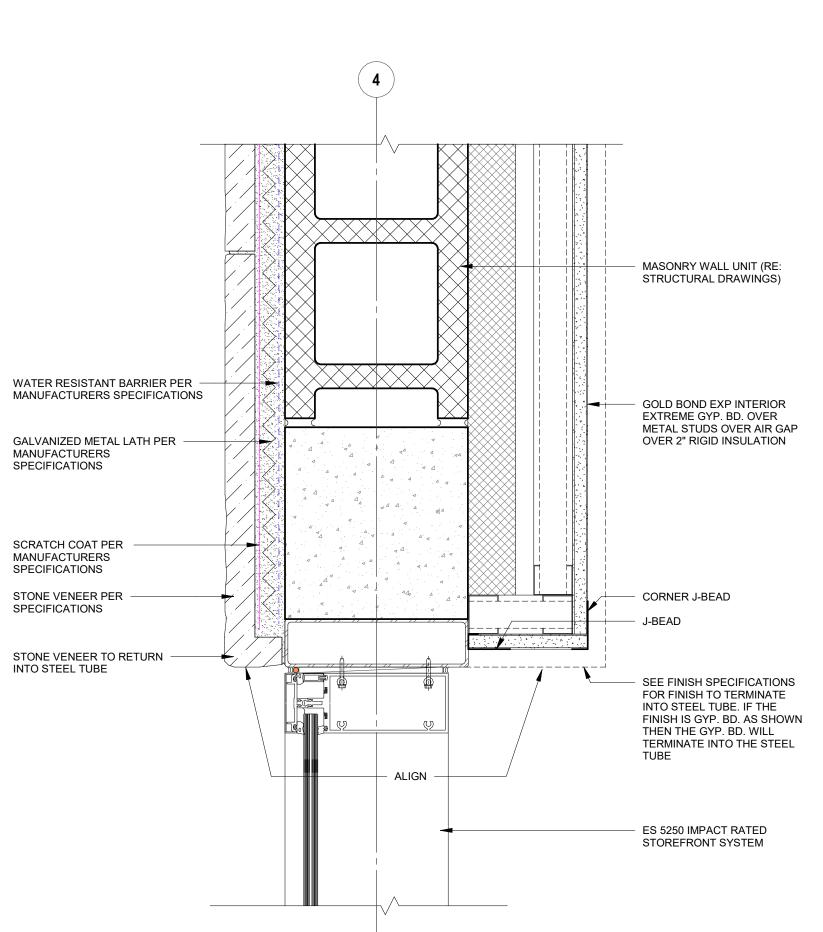

TYP. STOREFRONT JAMB DETAIL

SCALE: 3" = 1'-0"



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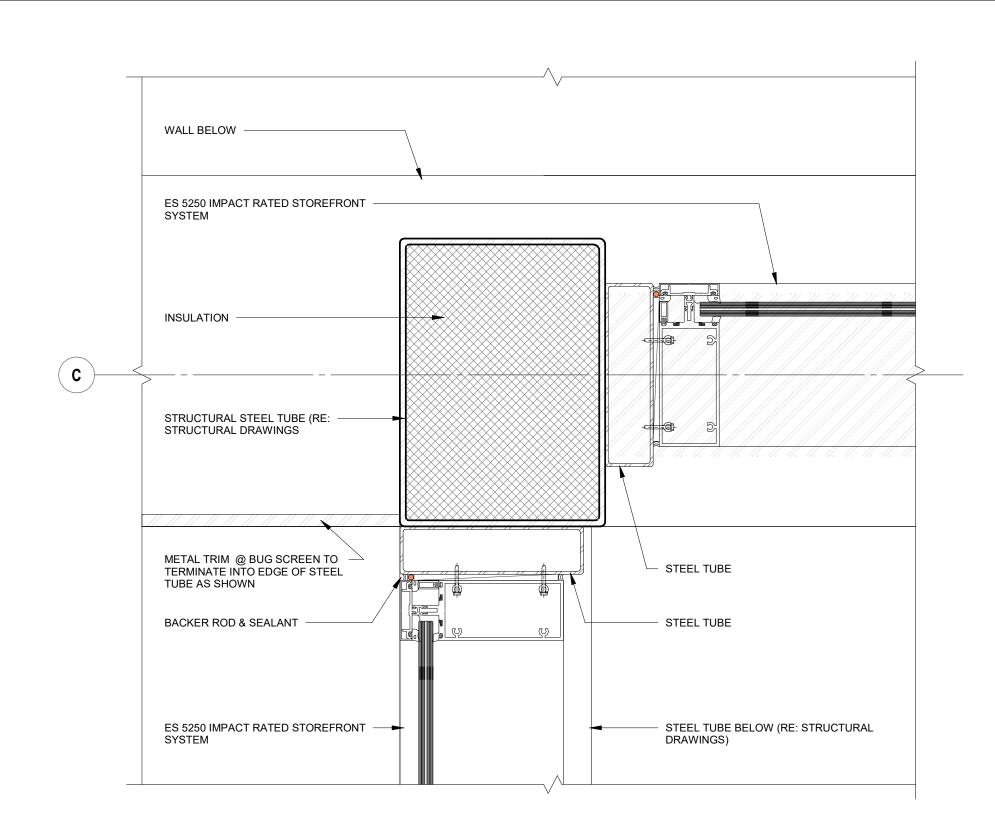
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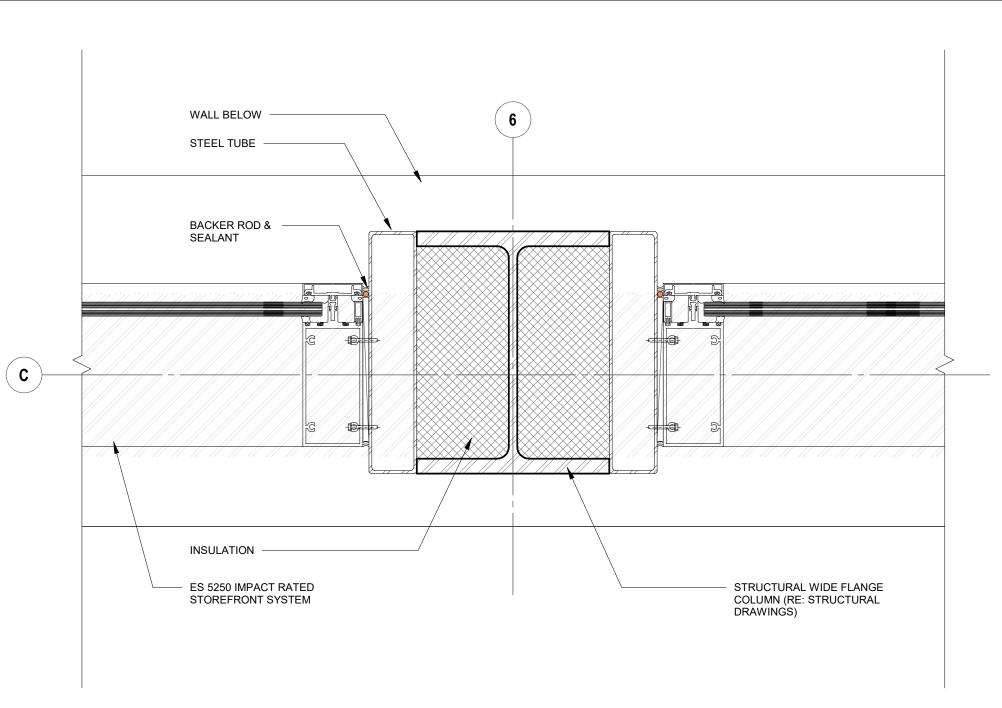
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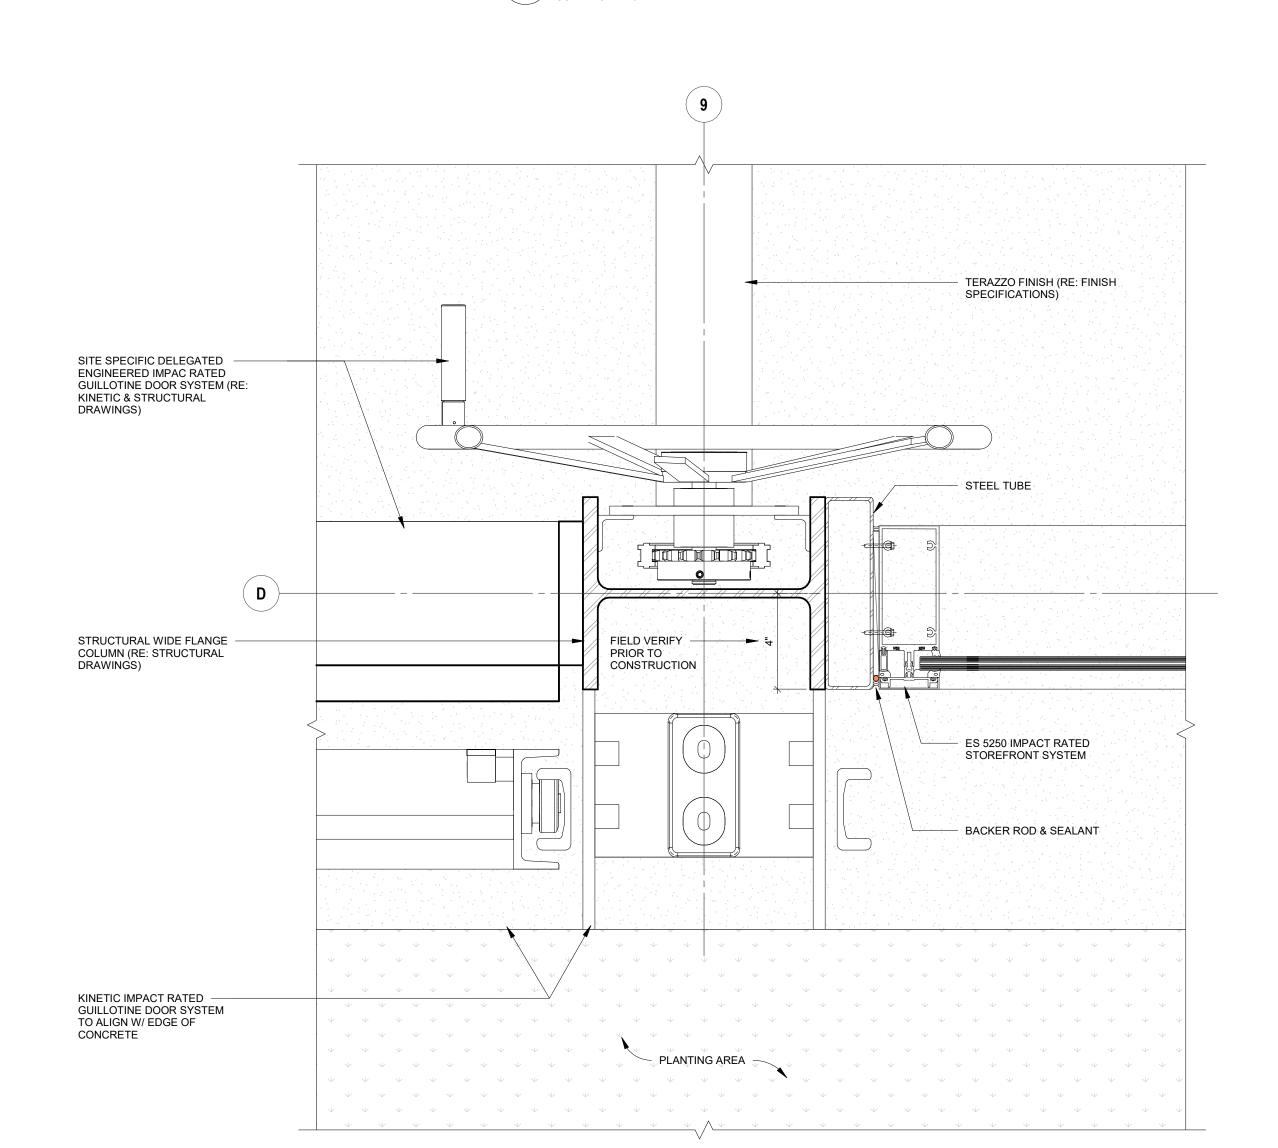


3 CLERESTORY CORNER JAMB DETAIL @ STOREFRONT


SCALE: 3" = 1'-0"

4 CLERESTORY TYP. JAMB DETAIL @ STOREFRONT


SCALE: 3" = 1'-0"





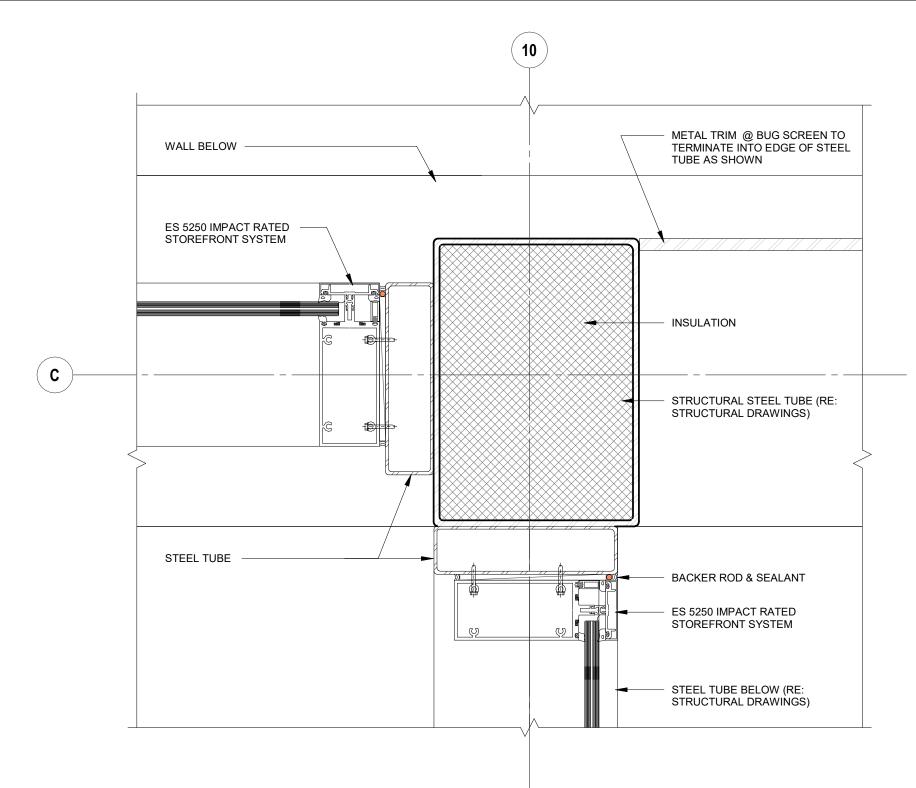



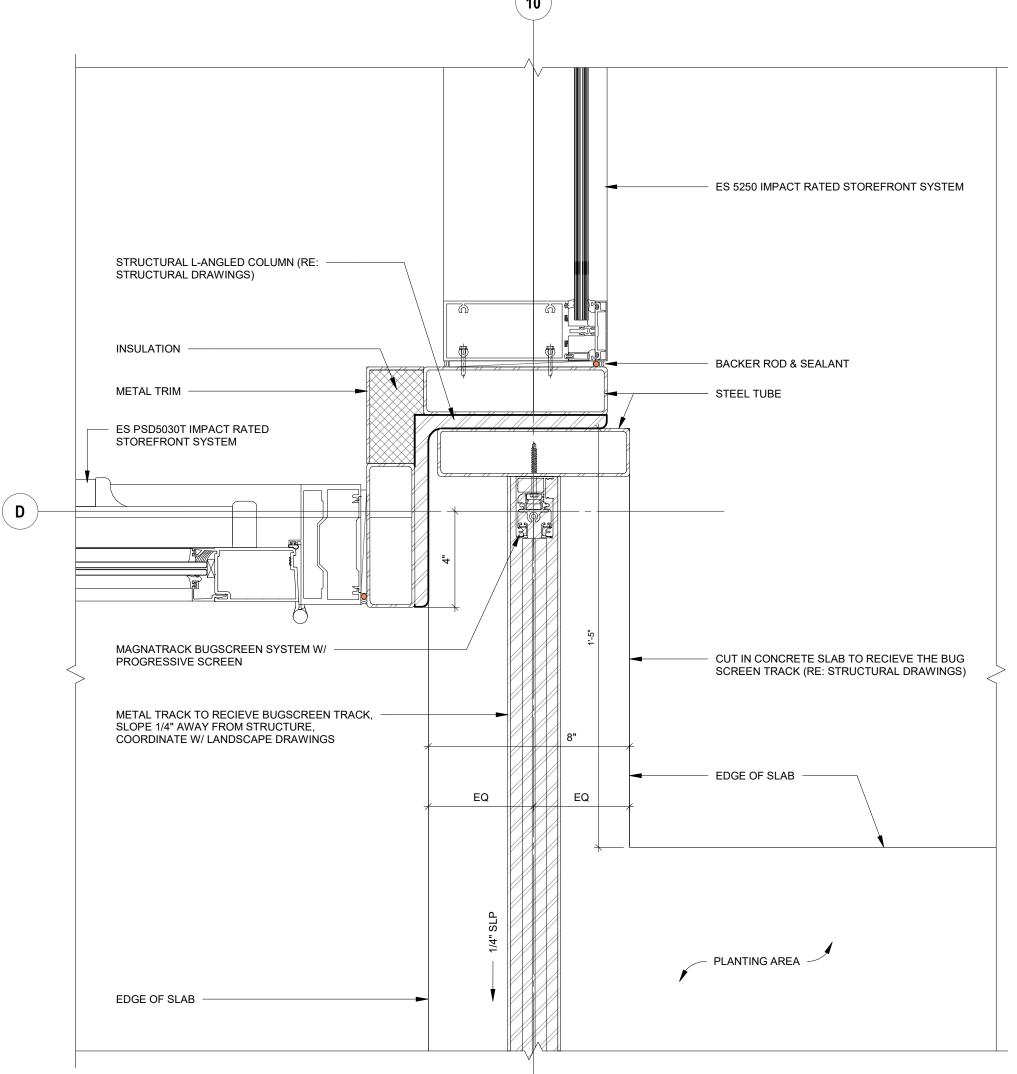

CORNER L-ANGLED COLUMN DETAIL W/ BUGSCREEN TRACK

SCALE: 3" = 1'-0"



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design architect
Olson Kundig

159 South Jackson St,

Suite 600

Seattle, WA 98104



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Seal:

- ES PSD5030T IMPACT RATED STOREFRONT

SITE SPECIFIC DELEGATRED ENGINEERED IMPACT RATED GUILLOTINE DOOR SYSTEM (RE: KINETICS & STRUCTURAL DRAWINGS)

REMOVABLE TRENCH DRAIN FOR CLEANING, FASTEN TO FLOOR STAINLESS STEEL @ EA KINETIC DOOR SYSTEM

CONCRETE SLAB ON GRADE OVER VAPOR BARRIER (RE: STRUCTURAL

100'-0"

CONCRETE SLAB ON GRADE OVER VAPOR BARRIER (RE: STRUCTURAL

IMPORTANT! THERE MUST BE A TRENCH DRAIN BENEATH EACH KINETIC WALL. THRESHOLD SHOULD BE DETAILED SO THAT IT CAN BE REMOVED FOR DRAIN SERVICING DETAILS

LOWER TERRACE 98'-0"

DRAIN FROM KINETIC DOOR TRENCH DRAIN, DRAIN INTO PLANTER BELOW

CONCRETE FOOTING (RE: STRUCTURAL DRAWINGS

DRAWINGS

DOOR SYSTEM

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BUILDING SECTION - PRO SHOP - N-S - Callout 1 - Callout 3


CONCRETE FOOTING (RE: STRUCTURAL DRAWINGS


STEEL HANDRAIL

STONE FEATURE (RE: LANDSCAPE DRAWINGS)


CONCRETE STAIR (RE: —— STRUCTURAL DRAWINGS

18"H CONCRETE LOW WALL (RE: STRUCTURAL DRAWINGS

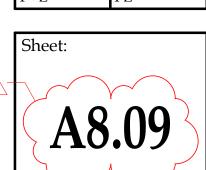


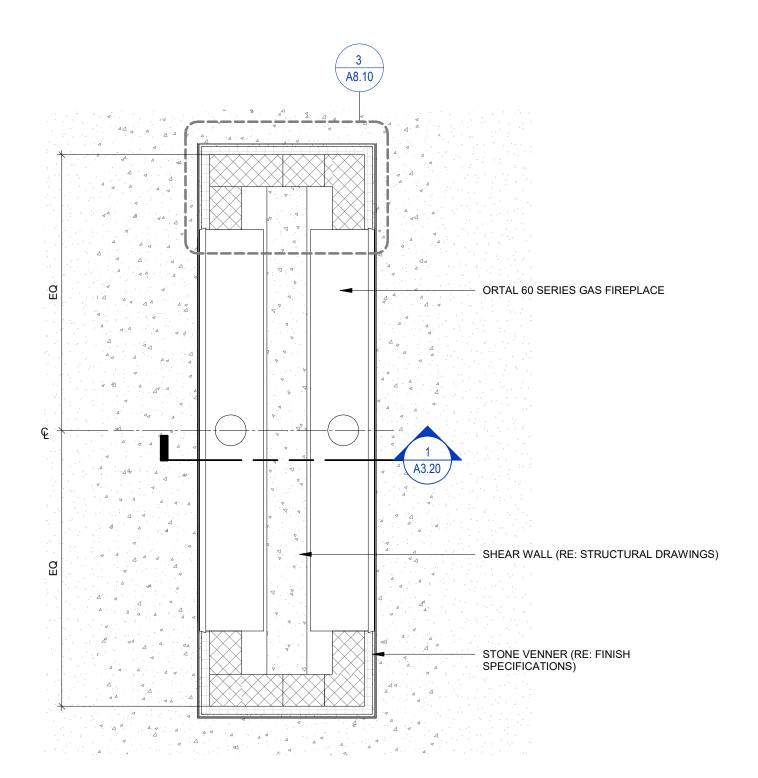




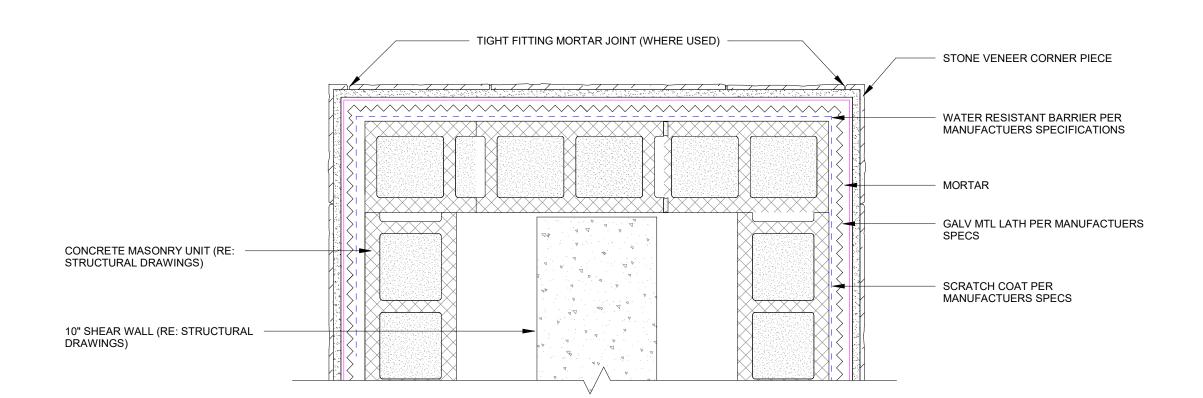




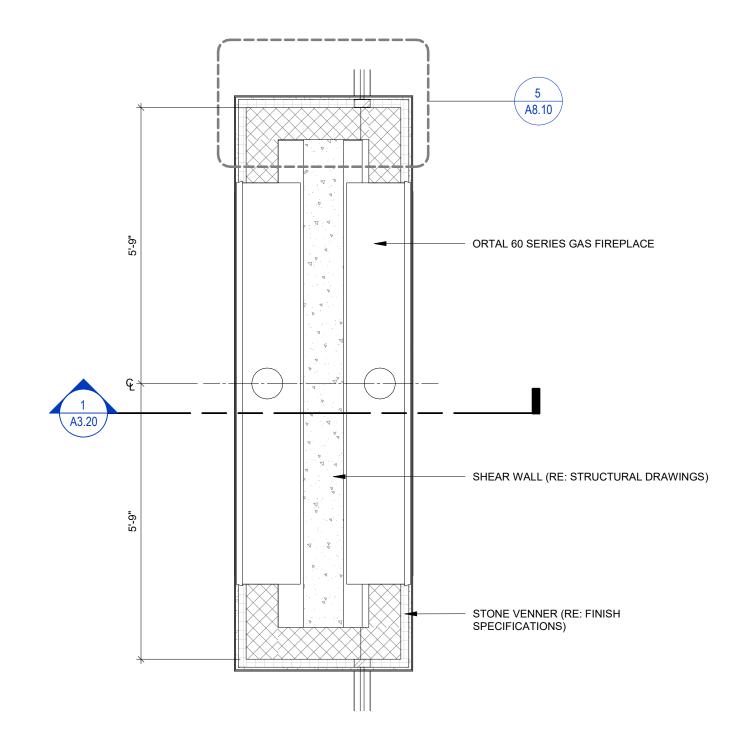

MAIN LEVEL CHIMNEY PLAN B SCALE: 1/2" = 1'-0"

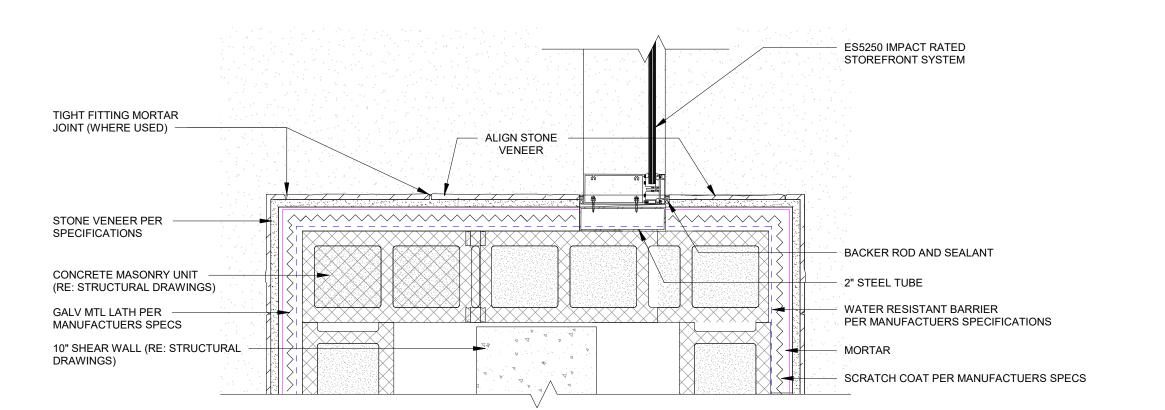

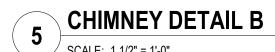



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ATLANTIC FIELDS GOLF HOUSE

PERMIT SET

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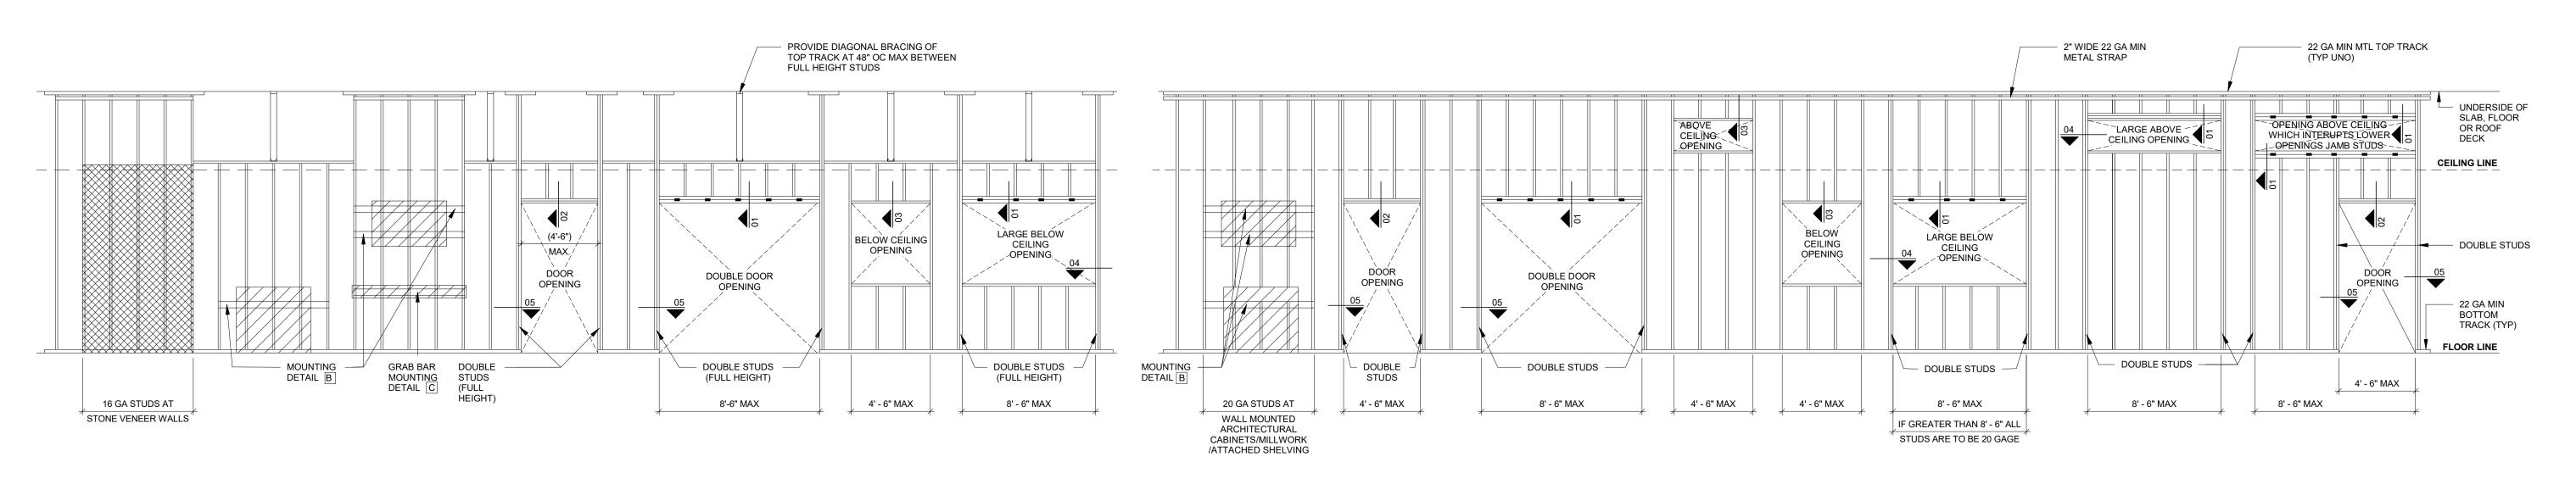
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EXTERIOR CHIMNEY DETAILS

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1. ALL STUDS ARE SPACED 16" OC MAXIMUM.

FLANGE MINIMUM.

4. DENOTES STONE.

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ATLANTIC

FIELDS

ATLANTIC FIELDS **GOLF HOUSE**

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FRAMING DETAILS

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2. ALL STUDS SHALL BE "C" STUDS WITH 1/4"

3. DENOTES SHELVING OR CABINETRY.


5. IN NO CASE SHALL DOUBLE STUDS AT SIDES OF OPENING BE CUT FOR DUCTWORK OR OTHER MECHANICAL SYSTEMS.

6. AT LEAD LINED PARTITIONS STUDS SHOULD BE 20 GA.

ACCESSORY / EQUIPMENT MOUNTING DETAILS

ACCESSORY / EQUIP MOUNTING DETAIL TYP. A


SCALE: 1/4" = 1'-0"

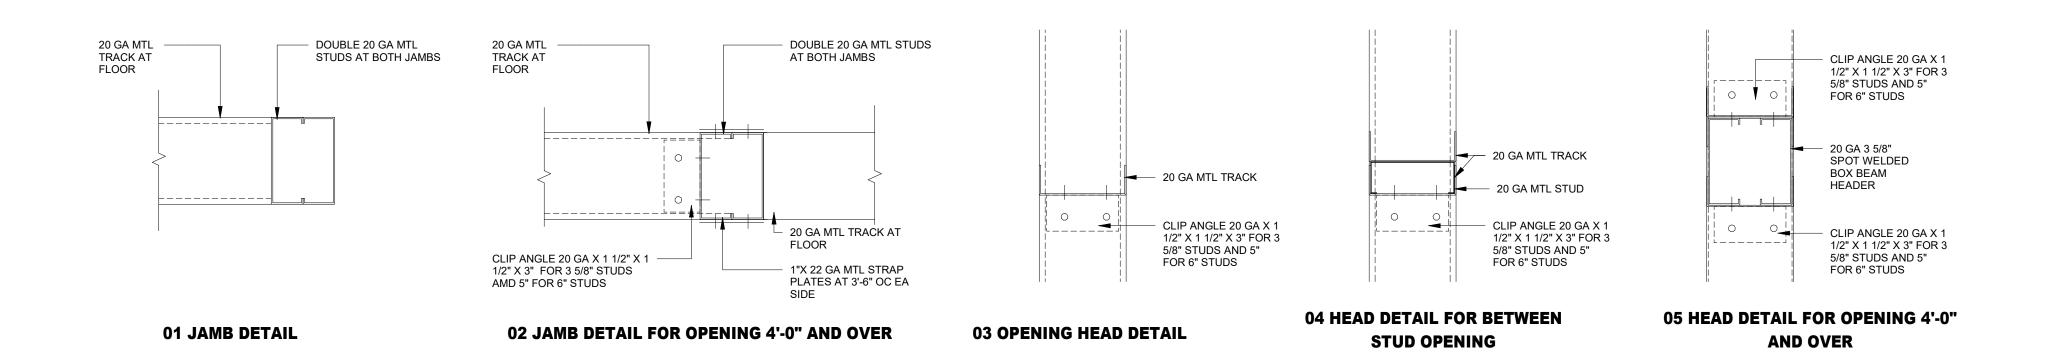



TYP. FRAMING DETAILS

SCALE: 3" = 1'-0"

SCALE: 3/8" = 1'-0"

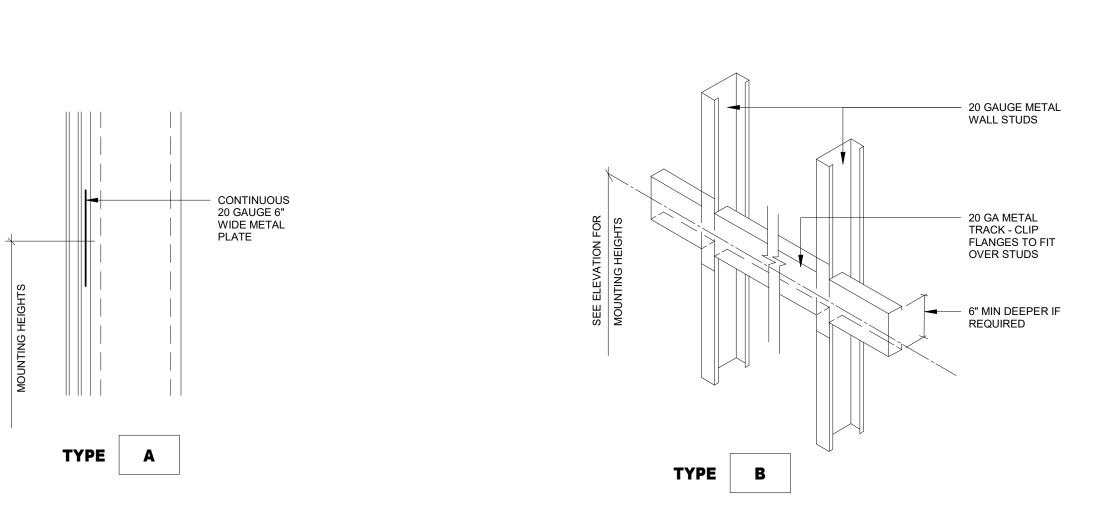

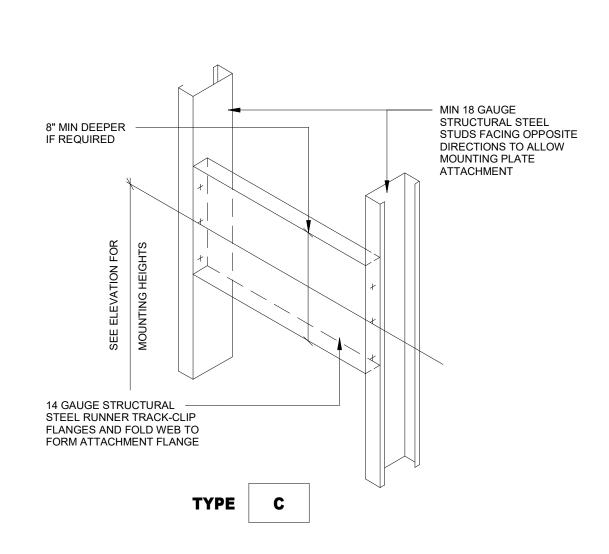

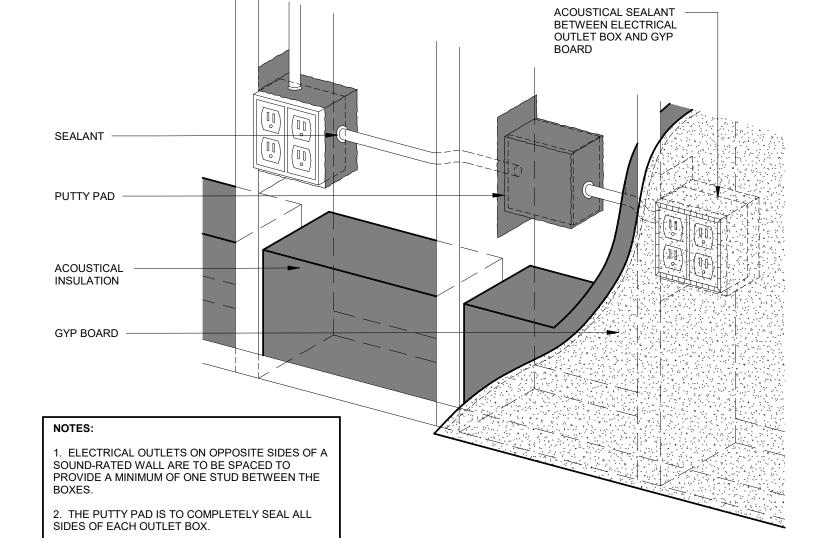


ACOUSTICAL PUTTY PAD IN INT. PARTITION DEMISING WALL

SCALE: 1 1/2" = 1'-0"








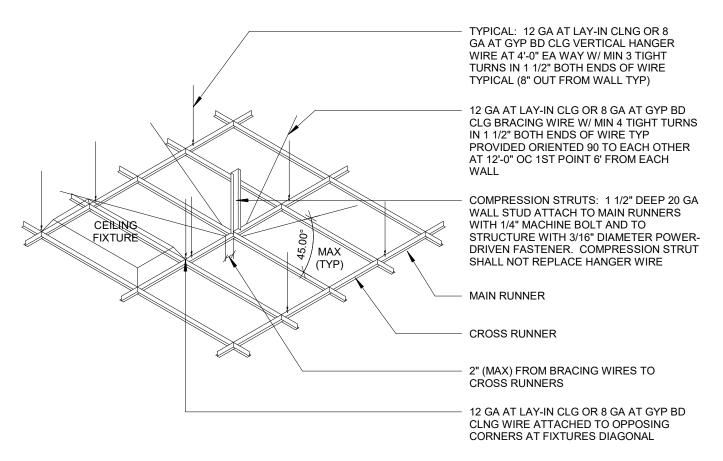

NOTES:

- 1. ICBO (INTERNATIONAL COUNCIL OF BUILDING OFFICIALS) EVALUATION REPORT 4071 GYPSUM WALLBOARD (066). (THIS REPORT HAS THE SAME REQUIREMENTS FOR GYP BD CEILINGS AND LAY-IN CEILING.
- 2. ALL LATERAL SUPPORTS MUST BE LOCATED A MIN OF 6" (152mm) FROM HORIZONTAL UNBRACED PIPES AND
- 3. VERTICAL STRUTS FASTENED TO THE MAIN RUNNER SHALL BE EXTENDED TO AND FASTENED TO THE STRUCTURAL MEMBERS SUPPORTING THE ROOF OR FLOOR ABOVE. THE STRUT SHALL BE ADEQUATE TO RESIST THE VERTICAL LOAD INDUCED BY THE BARRIER WIRES.
- 4. THE VERTICAL STRUTS AT HORIZONTAL RESTRAINT POINTS SHALL BE PLACED 12'-0" (3658mm) OC IN BOTH DIRECTIONS, WITH THE FIRST POINT WITHIN 6'-0" (1830mm) FROM EACH WALL.



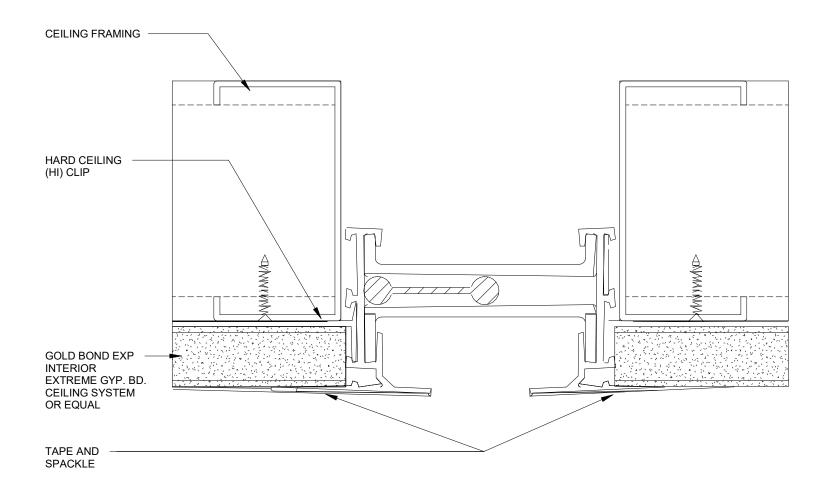



BAUCO PLUS II CONCEALED
FRAME FLUSH ACCESS PANEL
WITH RECESS FOR GYP BD
PANEL

MTL STUD FRAMING FOR
GYP. BD. CEILING PER
MANUFACTURERS
SPECIFICATIONS

GYP. BD. W. CONT. CORNER BEAD
AROUND OPENING


GYP. BD. W. CONT. CORNER BEAD
AROUND OPENING

MECHANICAL TOUCH LATCH PER
MANUFACTURERS SPECIFICATIONS

CONT. HINGE AT ACCESS
PANEL PER THE BAUCO
PLUS II

GYP. BD. INFILL PANEL TO MATCH
CEILING IN FINISH AND COLOR

CUSTOMIZE SIZE, REFER TO
CEILING PLAN

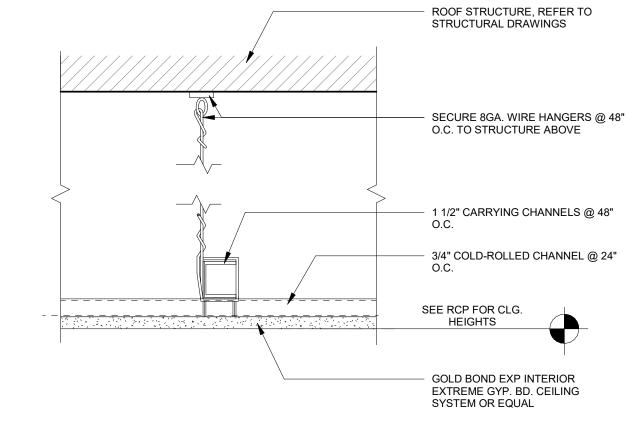

CONCEALED FRAME FLUSH ACCESS PANEL





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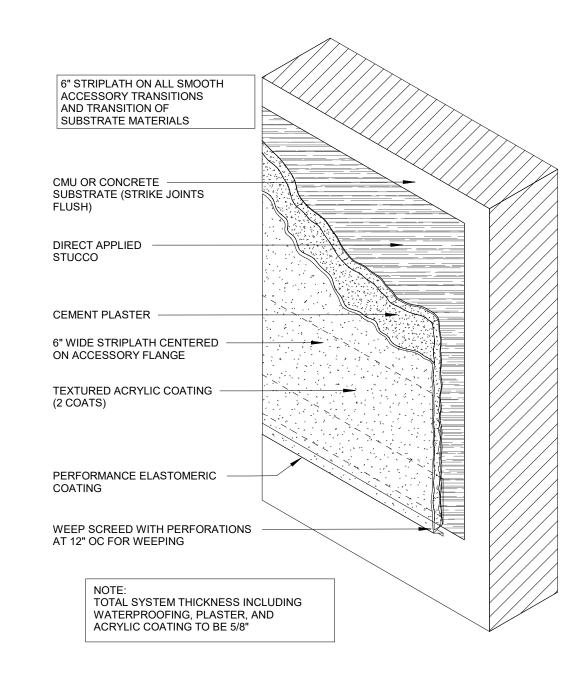
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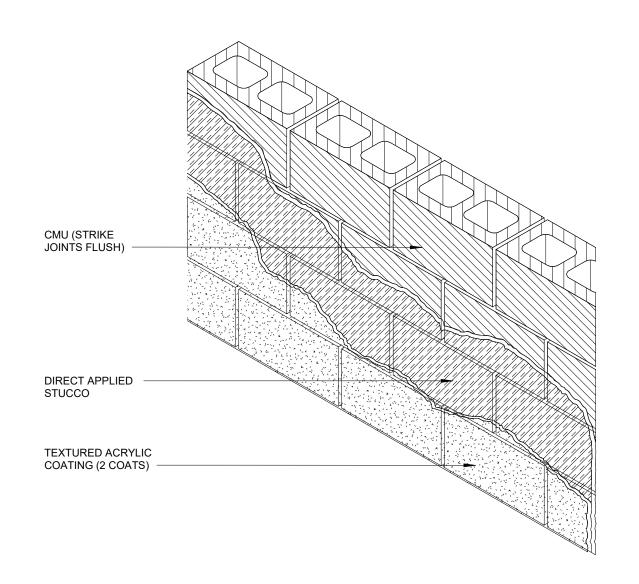
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DIRECT BOND PLASTER DETAIL



2 TEXTURED ACRYLIC SYSTEM (TAC-05) SCALE: 3" = 1'-0"



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